Proposed: Detached Steel Framed Shed

Client: Damien Hudson

Address: 10 Coomber Street, Rylstone, NSW 2849 MID-WESTERN REGIONAL COUNCIL

General Specification:

- Drawings prepared via information supplied by the owner and/or builder
- All Measurements & Dimensions are in millimetres unless otherwise stated
- All Dimensions, Levels & Heights to be verified on site prior to construction - Builder to be responsible to verify all documentation as to their accuracy & suitability
- Surveyed Levels to be taken in preference to Datum Heights
- Plans are to be read in conjunction with Engineers details & other provided documentation/drawings
- All Construction to be in accordance with National Construction Code/NCC Volume 2 Building Code of Australia Class 1 & Class 10 Buildings Statutory Requirements
- All work to be carried out in accordance with RFS Bushfire Guidelines Planning for Bush Fire Protection 2019 (NSW), taking preference over Basix commitments or approval conditions
- Builder to comply with requirements of all legally constituted authorities having jurisdiction over the building works & the provisions of the Home Building Act
- Prior to commencement of work, builder to provide temporary toilet facilities for the use of subcontractors where the local authority requires the temportary toilet. On completion, builder to remove.
- All Earthworks shall be in accordance with Engineers details & NCC H1D3 - All Earthworks retaining structures (ie retaining walls) to NCC H1D3, AS 4678 and Engineers details (if applicable)
- Stormwater & Drainage to be carried out in accordance with NCC H2D2
- All Plumbing, Electrical, Gas & other construction work to be completed by licensed tradespersons
- Where Natural Ventilation isn't provided in a WC, mechanical ventilation to be installed in accordance with NCC 10.6
- All accessibility provisions to AS1428.1 (if applicable)
- Do not scale from plans

Legend:

DP: Downpipe

NGL: Natural Ground Line

FGL: Finished Ground Line

FFL: Finished Floor Level

FSL: Finished Surface Level

RL: Reduced Level WC: Water Closet

Van: Vanity

FW: Floor Waste

TOW: Top of Wall

BOW: Bottom of Wall

RWT: Rainwater Tank

SEDIMENT TRAPPING DEVICES.

SEDIMENT FENCES SEDIMENT FENCES



DESCRIPTION

A sediment fence (also known as a silt fence) is a temporary barrier of geotextile filter or fabric, usually supported by steel mesh and steel posts.

DESIGN LIMITATIONS

Sediment Fences have the following design limits:

- The area draining to the fence is 0.6ha or less.
- The maximum slope length behind the fence is 60m.

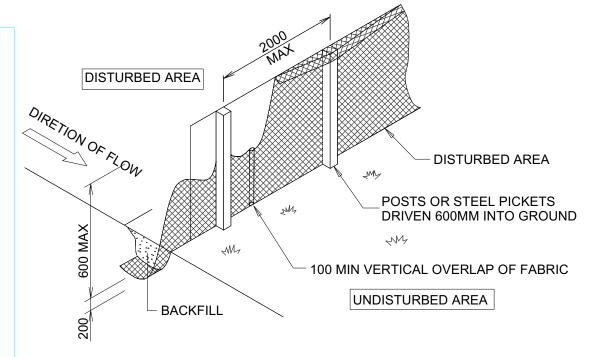
PURPOSE

Sediment fences filter runoff, trapping the sediment and allowing filtered water to pass through.

Sediment fences should have a stable outlet or overflow point, in-case the flow rates exceed their capacity to filter the water.

MAINTENANCE

After each rain event check for undercutting, sagging and overtopping, and repair immediately. Sediment collected should be removed from site.



SEDIMENT TRAPPING DEVICES.

NOT TO SCALE

Subject Site:



Revision Schedule:

Rev:	Changes Made:	Date:	Ву:
V1	Preliminary Plans	15/01/25	WR
V2	Final Plans Issued	16/01/25	WR
V3	Plan amended as per site measure.	30/01/25	WR

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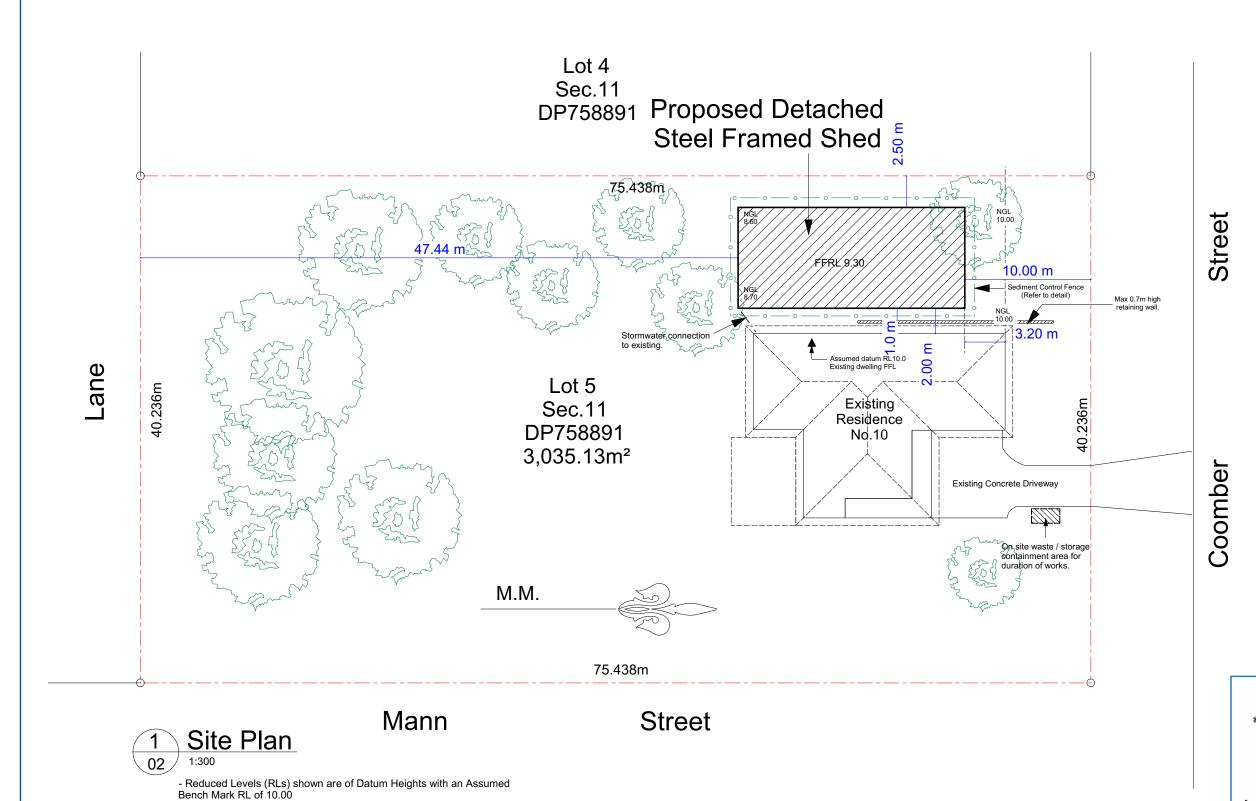
Supplied By:





Job No: Note: Plans to be printed on A3 to be to scale. Do not scale off plans. All dimensions and natural ground heights to be checked and verified on site

250115



Site Calculations

m² **Area Summary** Existing Dwelling (Including verandahs) = 260.00 Proposed Shed = 144.00 % Total Site Coverage = 13.31% % Landscaped Area.....

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Supplied By:





Fernleigh DRAFTING I COUNCIL SERVICES

fernleighdrafting.com.au hello@fernleighdrafting.com.au

Proposed: Detached Steel Framed Shed

Damien Hudson

Address:

10 Coomber Street, Rylstone, NSW 2849

Lot 5/ Sec.11 /DP758891

MID-WESTERN REGIONAL COUNCIL Council:

Plan:

Drawn: WR - 25-01

Site Plan

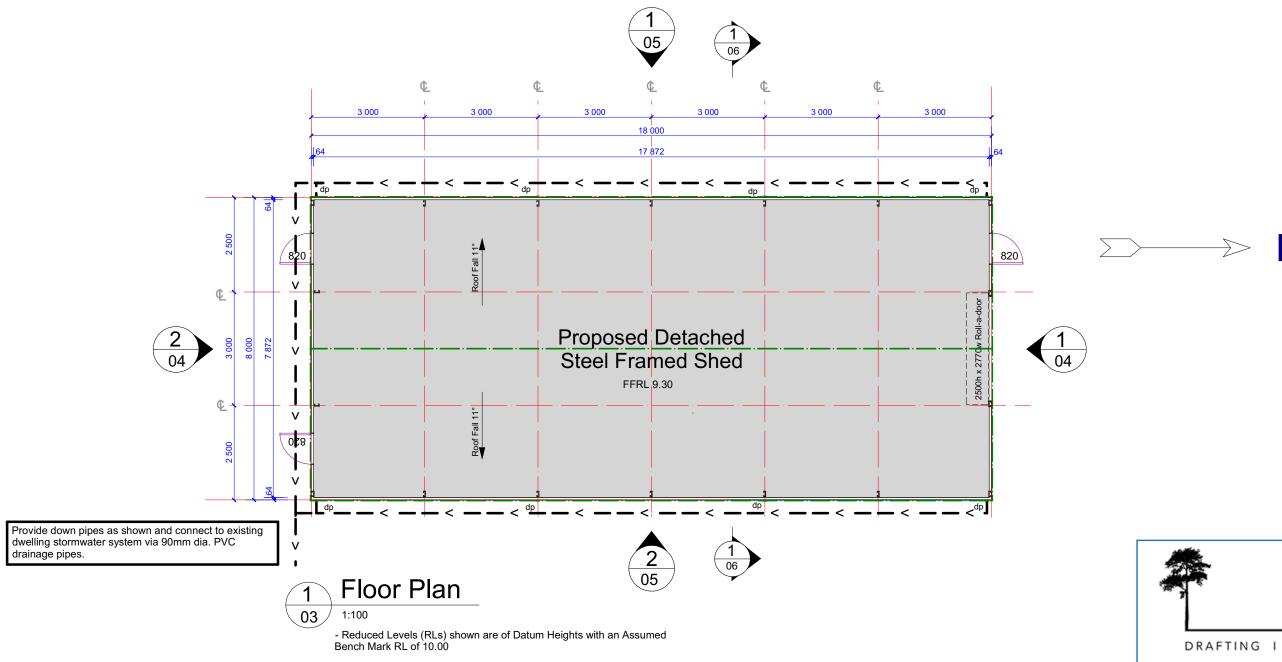
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<u>Fernleigh</u>

COUNCIL SERVICES

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Proposed: Detached Steel Framed Shed Client: Damien Hudson

Address:

10 Coomber Street, Rylstone, NSW 2849

Lot 5/ Sec.11 /DP758891

MID-WESTERN REGIONAL COUNCIL

Plan:

Floor Plan

Drawn: WR - 25-01

Date: January 2025

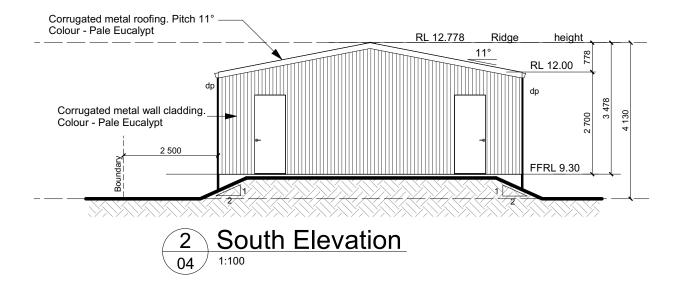
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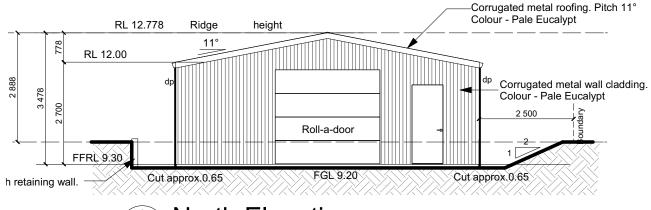
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Note: Plans to be printed on A3 to be to scale. Do not scale off plans. All dimensions and natural ground heights to be checked and verified on site.





North Elevation

- Reduced Levels (RLs) shown are of Datum Heights with an Assumed Bench Mark RL of 10.00

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DRAFTING I

Proposed: Detached Steel Framed Shed

Client: Damien Hudson

Address:

10 Coomber Street, Rylstone, NSW 2849

Lot 5/ Sec.11 /DP758891

MID-WESTERN REGIONAL COUNCIL Council:

Plan:

Elevations

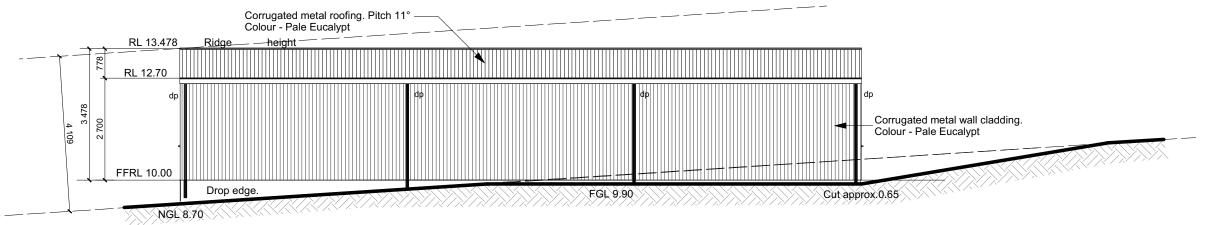
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Date: January 2025

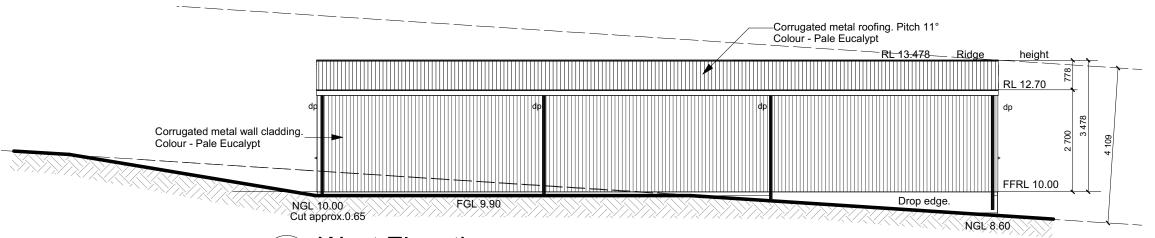
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Job No: 250115

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2 East Elevation 05



West Elevation

05

- Reduced Levels (RLs) shown are of Datum Heights with an Assumed Bench Mark RL of 10.00

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Proposed: Detached Steel Framed Shed

Client: Damien Hudson

Address:

10 Coomber Street, Rylstone, NSW 2849

Lot 5/ Sec.11 /DP758891

MID-WESTERN REGIONAL COUNCIL

Plan:

Elevations

Drawn: WR - 25-01 Date: January 2025

Scale: 1:100 @ A3

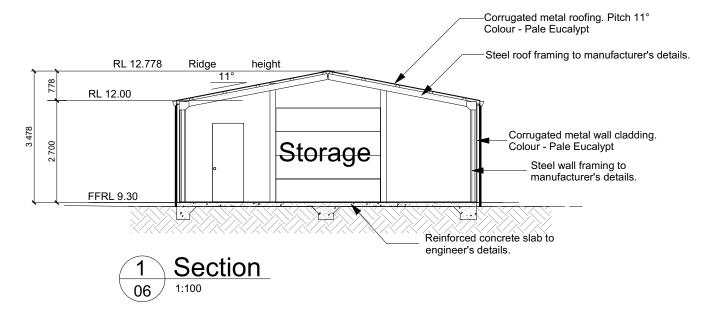
Job No: 250115

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- Reduced Levels (RLs) shown are of Datum Heights with an Assumed Bench Mark RL of 10.00

*If any uncontained fill is required on site, Class 'P' is applicable.

All works to be completed in accordance with the performance requirements of the National Construction Code (NCC) 2022 Volume 2

Detached Portal Frame Sheds

Part H1 Structure (dealt with in Engineering)

H1P1 Structural reliability and resistance

H1P2 Buildings in flood areas

H1D2 Structural provisions H1D3 Site preparation

H1D4 Footings and slabs

H1D6 Framing

H1D7 Roof and wall cladding

H1D8 Glazing

H1D9 Earthquake areas

H1D10 Flood hazard areas

H1D11 Attachment of framed decks and balconies to external walls of

buildings using a waling plate

H1D12 Piled footings

Part H2 Damp and weatherproofing (dealt with in Engineering)

H2P1 Rainwater management

H2P2 Weatherproofing

H2P4 Drainage from swimming pools

H2D2 Drainage

Part H3 Fire safety (dealt with in Engineering)

H3D1 Deemed-to-Satisfy Provisions

H3D2 Fire hazard properties and non-combustible building elements

H3D3 Fire separation of external walls

Part H4 Health and amenity

H4P1 Wet areas

H4P2 Room heights

Part H5 Safe movement and access

H5P1 Movement to and within a building

Part H7 Ancillary provisions and additional construction requirements (dealt with in Engineering)

H7P1 Swimming pool access

H7P2 Swimming pool reticulation systems

H7P5 Buildings in bushfire prone areas

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