

SECONDARY DWELLING - 185 CHURCH STREET, MUDGEE

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SINGLE STOREY DWELLING CLIENT PLAN APPROVAL

Signed

LEGEND WC - WATER CLOSET HWS - HOT WATER SYSTEM

MB - METER BOX SHR - SHOWER VTY - VANITY PTY - PANTRY

MW - MICROWAVE SD - SMOKE DETECTOR LDRY - LAUNDRY BED - BEDROOM
PDR - POWDER ROOM
O/H - OVERHEAD CUPBOARDS
BAL - BUSHFIRE ATTACK LEVEL

GSD - GLASS SLIDING DOOR

CB - COLORBOND
LGA - LOCAL GOVERNMENT PLAN
WT - WINDOW TOP
WB - WINDOW BOTTOM
RL - RIDGE LINE
AHD - AUSTRALIAN HEIGHT DATUM
PP - POWER POLE
VEG - VEGETATION
EB - EDGE OF BITUMEN
BM - BENCH MARK
GUT - GUTTER
EXT - EXIT FXT - FXIT BC - BROOM CLOSET OBS - OBSCURE WINDOV

TUB - LAUNDRY TUB

CB - COLORBOND

WM - WASHING MACHINE

GENERAL BUILDING NOTES

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Title Page

CLIENT: ATTARD

JOB NUMBER: 202754

LOCATION: 185 CHURCH ST, MUDGEE LGA: MID-WESTERN REGIONAL COUNCIL


DRAWN: AF

LOT/DP: 8/DP238892 SCALE: 1:100 @ A3 SHEET NO: DA.1 ISSUE: DA

DATE: Thursday, 26 September 2024

DESIGN: JACARANDA

REF NUMBER: IN CASE OF ALTERATIONS OR DISCREPANCIES NOTIFY HITECH HOMES DESIGN OFFICE

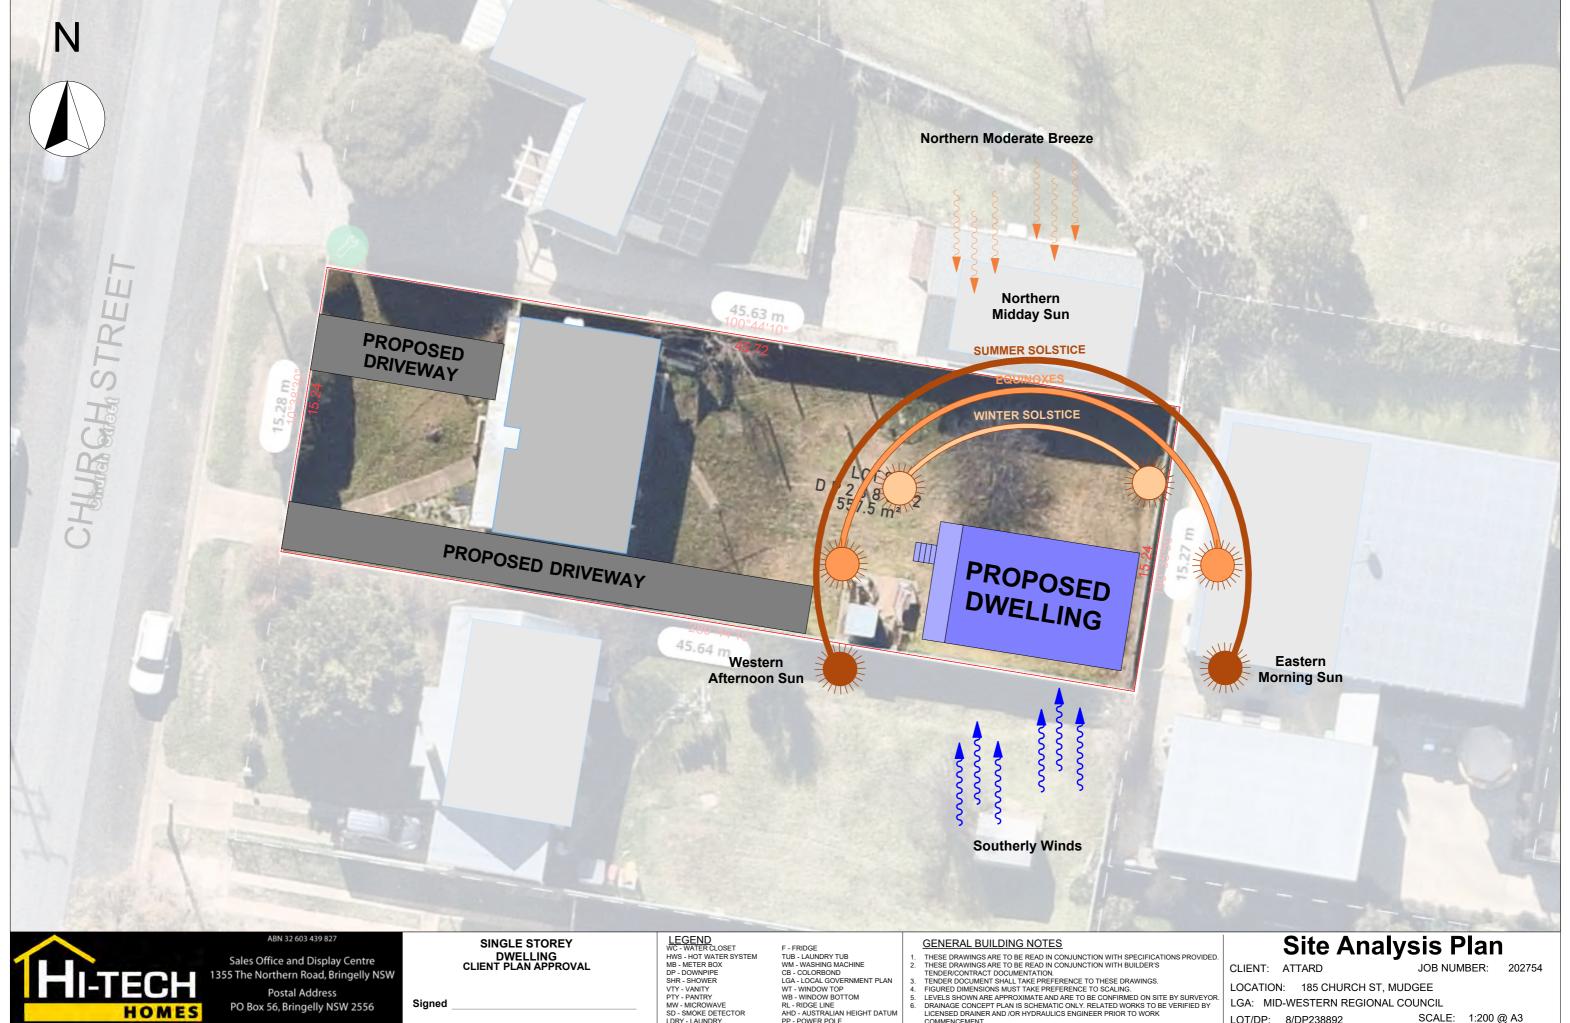



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Signed

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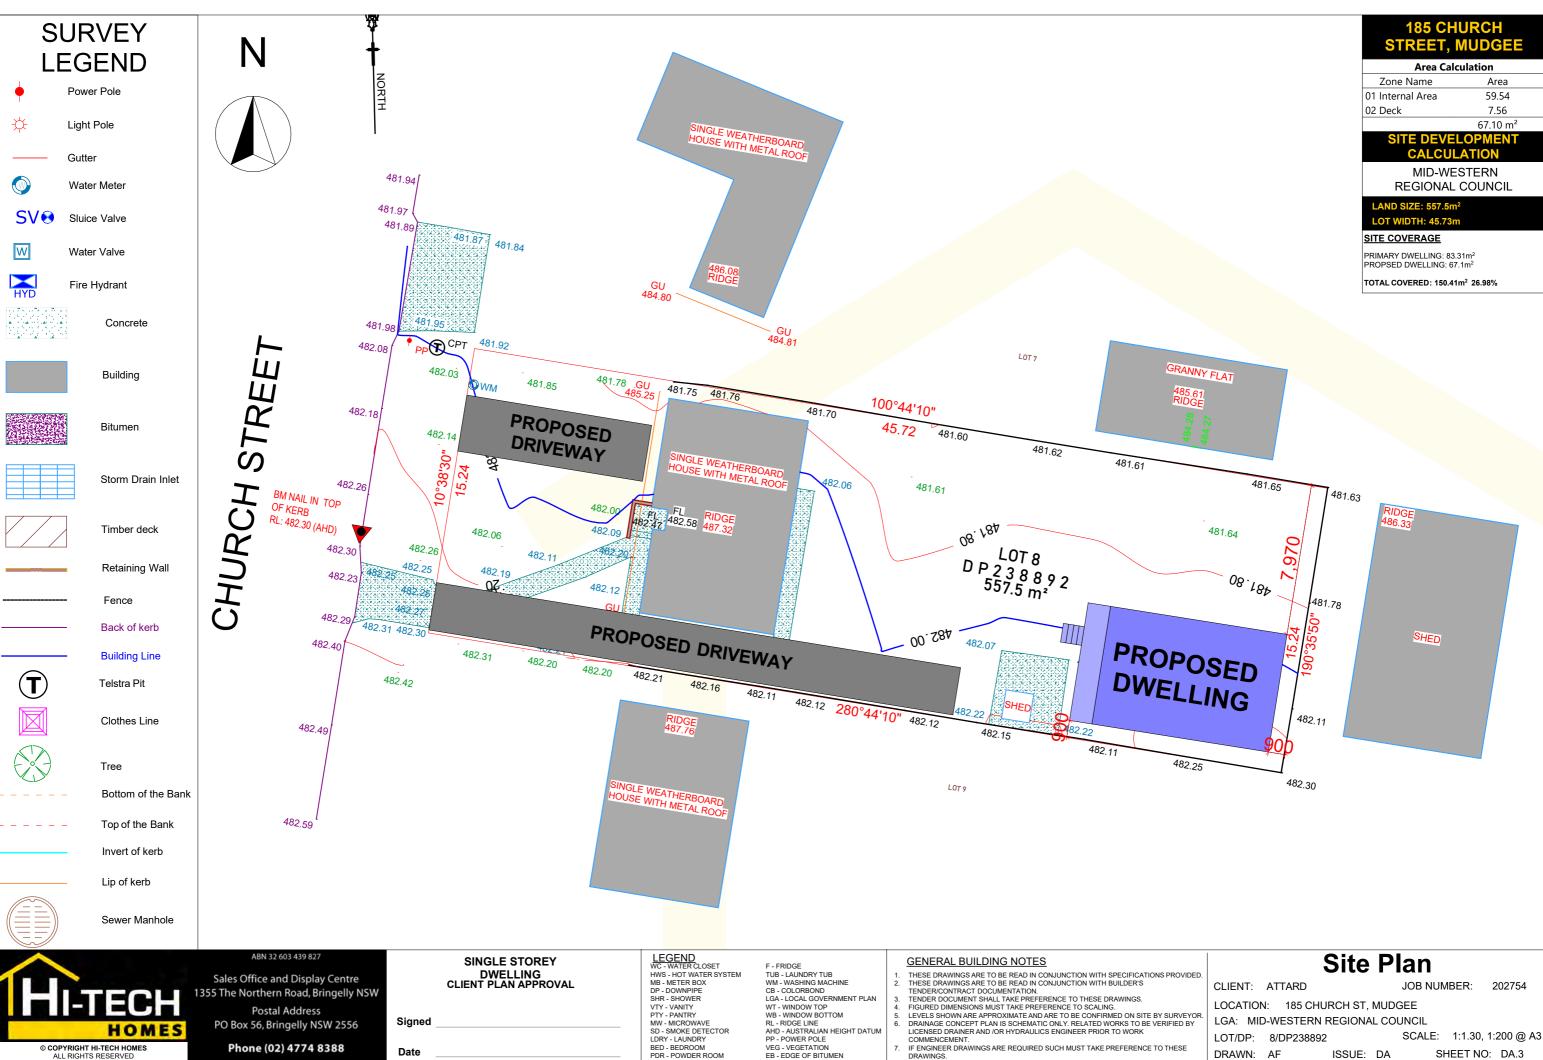
EXT - EXIT BC - BROOM CLOSET OBS - OBSCURE WINDOW

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- BUILDING WORKS BY REGISTERED SURVEYOR. IN CASE OF ALTERATIONS OR DISCREPANCIES NOTIFY HITECH HOMES DESIGN OFFICE

LOCATION: 185 CHURCH ST, MUDGEE LGA: MID-WESTERN REGIONAL COUNCIL

LOT/DP: 8/DP238892 SCALE: 1:200 @ A3 SHEET NO: DA.2 DRAWN: AF ISSUE: DA

DESIGN: JACARANDA REF NUMBER:



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FXT - FXIT

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GSD - GLASS SLIDING DOOR

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SHEET NO: DA.3 ISSUE: DA DESIGN: JACARANDA REF NUMBER:

LEGENDS

	DESCRIPTION
	PROPOSED PIPES TO OUTLET
D.P	PROPOSED NEW DOWNPIPE (Ø100 UNO)

GROUND FLOOR DRAINAGE PLAN

GENERAL NOTES

ALL DRAINAGE LINES SHALL BE UPVC (CLASS SH) LAID @ 1% FALL MIN, UNO. ALL STORMWATER DOWNPIPES Ø100 UNO.

TYPICAL MINIMUM EFFECTIVE EAVES GUTTER SIZE = 6700 mm² MINIMUM EFFECTIVE EAVES GUTTER SLOPE = 1:500





RAINWATER SUPPLY SIGN

GENERAL NOTES

- ALL LINES ARE TO BE Ø100 uPVC @ MIN 1% GRADE UNLESS NOTED OTHERWISE. CHARGED LINES TO BE SEWER GRADE & SEALED.
- IT IS THE CONTRACTOR'S RESPONSIBILITY TO LOCATE & LEVEL ALL EXISTING SERVICES PRIOR TO THE COMMENCEMENT OF ANY EARTHWORKS.
- ALL PIPES TO HAVE MINIMUM 150mm COVER IF LOCATED WITHIN PROPERTY.
- ALL PITS IN LANDSCAPE AREAS TO BE 450 x 450 PLASTIC UNO. AND ALL PITS IN DRIVEWAYS TO BE 450 x 450 CONCRETE UNO.
- PITS LESS THAN 600 DEEP MAY BE BRICK, PRECAST OR CONCRETE UNO.
- ALL BALCONIES AND ROOFS TO BE DRAINED AND TO HAVE SAFETY OVERFLOWS IN ACCORDANCE WITH RELEVANT AUSTRALIAN STANDARDS.
- ALL EXTERNAL SLABS TO BE WATERPROOFED. 7.
- ALL GRATES TO HAVE CHILD PROOF LOCKS
- ALL DRAINAGE WORKS TO AVOID TREE ROOT ZONE.
- ALL DP'S TO HAVE LEAF GUARDS.
- ALL EXISTING LEVELS TO TO BE CONFIRMED BY BUILDER PRIOR TO CONSTRUCTION.
- 12. ALL WORKS WITHIN COUNCIL RESERVE TO BE INSPECTED BY COUNCIL PRIOR TO CONSTRUCTION.
- COUNCIL'S ISSUED FOOTWAY DESIGN LEVELS TO BE INCORPORATED INTO THE FINISHED LEVELS ONCE ISSUED BY COUNCIL.
- ALL WORKS SHALL BE IN ACCORDANCE WITH BCA AND AS3500.3.
- EXISTING STORMWATER PIPE LOCATIONS HAVE BEEN ASSUMED. PLUMBER TO INSPECT PRIOR TO WORKS AND UPGRADE PIPES AS NECESSARY.

CHURCH STREET PP CP **PROPOSED** DRIVEWAY STORMWATER OVERFLOW TO STREE LOT 8 5238892 557.5 m² 08.184 PROPOSED DRIVEWAY **PROPOSED DWELLING**

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- BROOM CLOSE

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Stormwater Plan

CLIENT: ATTARD

JOB NUMBER: 202754

LOCATION: 185 CHURCH ST, MUDGEE LGA: MID-WESTERN REGIONAL COUNCIL

LOT/DP: 8/DP238892 SCALE: 1:250 @ A3

SHEET NO: DA.4 DRAWN: AF ISSUE: DA DESIGN: JACARANDA

LANDSCAPE LEGEND



TURF AREA




EXISTING HARDSTAND AREAS



EXISTING STRUCTURES



PROPOSED STRUCTURES

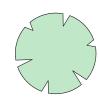

EXISTING TREES/GARDENS

NOTE:

- 9 Substitution of plant species or varieties will not be permitted
- 10 Unless otherwise specified or directed, all instructions are to be issued by the consulting landscape designer.

- All storm water outlets & surface run off shall be to Hydraulic Engineers detail.
- 4 Refer to Architectural elevations & Sections for existing and proposed
- indscope works shall comply with all councils DA & CC conditions all relevant "AUSTRALIAN STANDARDS" and AUS_SPEC NO.1
- ation system If required, shall be designed & installed to comply AS 2698, AS 2698.1-1994, AS 2698.2-1985, AS 2698.3-1990,
- MAINTENANCE— All landscape works are to be maintained for a period of 12 weeks after find completion. Replace all plants which have falled with the some species. Mulch is to be maintained at specified depth. All plants and turf shall be watered on a regular bat to maintain moisture levels required for optimum growth. All garden areas are to be maintained free from weeds.

PLANT SCHEDULE

PLANT	SYMBOL	NAME	SIZE	POT	QTY
		HEBE BUXIFOLIA 'INSPIRATION (OR SIMILAR)	1.5 X 1.5	150MM	5
	*	PHORMIUM TENAX 'PURPUREN (OR SIMILAR)	1 X 1	150MM	3
	A STATE OF THE STA	DIANELLA (OR SIMILAR)	0.4 X 0.4	150MM	8
		CHAMAECYPARIS LAWSONIANA	2 X 1.5	25L	5

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SELECTED TURE -

BRICK GARDEN EDGE WITH 10mm MORTAR FLUSH JOINT

100 DEPTH MULCH

MORTAR BED 3:1 - SAND : CEMENT MIX-

(WIDEN MORTAR JOINTS AS REQUIRED TO ACCOMMODATE CURVED LINES)

1. TURF & GARDEN EDGE DETAIL

AUGNMENT OF BRICK EDGE SHALL BE EVEN & FREE FROM DIPS AND HUMPS.

LAY TURF IN STRETCHER PATTERN WITH CLOSE BUTT

100 TOPSOIL & FERTILISER

SUB-GRADE BROKEN UP TO 100 DEPTH

SURFACE AFTER LAYING
AND WATER UNTIL TOPSOIL IS
MOISTENED TO ITS FULL DEPTH

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Area Calculation		
Zone Name	Area	
01 Internal Area	59.54	
02 Deck	7.56	
	67.10 m ²	

MID-WESTERN REGIONAL COUNCIL

PLACE FERTILISER PELLETS WITH "NPK" SLOW RELEASE FERTILISER AROUND THE PLANT AT THE TIME OF PLANTING

BACKFILL WITH SELECTED GARDEN
MIXTURE — COMPACTED LIGHTLY
& UNIFORMLY IN 150 LAYERS

100 DEPTH MULCH

MOIST ROOTBALL

LANDSCAPED AREA

STRUCTURES: 150.41m² HARDSTAND AREAS: 144.46m² LANDSCAPE AREA: 262.63m² 47.11%



STAKE SIZE |QUANTITY | HEIGHT


SELECTED PLANTING THOROUGHLY WATER PLANT

BEFORE & AFTER PLANTING 50 WIDE WEBBING THE CROSSED TO FORM A FIGURE 8 AND STAPLED TO STAKE

MOUNDED WATER BASIN

>2500 (45L POT) 1-2500 (25L POT)

<1000 (15L POT)

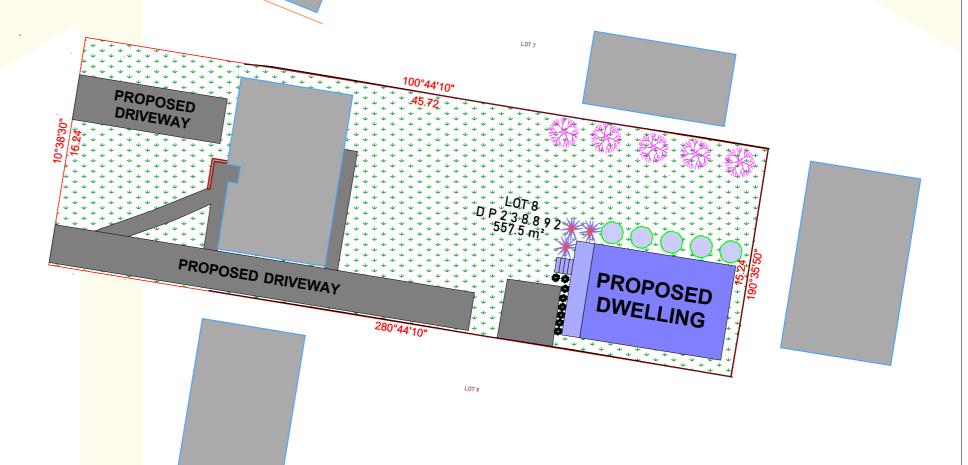

Landscape Plan

JOB NUMBER: CLIENT: ATTARD 202754

LOCATION: 185 CHURCH ST, MUDGEE

LGA: MID-WESTERN REGIONAL COUNCIL LOT/DP: 8/DP238892 SCALE: 1:1.30, 1:250 @ A3

SHEET NO: DA.5 DRAWN: ISSUE: DA DESIGN: JACARANDA

FULL SITE PLAN

SEDIEMT CONTROL FENCE LAYOUT

This is a Soil and Water Management Plan, and shows an acceptable way of managing soil erosion and water quality on the site. The Site Manager shall be responsible for implementation and management of the Soil and Water Management on the site.

This plan is to be read in conjunction with the DA and Engineering Plans, and any other plans written instructions, specification or documentation that may be issued relating to development of the site. Ensure that all soil and water management works are located as instructed by the Site Manager or as shown on the plans, specification or other relevant documentation.

All workers and sub-contractors shall be informed of their responsibilities in minimising the potential for soil erosion and pollution to downslope lands and waterways.

Water will be prevented from entering the permanent drainage system unless it is relatively sediment free, ie the catchment area has been permanently landscaped and/or any likely sediment has been filtered through or settled within an approved structure to meet environmental guidelines.

'Sediment' fencing and adjacent swales will be installed as indicated on the plans and at the direction of superintendent to ensure containment of sediment. The swales will outlet or overflow under stabilised conditions into the sediment basins, to safely convey water into a suitable filtering system should the pores in the fabric block.

Construct a new sediment basin (if indicated on plans) at the location shown and clean out the existing dams to act as a sediment basin during the construction period and beyond.

Sediment basins shall have a minimum wet sediment capacity of 10 cubic metres and be designed with suitable overflow spillways to remain stable in at least the 1 in 10 year ARI (10% AEP), critical duration storm event.

In general, water shall not be released or pumped from sediment basins unless water quality complies with the 'Australian and New Zealand Guidelines for Fresh and Marine Water Quality' and in particular 50mg/L maximum suspended solids. Artificial flocculation to settle finer particles may be necessary in this instance. The basins are to be emptied within 48 hours after a storm event, but only after water has reached acceptable quality levels.

Stockpiles must not be located within 2m of hazard areas, including likely areas of concentrated or high velocity flows such as waterways, paved areas and driveways. Where they are between 2m and 5m metres from such areas, special sediment control measures should be taken to minimise possible pollution to downslope waters, e.g. through installation of additional 'sediment' fencing and bunds around the stockpiles.

Regular checking and maintenance of the measures to ensure the integrity of the installed measures.








TECHNIQUES


Stockpile Management



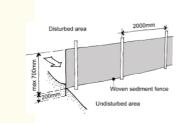


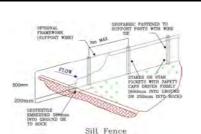

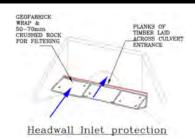

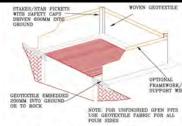

Grated/Unfinished Pit Protection

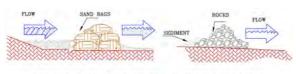



Sand bag or Rock Filter Sedimentation Trap

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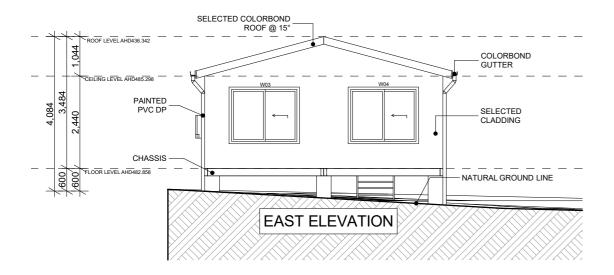
Sediment Control Plan


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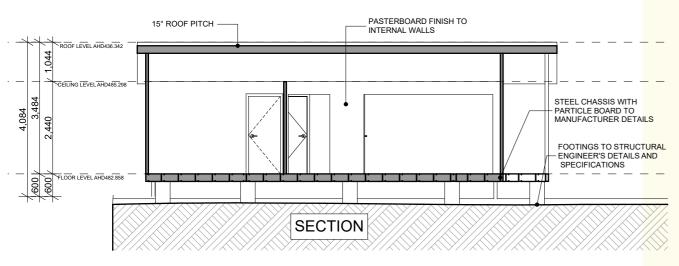
LOCATION: 185 CHURCH ST, MUDGEE


LGA: MID-WESTERN REGIONAL COUNCIL LOT/DP: SCALE: 1:300, 1:200 @ A3 8/DP238892


SHEET NO: DA.6 DRAWN: AF ISSUE: DA DESIGN: JACARANDA REF NUMBER:





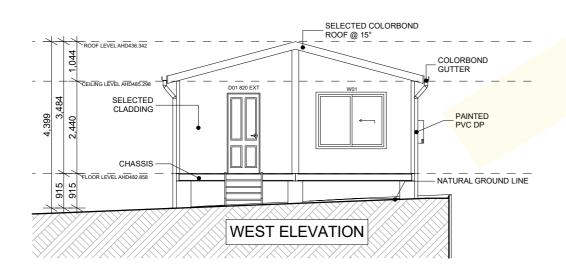

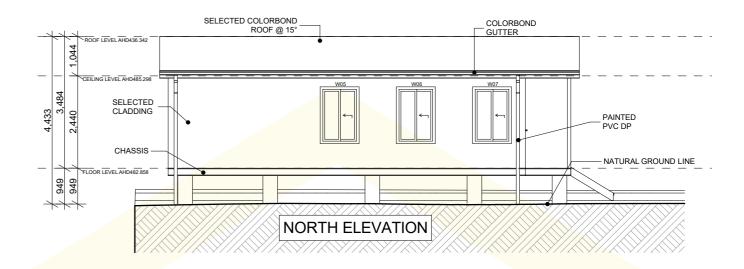

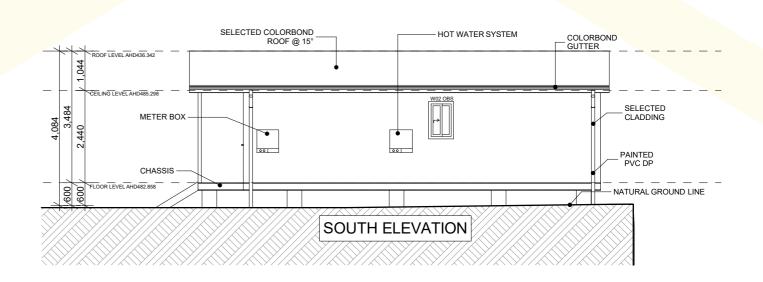

Door List			
Door ID	Width	Height	Quantity
D01 820 EXT	820	2,100	1
D02 720	720	2,040	1
D03 1050 DD	1,050	2,100	1
D04 820	820	2,040	1
D05 820	820	2,040	1
D06 820	820	2,040	1
D07 1890 SD	1,890	2,100	1
D08 1990 SD	1,990	2,100	1
			8

		Window Lis	st	
Window ID	Width	Height	Head Height	Quantity
W01	1,810	1,450	2,100	1
W02 OBS	610	940	2,100	1
W03	1,810	1,450	2,100	1
W04	1,810	1,450	2,100	1
W05	970	1,450	2,100	1
W06	970	1,450	2,100	1
W07	970	1,450	2,100	1
				7

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RD - ROBE DOOR CSD - CAVITY SLIDING DOOF

TUB - LAUNDRY TUB WM - WASHING MACHINE

WM - WASHING MACHINE
CB - COLORBOND
LGA - LOCAL GOVERNMENT PLAN
WT - WINDOW TOP
WB - WINDOW BOTTOM
RL - RIDGE LINE
AHD - AUSTRALIAN HEIGHT DATUM
PP - POWER POLE
VEG - VEGETATION
EB - EDGE OF BITUMEN
BM - BENCH MARK
GUT - GUTTER
EXT - EXIT GSD - GLASS SLIDING DOOR EXT - EXIT BC - BROOM CLOSET OBS - OBSCURE WINDOV

GENERAL BUILDING NOTES

- THESE DRAWINGS ARE TO BE READ IN CONJUNCTION WITH SPECIFICATIONS PROVIDED.

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 THESE DRAWINGS ARE TO BE READ IN CONJUNCTION WITH BUILDER'S
 TENDER/CONTRACT DOCUMENTATION.
 TENDER DOCUMENT SHALL TAKE PREFERENCE TO THESE DRAWINGS.
 FIGURED DIMENSIONS MUST TAKE PREFERENCE TO SCALING.
 LEVELS SHOWN ARE APPROXIMATE AND ARE TO BE CONFIRMED ON SITE BY SURVEYOR.
 DRAINAGE CONCEPT PLAN IS SCHEMATIC ONLY, RELATED WORKS TO BE VERIFIED BY
 LICENSED DRAINED AND JOED MYDRAJILICS ENGINEED PROJECT TO WORK. LICENSED DRAINER AND /OR HYDRAULICS ENGINEER PRIOR TO WORK
- IF ENGINEER DRAWINGS ARE REQUIRED SUCH MUST TAKE PREFERENCE TO THESE
- DRAWINGS.
 ALL BOUNDARY CLEARANCES MUST BE VERIFIED BEFORE COMMENCEMENT OF BUILDING WORKS BY REGISTERED SURVEYOR.
- IN CASE OF ALTERATIONS OR DISCREPANCIES NOTIFY HITECH HOMES DESIGN OFFICE

Elevations/Section

JOB NUMBER: 202754 CLIENT: ATTARD


LOCATION: 185 CHURCH ST, MUDGEE LGA: MID-WESTERN REGIONAL COUNCIL

DRAWN: AF

LOT/DP: 8/DP238892 SCALE: 1:1, 1:100 @ A3 SHEET NO: DA.8

ISSUE: DA DESIGN: JACARANDA REF NUMBER:

EXTERNAL COLOUR PLAN

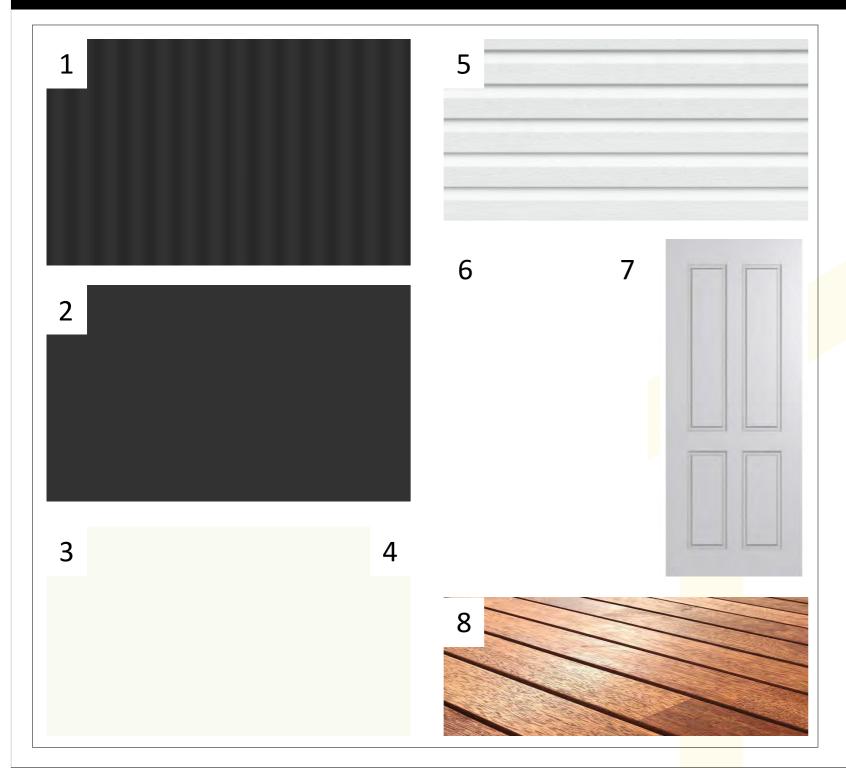



LEGEND

- ROOF: COLORBOND CORRUGATED 762 CB MONUMENT
- **GUTTER: CB MONUMENT**
- 3) FASCIA: CB DOVER WHITE
- 4) DOWNPIPES: CB DOVER WHITE
- CLADDING: DURATUFF VINYL HORIZONTAL DT STERLING 5)
- 6) WINDOWS & FLYSCREENS: WHITE - NYLON MESH
- ENTRY DOOR: HUME DOORS VAUCLUSE XV14 WHITE 7)
- 8) **DECKING: HARDWOOD MERBAU**

JOB NO: 202754

Sales Office and Display Centre

SITE ADDRESS: 185 CHURCH STREET, MUDGEE

CLIENT: ATTARD

The colours shown represent actual product colours as accurately as possible. However, we recommend checking your chosen colours against an actual sample of the products before purchasing, as varying screens and devices may affect colour tones and finishes.

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355 The Northern Road, Bringelly NSW **Postal Address** PO Box 56, Bringelly NSW 2556 Phone (02) 4774 8388

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SINGLE STOREY DWELLING CLIENT PLAN APPROVAL

Signed

LEGEND WC - WATER CLOSET HWS - HOT WATER SYSTEM

MB - METER BOX WM - WASHING MACHINE CB - COLORBOND SHR - SHOWER VTY - VANITY PTY - PANTRY LGA - LOCAL GOVERNMENT PLAN WT - WINDOW TOP WB - WINDOW BOTTOM RL - RIDGE LINE MW - MICROWAVE SD - SMOKE DETECTOR AHD - AUSTRALIAN HEIGHT DATUM PP - POWER POLE LDRY - LAUNDRY VEG - VEGETATION EB - EDGE OF BITUME

BED - BEDROOM
PDR - POWDER ROOM
O/H - OVERHEAD CUPBOARDS
BAL - BUSHFIRE ATTACK LEVEL GUT - GUTTER GSD - GLASS SLIDING DOOR FXT - FXIT - BROOM CLOSE

TUB - LAUNDRY TUB

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GENERAL BUILDING NOTES

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External Colours

CLIENT: ATTARD

JOB NUMBER: 202754


LOCATION: 185 CHURCH ST, MUDGEE

LGA: MID-WESTERN REGIONAL COUNCIL LOT/DP: 8/DP238892 SCALE: 1:231.77 @ A3

SHEET NO: DA.9 DRAWN: AF ISSUE: DA DESIGN: JACARANDA

NOTIFICATION PLAN


185 CHURCH STREET, MUDGEE

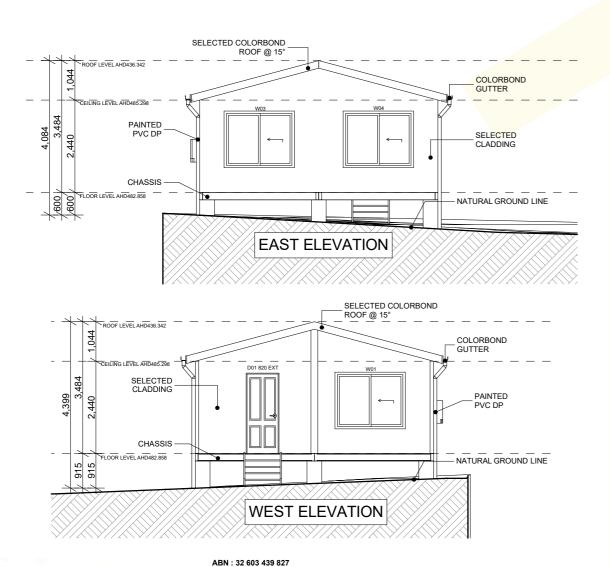




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SOUTH ELEVATION

Notification Plan

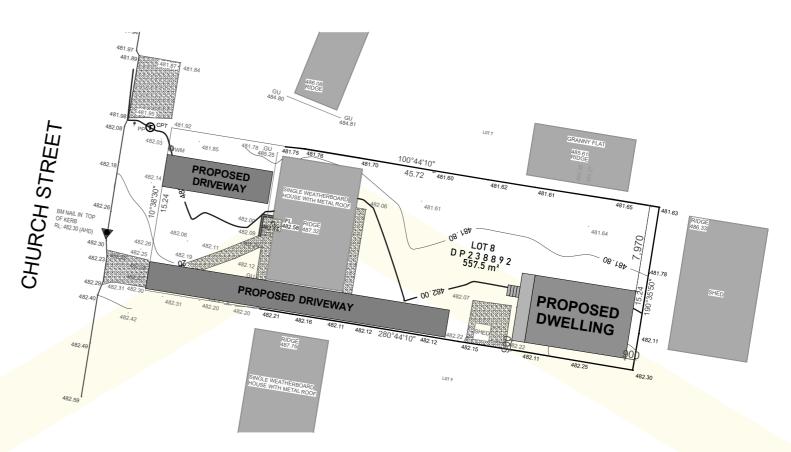- NATURAL GROUND LINE

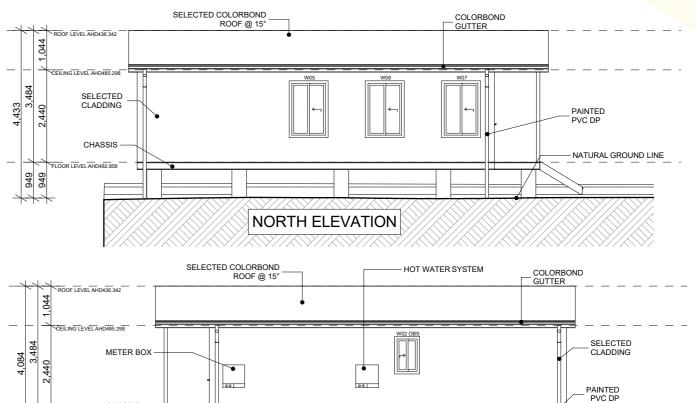JOB NUMBER: 202754 CLIENT: ATTARD

LOCATION: 185 CHURCH ST, MUDGEE LGA: MID-WESTERN REGIONAL COUNCIL

SCALE: 1:100, 1:350 @ A3 LOT/DP: 8/DP238892

DESIGN: JACARANDA