

PROPOSED SECONDARY DWELLING

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Phone (02) 4774 8388

Email: sales@hitechhomes.com.au

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SINGLE STOREY DWELLING **CLIENT PLAN APPROVAL**

Signed

LEGEND WC - WATER CLOSET HWS - HOT WATER SYSTEM

MB - METER BOX DP - DOWNPIPE SHR - SHOWER VTY - VANITY PTY - PANTRY

PTY - PANTRY
MW - MICROWAVE
SD - SMOKE DETECTOR
LDRY - LAUNDRY
BED - BEDROOM
PDR - POWDER ROOM
O/H - OVERHEAD CUPBOARDS
BAL - BUSHFIRE ATTACK LEVEL
CED - LASS SUIDING DOOR GSD - GLASS SLIDING DOOR EXT - EXIT RD - ROBE DOOR CSD - CAVITY SLIDING DOOR BC - BROOM CLOSET OBS - OSCURE WINDOV

TUB - LAUNDRY TUB WM - WASHING MACHINE

WM - WASHING MACHINE
CB - COLORBOND
LGA - LOCAL GOVERNMENT PLAN
WT - WINDOW TOP
WB - WINDOW BOTTOM
RL - RIDGE LINE
AHD - AUSTRALIAN HEIGHT DATUM
PP - POWER POLE
VEG - VEGETATION
EB - EDGE OF BITUMEN
BM - BENCH MARK
GUT - GUTTER
EXT - EXIT

GENERAL BUILDING NOTES

- THESE DRAWINGS ARE TO BE READ IN CONJUNCTION WITH SPECIFICATIONS PROVIDED.

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 ALL BOUNDARY CLEARANCES MUST BE VERIFIED BEFORE COMMENCEMENT OF BUILDING WORKS BY REGISTERED SURVEYOR.
- IN CASE OF ALTERATIONS OR DISCREPANCIES NOTIFY HITECH HOMES DESIGN OFFICE

Title Page


CLIENT: HEARN

JOB NUMBER: 202693

LOCATION: 87 HENRY BAYLY DRIVE, MUDGEE

LGA: MID-WESTERN REGIONAL COUNCIL LOT/DP: 2/DP1014531 SCALE: 1:103.49 @ A3

SHEET NO: DA.1 DRAWN: AF ISSUE: DA DESIGN: SNOW GUM REF NUMBER:

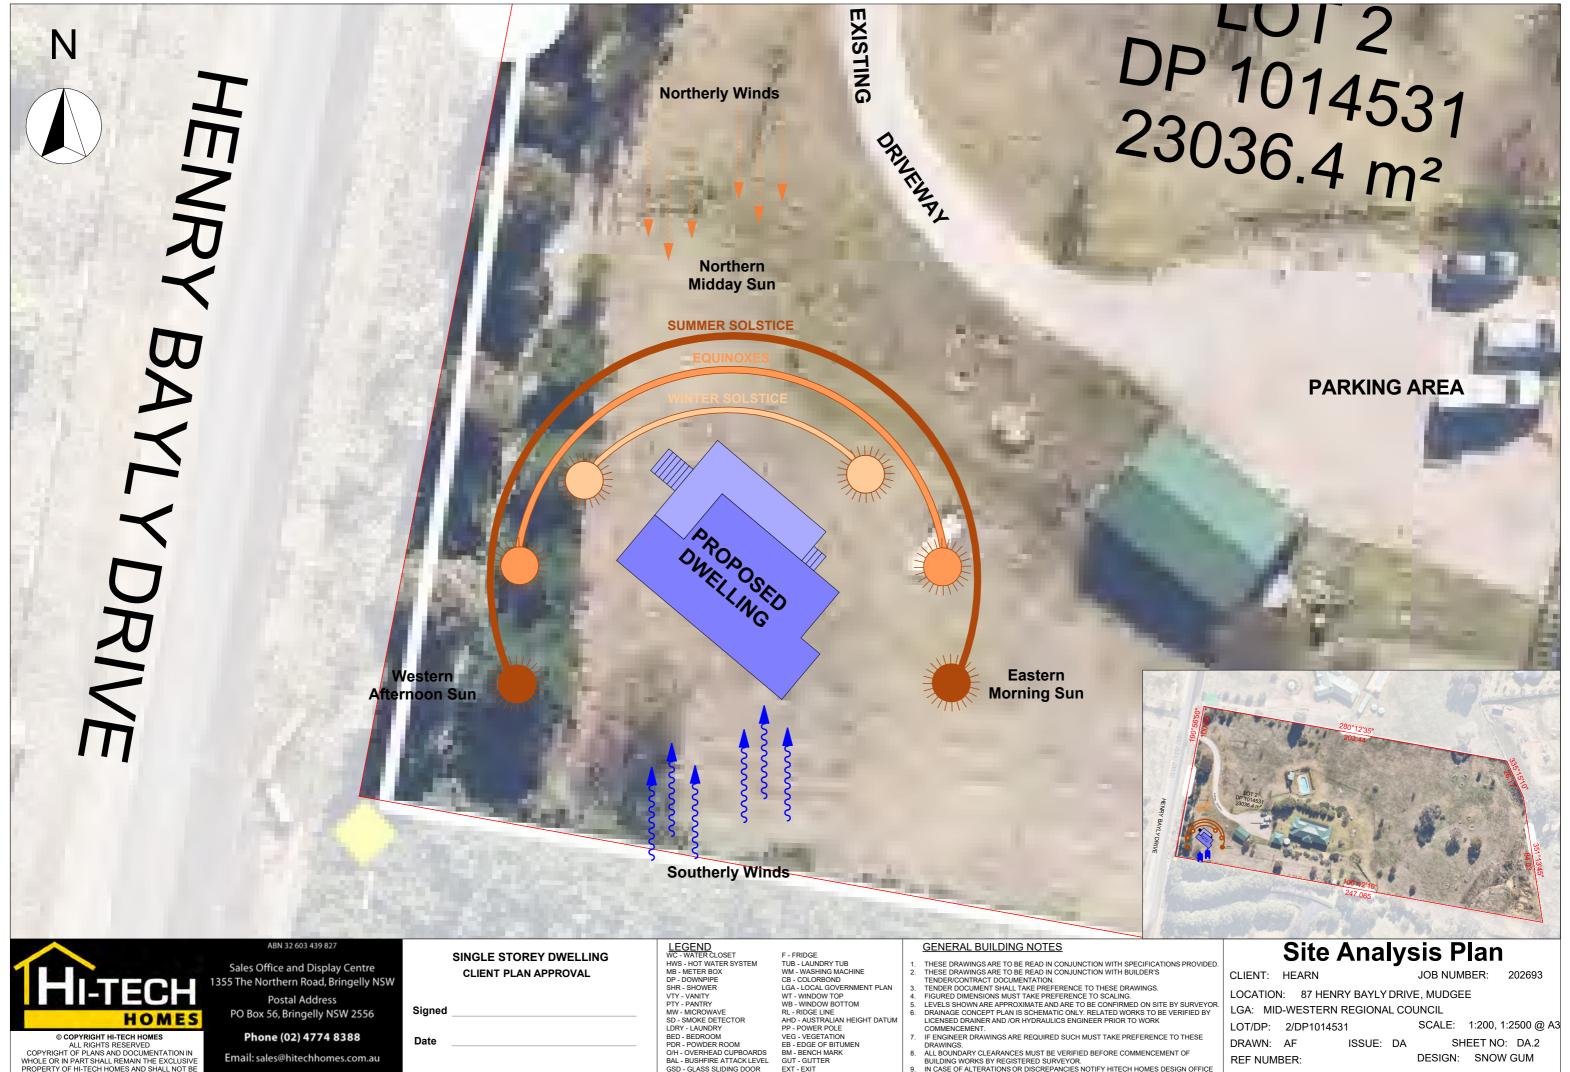

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BED - BEDROOM
PDR - POWDER ROOM
O/H - OVERHEAD CUPBOARDS
BAL - BUSHFIRE ATTACK LEVEL GSD - GLASS SLIDING DOOR FXT - FXIT


BC - BROOM CLOSET OBS - OSCURE WIND


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SHEET NO: DA.2

ISSUE: DA DESIGN: SNOW GUM REF NUMBER: DATE: Monday, 19 February 2024

DRAWN: AF



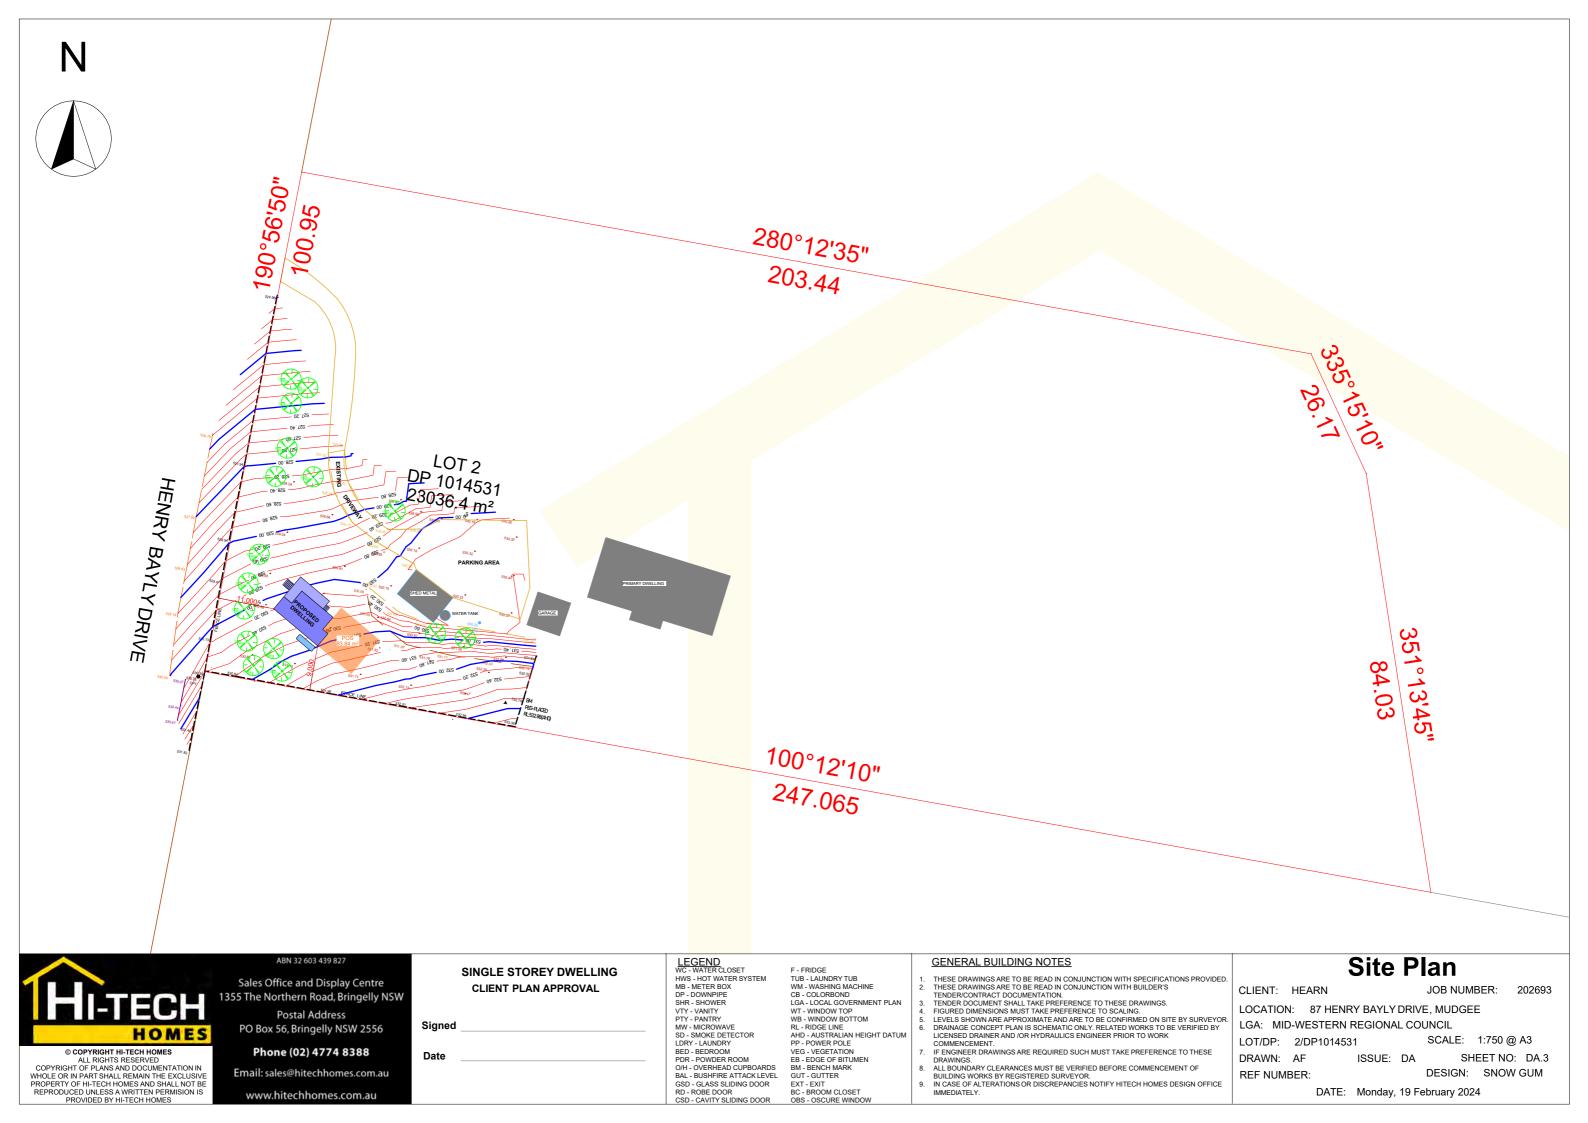


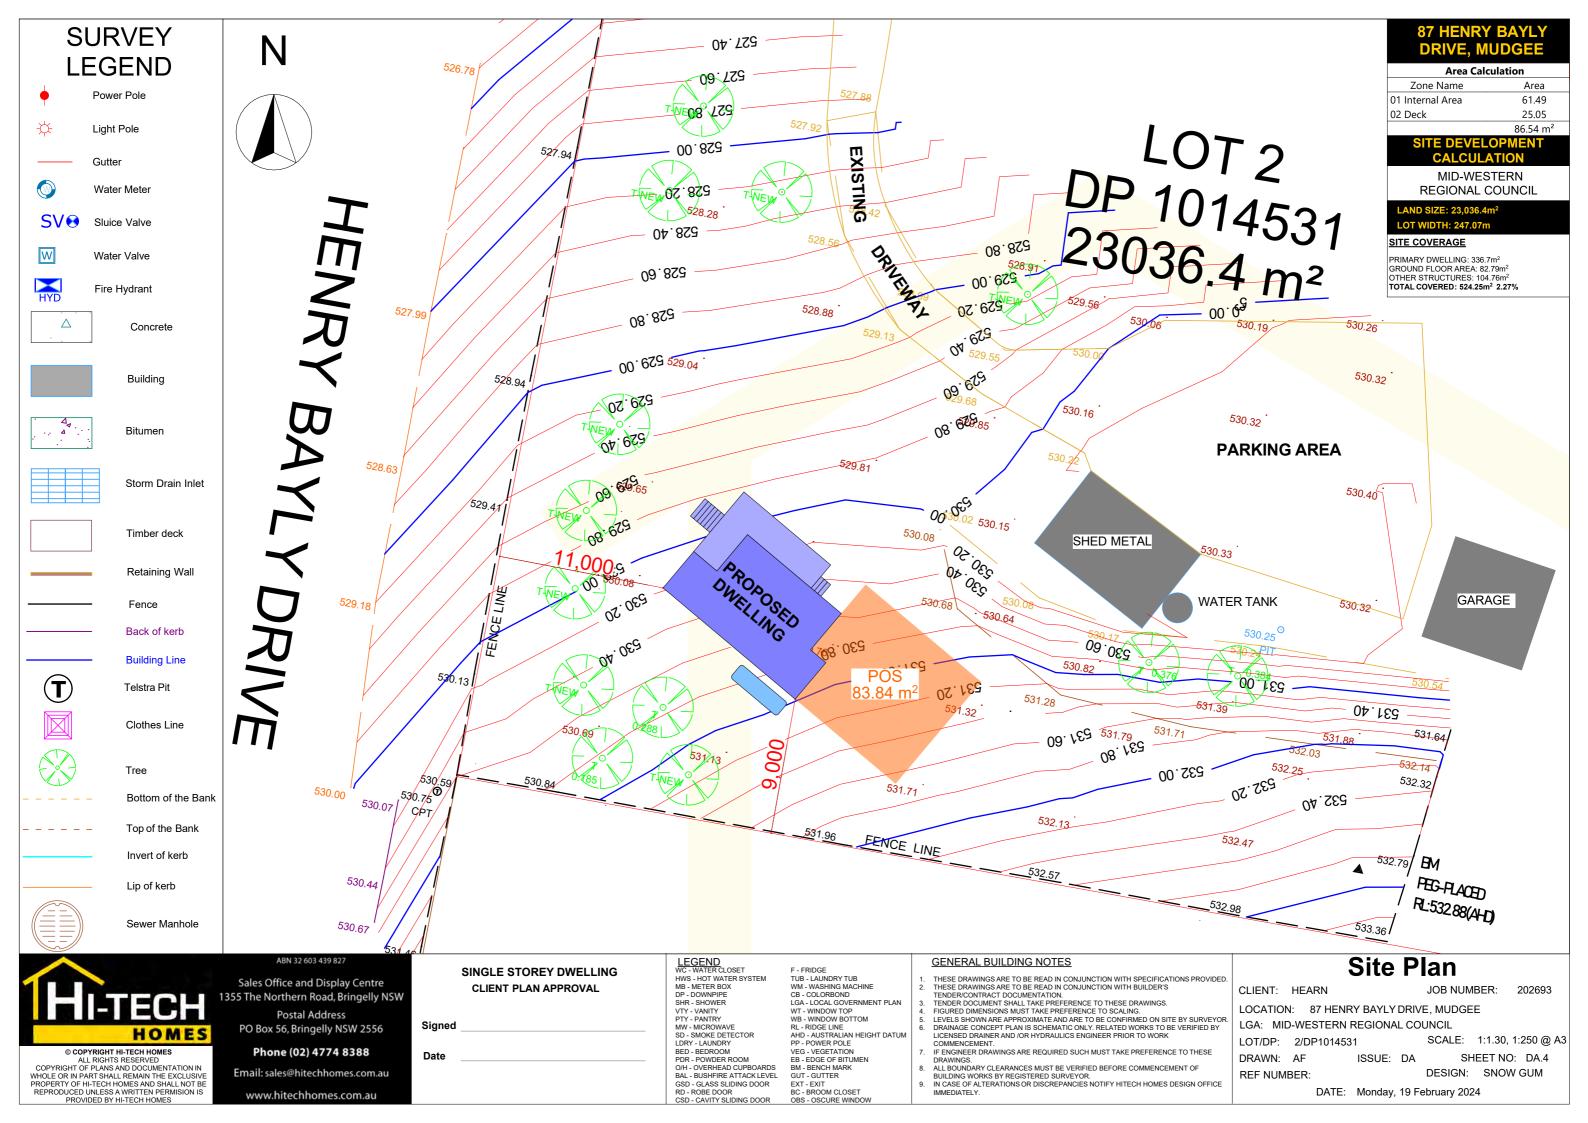LEGENDS


DESCRIPTION PROPOSED PIPES TO OUTLET PROPOSED NEW DOWNPIPE (Ø100 UNO)

GENERAL NOTES

- ALL LINES ARE TO BE Ø100 uPVC @ MIN 1% GRADE UNLESS NOTED OTHERWISE. CHARGED LINES TO BE SEWER GRADE & SEALED.
- IT IS THE CONTRACTOR'S RESPONSIBILITY TO LOCATE & LEVEL ALL EXISTING SERVICES PRIOR TO THE COMMENCEMENT OF ANY EARTHWORKS.
- ALL PIPES TO HAVE MINIMUM 150mm COVER IF LOCATED WITHIN 3. PROPERTY.
- ALL PITS IN LANDSCAPE AREAS TO BE 450 x 450 PLASTIC UNO. 4. AND ALL PITS IN DRIVEWAYS TO BE 450 x 450 CONCRETE UNO.
- PITS LESS THAN 600 DEEP MAY BE BRICK. PRECAST OR CONCRETE UNO.
- ALL BALCONIES AND ROOFS TO BE DRAINED AND TO HAVE SAFETY OVERFLOWS IN ACCORDANCE WITH RELEVANT AUSTRALIAN STANDARDS.
- ALL EXTERNAL SLABS TO BE WATERPROOFED. 7.
- ALL GRATES TO HAVE CHILD PROOF LOCKS.
- ALL DRAINAGE WORKS TO AVOID TREE ROOT ZONE.
- 10. ALL DP'S TO HAVE LEAF GUARDS.
- ALL EXISTING LEVELS TO TO BE CONFIRMED BY BUILDER PRIOR 11. TO CONSTRUCTION.
- 12. ALL WORKS WITHIN COUNCIL RESERVE TO BE INSPECTED BY COUNCIL PRIOR TO CONSTRUCTION.
- COUNCIL'S ISSUED FOOTWAY DESIGN LEVELS TO BE INCORPORATED INTO THE FINISHED LEVELS ONCE ISSUED BY COUNCIL.
- ALL WORKS SHALL BE IN ACCORDANCE WITH BCA AND AS3500.3.
- 15. EXISTING STORMWATER PIPE LOCATIONS HAVE BEEN ASSUMED. PLUMBER TO INSPECT PRIOR TO WORKS AND UPGRADE PIPES AS NECESSARY.

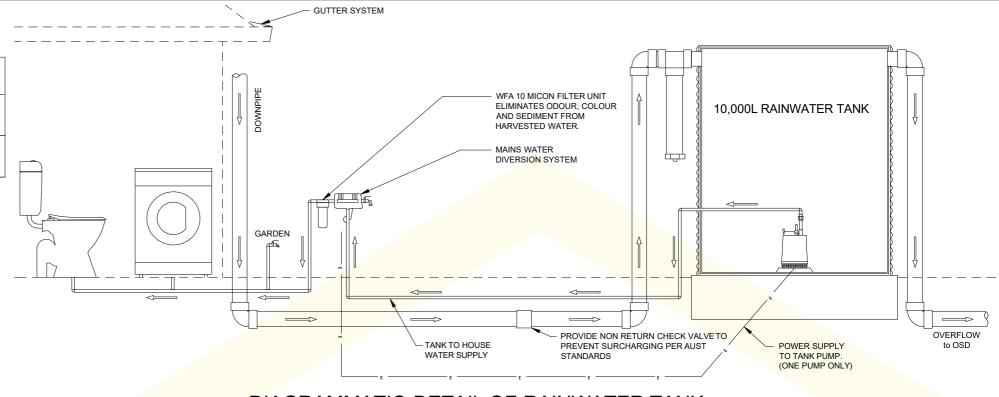

DIAGRAMMATIC DETAIL OF RAINWATER TANK

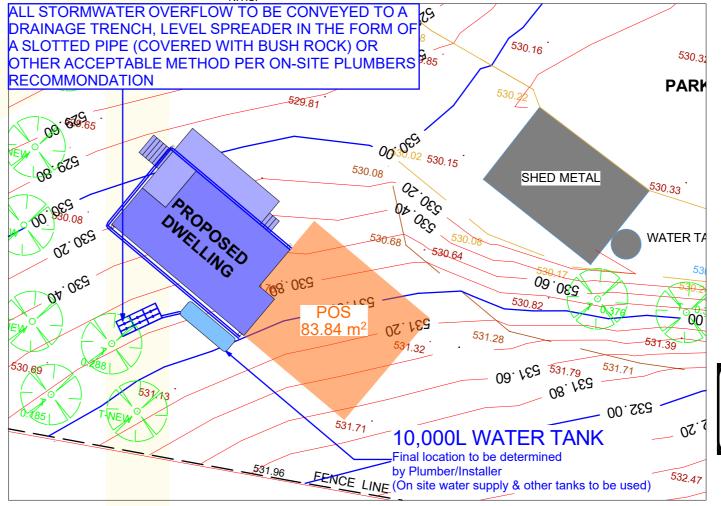



RAINWATER SUPPLY SIGN



202693

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Signed

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TUB - LAUNDRY TUB

- BROOM CLOSE

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Stormwater Plan

CLIENT: HEARN JOB NUMBER:

I OCATION: 87 HENRY BAYLY DRIVE, MUDGEE

LGA: MID-WESTERN REGIONAL COUNCIL

LOT/DP: 2/DP1014531 SCALE: 1:250 @ A3

SHEET NO: DA.5 DRAWN: AF ISSUE: DA DESIGN: SNOW GUM REF NUMBER:

LANDSCAPE LEGEND



TURF AREA



EXISTING DRIVEWAY



EXISTING STRUCTURES



PROPOSED STRUCTURES



EXISTING TREES/GARDENS

NOTE:


- All storm water outlets & surface run off shall be to Hydraulic Engineers detail.
- 3 Refer to survey plan for position of all existing services
- All landscape works shall comply with all councils DA & CC condit and all relevant "AUSTRALIAN STANDARDS" and AUS_SPEC NO.1 Specification C273—Landscaping.
- irrigation system If required, shall be designed & installed to com with AS 2698, AS 2698.1-1994, AS 2698.2-1985, AS 2698.3-1990,
- MAINTENANCE— All landscape works are to be maintained for a period of 12 weeks after final completion. Replace all plants which have falled with the some species. Mutch is to be maintained at specified depth. All plants and turf shall be watered on a regular basis to maintain moisture levels required for optimum growth. All garden areas are to be maintained free from weeks.

PLANT SCHEDULE

PLANT	SYMBOL	NAME	SIZE	POT	QTY
		HEBE BUXIFOLIA 'INSPIRATION (OR SIMILAR)	1.5 X 1.5	150MM	4
	*	PHORMIUM TENAX 'PURPUREN (OR SIMILAR)	1 X 1	150MM	4
	S. M. C.	DIANELLA (OR SIMILAR)	0.4 X 0.4	150MM	11
		CHAMAECYPARIS LAWSONIANA (OR SIMILAR)	2 X 1.5	25L	3
	STATE OF THE PARTY	BACKHOUSIA MYRTIFOLIA GREY MYRTLE	3 X 3	25L	3

LAY TURF IN STRETCHER PATTERN WITH CLOSE BUTT LIGHTLY TAMP TO AN EVEN BRICK GARDEN EDGE WITH 10mm MORTAR FLUSH JOINT SURFACE AFTER LAYING
AND WATER UNTIL TOPSOIL IS
MOISTENED TO ITS FULL DEPTH 100 DEPTH MULCH -100 TOPSOIL & FERTILISER MORTAR BED 3:1 - SAND : CEMENT MIX-(WDEN MORTAR JOINTS AS SUB-GRADE BROKEN SHAPE SUB-SOIL TO FALL TO SUB-SOIL DRAINS

1. TURF & GARDEN EDGE DETAIL

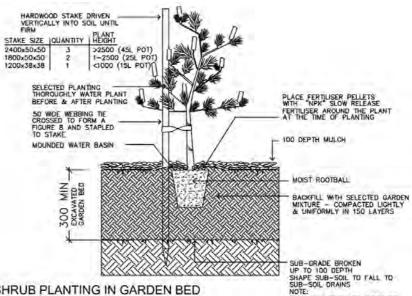

2. TREE & SHRUB PLANTING IN GARDEN BED

DO NOT PLANT IN UNSUITABLE WEATHER CONDITIONS SUCH AS EXTREME HEAT, COLD, WIND OR RAIN CLAY SOIL IS TO BE TREATED WITH CLAY BREAKER


87 HENRY BAYLY

Area Calculation			
Zone Name	Area		
01 Internal Area	61.49		
02 Deck	25.05		
	86 54 m ²		

MID-WESTERN REGIONAL COUNCIL

LANDSCAPED AREA

STRUCTURES: 524.25m² HARDSTAND AREAS: 610m2 LANDSCAPE AREA: 21,882.65m² 94.99%

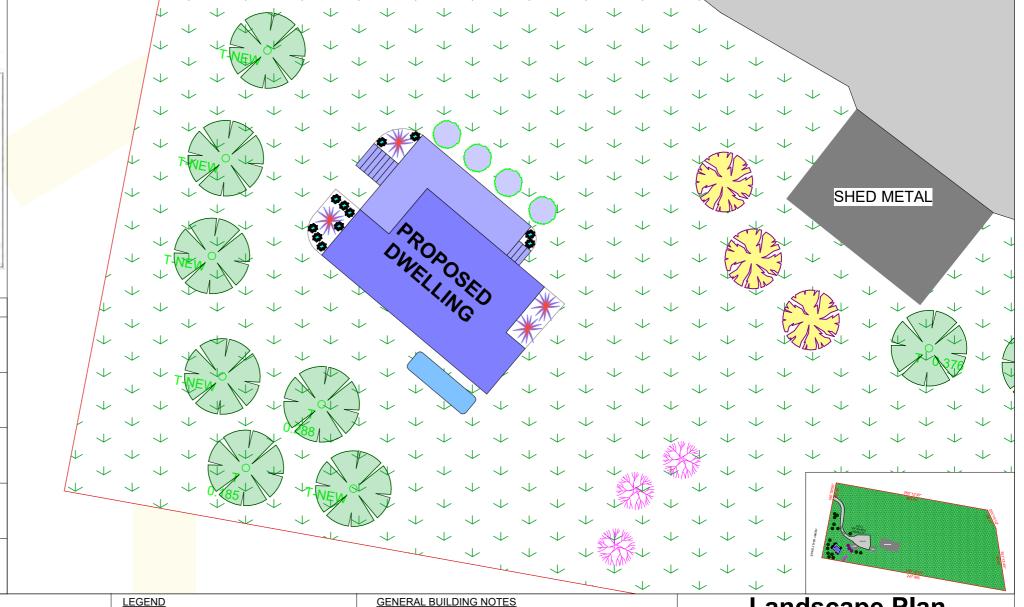

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AHD - AUSTRALIAN HEIGHT DATUM PP - POWER POLE VEG - VEGETATION EB - EDGE OF BITUM GUT - GUTTER FXT - FXIT - BROOM CLOSE

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Landscape Plan

202693

CLIENT: HEARN

LOCATION: 87 HENRY BAYLY DRIVE, MUDGEE

LGA: MID-WESTERN REGIONAL COUNCIL LOT/DP: 2/DP1014531 SCALE: 1:1.30, 1:200, 1:500

SHEET NO: DA.6 DRAWN: ISSUE: DA DESIGN: SNOW GUM

FULL SITE PLAN

SEDIEMT CONTROL FENCE LAYOUT

This is a Soil and Water Management Plan, and shows an acceptable way of managing soil erosion and water quality on the site. The Site Manager shall be responsible for implementation and management of the Soil and Water Management on the site.

This plan is to be read in conjunction with the DA and Engineering Plans, and any other plans written instructions, specification or documentation that may be issued relating to development of the site. Ensure that all soil and water management works are located as instructed by the Site Manager or as shown on the plans, specification or other relevant documentation.

All workers and sub-contractors shall be informed of their responsibilities in minimising the potential for soil erosion and pollution to downslope lands and waterways.

Water will be prevented from entering the permanent drainage system unless it is relatively sediment free, ie the catchment area has been permanently landscaped and/or any likely sediment has been filtered through or settled within an approved structure to meet environmental guidelines.

'Sediment' fencing and adjacent swales will be installed as indicated on the plans and at the direction of superintendent to ensure containment of sediment. The swales will outlet or overflow under stabilised conditions into the sediment basins, to safely convey water into a suitable filtering system should the pores in the fabric block.

Construct a new sediment basin (if indicated on plans) at the location shown and clean out the existing dams to act as a sediment basin during the construction period and beyond

Sediment basins shall have a minimum wet sediment capacity of 10 cubic metres and be designed with suitable overflow spillways to remain stable in at least the 1 in 10 year ARI (10% AEP), critical duration storm event.

In general, water shall not be released or pumped from sediment basins unless water quality complies with the 'Australian and New Zealand Guidelines for Fresh and Marine Water Quality' and in particular 50mg/L maximum suspended solids. Artificial flocculation to settle finer particles may be necessary in this instance. The basins are to be emptied within 48 hours after a storm event, but only after water has reached acceptable quality levels.


Stockpiles must not be located within 2m of hazard areas, including likely areas of concentrated or high velocity flows such as waterways, paved areas and driveways. Where they are between 2m and 5m metres from such areas, special sediment control measures should be taken to minimise possible pollution to downslope waters, e.g. through installation of additional 'sediment' fencing and bunds around the stockpiles.


Regular checking and maintenance of the measures to ensure the integrity of the installed measures.








TECHNIQUES

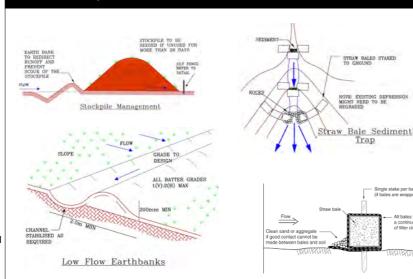

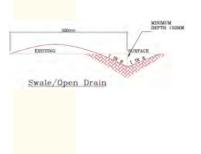


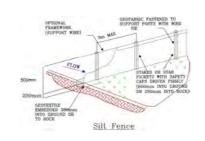

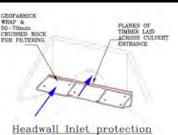

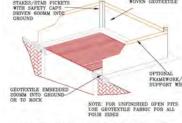

Grated/Unfinished Pit Protection

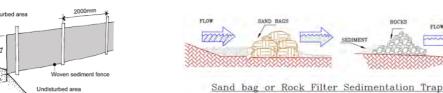



JOB NUMBER:

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Signed

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GENERAL BUILDING NOTES

COMMENCEMENT

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Sediment Control Plan

LOCATION: 87 HENRY BAYLY DRIVE, MUDGEE

LGA: MID-WESTERN REGIONAL COUNCIL

CLIENT: HEARN


LOT/DP: 2/DP1014531 SCALE: 1:250, 1:2000 @ A3 SHEET NO: DA.7 DRAWN: AF ISSUE: DA


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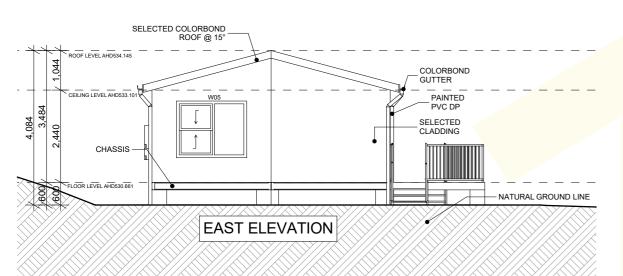
DATE: Monday, 19 February 2024




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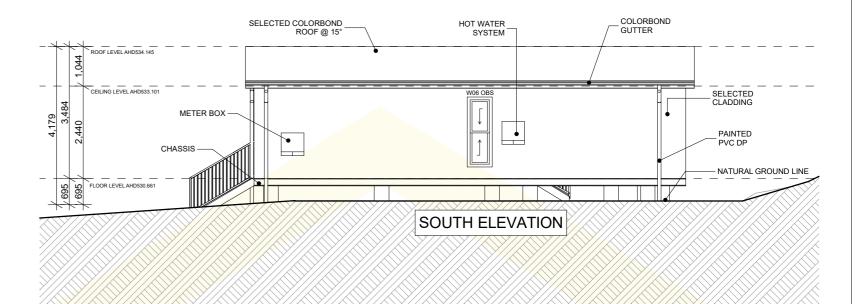
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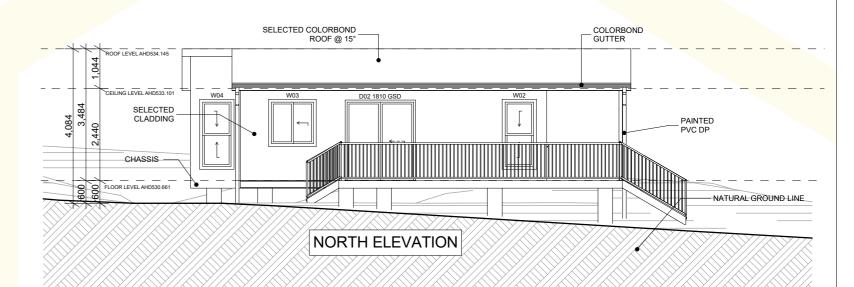
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-	Door List				
	Door ID	Width	Height	Quantity	
-	D01 820 EXT	820	2,100	1	
	D02 1810 GSD	1,810	2,100	1	
	D03 820	820	2,040	1	
L	D04 820	820	2,040	1	
	D05 820	820	2,040	1	
>	D06 820	820	2,040	1	
//	D07 1930 RD	1,930	2,100	1	
<	D08 1930 RD	1,930	2,100	1	
×,				8	

Window List						
Window ID	Width	Height	Head Height	Quantity		
W01	1,210	1,450	2,100	1		
W02	850	1,800	2,100	1		
W03	1,210	1,200	2,100	1		
W04	850	1,800	2,100	1		
W05	1,810	1,450	2,100	1		
W06 OBS	610	1,800	2,100	1		
W07	1,810	1,450	2,100	1		
				7		
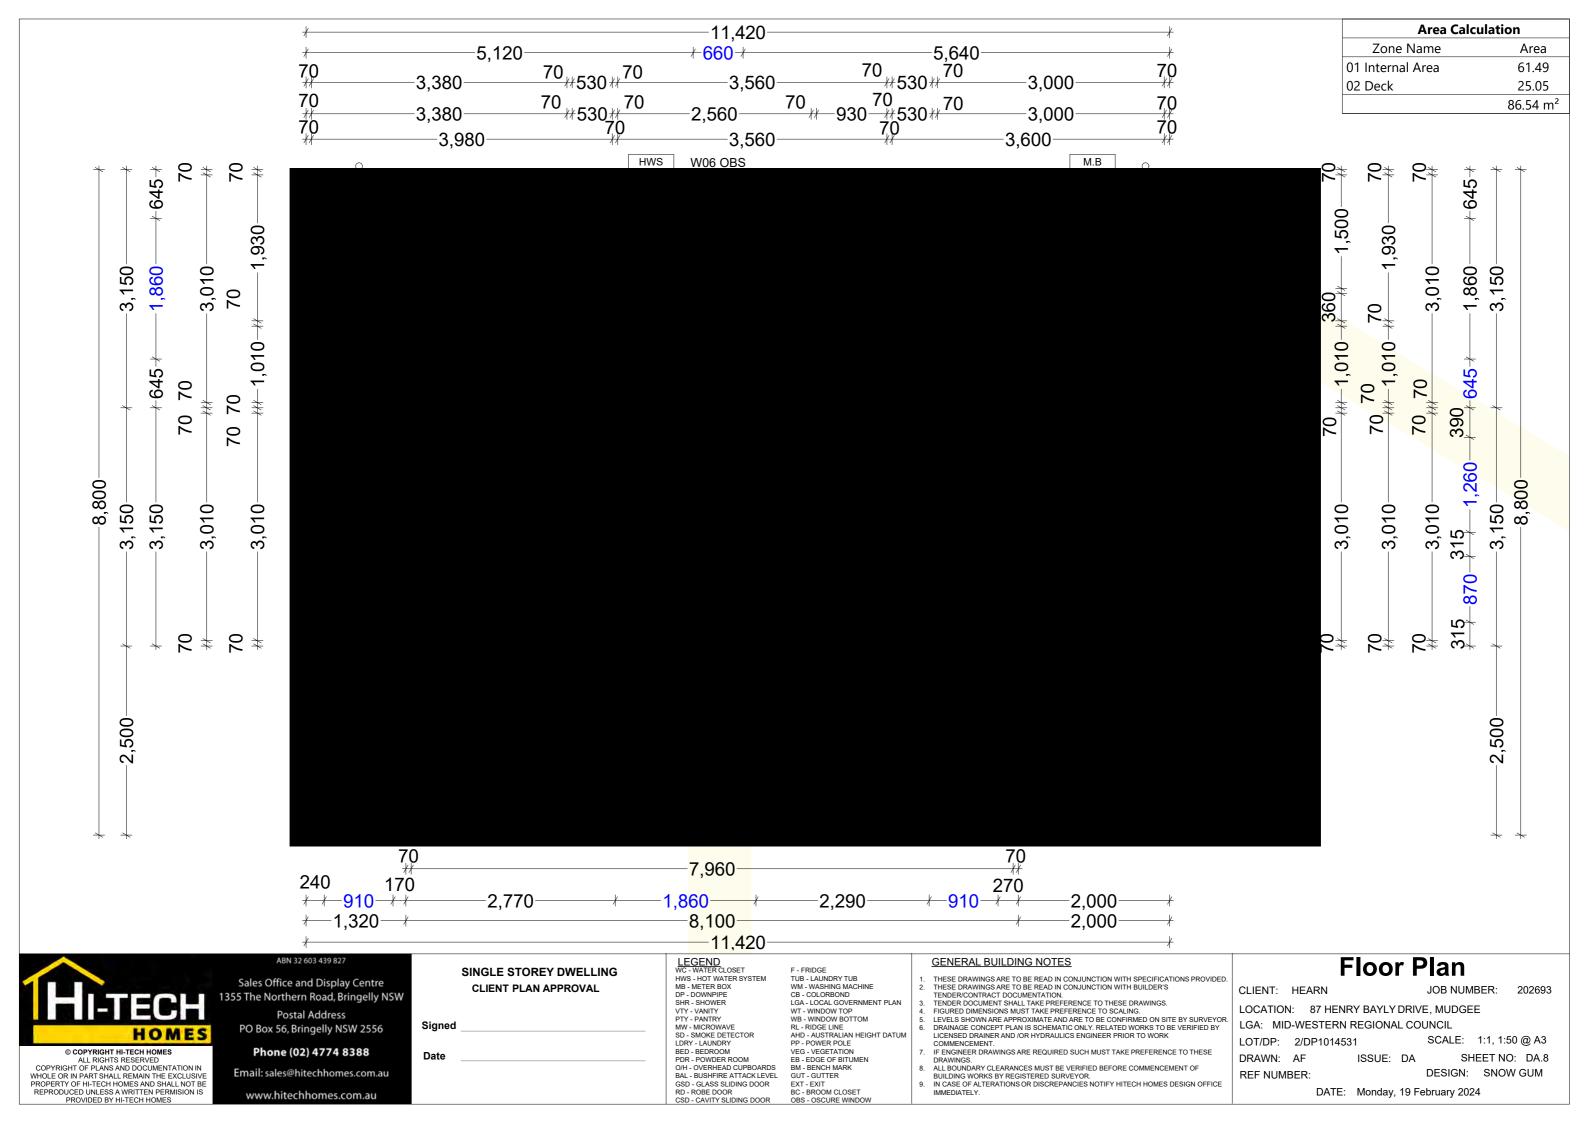
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Elevations/Section

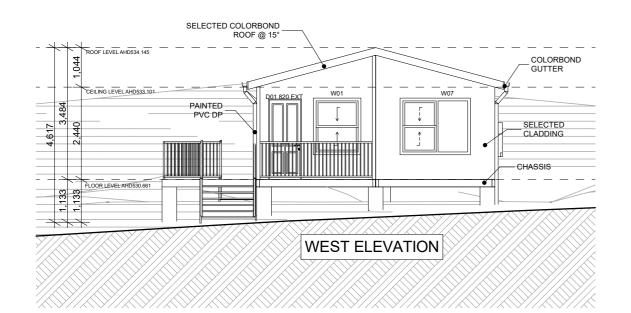CLIENT: HEARN JOB NUMBER: 202693

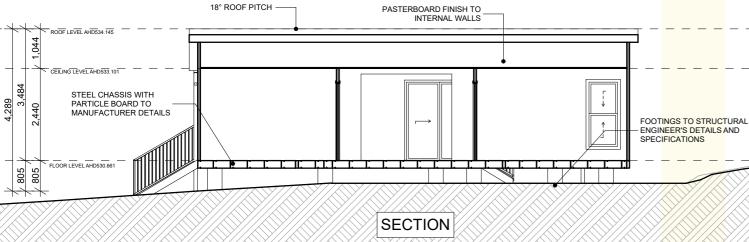REF NUMBER:

LOCATION: 87 HENRY BAYLY DRIVE, MUDGEE

LGA: MID-WESTERN REGIONAL COUNCIL

LOT/DP: 2/DP1014531 SCALE: 1:1, 1:100 @ A3 SHEET NO: DA.9 DRAWN: AF ISSUE: DA

DESIGN: SNOW GUM

EXTERNAL COLOUR PLAN





LEGEND

- ROOF: COLORBOND CORRUGATED 762 CB COTTAGE GREEN
- **GUTTER: CB COTTAGE GREEN** 2)
- **FASCIA: CB DOVER WHITE**
- 4) DOWNPIPES: CB SOUTHERLY
- 5) CLADDING: COLORBOND STEEL CLAD 762 - CB SOUTHERLY
- WINDOWS & FLYSCREENS: CB DOVER WHITE 6)
- 7) ENTRY DOOR: HUME VAUCLUSE XV14 - TB WHISPER WHITE
- 8) HANDRAILS: TIMBER VERTICAL - CB DOVER WHITE
- 9) **DECKING: HARDWOOD MERBAU**

JOB NO: 202693

SITE ADDRESS: MID-WESTERN REGIONAL, MUDGEE

CLIENT: HEARN

The colours shown represent actual product colours as accurately as possible. However, we recommend checking your chosen colours against an actual sample of the products before purchasing, as varying screens and devices may affect colour tones and finishes.

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SINGLE STOREY DWELLING **CLIENT PLAN APPROVAL**

Signed

LEGEND WC - WATER CLOSET HWS - HOT WATER SYSTEM

MB - METER BOX SHR - SHOWER VTY - VANITY PTY - PANTRY MW - MICROWAVE SD - SMOKE DETECTOR

LDRY - LAUNDRY BED - BEDROOM
PDR - POWDER ROOM
O/H - OVERHEAD CUPBOARDS
BAL - BUSHFIRE ATTACK LEVEL GSD - GLASS SLIDING DOOR

TUB - LAUNDRY TUB WM - WASHING MACHINE CB - COLORBOND

LGA - LOCAL GOVERNMENT PLAN WT - WINDOW TOP WB - WINDOW BOTTOM RL - RIDGE LINE AHD - AUSTRALIAN HEIGHT DATUM PP - POWER POLE VEG - VEGETATION EB - EDGE OF BITUMEI BM - BENCH MARK

GUT - GUTTER

BC - BROOM CLOSET OBS - OSCURE WIND

FXT - FXIT

GENERAL BUILDING NOTES

- THESE DRAWINGS ARE TO BE READ IN CONJUNCTION WITH SPECIFICATIONS PROVIDED. THESE DRAWINGS ARE TO BE READ IN CONJUNCTION WITH SPECIFICATIONS PROVIDED. THESE DRAWINGS ARE TO BE READ IN CONJUNCTION WITH BUILDER'S TENDER/CONTRACT DOCUMENTATION. TENDER DOCUMENT SHALL TAKE PREFERENCE TO THESE DRAWINGS. FIGURED DIMENSIONS MUST TAKE PREFERENCE TO SCALING. LEVELS SHOWN ARE APPROXIMATE AND ARE TO BE CONFIRMED ON SITE BY SURVEYOR.

- DRAINAGE CONCEPT PLAN IS SCHEMATIC ONLY, RELATED WORKS TO BE VERIFIED BY LICENSED DRAINER AND /OR HYDRAULICS ENGINEER PRIOR TO WORK
- IF ENGINEER DRAWINGS ARE REQUIRED SUCH MUST TAKE PREFERENCE TO THESE DRAWINGS.
 ALL BOUNDARY CLEARANCES MUST BE VERIFIED BEFORE COMMENCEMENT OF
- IN CASE OF ALTERATIONS OR DISCREPANCIES NOTIFY HITECH HOMES DESIGN OFFICE

External Colours

CLIENT: HEARN

JOB NUMBER: 202693

DESIGN: SNOW GUM


LOCATION: 87 HENRY BAYLY DRIVE, MUDGEE


LGA: MID-WESTERN REGIONAL COUNCIL


LOT/DP: 2/DP1014531 SCALE: 1:237.61 @ A3 SHEET NO: DA.10 DRAWN: AF ISSUE: DA

NOTIFICATION PLAN

87 HENRY BAYLY DRIVE, MUDGEE

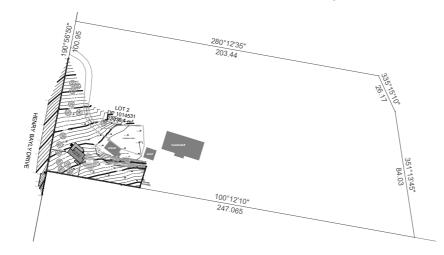

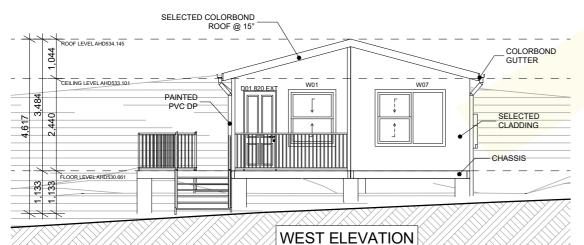

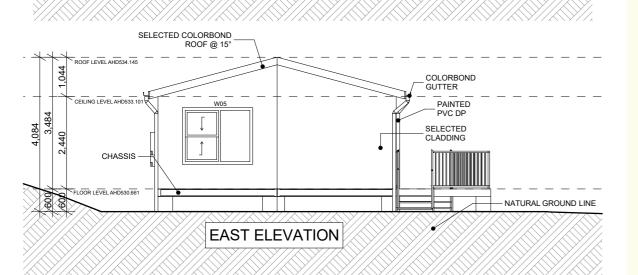




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Notification Plan

CLIENT:

JOB NUMBER: 202693

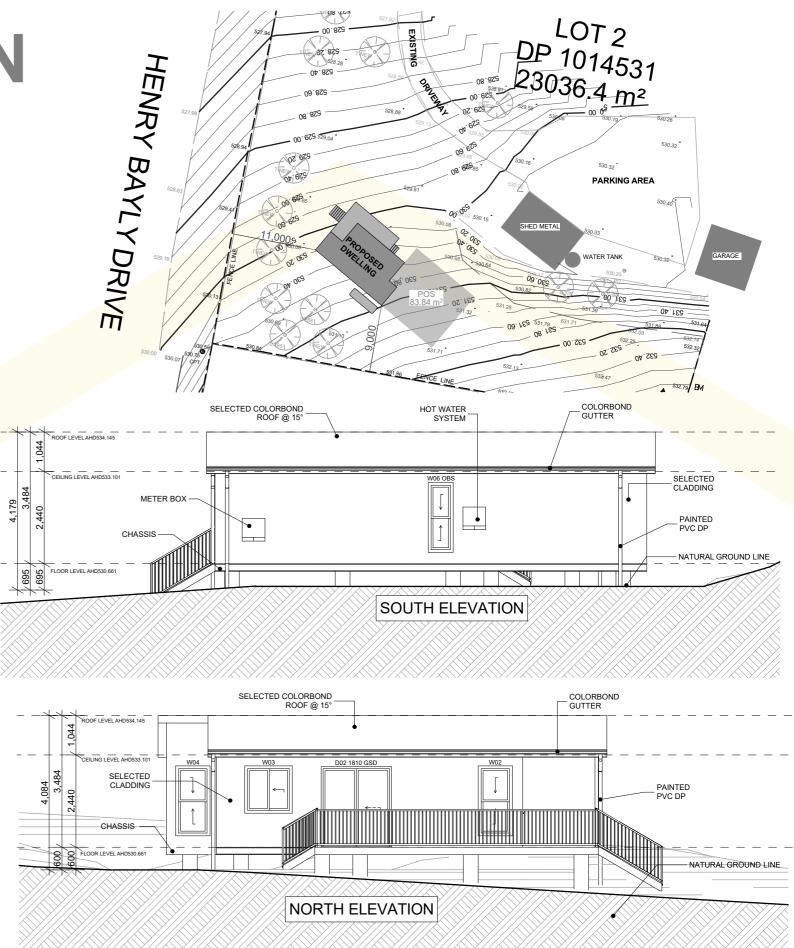LOCATION: 87 HENRY BAYLY DRIVE, MUDGEE

LGA: MID-WESTERN REGIONAL COUNCIL

SCALE: 1:100, 1:500, 1:2500 LOT/DP: 2/DP1014531

DESIGN: SNOW GUM