
PROPOSED NEW RESIDENCE FOR:

GAI DOBSON

LOT 6 DP793799, **11 COOMBER STREET,** RYLSTONE, NSW 2849

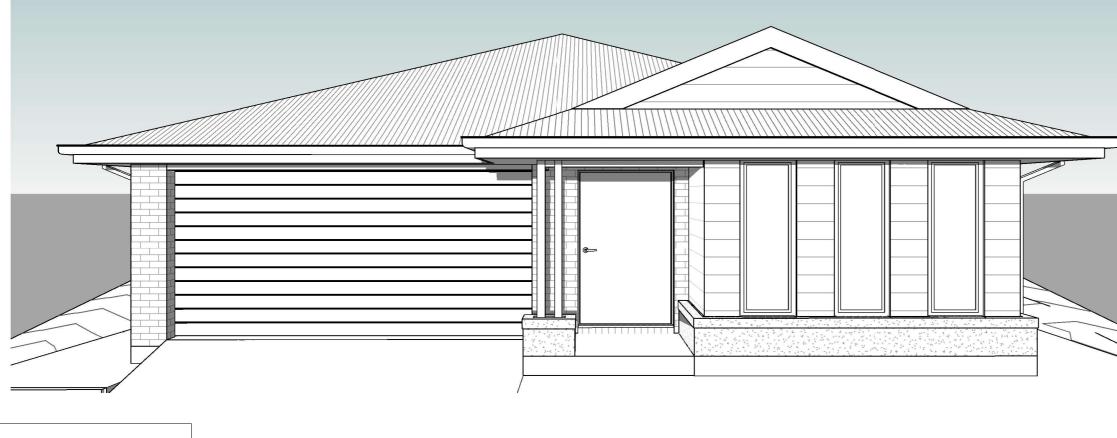



SHEET LIST							
SHEET NAME							
COVER SHEET							
SITE PLAN							
FLOOR PLAN							
ELEVATIONS							
SECTIONS							
BRICKWORK SETOUT							
SLAB LAYOUT							
PERSPECTIVES							
ELECTRICAL PLAN							
KITCHEN DETAILS							
WET AREA DETAILS							
WET AREA DETAILS							

				HOTONDO HOMES		CLIENT	PROPOSED NEW RESIDENCE FOR GAI DOBSON	PLAN	
				FOREVER		DATE////	AT LOT 6 DP793799,	FACADE	
B	AMENDMENTS	VN-JE	12/01/24	RETREAT	Hotondo	BUILDER			IEO
A	WORKING DRAWINGS	VN-JE	12/12/23	• Jorever part of your journey •	Homes		11 COOMBER STREET,	TITLE	
Rev	Amendment	Drawn	Date			DATE////	RYLSTONE, NSW 2849		

SPECIFICATIONS GENERAL

- IT IS RESPONSIBILITY OF BUILDER TO VERIFY ALL DOCUMENTS - AS TO THEIR ACCURACY AND SUITABILITY - PLANS TO BE READ IN CONJUNCTION WITH ENGINEER'S DETAILS

WHERE APPLICABLE - NCC - NATIONAL CONSTRUCTION CODE - VOLUME 2 - HOUSING

PROVISIONS STATUTORY REQUIREMENTS

- ALL WORK TO BE CARRIED OUT IN ACCORDANCE WITH THE NCC CONDITIONS IMPOSED BY LOCAL AUTHORITY, & COMMITMENTS

NOTED IN RELEVANT BASIX CERTIFICATE - THE BUILDER IS TO COMPLY WITH REQUIREMENTS OF ALL LEGALLY CONSTITUTED AUTHORITIES HAVING JURISDICTION OVER BUILDING WORKS AND PROVISIONS OF THE HOME BUILDING ACT. - BUILDER SHALL PROVIDE TEMPORARY TOILET FACILITIES FOR THE USE OF THE SUBCONTRACTORS

NCC REQUIREMENTS

ALL EARTHWORKS SHALL BE IN ACCORDANCE WITH ENGINEER'S DETAILS & PART 3.1.1 OF NCC. ALL EXCAVATIONS & UNDERFLOOR FILL SHALL BE IN ACCORDANCE WITH ENGINEER'S DETAILS & PART 3 2 2 OF NCC

- PRIMARY BUILDING ELEMENTS TO BE PROTECTED FROM SUBTERRENEAN TERMITES IN ACCORDANCE WITH PART 3.1.4 OF NCC PROVIDE ADEQUATE CROSS VENTILATION TO SPACE UNDER SUSPENDED GROUND FLOORS IN ACCORDANCE WITH

PART 3.4.1 OF NCC - STORMWATER DRAINAGE SHALL BE CARRIED OUT IN ACCORDANCE WITH PART 3.1.3 OF NCC - ALL TIMBER FRAMEWORK SHALL COMPLY WITH PART 3.4.1 OF NCC

OR AS1684 - ROOF TRUSSES SHALL BE DESIGNED IN ACCORDANCE WITH AS1720

& INSTALLED IN ACCORDANCE TO MANUFACTURER'S SPECIFICATIONS - STRIP & SHEET FLOORING SHALL BE INSTALLED IN ACCORDANCE WITH AS1684 - STEEL FRAMING SHALL BE IN ACCORDANCE WITH MANUFACTURER'S

SPECIFICATIONS & PART 3.4.2 OF NCC - ALL ROOF CLADDING SHALL COMPLY WITH PART 3.5.1 OF NCC, &

INSTALLED IN ACCORDANCE TO MANUFACTURER'S SPECIFICATIONS - GUTTERS & DOWNPIPES SHALL BE IN ACCORDANCE WITH PART 3.5.3 OF NCC

SARKING SHALL COMPLY WITH AS/NZS4200.1 & 2

- FLASHING SHALL COMPLY WITH EITHER AS4773 OR AS3700 - CLAY BRICK WORK SHALL COMPLY WITH EITHER AS4773 OR AS3700 - CONCRETE BLOCK WORK SHALL BE CONSTRUCTED IN ACCORDANCE

WITH EITHER AS4773 OR AS3700 - AUTOCLAVED AERATED CONCRETE PRODUCTS SHALL E INSTALLED IN ACCORDANCE WITH MANUFACTURER'S SPECIFICATIONS AS 5416.1 - DAMP PROOF COURSES & CAVITY VENTILATION SHALL COMPLY WITH EITHER AS4773 OR AS3700 - MORTAR & JOINT TOLERANCES SHALL BE IN ACCORDANCE WITH

FITHER AS4773 OR AS3700

- MASONRY ACCESSORIES SHALL COMPLY WITH EITHER AS4773 OR AS3700 APPROPRIATE TIES SHALL BE PROVIDED TO ARTICULATED MASONRY JOINTS

- LINTELS USED TO SUPPORT BRICKWORK OVER OPENINGS & BE PROTECTED FROM CORROSION SHALL COMPLY WITH EITHER AS4773 OR AS3700

- MASONRY VENEER SHALL COMPLY WITH PART 3.3.5 OF NCC - ENGAGED PIERS IN SINGLE LEAF MASONRY WALLS SHALL BE

CONSTRUCTED IN ACCORDANCE WITH EITHER AS4773 OR AS3700 - INTERNAL WET AREAS & BALCONIES OVER HABITABLE ROOMS TO BE WATERPROOFED IN ACCORDANCE WITH PART 3.8.1 OF NCC. WET AREA WALL LINING TO BE FIXED IN ACCORDANCE WITH MANUFACTURER'S SPECIFICATIONS - ALL TIMBER DOOR & DOOR SETS SHALL BE MANUFACTURED IN

ACCORDANCE WITH AS2688 & AS2689 UNLESS NOTED OTHERWISE IN THE SCHEDULE OF WORKS

- WINDOWS & DOORS SHALL BE MANUFACTURED & INSTALLED IN ACCORDANCE WITH AS 2047

ACCORDANCE WITH AS 200 WITH A STATE ACCORDANCE WITH A STATE & RAMP CONSTRUCTION SHALL BE IN ACCORDANCE WITH PART

3.9.1 OF NCC

- BALUSTRADES SHALL BE IN ACCORDANCE WITH PART 3.9.2 OF NCC - ALL PLUMBING SHALL COMPLY WITH REQUIREMENTS OF RELEVANT SUPPLY AUTHORITY & AS3500, & BE CARRIED OUT BY A LICENSED PLUMBER - ALL ELECTRICAL WORK SHALL COMPLY WITH REQUIREMENTS OF RELEVANT SUPPLY AUTHORITY & AS3000 & BE CARRIED OUT BY LICENSED ELECTRICIAN

-ALL GAS INSTALLATIONS SHALL COMPLY WITH REQUIREMENTS OF RELEVANT SUPPLY AUTHORITY, & BE CARRIED OUT BY A LICENSED GAS FITTER

- PROVIDE & INSTALL HARD WIRED SMOKE ALRAMS IN ACCORDANCE WITH AS3786 & PART 3.7.5 OF NCC - INSTALLATION OF WALL & FLOOR TILES SHALL BE IN ACCORDANCE WITH

A\$3958.1 - BUILDING TO BE SEALED TO THE REQUIREMENTS OF PART 3.12.3 OF NCC,

INCLUDING CHIMNEY'S, FLUES, ROOF LIGHTS, EXTERNAL WINDOWS & DOORS, EXHAUST FANS, ROOF, WALLS, & FLOORS.

- SERVICES ARE TO BE INSTALLED TO THE REQUIREMENTS OF QLD PART 3.12.5 OF BCA, INCLUDING HOT WATER SUPPLY, INSULATION OF SERVICES, CENTRAL HEATING WATER PIPING, HEATING & COOLING DUCTWORK MECHANICAL VENTILATION IS TO BE INSTALLED IN ACCORDANCE WITH PART 3.8.5 OF NCC


- INWARD SWINGING WC DOORS ARE TO BE FITTED WITH LIFT OFF HINGES TO COMPLY WITH PART 3.8.3.3 OF NCC


- CONDENSATION MANAGEMENT TO COMPLY WITH PART 3.8.7 OF NCC - FIRE HAZARD PROPERTIES TO COMPLY WITH PART 3.7.1.2 OF NCC

- WALL CLADDING TO COMPLY WITH PART 3.5.4 OF NCC


	SCALE	
APSLEY 162 MOD.	SHEET SIZE	A3
DRAWING STAGE:	DATE	12/01/24
PRELIMINARY	DRAWN	VN-JE
COVER SHEET	JOB No. 00-000	DWG No. 00



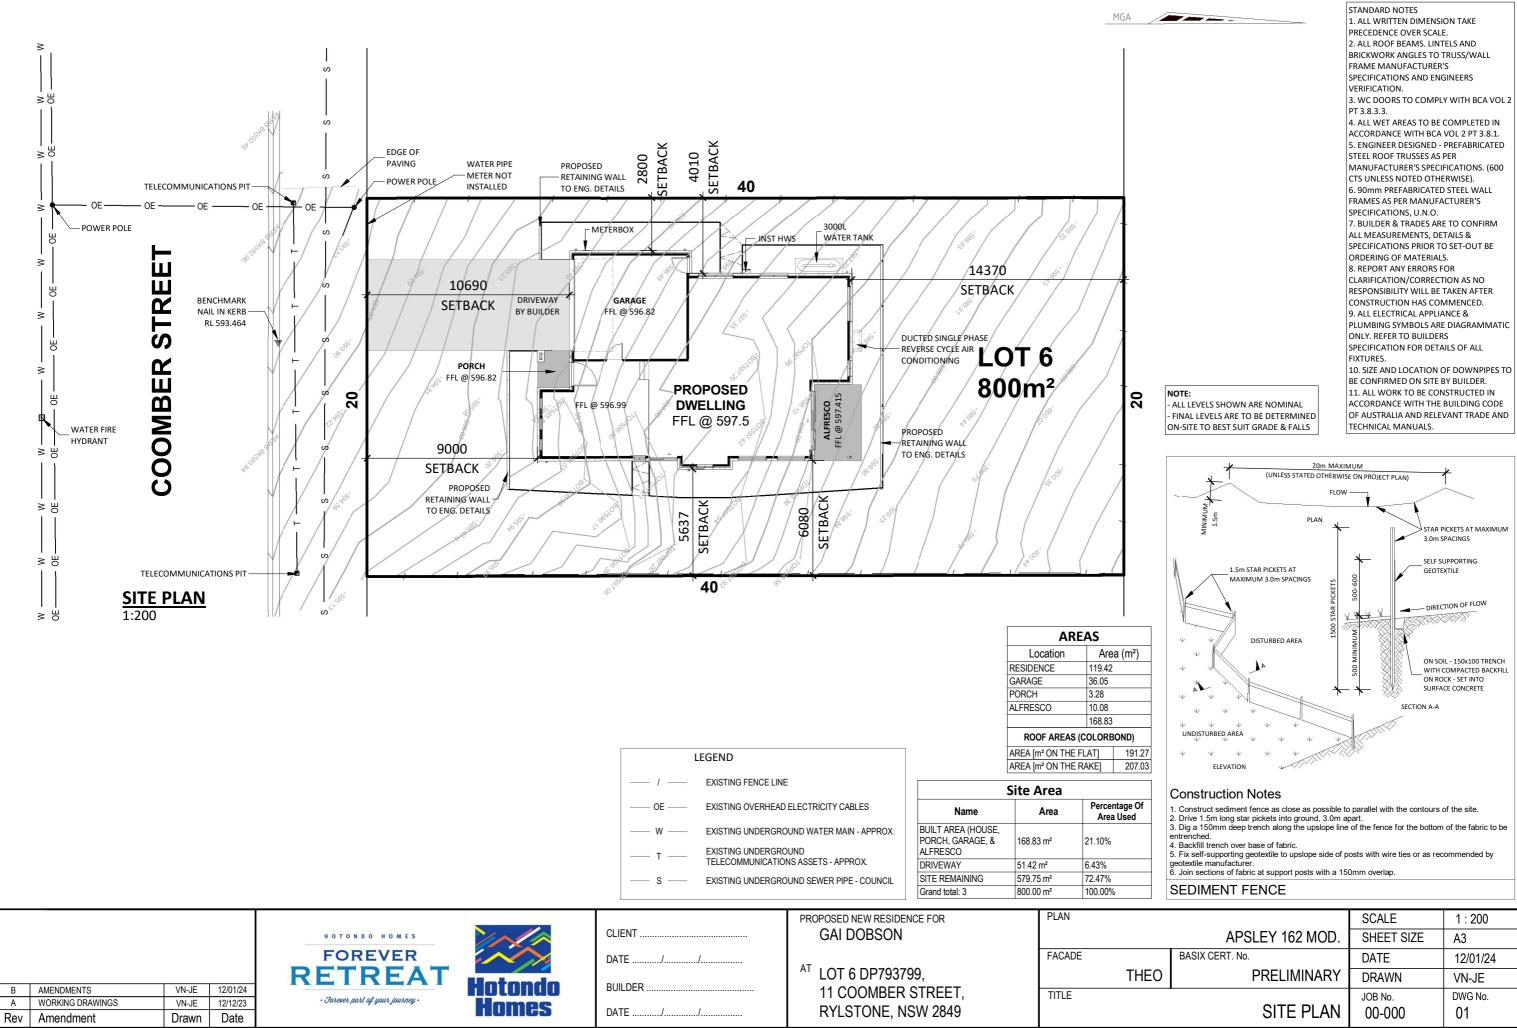

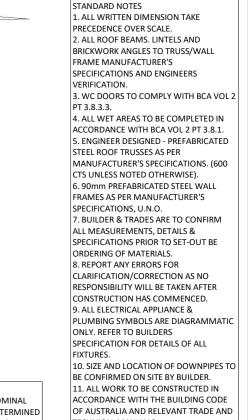

		SCALE	1 : 200
	APSLEY 162 MOD.	SHEET SIZE	A3
	BASIX CERT. No.	DATE	12/01/24
)	PRELIMINARY	DRAWN	VN-JE
		JOB No.	DWG No.
	SITE PLAN	00-000	01

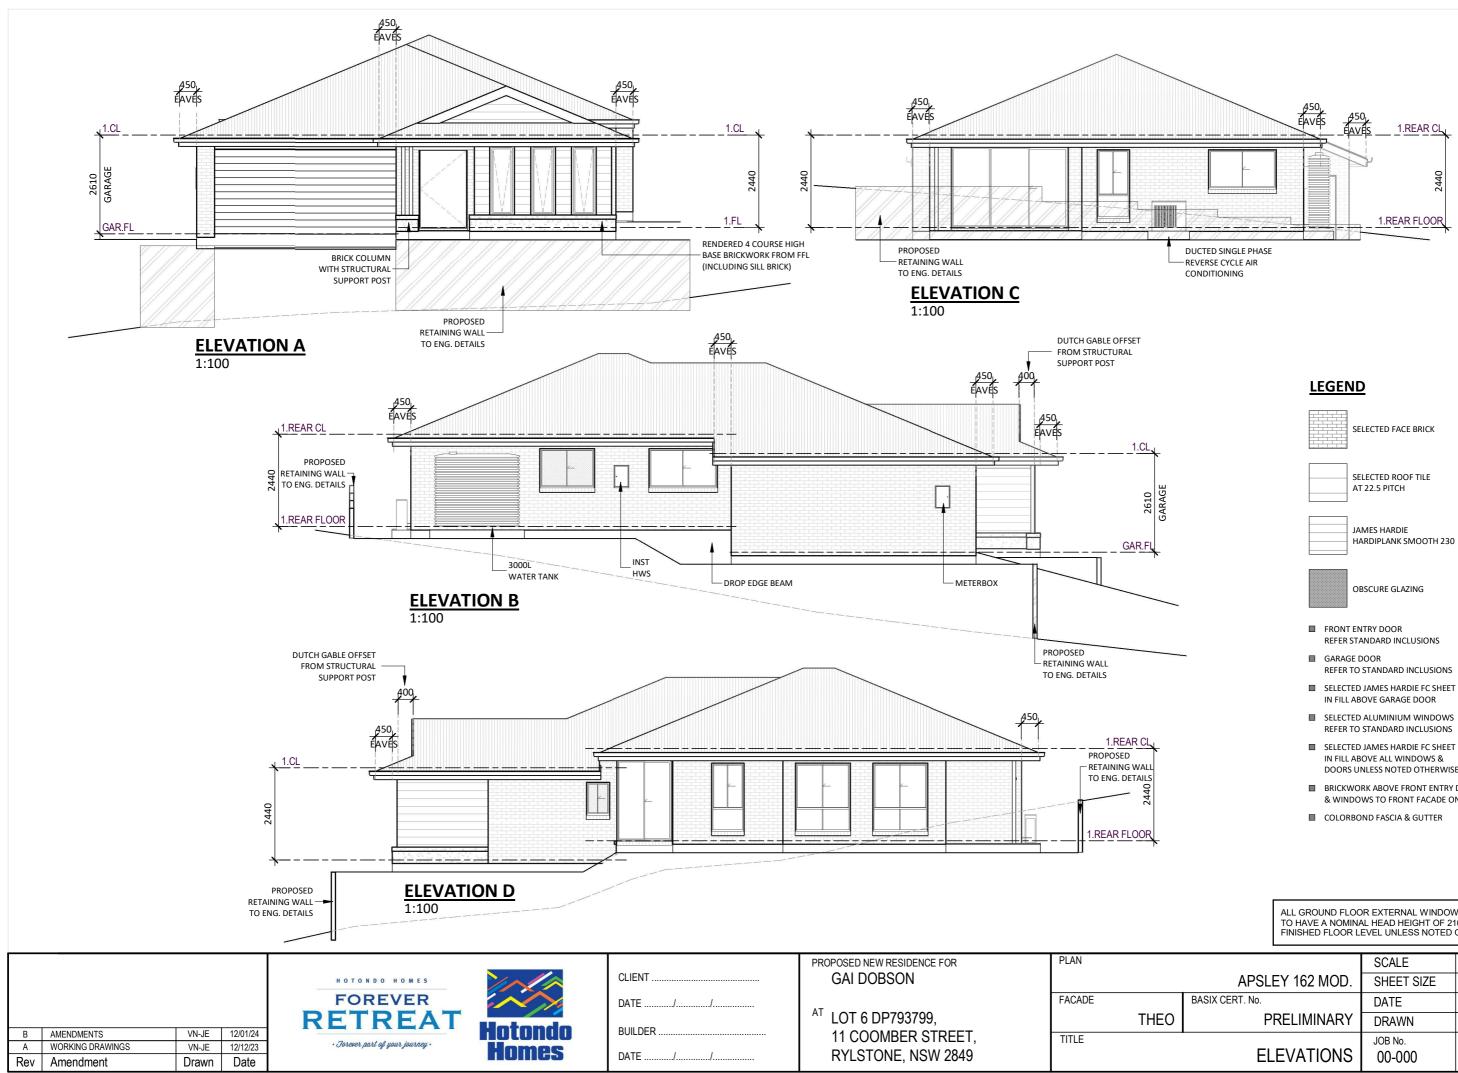


HARDIPLANK SMOOTH 230

- REFER TO STANDARD INCLUSIONS
- REFER TO STANDARD INCLUSIONS
- DOORS UNLESS NOTED OTHERWISE
- BRICKWORK ABOVE FRONT ENTRY DOOR & WINDOWS TO FRONT FACADE ONLY

ALL GROUND FLOOR EXTERNAL WINDOWS & DOORS TO HAVE A NOMINAL HEAD HEIGHT OF 2100mm FROM FINISHED FLOOR LEVEL UNLESS NOTED OTHERWISE

	SCALE	1 : 100
APSLEY 162 MOD.	SHEET SIZE	A3
BASIX CERT. No.	DATE	12/01/24
PRELIMINARY	DRAWN	VN-JE
ELEVATIONS	JOB No. 00-000	DWG No. 03

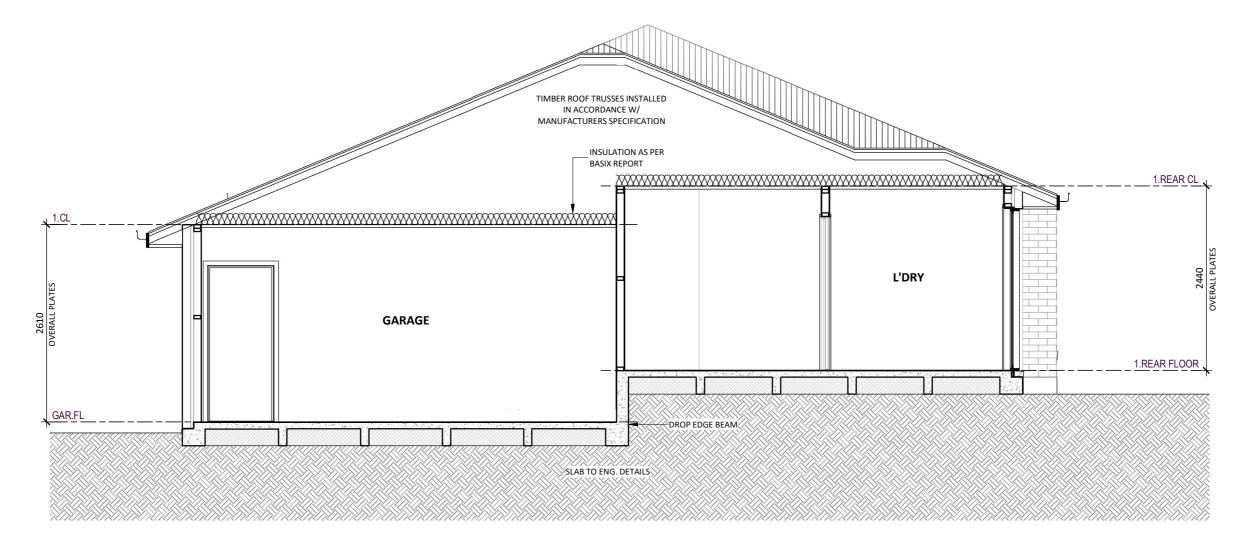

SECTION A SCALE 1:50




LEGEND

REFER TO APPROVED BUILDING PERMIT DRAWINGS FOR ALL FINAL SPECIFICATIONS

- ROOF TRUSSES AT 22.5° TO MANUFACTURERS SPECIFICATION
- SELECTED COLORBOND FASCIA & GUTTER
- CONCRETE SLAB TO ENGINEERS SPECIFICATION
- PLASTERBOARD LINING TO ALL CEILINGS AND WALLS

	SCALE	1 : 50
APSLEY 162 MOD.	SHEET SIZE	A3
BASIX CERT. No.	DATE	12/01/24
PRELIMINARY	DRAWN	VN-JE
SECTIONS	JOB No. 00-000	DWG No. 04

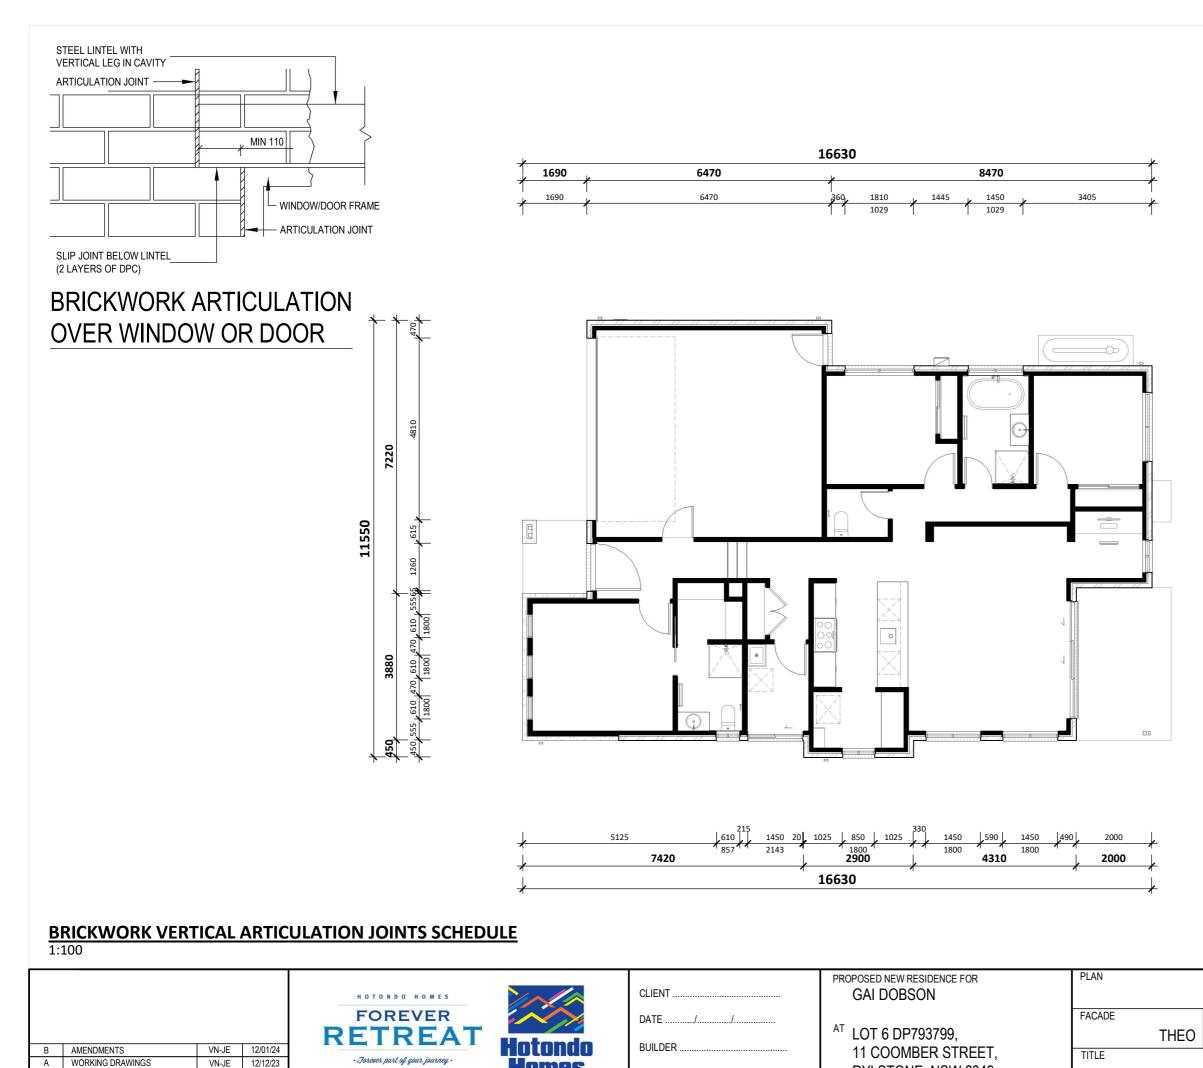

Homes

Rev Amendment

Date

Drawn

DATE .


RYLSTONE, NSW 2849



BRICKWORK ARTICULATION

BRICKWORK ARTICULATION JOINTS

- 1. In straight, continuous walls having no openings, at no more than 7.0m.
- Where the height of the wall changes by more 20%, at the position of change in height; and
 Where openings more than 900x900mm occur, at not more than 5m centre and positioned in line with one edge of the opening; and
 Where walls change thickness; and
- 5. At control or construction joints in footing slab; and
- 6. At junctions of walls constructed of different masonry materials; and
- 7. At a distance from all corners between 2m-4.5m.

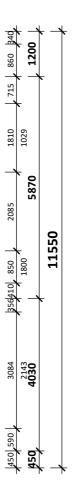

	SCALE	1 : 100
APSLEY 162 MOD.	SHEET SIZE	A3
BASIX CERT. No.	DATE	12/01/24
PRELIMINARY	DRAWN	VN-JE
BRICKWORK SETOUT	JOB No. 00-000	DWG No. 05-1

PLUMBER AND CONCRETER TO CONFIRM ALL PC ITEMS FOR SLAB PENETRATION OFFSET AND DIMENSIONS



- 1. VERIFY ALL DIMENSIONS PRIOR TO COMMENCEMENT.
- 2. ALL PLAN DIMENSIONS ARE TO OUTSIDE OF BRICKWORK UNLESS NOTED OTHERWISE.
- 3. FOOTINGS AND SLAB CONSTRUCTION TO BE IN ACCORDANCE WITH ANY GEOTECHNICAL REPORT & ENGINEERS' DETAIL FOR THIS ALLOTMENT.
- 4. TERMITE PROTECTION TO BE IN ACCORDANCE WITH AS 3660.1 1995 AND NCC 3.1.3.

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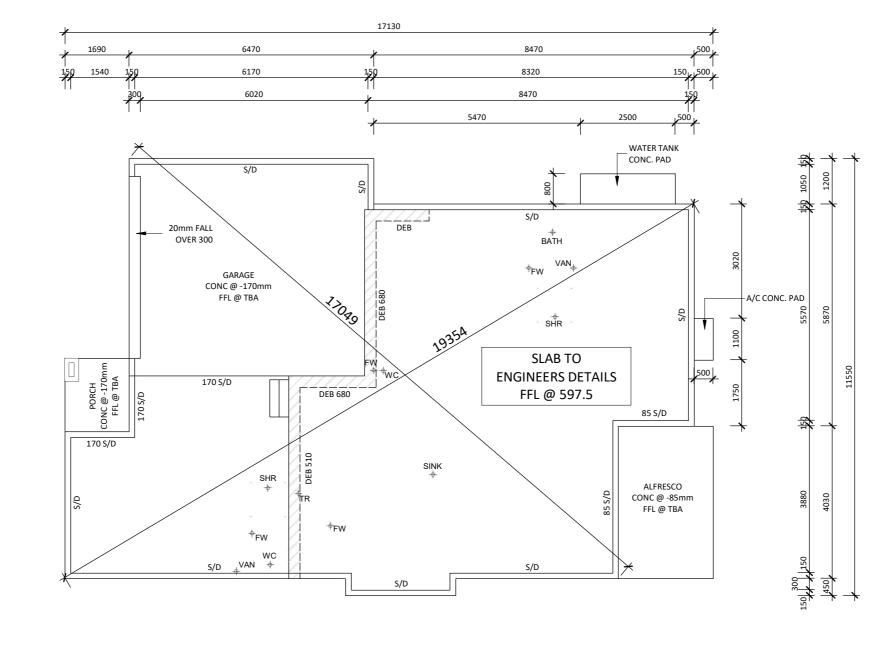
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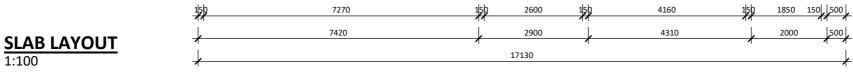
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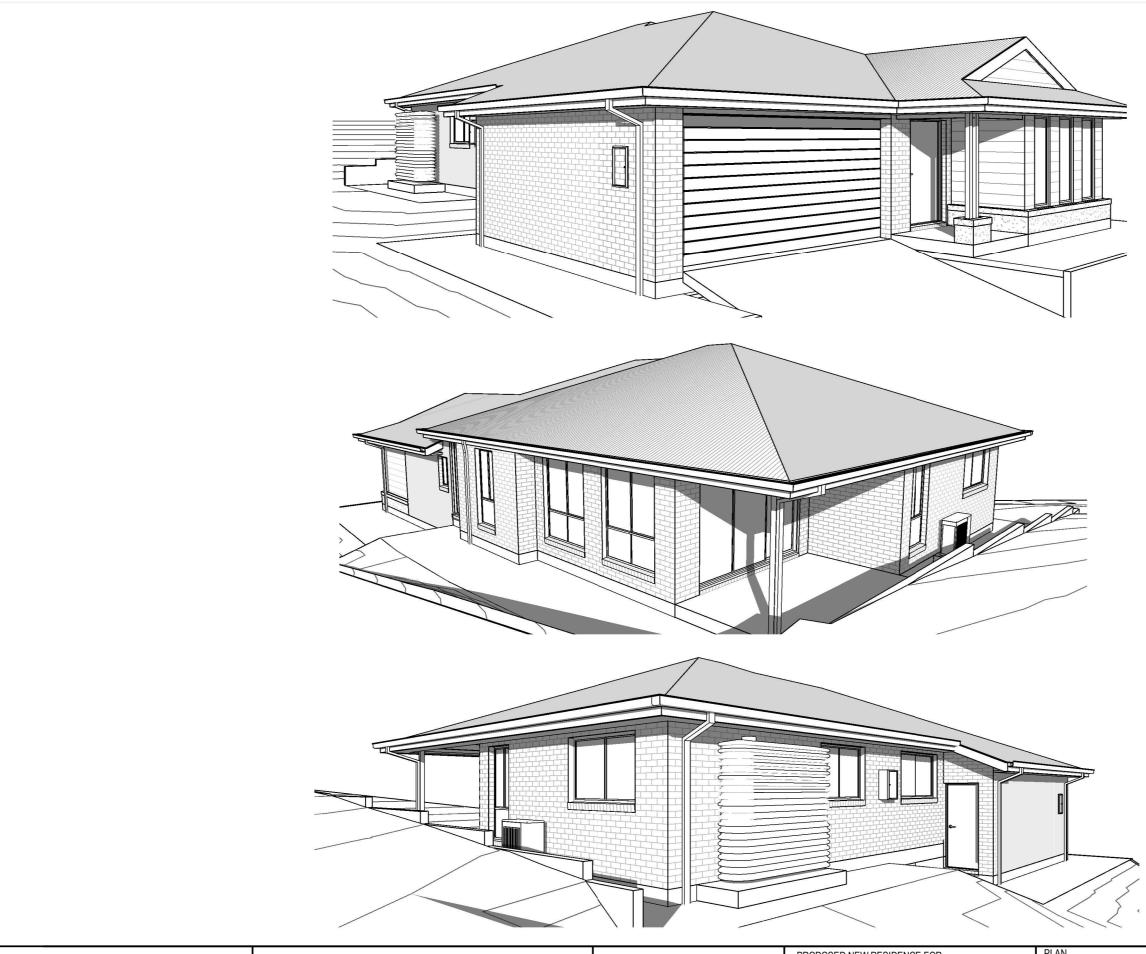
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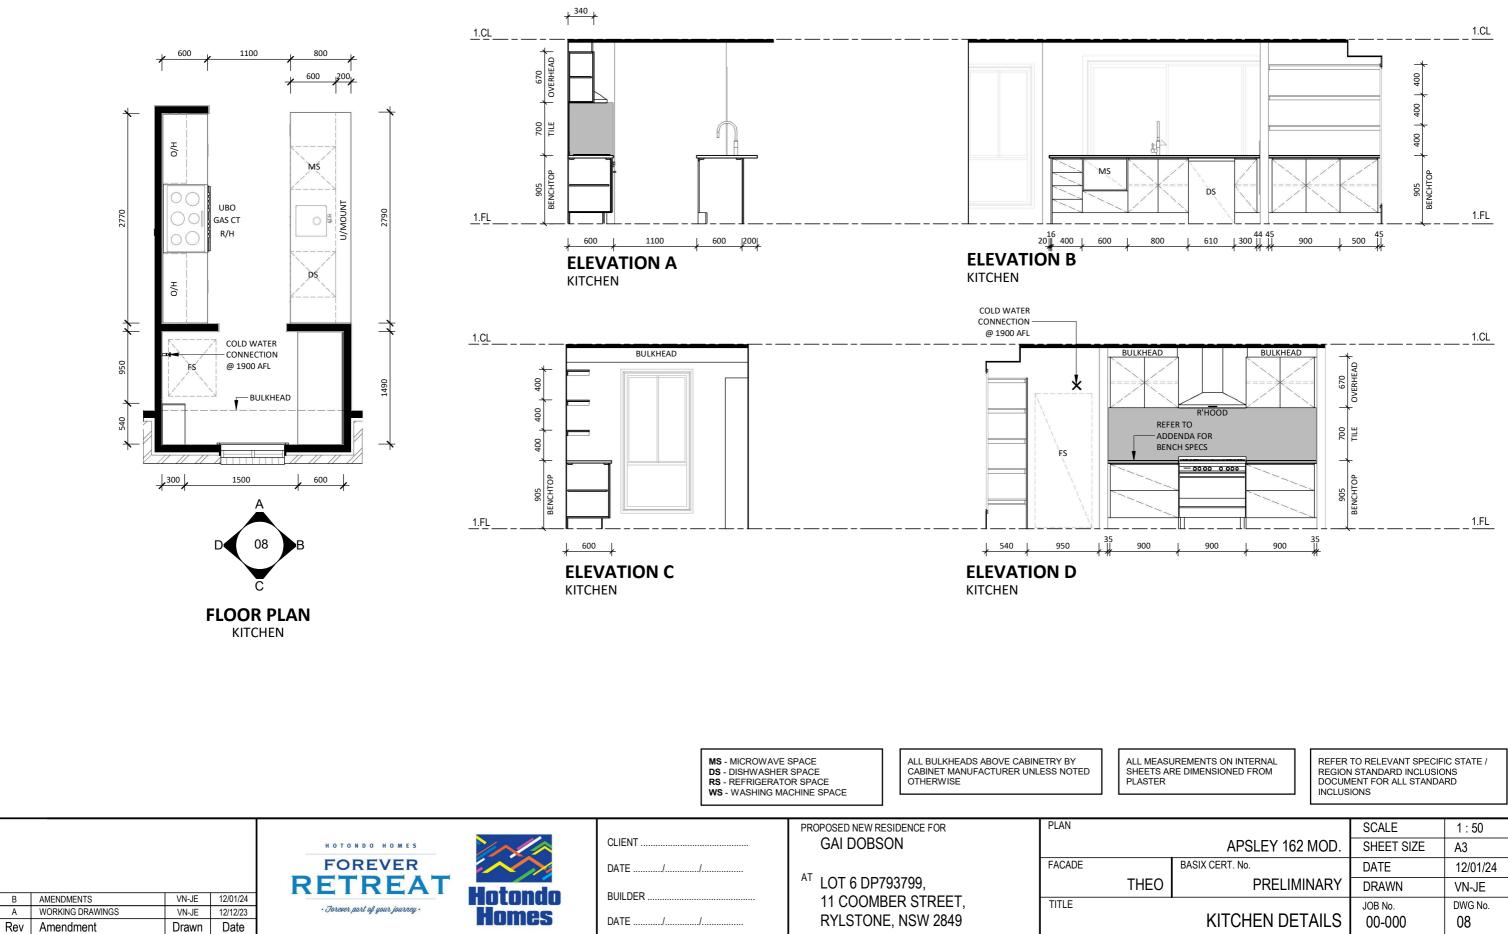





	SCALE	1 : 100
APSLEY 162 MOD.	SHEET SIZE	A3
BASIX CERT. No.	DATE	12/01/24
PRELIMINARY	DRAWN	VN-JE
SLAB LAYOUT	JOB No. 00-000	DWG No. 05-2




							PROPOSED NEW RESIDENCE FOR	PLAN			SCALE	
				HOTONDO HOMES		CLIENT	GAI DOBSON			APSLEY 162 MOD.	SHEET SIZE	A3
				FOREVER		DATE///	AT.	FACADE		BASIX CERT. No.	DATE	12/01/24
	1			RETREAT	Hotopdo		^{A1} LOT 6 DP793799,		THEO	PRELIMINARY	DRAWN	VN-JE
В	AMENDMENTS	VN-JE	12/01/24	· Jorever part of your journey ·	Hotondo	BUILDER	11 COOMBER STREET,	TITLE			JOB No.	DWG No.
A	WORKING DRAWINGS	VN-JE	12/12/23	· Surever part of your journey ·	Homes	DATE	RYLSTONE, NSW 2849			PERSPECTIVES	00-000	
Rev	Amendment	Drawn	Date			DATE	RTESTONE, NSW 2049			FLRGFLGTIVLS	00-000	06



	SCALE	1 : 50
APSLEY 162 MOD.	SHEET SIZE	A3
BASIX CERT. No.	DATE	12/01/24
PRELIMINARY	DRAWN	VN-JE
KITCHEN DETAILS	JOB No. 00-000	DWG No.

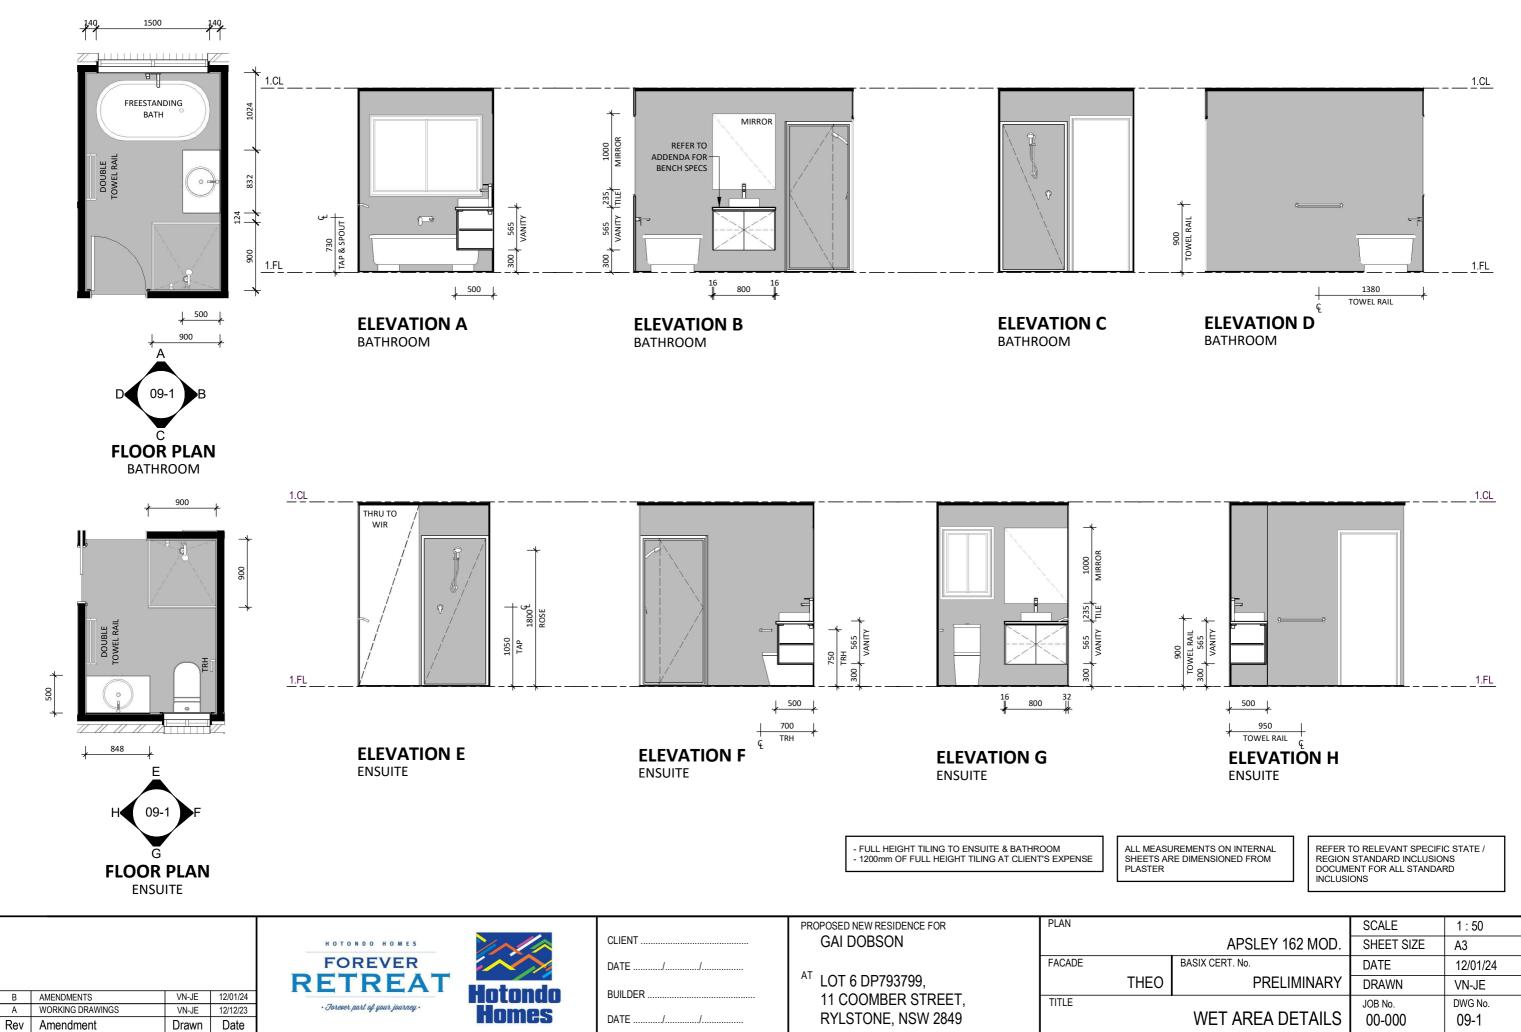

PRELIMINARY	DRAWN	VN-JE
WET AREA DETAILS	JOB No. 00-000	DWG No. 09-1

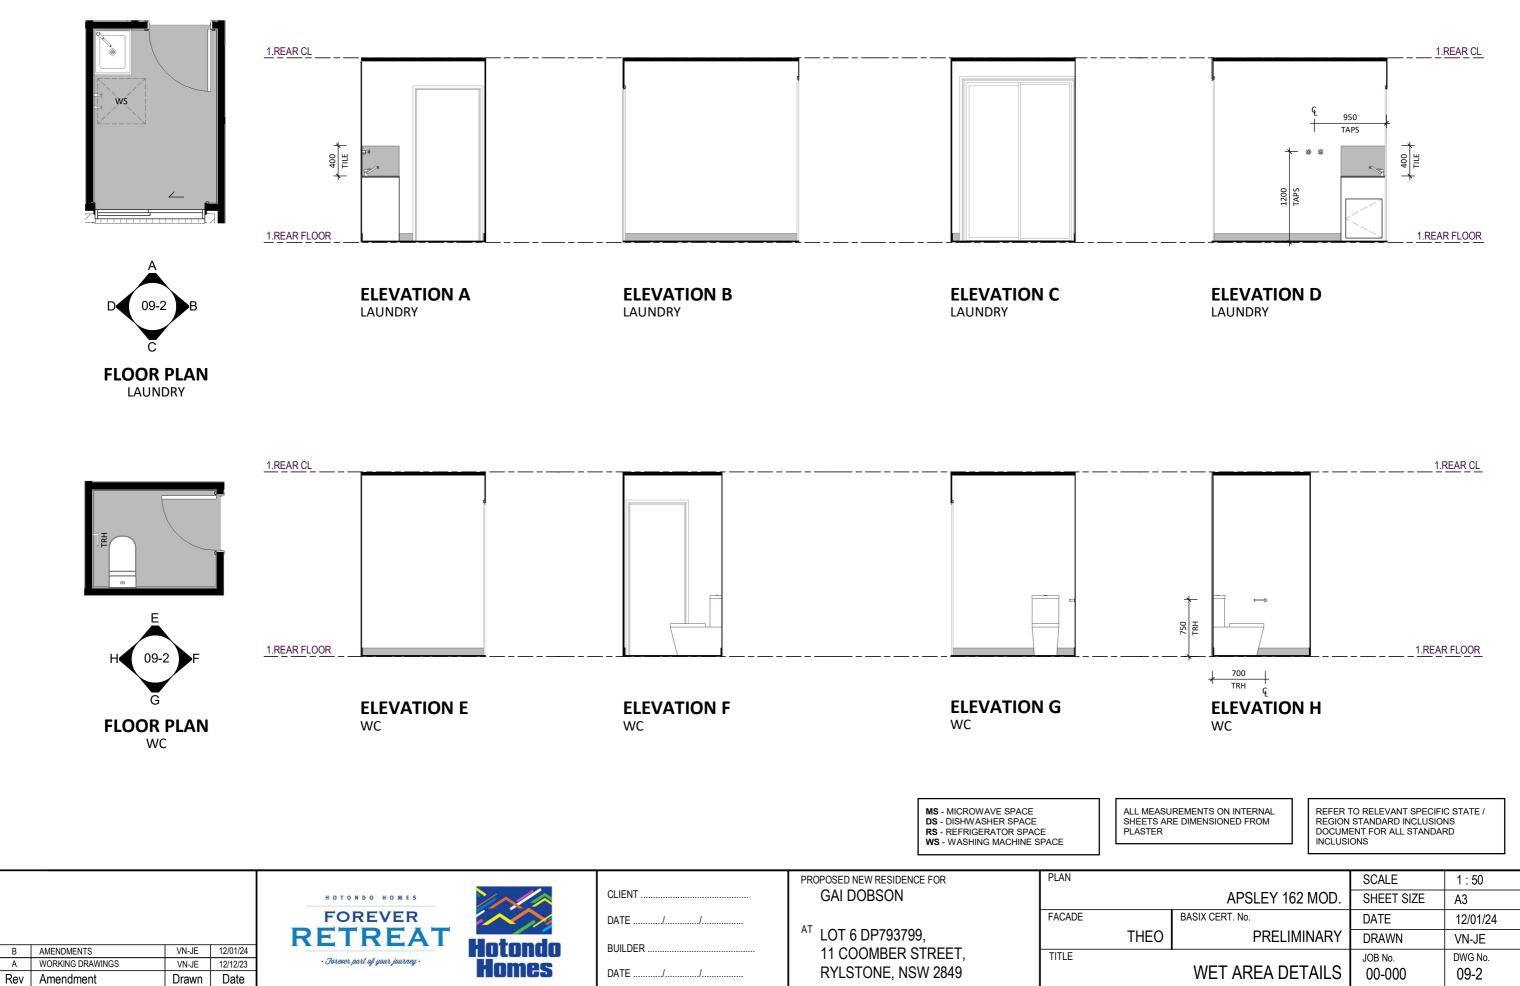

BASIX CERT. No.	DATE	12/01/24
PRELIMINARY	DRAWN	VN-JE
WET AREA DETAILS	JOB No. 00-000	DWG No. 09-2

Water Commitments	Show on DA plans	Show on CC/CDC plans & specs	Certifier check
Fixtures			
The applicant must install showerheads with a minimum rating of 4 star (> 4.5 but <= 6 L/min plus spray force and/or coverage tests) in all showers in the development.		~	~
The applicant must install a toilet flushing system with a minimum rating of 4 star in each toilet in the development.		~	~
The applicant must install taps with a minimum rating of 6 star in the kitchen in the development.		~	
The applicant must install basin taps with a minimum rating of 6 star in each bathroom in the development.		~	
Alternative water			
Rainwater tank			
The applicant must install a rainwater tank of at least 3000 litres on the site. This rainwater tank must meet, and be installed in accordance with, the requirements of all applicable regulatory authorities.	~	~	~
The applicant must configure the rainwater tank to collect rain runoff from at least 80 square metres of the roof area of the development (excluding the area of the roof which drains to any stormwater tank or private dam).		~	~
The applicant must connect the rainwater tank to:			
all toilets in the development		v .	~
the cold water tap that supplies each clothes washer in the development		✓	~
 at least one outdoor tap in the development (Note: NSW Health does not recommend that rainwater be used for human consumption in areas with potable water supply.) 		~	~
all hot water systems in the development		~	~

Window/glazed door no.	Maximum height (mm)	Maximum width (mm)	Туре	Shading Device (Dimension within 10%)	Overshadowing						
North facing											
W01	2100	3000	aluminium, single, clear	eave 2000 mm, 90 mm above head of window or glazed door	not overshadowed						
W02	1800	900	aluminium, single, clear	eave 450 mm, 90 mm above head of window or glazed door	not overshadowed						
W03	1000	1800	aluminium, single, clear	eave 450 mm, 90 mm above head of window or glazed door	not overshadowed						
East facing											
W04	1000	1500	aluminium, single, clear	eave 450 mm, 90 mm above head of window or glazed door	not overshadowed						
W05	1000	1800	aluminium, single, clear	eave 450 mm, 90 mm above head of window or glazed door	not overshadowed						
South facing											

				Window/glazed door no.	Maximum	Maximum width	Туре	Shading Device (Dimension within	Overshadowing
Thermal Comfort Commitments		Show on CC/CDC plans & specs	Certifier check	W06	height (mm) 1800	(mm) 2100	aluminium, single, clear	10%) eave 450 mm, 90 mm above head of	not overshadowed
Windows, glazed doors and skylights					1000	2100	alaminani, oligio, oloar	window or glazed door	not overendadowed
Windows, glazed doors and skylights West facing									
The applicant must install the windows, glazed doors and shading devices described in the table below, in accordance with the					1				
specifications listed in the table. Relevant overshadowing specifications must be satisfied for each window and glazed door.		·	V	W07	900	600	aluminium, single, clear	eave 450 mm, 90 mm above head of	not overshadowed
The dwelling may have 1 skylight (<0.7 square metres) which is not listed in the table.				1				window or glazed door	
	V	✓	V	W08	2100	1500	aluminium, single, clear	eave 450 mm, 90 mm above head of	not overshadowed
The following requirements must also be satisfied in relation to each window and glazed door:								window or glazed door	
The following requirements must also be satisfied in relation to each window and glazed door.	_		_	W09	1800	900	aluminium, single, clear	eave 450 mm, 90 mm above head of	not overshadowed
					1000	500	auminum, single, clear	window or glazed door	not oversnadowed
 For the following glass and frame types, the certifier check can be performed by visual inspection. 									
			•	W10	1800	1500	aluminium, single, clear	eave 450 mm, 90 mm above head of	not overshadowed
- Aluminium single clear								window or glazed door	
- Aluminium double (air) clear				W11	1800	1500	aluminium, single, clear	eave 450 mm, 90 mm above head of	not overshadowed
								window or glazed door	
- Timber/uPVC/fibreglass single clear					1	1	1	-	1
- Timber/uPVC/fibreglass double (air) clear									

				HOTONDO HOMES		CLIENT	PROPOSED NEW RESIDENCE FOR GAI DOBSON	PLAN	
				FOREVER RETREAT		DATE////	^{AT} LOT 6 DP793799,	FACADE	THEO
В	AMENDMENTS	VN-JE	12/01/24		Hotondo	BUILDER	11 COOMBER STREET,	TITLE	
Α	WORKING DRAWINGS	VN-JE	12/12/23	• Forever part of your journey •	Homes		· · · · ·		
Rev	Amendment	Drawn	Date			DATE	RYLSTONE, NSW 2849		

		SCALE	1 : 50
	APSLEY 162 MOD.	SHEET SIZE	A3
	BASIX CERT. No.	DATE	12/01/24
)	PRELIMINARY	DRAWN	VN-JE
	WET AREA DETAILS	JOB No. 00-000	DWG No. 10

Energy Commitments	Show on DA plans	Show on CC/CDC plans & specs	Certifier check	Energy Commitments	Show on DA plans	Show on CC/CDC plans & specs	Certifier check
Hot water	İ			all bathrooms/toilets; dedicated			
The applicant must install the following hot water system in the development, or a system with a higher energy rating: gas instantaneous.	~	 ✓ 	~	the laundry; dedicated			
Cooling system				 all ballways: dedicated 		· ·	Y
The applicant must install the following cooling system, or a system with a higher energy rating, in at least 1 living area: 1-phase airconditioning; Energy rating: 4.5 Star (old label)		 ✓ 	~	all haliways; dedicated		 ✓ 	~
The applicant must install the following cooling system, or a system with a higher energy rating, in at least 1 bedroom: 1-phase airconditioning; Energy rating; 4.5 Star (old label)		_	_	Natural lighting			
Heating system		· ·	· ·	The applicant must install a window and/or skylight in the kitchen of the dwelling for natural lighting.	 ✓ 	 ✓ 	~
The applicant must install the following heating system, or a system with a higher energy rating, in at least 1 living area: 1-phase airconditioning; Energy rating: 4.5 Star (old label)		~	~	The applicant must install a window and/or skylight in 2 bathroom(s)/toilet(s) in the development for natural lighting.	~	~	~
The applicant must install the following heating system, or a system with a higher energy rating, in at least 1 bedroom: 1-phase airconditioning; Energy rating: 4.5 Star (old label)		~	~	Other		1	
Ventilation				The applicant must install a gas cooktop & electric oven in the kitchen of the dwelling.		V	
The applicant must install the following exhaust systems in the development: At least 1 Bathroom: individual fan, ducted to façade or roof; Operation control: manual switch on/off				The applicant must construct each refrigerator space in the development so that it is "well ventilated", as defined in the BASIX definitions.		~	
Kitchen: individual fan, ducted to façade or roof; Operation control: manual switch on/off			L.	The applicant must install a fixed outdoor clothes drying line as part of the development.		 ✓ 	
Laundry: natural ventilation only, or no laundry; Operation control: n/a		~	~				
Artificial lighting							
The applicant must ensure that the "primary type of artificial lighting" is fluorescent or light emitting diode (LED) lighting in each of the following rooms, and where the word "dedicated" appears, the fittings for those lights must only be capable of accepting fluorescent or light emitting diode (LED) lamps:							
at least 4 of the bedrooms / study; dedicated		~	~				
at least 2 of the living / dining rooms; dedicated		 Image: A second s	~				
the kitchen; dedicated							

Legend

In these commitments, "applicant" means the person carrying out the development.

Commitments identified with a v in the "Show on DA plans" column must be shown on the plans accompanying the development application for the proposed development).

Commitments identified with a v in the "Show on CC/CDC plans and specs" column must be shown in the plans and specifications accompanying the application for a construction certificate / complying development certificate for the proposed development.

Commitments identified with a v in the "Certifier check" column must be certified by a certifying authority as having been fulfilled, before a final occupation certificate(either interim or final) for the development may be issued.

				HOTONDO HOMES		CLIENT	PROPOSED NEW RESIDENCE FOR GAI DOBSON	PLAN	
				FOREVER RETREAT	Hotondo	DATE	^{AT} LOT 6 DP793799,	FACADE	THEO
B A	AMENDMENTS WORKING DRAWINGS	VN-JE VN-JE	12/01/24 12/12/23	• Forever part of your journey •		BUILDER	11 COOMBER STREET,	TITLE	
Rev	Amendment	Drawn	Date		Homes	DATE	RYLSTONE, NSW 2849		

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	SCALE	1 : 50
APSLEY 162 MOD.	SHEET SIZE	A3
BASIX CERT. No.	DATE	12/01/24
PRELIMINARY	DRAWN	VN-JE
WET AREA DETAILS	JOB No. 00-000	DWG No. 11