
Issued For:

# **CLIENT REVIEW & COORDINATION**

Project Description:

Proposed New Single Storey Dual Occupancy & **Torrens Title Sub-Division Located At:** 

## Lot 1 in DP 1297909 No.90 Douro Street, Mudgee. NSW

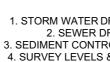

**GENERAL NOTES:** 2. SEWER DRAINAGE & WASTE WATER TO SYDNEY WATER SEWER MAIN SURVEY PLAN +-100mm 5. TERMITE CONTROL CHEMICAL OR PHYSICAL BARRIER TO BE INSTALLED IN ACCORDANCE WITH AS3660 COMMENCEMENT OF WORK RELEVANT STANDARDS AUSTRALIA CODES 8. FIGURED DIMENSIONS TAKE PREFERENCE TO SCALE 9. ALL DIMENSIONS IN MILLIMETRES U.N.O. 10. DRIVEWAY GRADIENT TO COMPLY WITH COUNCIL REGULATIONS 11. DROP EDGE BEAMS TO ENGINEERS DETAILS IF REQUIRED MASONRY NOT EXCEEDING 600mm HIGH 15. PERMANENT DRIVEWAY TO BE REINFORCED CONCRETE 16. ANY CONCRETE PATHS TO BE REINFORCED CONCRETE SURFACE WATER FROM GRASSED & CONCRETE AREAS CONNECTED INTO THE STORMWATER LINE REFERENCE 4980 WHERE THE SILL IS LESS THAN 1.7M ABOVE FLOOR LEVEL, OR 3.9.2.6 OF THE NCC VOLUME 2

12. ALL STRUCTURAL BEAM SIZES & DETAILS TO ENGINEERS SPECIFICATIONS 19. SURVEY DATAOBTAINED FROM SYDNEY REGISTERED SURVEYORS - PLAN

6. VERIFY ALL DIMENSIONS, LEVELS & EXISTING CONDITION ON SITE PRIOR TO 17. SURFACE DRAINS WILL BE INCORPORATED IN THE LANDSCAPING TO REMOVE

I. STORM WATER DRAINAGE TO STREET STORMWATER SYSTEM & THE BASIX REPORT 3. SEDIMENT CONTROL BARRIER TO COUNCIL SPECIFICATIONS DURING CONSTRUCTION 4. SURVEY LEVELS & CONTOURS TO AUSTRALIAN HEIGHT DATUM OR AS INDICATED ON 7. ALL WORK & MATERIALS TO COMPLY WITH THE BUILDING CODE OF AUSTRALIA & 13. ANY RETAINING WALL REQUIRED WILL BE CONSTRUCTED FROM COPPER LOGS OR 14. AN ALL WEATHER ACCESS CONSISTING OF RECYCLED CONCRETE WILL BE PROVIDED 18. AGRICULTURAL DRAINS WILL BE APPLIED BEHIND ALL RETAINING WALLS & WILL BE 20. CHILD PROOF SCREENS MUST BE FITTED TO FIRST FLOOR BEDROOM WINDOWS WINDOW OPENINGS TO BE RESTRICTED TO 125mm, IN ACCORDANCE WITH CLAUSE

onte	ents			
			11	Sub-Division Plan
			10	Landscape Plan
			9	Roof Plan, Section & Schedules
			8	Elevations
			7	Elevations
			6	Proposed Floor Plan
			5	Sedimentaion & Waste Plan
			4	Stormwater Plan
			3	Site Plan
			2	Basix / Nathers
2	09.11.23	Client Review	1	Cover Sheet
Rev	Date	Amendment	Sheet	Description


Openion      Orafting	Issue	Amendment	Date:	North:	
A Design & Drafting		Client Review	09.11.23		
RESIDENTIAL DESIGN & DRAFTING SERVICES					
Phone: (02) 9757 - 4002 Fax: (02) 9757 - 4003 Email: jr.design.drafting@gmail.com					
Address: Suite 304 No. 447 Victoria Street, Wetherill Park. NSW 2164					
General Notes: 1. All work to be carried out in accordance with the requirements of the Building Code of Australia and the relevant local authority.					
<ol> <li>All timber framing to be carried out to the requirements of Australian Standards (as 1684) as a minimum.</li> <li>All reinforced concrete, steel beams including supports, and nominated beams including supports to Engineer's details.</li> </ol>					بالت
4. Structural Engineer to check, detail and certify brickwork to garage area with a height greater than 3000mm between horizontal supports. 5. All brickwork to be constructed in accordance with the requirements of the Building Code of Australia. 6. Centrol joints in brickwork to be provided in accordance with the requirements of the Building Code of Australia. 7. Donway openings with hward opening doors to room containing bilets which are closer han 1500mm to the object.	This pla	Copyright: In is the exclusive property of JR Design & Drafting. and			
are to be fitted with hinges to allow the door to be removed from the outside when the door is closed.	us	ed, reproduced or copied wholly in any way without per	mission		



roposed

#### **AUSTRALIAN STANDARD CODES** AS 1288 Glazing AS 1684.4 Timber Framing AS 1728.1 Timber Structures Code AS 2857 Termite Protection AS 2878.1 Residential Slabs & Footings AS 3500 National Plumbing & Drainage AS 3600 Concrete Structures AS 3700 Masonry in Buildings AS 3786 Smoke Alarms AS 4100 Steel Structures

	Drawing Title:			Revision:
ancy	Cover Page			2
	L.G.A			
	Mid-Western Regional			Design:
	Facade : CUSTOM	Date	09.11.23	CUSTOM
	Scale	Sheet	1 of 11	JR Job No: 2304

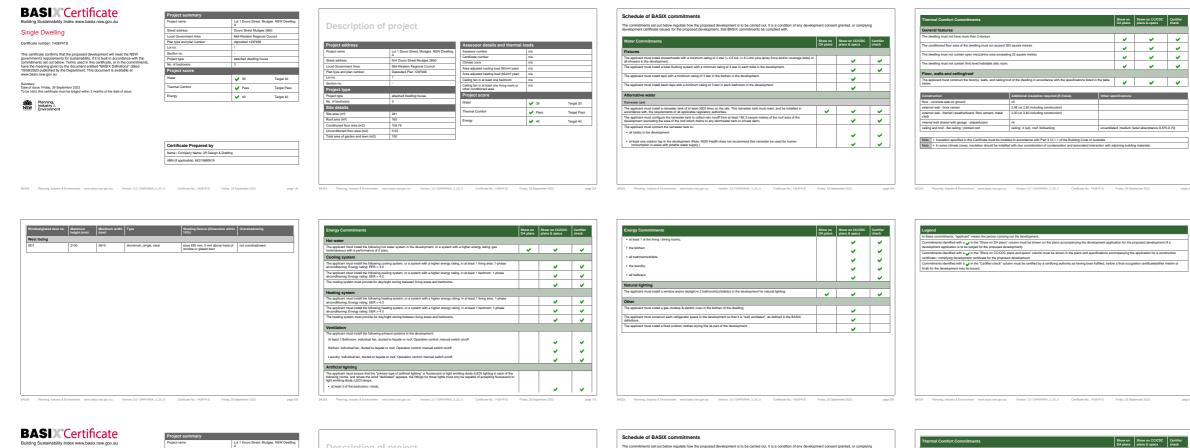


BASIX Certificate	Project summary				
uilding Sustainability Index www.basix.nsw.gov.au	Project name	Lot 1 Douro Street, M A			
Sinale Dwelling	Street address Douro Street Mudgee 2850				
single Briteling	Local Government Area	Mid-Western Regione	Mid-Western Regional Council		
ertificate number: 1428741S	Plan type and plan number deposited 1297909				
	Lot no.	1			
his certificate confirms that the proposed development will meet the NSW	Section no.	-			
overnment's requirements for sustainability, if it is built in accordance with the symmitments set out below. Terms used in this certificate, or in the commitments.	Project type	attached dwelling hou	ise		
ommitments set out below. Lerms used in this certificate, or in the commitments, ave the meaning given by the document entitled "BASIX Definitions" dated	No. of bedrooms	3			
009/2020 published by the Department. This document is available at ww.basix.nsw.gov.au	Project score				
	Water	✓ 39	Target 30		
ecretary ate of issue: Friday, 29 September 2023 be valid, this certificate must be lodged within 3 months of the date of issue.	Thermal Comfort	V Pass	Target Pass		
	Energy	40	Target 40		
NSW Planning, Industry & Environment					

Certificate Prepared by Name / Company Name: JR Design & Drafting ABN (if applicable): 66319680618

Project address	Lot 1 Douro Street, Muddee, NSW Dwelling	Assessor details and thermal	nia	
Project name	A	Assessor number Cartificate number	nia	
Street address	N/A Douro Street Mudgee 2850	Carate zone	nia	
Local Government Area	Mid-Western Regional Council	Area adjusted cooling load (MJ/m?-year)	nia	
Plan type and plan number	Deposited Plan 1297909	Area adjusted beating load (MJ/m².year)	nia	
Lot no.	1	Ceiling fan in at least one bedroom	nia	
Section no.		Ceiling fan in at least one living room or	nia	
Project type		other conditioned area		
Project type	attached dwelling house	Project score		
No. of bedrooms	3	Water	<b>y</b> 39	Tars
Site details				
Site area (m²)	281	Thermal Comfort	V Pass	Tarç
Roof area (m²)	165	Energy	<b>√</b> 40	Tars
Conditioned floor area (m2)	108.78		• -	
Unconditioned floor area (m2)	5.53			
Total area of garden and lawn (m2)	100			


Water Commitments	Show on DA plans	Show on CC/CDC plans & specs	Certif
Fixtures			i i
The applicant must install showerheads with a minimum rating of 4 star (>4.5 but <= 6 Limin plus spray force and/or coverage tests) in all showers in the development.		~	
The applicant must install a tollet flushing system with a minimum rating of 3 star in each tollet in the development.		~	
The applicant must install taps with a minimum rating of 3 star in the kitchen in the development.		~	
The applicant must install basin taps with a minimum rating of 3 star in each bathroom in the development.		~	
Alternative water			
Rainwater tank			
The applicant must install a rainwater tank of at least 5000 litres on the site. This rainwater tank must meet, and be installed in accordance with, the requirements of all applicable regulatory authorities.	~	~	
The applicant must configure the rainwater tank to collect rain runoff from at least 165.3 square metres of the roof area of the development (excluding the area of the roof which drains to any stormwater tank or private dam).		×	
The applicant must connect the rainwater tank to:			
all talkts in the development		<b>~</b>	•
<ul> <li>at least one outdoor tap in the development (Note: NSW Health does not recommend that rainwater be used for human consumption in areas with potable water supply.)</li> </ul>		<b>~</b>	

	mal Comfort Commitments			Show on DA plans	Show on CC plans & spe	
Gen	eral features					
The d	~	<b>~</b>				
The o						
The d	1					
The d	The dwelling must not contain third level habitable attic room.					
Floo	r, walls and ceiling/roof			~		
	pplicant must construct the floor(s), walls, and ceiling/s	oof of the dwelling in accordance with the specifications	isted in the table	~	~	
Const	aruction	Additional insulation required (R-Value)	Other sp	pecifications		
floor -	concrete slab on ground	ni				
extern	al wall - brick veneer	2.06 (or 2.60 including construction)				
extern clad)	nal wall - framed (weatherboard, fibre cement, metal	2.20 (or 2.60 including construction)				
intern	al wall shared with garage - plasterboard	ni				
ceiling	g and roof - flat ceiling / pitched roof	ceiling: 4 (up), roof: foil/sarking	unventila	ated; medium (	solar absorptan	
Note	· Insulation specified in this Certificate must be instal	illed in accordance with Part 3.12.1.1 of the Building Cod	le of Australia.			
		ed with due consideration of condensation and associate				

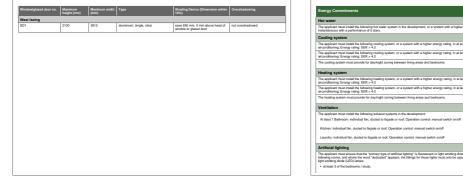

Energy Commitments	Show on DA plans	Show on CC/CDC plans & specs	Certifier check
Hot water			
The applicant must install the following hot water system in the development, or a system with a higher energy rating: gas instantaneous with a performance of 5 stars.	~	×	~
Cooling system			
The applicant must install the following cooling system, or a system with a higher energy rating, in at least 1 living area: 1-phase airconditioning; Energy rating: EER > 4.0		~	~
The applicant must install the following cooling system, or a system with a higher energy rating, in at least 1 bedroom: 1-phase airconditioning; Energy rating: EER > 4.0		×	~
The cooling system must provide for day/hight zoning between living areas and bedrooms.		~	~
Heating system			
The applicant must install the following heating system, or a system with a higher energy rating, in at least 1 living area: 1-phase airconditioning; Energy rating; EER > 4.0		~	~
The applicant must install the following heating system, or a system with a higher energy rating, in at least 1 bedroom: 1-phase airconditioning; Energy rating: EER > 4.0		×	~
The heating system must provide for day/hight zoning between living areas and bedrooms.		~	~
Ventilation			
The applicant must install the following exhaust systems in the development:	1		1
At least 1 Bathroom: individual fan, ducted to façade or roof; Operation control: manual switch on/off		<ul> <li></li> </ul>	v
Kitchen: individual fan, ducted to façade or roof; Operation control: manual switch on/off			
Laundry: individual fan, ducted to laçade or roof; Operation control: manual switch on/off		v .	-
Artificial lighting			
The applicant must ensure that the "primary type of antificial lighting" is fluorescent or light emitting dode (LED) lighting in each of the tolkwing rooms, and where the word "decloated" appears, the fittings for those lights must only be capable of accepting fluorescent or right emitting dods (LED) largos.			
at least 3 of the bedrooms / study;			

Energy Commitments	Show on DA plans	Show on CC/CDC plans & specs	Certif
at least 1 of the living / dining rooms;		~	
the kitcher;			
all bathrooms/toilets;		1 I I	13
the laundry;		1 J	
• al halways;		<u> </u>	13
Natural lighting			
The applicant must install a window and/or skylight in 2 bathroom(s) (toilet(s) in the development for natural lighting.	~	~	
Other			
The applicant must install a gas cooktop & electric oven in the kitchen of the dwelling.		~	
The applicant must construct each refrigerator space in the development so that it is "well ventilated", as defined in the BASIX definitions.		~	
The applicant must install a fixed outdoor clothes drying line as part of the development.		~	

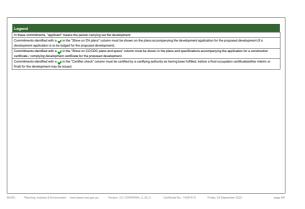



Thermal Comfort Co	mmitments				Show on DA plans	Show on CC/CDC plans & specs	Ce ch	
Windows, glazed doe	ors and skyligh	ts						
The applicant must install th specifications listed in the t	he windows, glazed able. Relevant over:	doors and shading d hadowing specificati	wices described in the table belo ons must be satisfied for each wi	w, in accordance with the ndow and glazed door.	~	~	Γ	
The dwelling may have 1 s	kylight (<0.7 square	metres) which is not	listed in the table.		~	~		
The following requirements	must also be satisf	ied in relation to each	window and glazed door:		~			
For the following glass	and frame types, the	i certifier check can b	e performed by visual inspection.		•	• •		
- Aluminium single cl								
- Aluminium double (a								
Timber/uPVC/fibreg     Timber/uPVC/fibreglass								
Windowiglazed door no.	Maximum height (mm)	Maximum width (mm)	Туре	Shading Device (Dimere 10%)	sion within	Overshadowing		
East facing								
W1	1800	1210	aluminium, single, clear	solid overhang 750 mm, 0 above head of window or door		not overshadowed		
W2	1800	1210	aluminium, single, clear	eave 650 mm, 0 mm abo window or glazed door	ve head of	not overshadowed		
South facing								
W3	860	610	aluminium, single, clear	eave 650 mm, 0 mm abo window or glazed door		not overshedowed		
W4	1030	1810	aluminium, single, clear	eave 650 mm, 0 mm abo window or glazed door		not overshedowed		
	1030	1810	aluminium, single, clear	eave 650 mm, 0 mm abor window or glazed door	ve head of	not overshedowed		
W5	1030			eave 650 mm. 0 mm abo		not mersharlowed		








Thermal Comfort	Commitments				Show on DA plans	Show on CC/CDC plans & specs	Certifier check
Windows, glazed	doors and skylight	s					
The applicant must inst pecifications listed in t	all the windows, glazed he table. Relevant overs	doors and shading de hadowing specificati	wices described in the table below ons must be satisfied for each win	, in accordance with the low and glazed door.	~	~	~
The dwelling may have	dwelling may have 1 skylight (<0.7 square metres) which is not fasted in the table.						~
	following requirements must also be satisfied in relation to each window and glazed door:						č
Aluminium single     Aluminium doub     Timber/uPVC/fib     Timber/uPVC/fibred	le (air) clear rreglass single clear						
/indowiglazed door r	no. Maximum height (mm)	Maximum width (mm)	Туре	Shading Device (Dimen 10%)	sion within	Overshadowing	
							_
	1800	1210	aluminium, single, clear	solid overhang 750 mm, i above head of window or door	) mm glazed	not overshadowed	
V1	1800	1210	aluminium, single, clear aluminium, single, clear	above head of window or	glazed	not overshadowed	
W1 W2				above head of window or door eave 650 mm, 0 mm abo	glazed		
East facing W1 W2 South facing W3				above head of window or door eave 650 mm, 0 mm abo	glazed ve head of		
W1 W2 South facing	1800	1210	aluminium, single, clear	above head of window or door eave 650 mm, 0 mm abo window or glazed door eave 650 mm, 0 mm abo	glazed ve head of ve head of	not overshadowed	
V1 V2 South facing V3	860	1210	aluminium, single, clear aluminium, single, clear	above head of window or door eave 650 mm, 0 mm abo window or glazed door eave 650 mm, 0 mm abo window or glazed door eave 650 mm, 0 mm abo	glazed we head of we head of we head of	not overshadowed	

	Drawing	Title:			Revision:
ancy					2
	L.G.A				
	Mic	d-Weste	ern Reg	gional	Design:
	Facade :	CUSTOM	Date	09.11.23	CUSTOM JR Job No:
	Scale	1:3.77	Sheet	2 of 11	2304

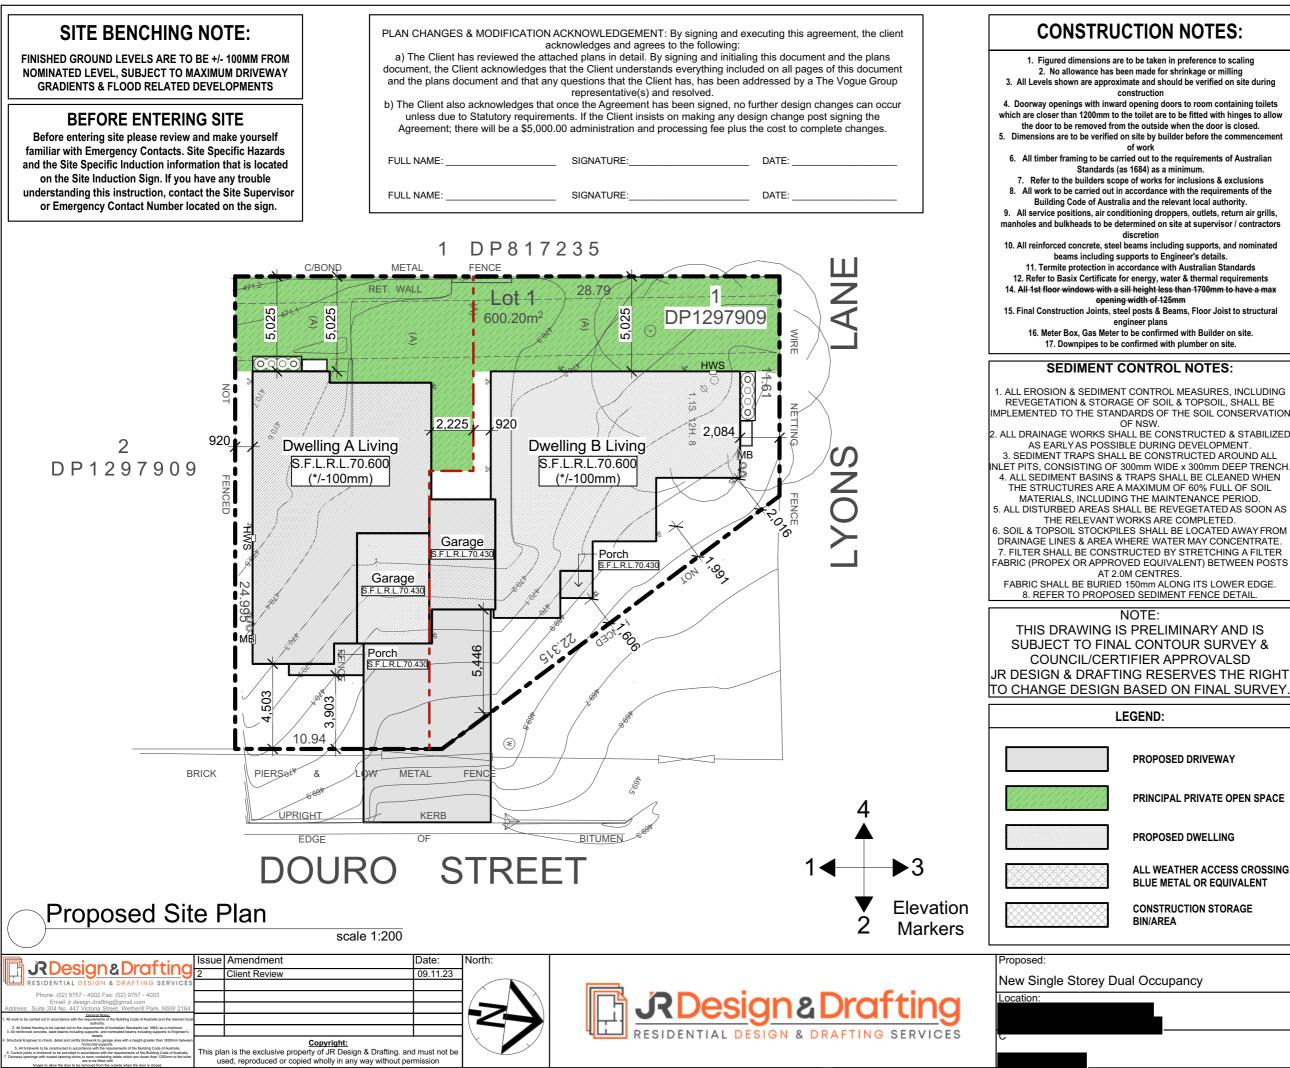

PROPOSED DRIVEWAY

PRINCIPAL PRIVATE OPEN SPACE

PROPOSED DWELLING

ALL WEATHER ACCESS CROSSING **BLUE METAL OR EQUIVALENT** 

CONSTRUCTION STORAGE

## D.A

#### SITE COVERAGE

SITE AREA	600.20m <sup>2</sup>
ALLOWED AS PER DCP 50% Site Area	300.10m <sup>2</sup>
PROPOSED AREA	282.04m <sup>2</sup>

### **PRIVATE OPEN SPACE**

REQUIRED BY DCP PROPOSED AREA DWELLING A

PROPOSED AREA DWELLING B

80.00m<sup>2</sup> 80 00m<sup>2</sup>

81.15m<sup>2</sup>

MINIMUM 2.5M X 2.5M

YES

PRINCIPAL PRIVATE OPEN SPACE 24.00m<sup>2</sup> MINIMUM 6M X 4M YFS

#### **DRIVEWAY / PATHWAY AREAS**

DRIVEWAY CROSSOVER AREA:

TBCm<sup>2</sup> TBCm<sup>2</sup>

N/A

DRIVEWAY AREA:


PATHWAY AREA:

### **COMPLIANCE TABLE**

**MID-WESTERN REGIONAL** DEVELOPMENT CONTROL PLAN

CRITERIA	ALLOWED/ REQUIRED	PROPOSED
FRONT SETBACK:	4.5M	4.5M
ARTICULATION ZONE:	3.5M	3.90M
GARAGE SETBACK:	5.5M	5.58M
REAR SETBACK:	0.9M	5.025M
GF SIDE SETBACK (A):	0.9M	1.5M
GF SIDE SETBACK (B):	0.9M	2.07M
LANEWAY SETBACK:	2.0M	2.07
FF SIDE SETBACK (B):	N/A	N/A
BUILDING HEIGHT:	8.5M	твс
CAR PARKING SPACES:	2 SPACES	2 SPACES
DRIVEWAY WIDTH:	N/A	4.5M

	Drawing	Drawing Title:			Revision:
ancy	Proposed Site Plan / Concept Drainage Plan				<b>0</b>
	L.G.A	pr Draina			
	Mid-Western Regional				Design:
	Facade :	CUSTOM	Date	09.11.23	CUSTOM JR Job No:
	Scale	1:200	Sheet	3 of 11	2304

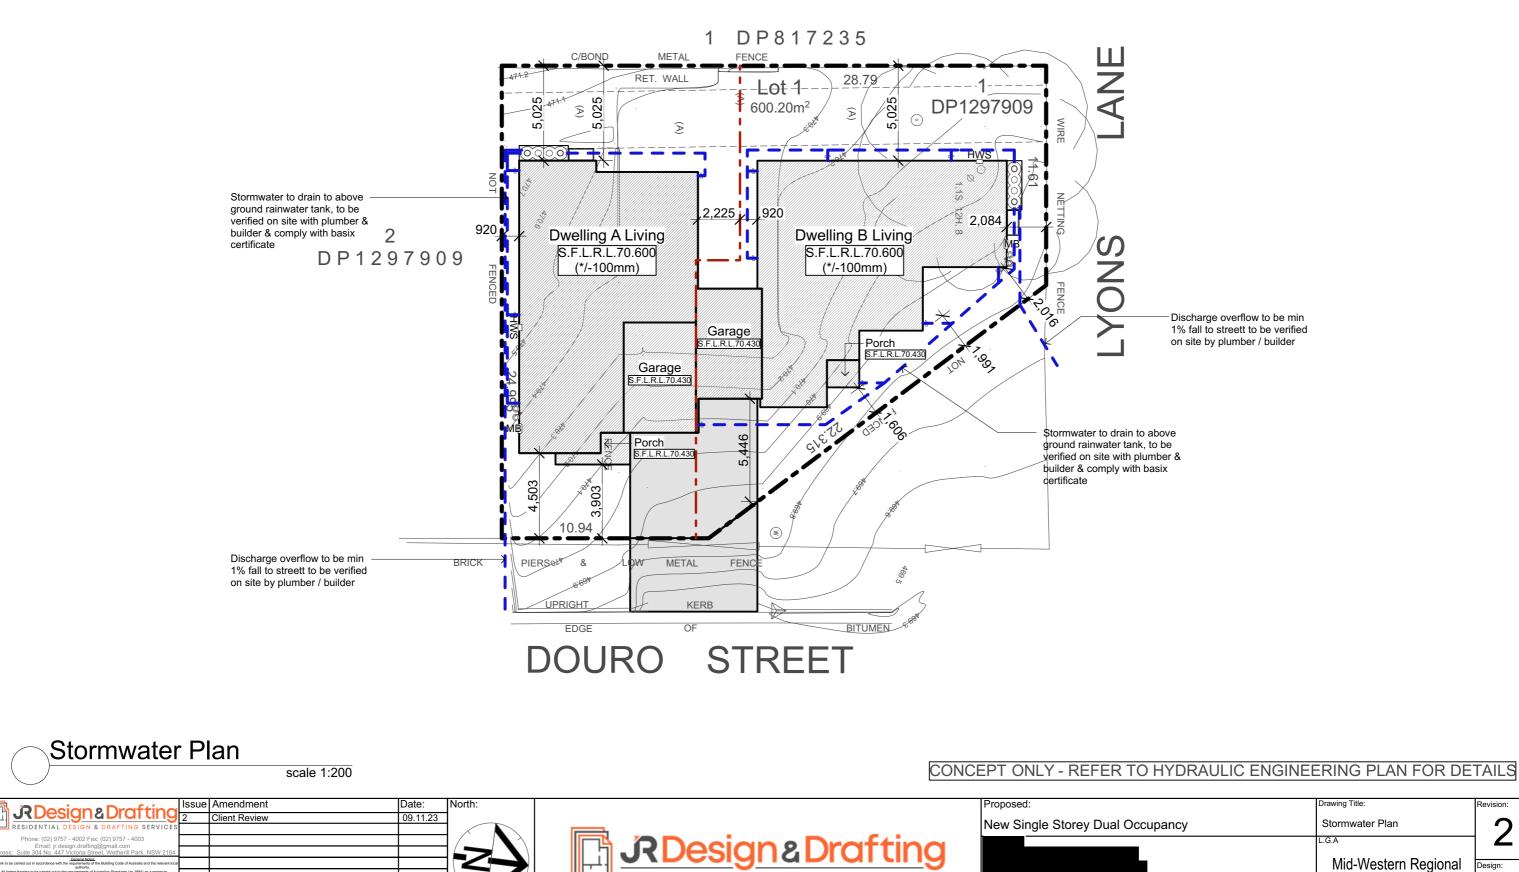

RESIDENTIAL DESIGN & DRAFTING SERVICES


ITESS. Outnot Control Control Note: Clearate Note: Role to be carried out in accordance with the requirements of Australian Standards (as 1684) as a minimum A instruction of the carried out the magnitements of Australian Standards (as 1684) as a minimum A instructed concrete, steel beams including supports, and normated seems including supports. In English Carried Standards and Standards and Standards and Standards (as 1684) as a minimum A instructed concrete, steel beams including supports, and normated seems including supports. In English Carried Standards and Standards and Standards and Standards and Standards (as 1684) as a minimum A instructed concrete, steel beams including supports, and normated seems including supports. The Standards and Standards (as 1684) as a minimum carried set of the Standard Standards (as 1684) as a minimum of the Standards (as 1684) as a minimum A instructed set of the Standard Standards (as 1684) as a minimum of the Standards (as 1684) as a minimum


al Engineer to check, detail and certify brickwork to garage area with a height greater than 3000m horizontial supports. All brickwork to be constructed in accordance with the requirements of the Building Code of Austra

<u>Copyright:</u> This plan is the exclusive property of JR Design & Drafting. and must not be used, reproduced or copied wholly in any way without permission

	Drawing	Revision:			
ancy	Stormwater Plan				2
	L.G.A				
	Mic	Design:			
	Facade :	CUSTOM	Date	09.11.23	CUSTOM JR Job No:
	Scale	1:200	Sheet	4 of 11	2304


Discharge overflow to be min 1% fall to streett to be verified on site by plumber / builder

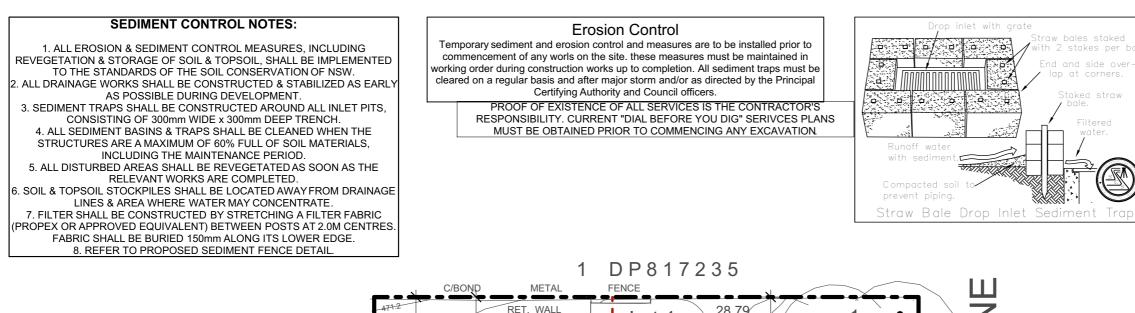


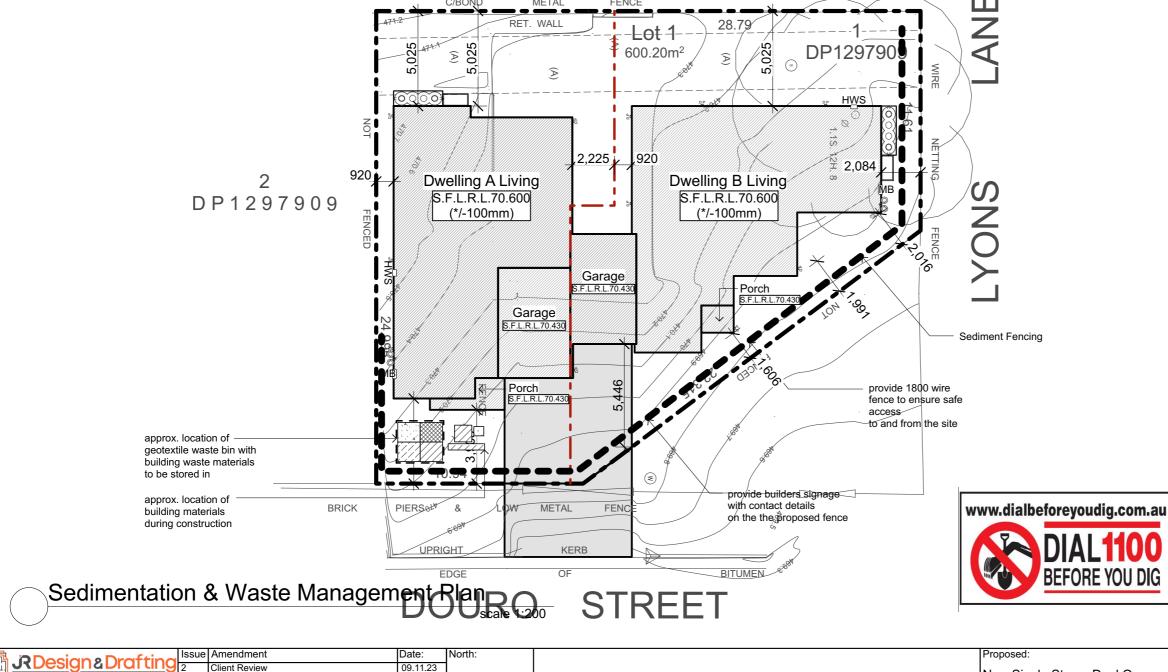


	4		09.11.23		
RESIDENTIAL DESIGN & DRAFTING SERVICES					
Phone: (02) 9757 - 4002 Fax: (02) 9757 - 4003				$ \left  \right\rangle^{1} \left  \right\rangle$	
Email: jr.design.drafting@gmail.com Address: Suite 304 No. 447 Victoria Street, Wetherill Park. NSW 2164					
General Notes: All work to be carried out in accordance with the requirements of the Building Code of Australia and the relevant local authority.					
<ol> <li>All timber framing to be carried out to the requirements of Australian Standards (as 1684) as a minimum.</li> <li>All reinforced concrete, steel beams including supports, and nominated beams including supports to Engineer's details</li> </ol>					
Bruchural Engineer to check, detail and certify tokicules for sprange seta with a height greater than 3000mm between boccordial support. 6. All proteivork to be constructed in accordance with the requirements of the Building Code of Australia. Control prints inclusions to be provided in accordance with the requirements of the Building Code of Australia. Doorway openings with inward opening doors to room containing tolets which are closer than 1200mm to the tolet are to be fitted with	This pla	Copyright: In is the exclusive property of JR Design & Drafting. and ed, reproduced or copied wholly in any way without per			

RESIDENTIAL DESIGN & DRAFTING SERVICES

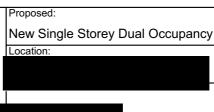

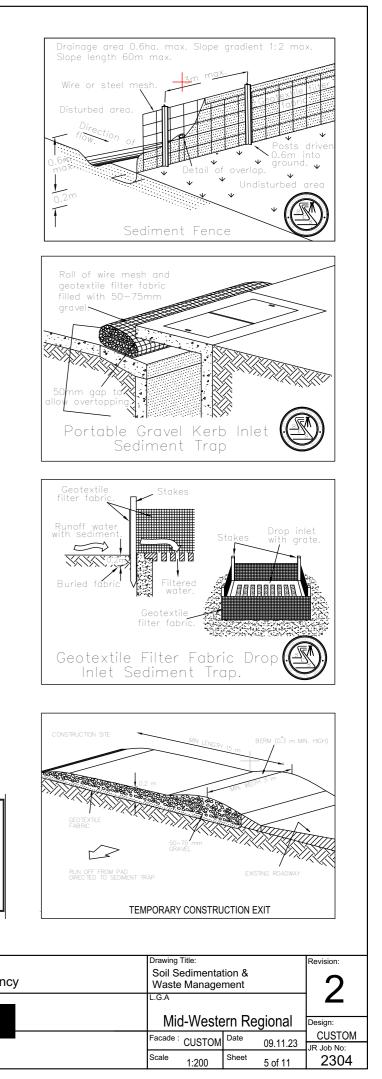


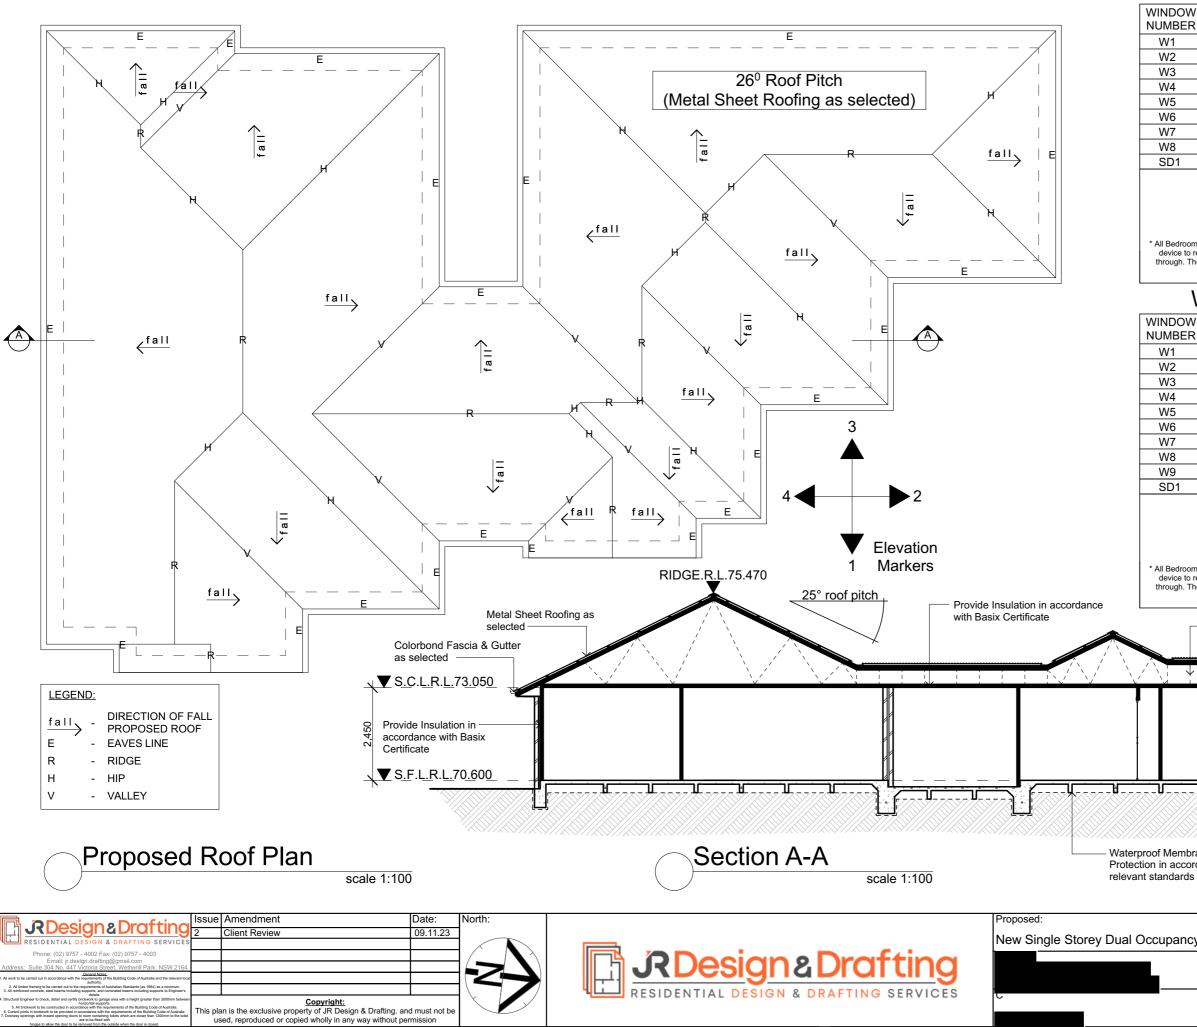

DOW BER	HEIGHT (mm)	WIDTH (mm)	COMMENT	REVEAL
	( )	1210		
	1800		Aluminium Double Hung	Cladding
2 3 4 5 6 7	1800	1210	Aluminium Double Hung	Cladding
2	860	610	Aluminium Sliding Obscure	Brick Veneer
+	1030	1810	Aluminium Sliding	Brick Veneer
)	1030	1810	Aluminium Sliding Obscure	Brick Veneer
) 7	1030	1810	Aluminium Sliding	Brick Veneer
3	1030	850	Aluminium Sliding	Brick Veneer
	1030	850	Aluminium Sliding	Brick Veneer
1	2100	3610	Aluminium Sliding Door	Brick Veneer
ce to res	trict the window o device of screen r	or level more that pening, or a suita nust also be able	leight + 60mm Note: n 2 meters from natural ground level ble screen, so a 125mm diameter sp to withstand an outward horizontal fr D BE FITTED WITH RESTRICTORS	ohere cannot pass orce of 250 N. ALL
			dule Dwelling	g B
DOM	HEIGHT	WIDTH	COMMENT	REVEAL
BER	(mm)	(mm)		
	1800	2650	Aluminium Double Hung	Cladding
2	600	1570	Aluminium Sliding	Brick Veneer
3	600	1570	Aluminium Sliding	Brick Veneer
l.	1800	1210	Aluminium Double Hung	Brick Veneer
5	1800	1210	Aluminium Double Hung	Brick Veneer
6 7	860	610	Aluminium Sliding Obscure	Brick Veneer
	1030	1810	Aluminium Sliding	Brick Veneer
3	1030	1570	Aluminium Sliding Obscure	Brick Veneer
) )1	1800 2100	1210 3610	Aluminium Sliding Aluminium Sliding Door	Brick Veneer Brick Veneer
ce to res	Vindows with a flo	* All Windows to b Before * Frame Stud -Window V -Window H or level more that pening, or a suita	to Standard Windows Spec. e counted & checked ordering I Openings to be: Width + 70mm leight + 60mm Note: n 2 meters from natural ground level ble screen, so a 125mm diameter sp to withstand an outward horizontal fr	must be fitted with a here cannot pass
	Roof Trusses Roof Man. D	s to etails		3
¥				
			<u> </u>	<u>.</u> L. <u>73</u> .0 <u>5</u> 0 <b>V</b>
			Colorbond Faso as selected	
			→ → Waffle Pod Slab Details	.L. <u>70.60</u> 0 <b>T</b>


Waffle Pod Slab to Eng. Details S.F.L.R.L.70.600 Waterproof Membrane & Termite Protection in accordance with all relevant standards Drawing Title: Roof Plan. Section A-A

ancy	Roof Plan, Section A-A & Window Schedule				2
	Mid-Western Regional				Design:
	Facade :	CUSTOM	Date	09.11.23	CUSTOM JR Job No:
	Scale	1:100	Sheet	7 of 11	2304

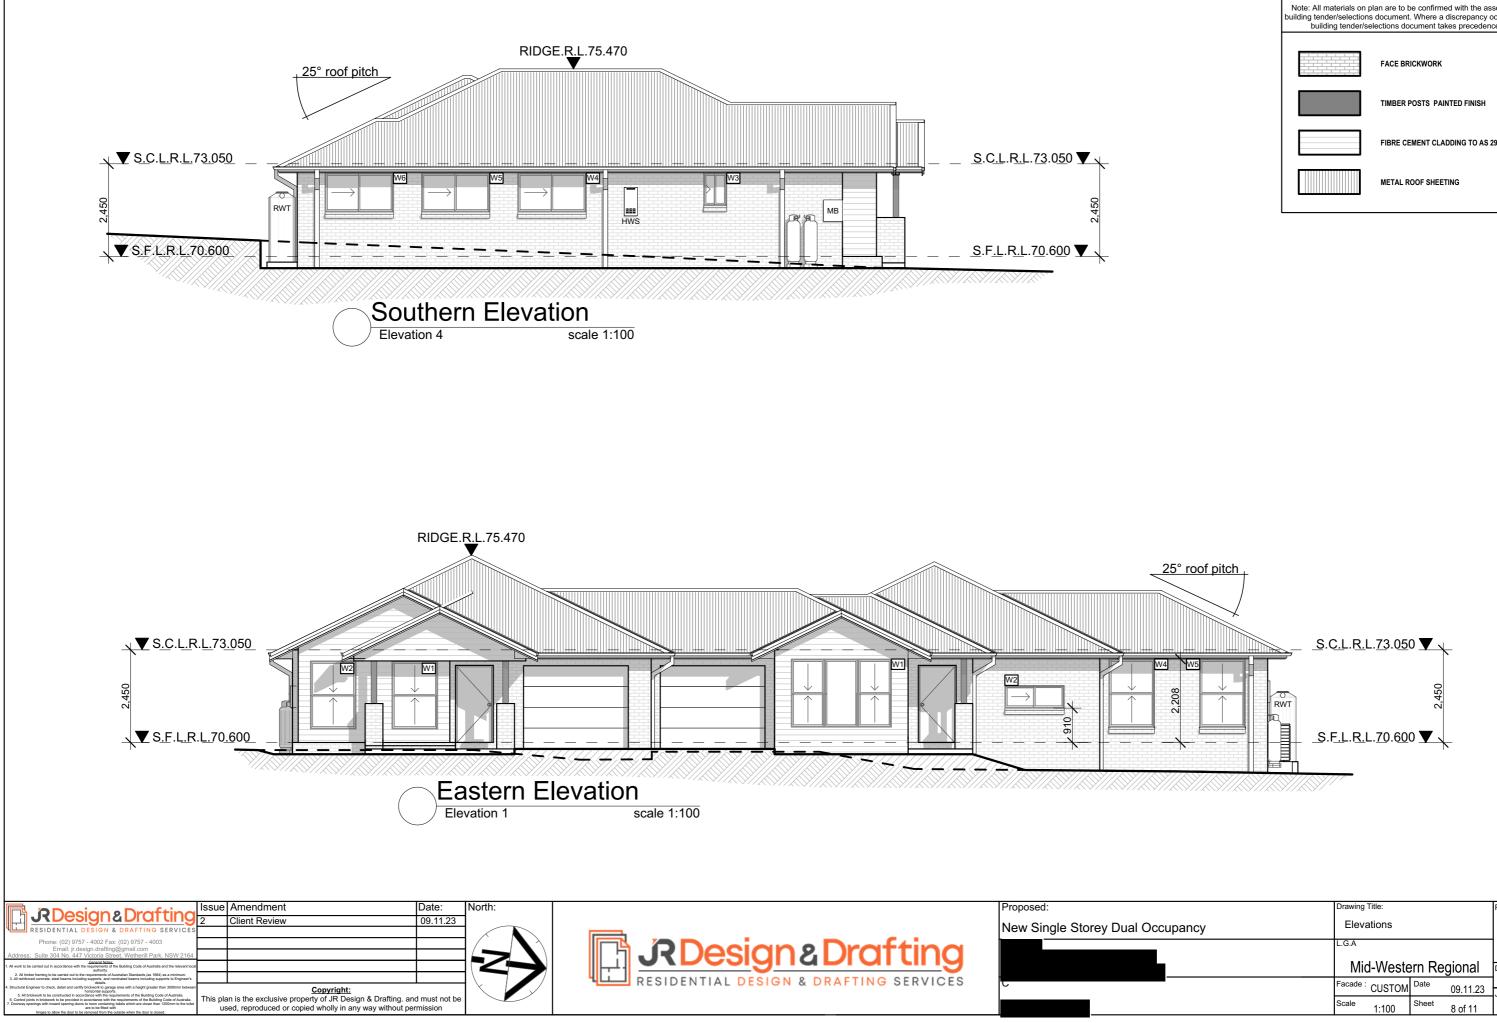


MATERIALS LEGEND:						
building tender/selection	Note: All materials on plan are to be confirmed with the associated building tender/selections document. Where a discrepancy occurs, the building tender/selections document takes precedence.					
	FACE BRICKWORK					
	TIMBER POSTS PAINTED FINISH					
FIBRE CEMENT CLADDING TO AS 2908.2						
METAL ROOF SHEETING						
1						

	Drawing Title:				Revision:
ancy	Eleva	2			
	L.G.A				2
	Mid-Western Regional			Design:	
	Facade :	CUSTOM	Date	09.11.23	CUSTOM JR Job No:
	Scale	1:100	Sheet	8 of 11	2304

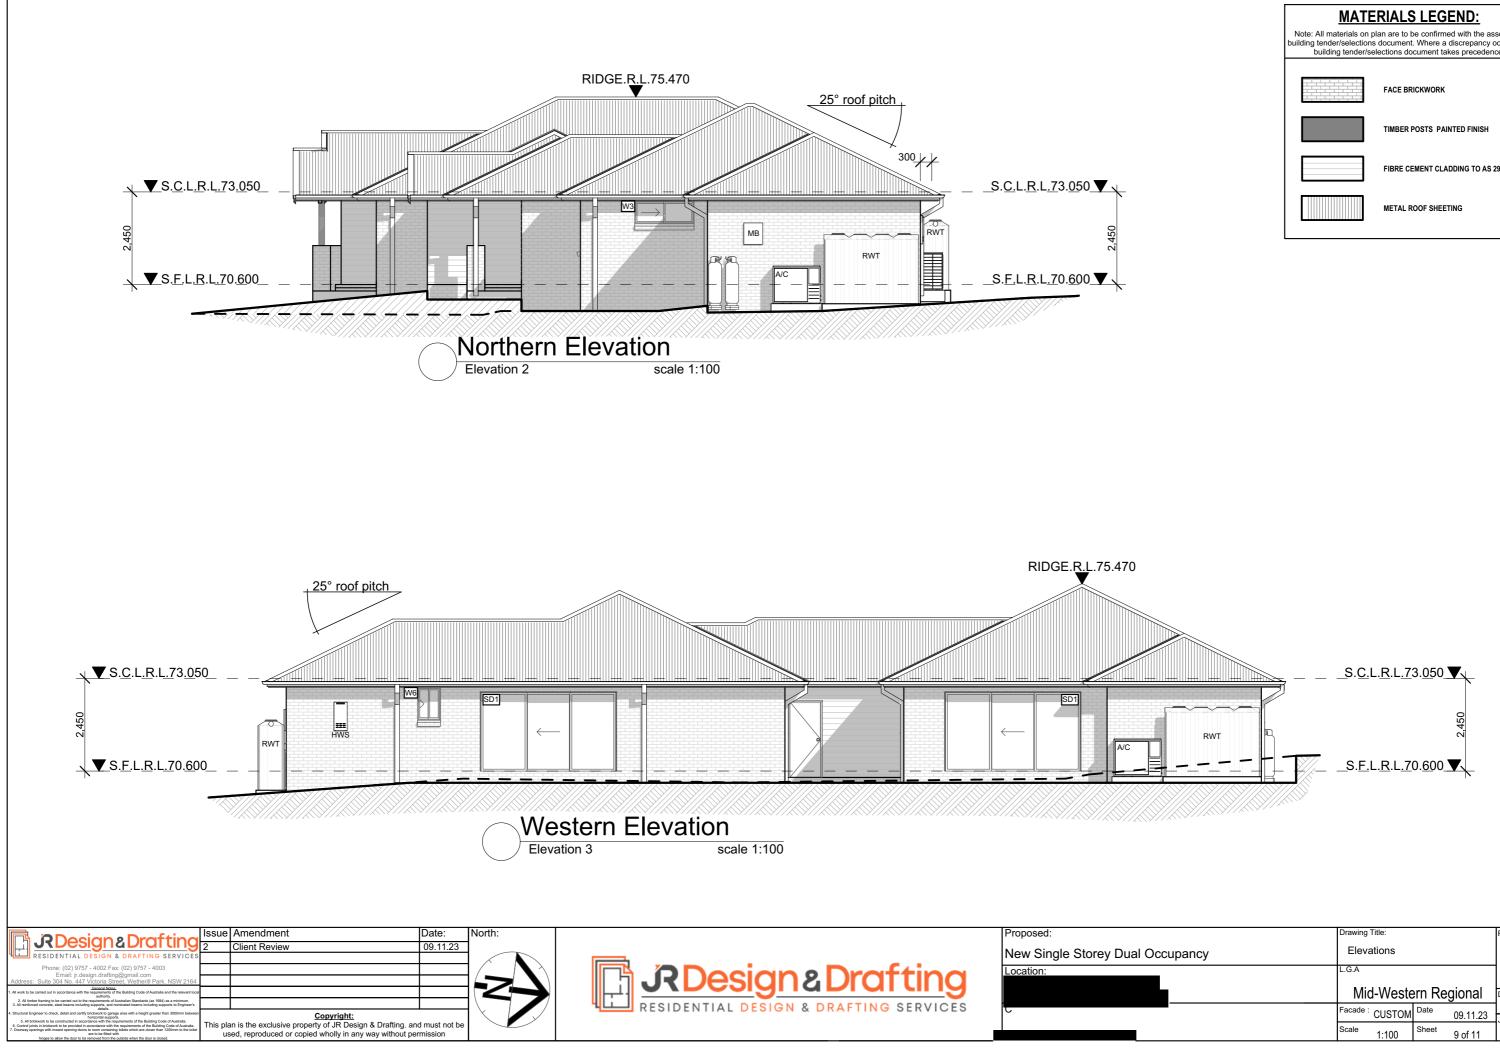


MATERIALS LEGEND:						
building tender/selection	Note: All materials on plan are to be confirmed with the associated building tender/selections document. Where a discrepancy occurs, the building tender/selections document takes precedence.					
	FACE BRICKWORK					
	TIMBER POSTS PAINTED FINISH					
	FIBRE CEMENT CLADDING TO AS 2908.2					
	METAL ROOF SHEETING					

	Drawing	Revision:			
ancy	Elevations				2
	L.G.A				
	Mic	d-Weste	ern Reg	gional	Design:
	Facade :	CUSTOM	Date	09.11.23	CUSTOM
	Scale	1:100	Sheet	9 of 11	2304

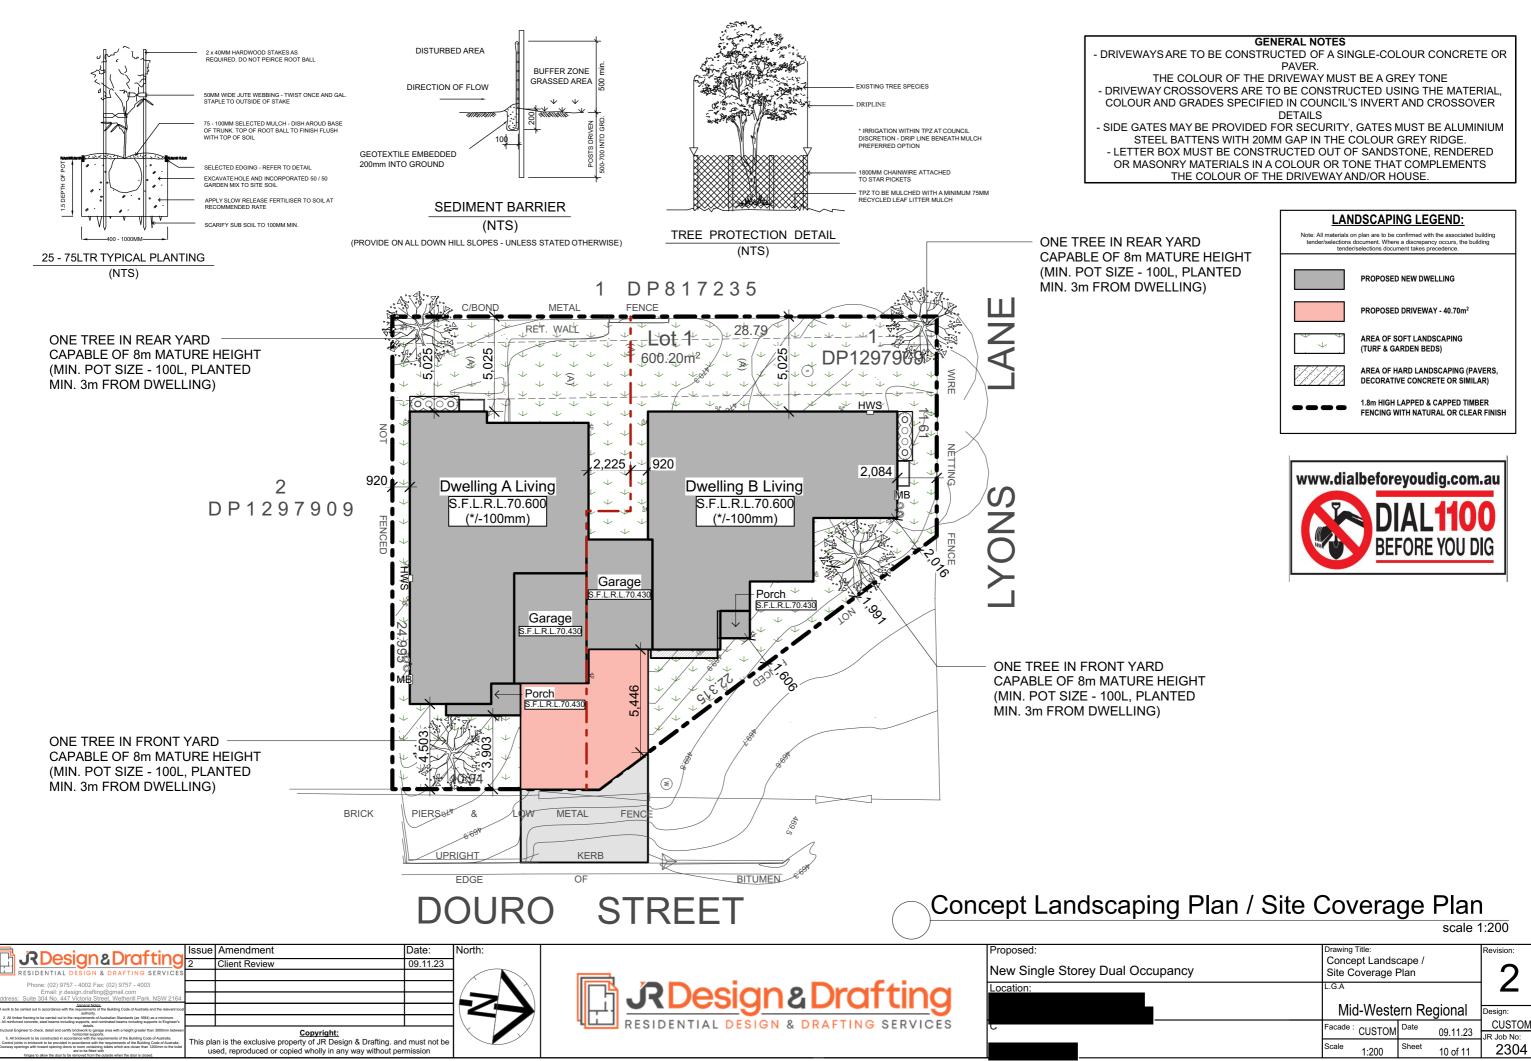

	Drawing Title:	Revision:	
ancy	Concept Landso Site Coverage F	2	
	L.G.A		
	Mid-Weste	Design:	
	Facade : CUSTOM	Date 09.11.	22 CUSTOM
		09.11.	JR Job No:
	Scale 1:200	Sheet 10 of 1	11 2304

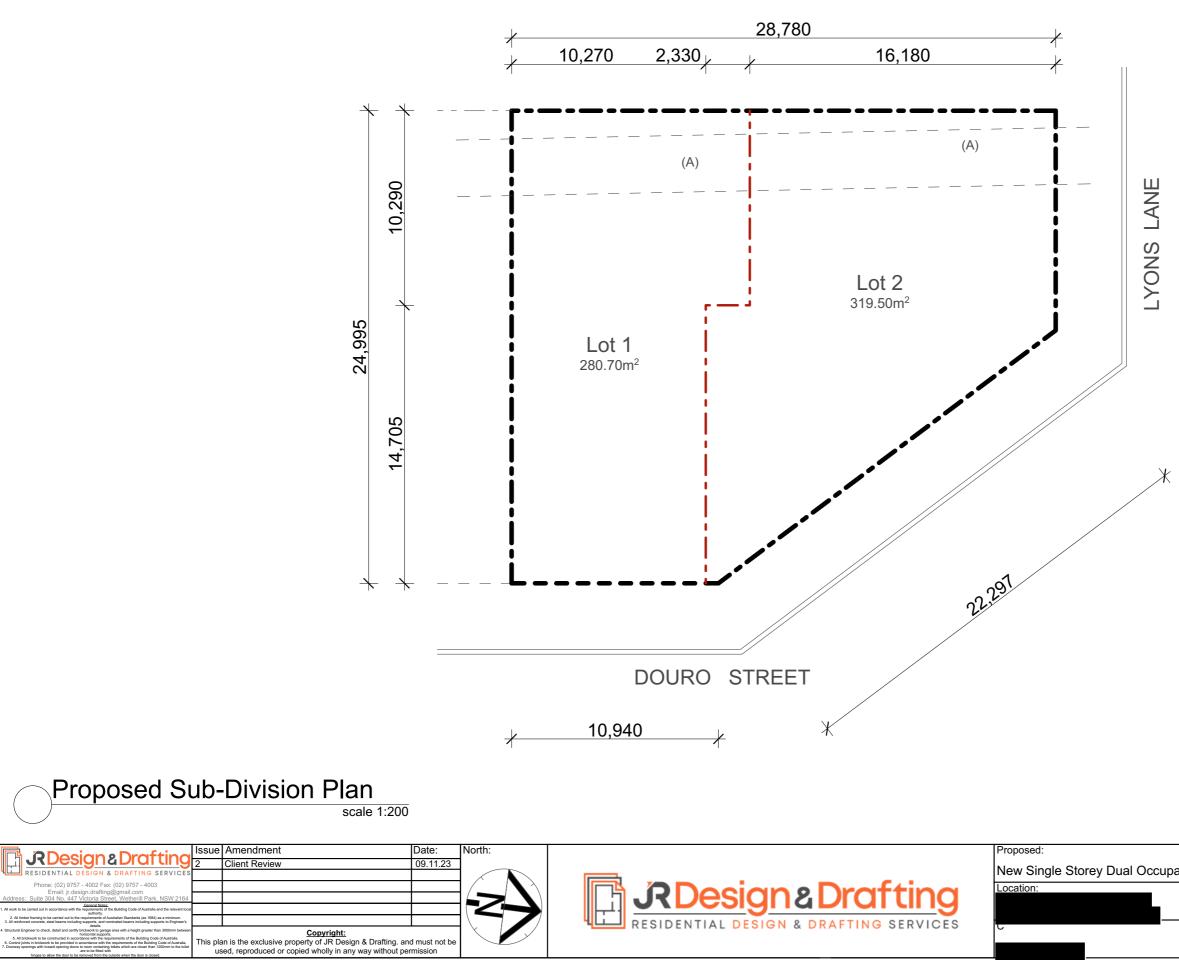



	Drawing Title:				Revision:
ancy	Proposed Sub-Division Plan			2	
	L.G.A				
	Mid-Western Regional				Design:
	Facade :	CUSTOM	Date	09.11.23	CUSTOM
	Scale	1:200	Sheet	11 of 11	2304