


FINISH SCHEDULE			
BRICKS	Austral range Everyday Life - Unwind		
ROOFING	Colorbond - Surfmist		
FASCIA & GUTTERS	Colorbond Windspray		
ALL CEILINGS	Dulux Wash & Wear - White on White		
OFFICE WALLS	Dulux Wash & Wear - Lexicon Quarter strength		
SKIRTING BOARDS & ARCHITRAVES	Dulux Wash & Wear - Windspray Half strength		
DOORS	Dulux Wash & Wear - Windspray		
BENCH TOPS	Laminex - Fresh Snow, Natural		
CABINETRY PANELS	Laminex - Pewter 329 Absolute matt finish		
OUTDOOR KITCHEN BENCHES	Stainless steel		

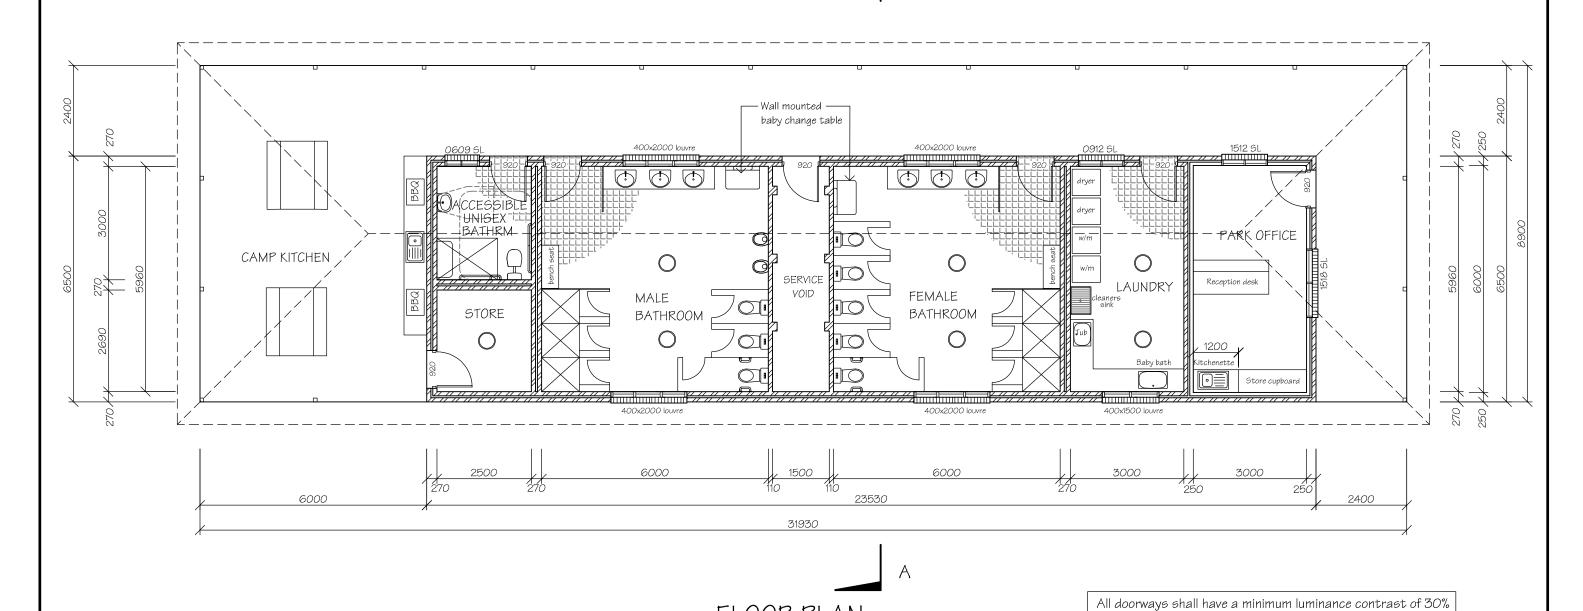

FLOOR PLAN

SCALE 1:100

1000mm 0 1m 2m 3m 4m 5m METRES

Presentation:

RELIABLE DRAFTING SERVICE

Kate Foody 12 Alexander Street EGLINTON 2795 ph. 63 371116 Mob. 0402608213 A.B.N. 60 167 131 984

email kate@draftingservice.net.au

PROPOSED OFFICE & AMENITIES BLOCK RYLSTONE CARAVAN PARK CARWELL ST., RYLSTONE

Client:

MID WESTERN REGIONAL COUNCIL


oor Areas:			
AMENITIES:	79.8m²	:	
CAMP KITCHEN	l: 49.8m²	2	
TOTAL:	129.6m	2	
ob No.	DWG. No.	Amdt.	No
01 70	1 4	b	


to comply with AS1428.1 - Design for Access & Mobility Minimum width of the area of luminance shall be 50mm

 Job No.
 DWG. No.
 Amdt.
 No. in sec

 21.72
 1
 B
 5

 Scale: AS SHOWN
 Date: 16-7-21
 File: 2172.dwg

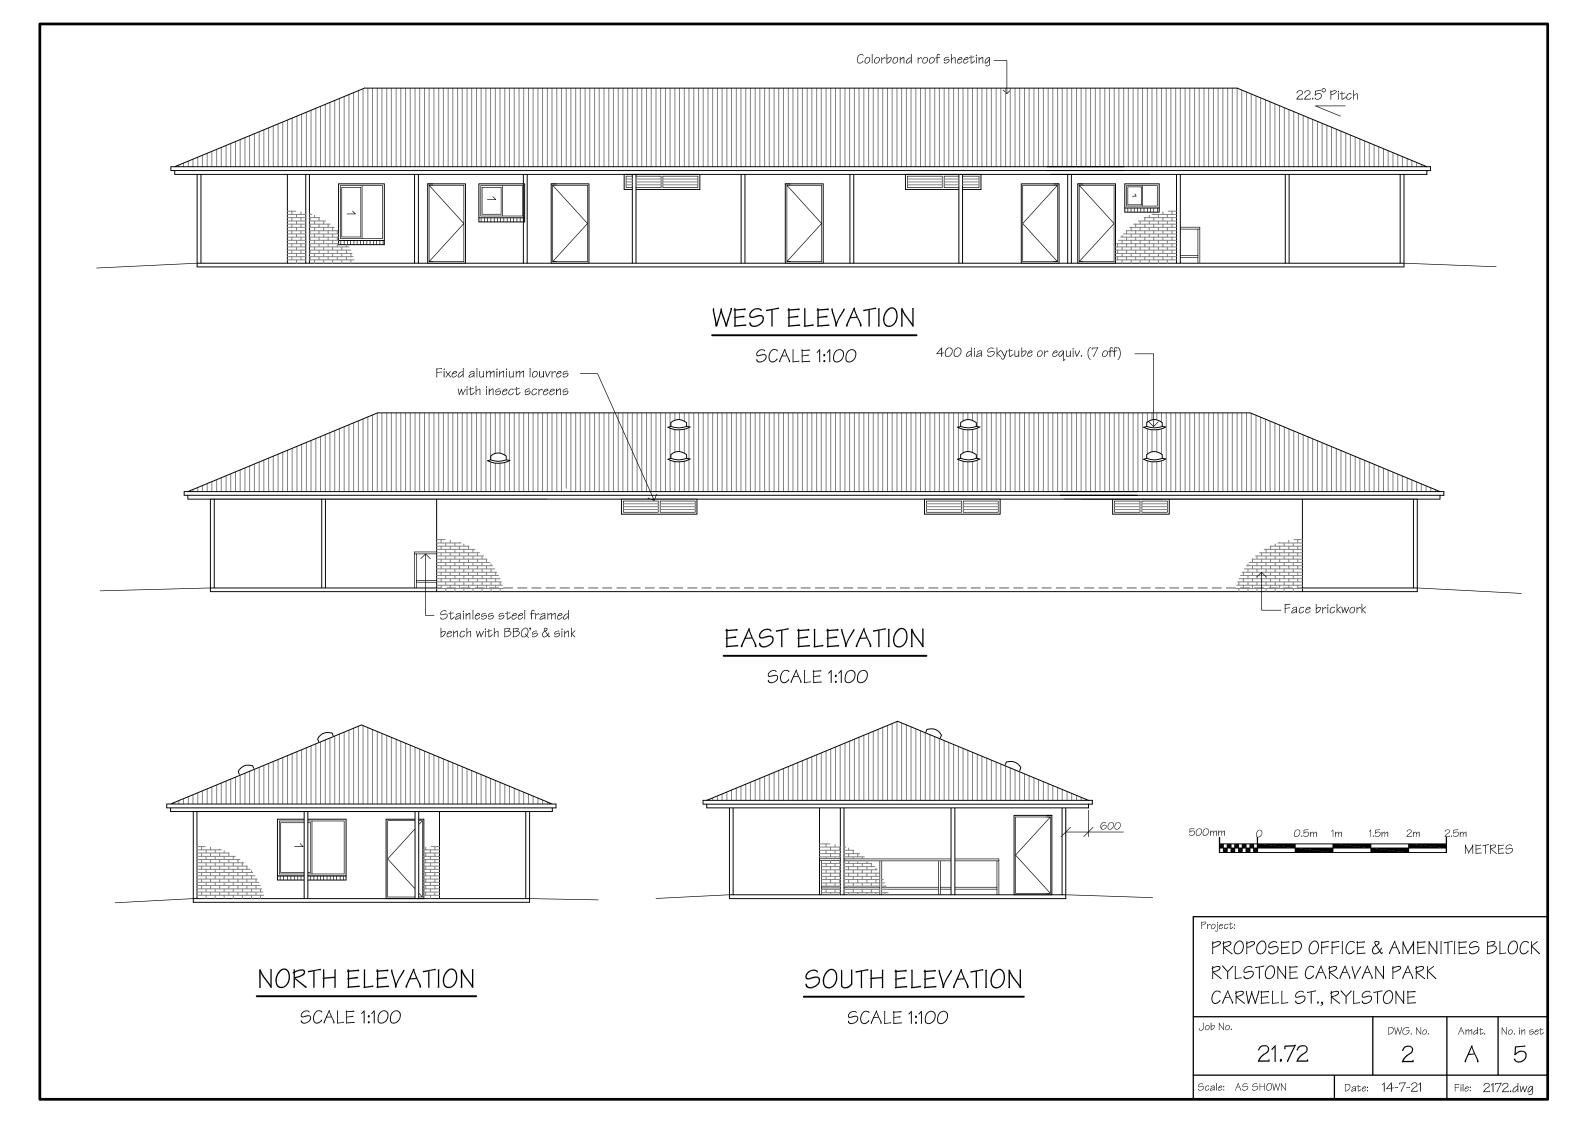

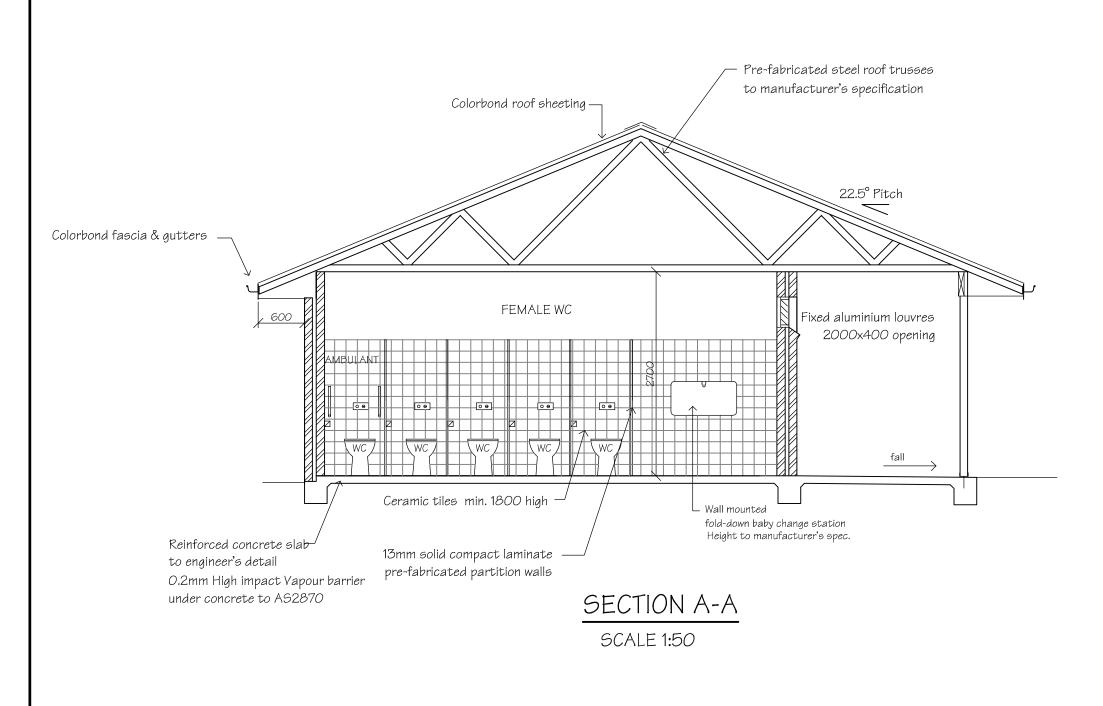

Section J BCA requirements - Rylstone Caravan Park - amenities block & office

(to be read in conjunction with Section J report)

- Insulation (office area only)

 Roof (light colour with SA<0.45): reflective sarking
 Ceiling: R3.5
 External walls: R2.0 and sarking
 Internal walls adjoining laundly: R2.0
 Floor: R1.1 Kooltherm K3 board (office area only)

External windows & glass doors (office area only) • All façades: U=5.8 SHGC=0.60

- Glazing to comply with AS2047

Draught sealing (office area only)

External door to have foam seal around perimeter, draught stopper along bottom edge and self-

- Air conditioning (office area only)

 Package AC units to comply with MEPS


 Minimum COP/EER of 2.90
- Any AC unit with a heating or cooling capacity of more than 2kWr to have a time switch controller (refer to spec J6 of BCA for details).

- All new external lighting
 All new external lighting to be controlled by either a daylight sensor or time switch and where total perimeter lighting exceeds 100W have a minimum of 90% of light fittings to be LEDS or be controlled by a motion sensor.
 Façade lighting or illuminated signs to be controlled by a time switch or daylight sensor.

Heated sanitary water systems to be designed and installed as per part B2 NCC vol. 3

PROPOSED OFFICE & AMENITIES BLOCK RYLSTONE CARAVAN PARK CARWELL ST., RYLSTONE

Job No.		DWG. No.	Amdt.	No. in set
21.72		3	В	5
Scale: AS SHOWN	Date:	15-7-21	File: 21	72 dwa

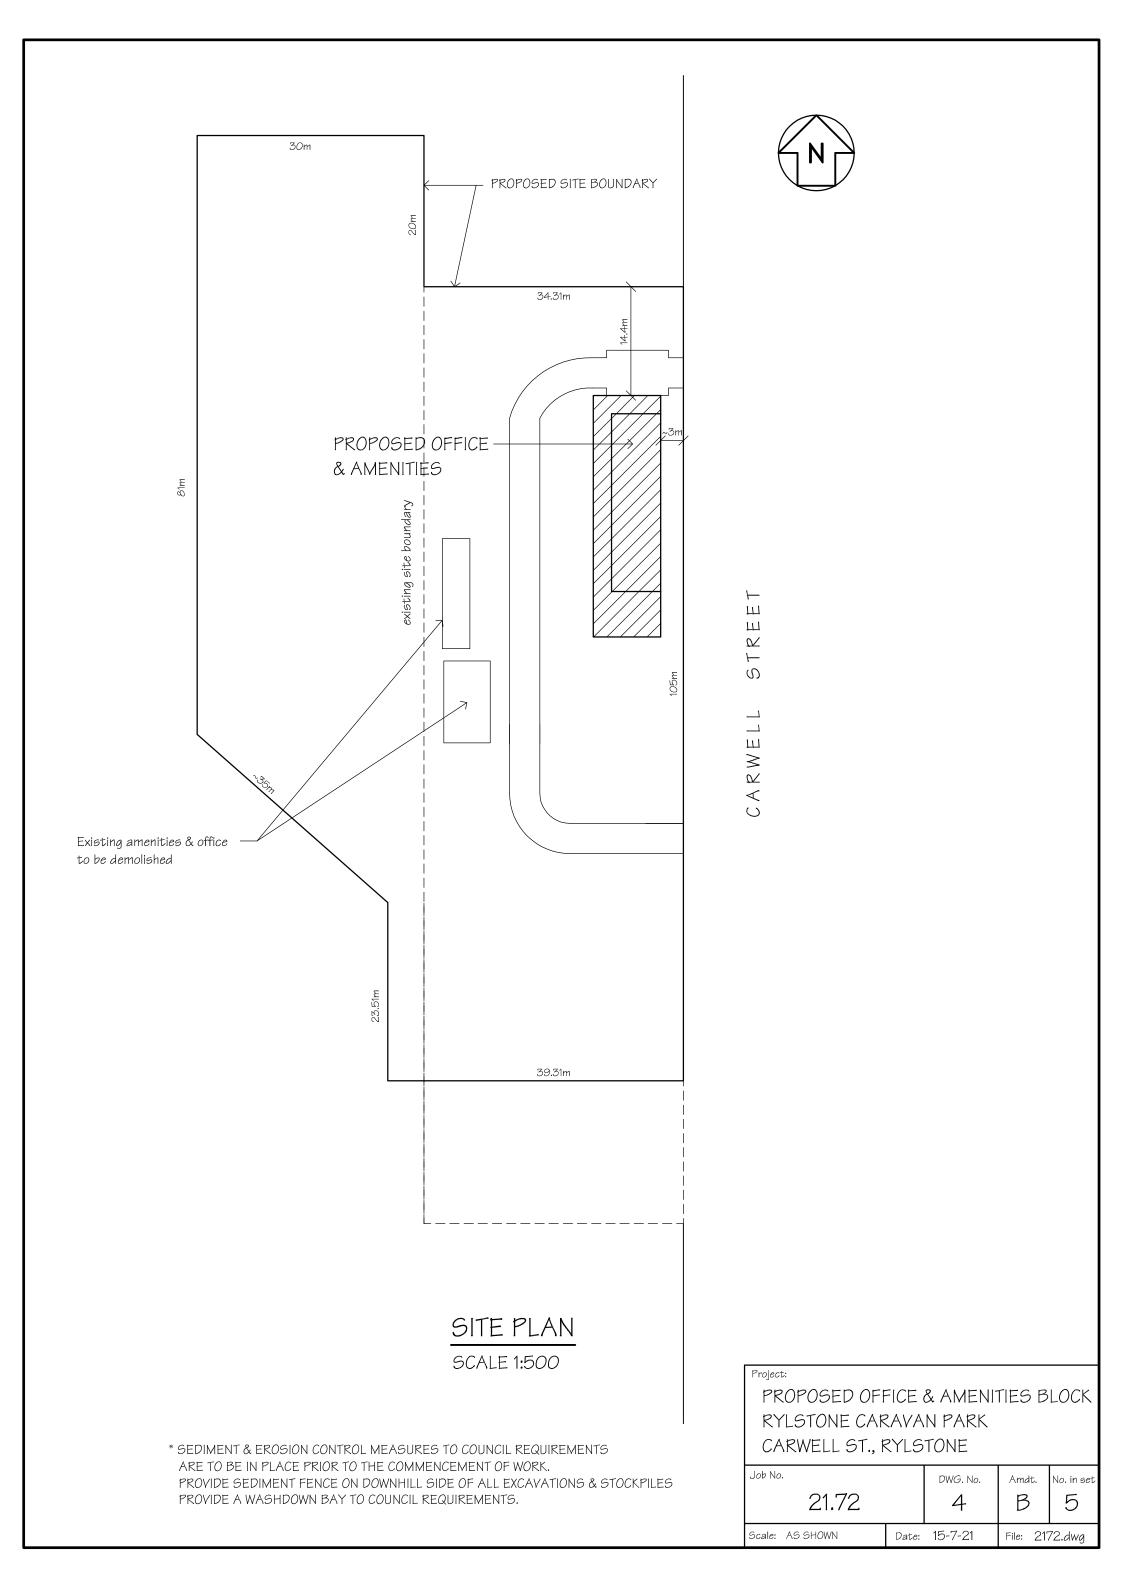

NOTES

GENERAL

PRIOR TO ANY EXCAVATION OR CONSTRUCTION ON THE SITE, THE RELEVANT AUTHORITY SHOULD BE CONTACTED FOR LOCATION UNDERGROUND SERVICES.

THE DRAWINGS SHOW THE MAJOR WORK TO BE CARRIED OUT BUT ARE NOT NECESSARILY THE TOTAL WORKS REQUIRED FOR THE PROJECT.

ALL WORK SHALL BE CARRIED OUT IN ACCORDANCE WITH THE NATIONAL CONSTRUCTION CODE (N.C.C. Vol. 1. 2019).

ALL MATERIALS & STRUCTURES SHALL COMPLY WITH SECTION B - STRUCTURE, & SPEC. C1.10 OF THE N.C.C.

IT IS THE RESPONSIBILITY OF THE BUILDER TO VERIFY DOCUMENTS AS TO THEIR ACCURACY & SUITABILITY.

ALL STEEL & CONCRETE MEMBERS SHALL BE CONSTRUCTED IN ACCORDANCE WITH THE ENGINEER'S DETAILS & RELEVANT CODES & AUSTRALIAN STANDARDS

ALL DIMENSIONS SHALL BE VERIFIED ON SITE.

BUILDING SITE SHALL BE SECURED WITH MANPROOF CHAINWARE FENCING DURING CONSTRUCTION.

FABRICATOR TO MEASURE & CHECK DETAILS ON SITE.

SOIL & SEDIMENT EROSION CONTROL SHALL BE UNDERTAKEN IN ACCORDANCE WITH THE REQUIREMENTS OF MID WESTERN REGIONAL COUNCIL & THE ENVIRONMENTAL PROTECTION AGENCY.

ALL STORMWATER DRAINAGE WORK SHALL BE IN ACCORDANCE WITH AS/NZ 3500.3.2

FIRE HAZARD PROPERTIES OF ALL MATERIALS & ASSEMBLIES MUST COMPLY WITH PART C1.10 OF BCA.

THE ELECTRICITY SUPPLY SYSTEM SHALL COMPLY WITH PART C2.13 OF THE N.C.C.

ACCESS & EGRESS

REQUIRED PATHS OF EXIT BE IN ACCORDANCE WITH PART D1.6 OF THE N.C.C. THE UNOBSTRUCTED HEIGHT MUST BE NO LESS THAN 2.0m EXCEPT AT DOORWAYS WHERE THE HEIGHT MAY BE REDUCED TO 1.98m. THE UNOBSTRUCTED WIDTH OF EACH EXIT OR PATH OF TRAVEL TO AN EXIT, EXCEPT AT DOORWAYS, MUST BE 1.0m MINIMUM.

DISTANCES TO REQUIRED EXITS MUST BE MEASURED ALONG THE SHORTEST PATH OF TRAVEL, WHETHER BY STRAIGHT LINES, CURVES, OR COMBINATION OF BOTH.

DISCHARGE FROM EXITS MUST BE IN ACCORDANCE WITH N.C.C. D1.10. EXITS MUST NOT BE BLOCKED AT THE POINT OF DISCHARGE, AND WHERE NECESSARY SUITABLE BARRIERS MUST BE PROVIDED TO

PREVENT VEHICLES FROM BLOCKING EXIT.

OPERATION OF LATCHES MUST BE IN ACCORDANCE WITH PART D2.21 OF THE N.C.C. A REQUIRED EXIT DOOR MUST BE READILY OPENABLE WITHOUT A KEY FROM THE SIDE THAT FACES THE PERSON SEEKING EGRESS BY A SINGLE HAND DOWNWARD ACTION OR PUSHING ACTION ON A SINGLE DEVICE WHICH IS LOCATED BETWEEN 900mm AND 1200mm FROM THE FLOOR.

BUILDINGS & PARTS OF BUILDINGS MUST BE ACCESSIBLE AS REQUIRED BY PART D3.1 OF THE N.C.C.

AN ACCESSWAY MUST BE PROVIDED TO THE BUILDING FROM THE MAIN POINTS OF PEDESTRIAN ENTRY; & FROM ANOTHER ACCESSIBLE BUILDING CONNECTED BY A PEDESTRAIN LINK; & FROM ANY REQUIRED ACCESSIBLE CARPARKING SPACE ON THE ALLOTMENT; AS REQUIRED BY PART D3.2 OF THE N.C.C.

PARTS OF THE BUILDING REQUIRED TO BE ACCESSIBLE FOR PEOPLE WITH DISABLITIES MUST COMPLY WITH PART D3.2 & D3.3 OF THE N.C.C. & AS 1428.1

PROVIDE A CONTINUOUS ACCESSIBLE PATH OF TRAVEL IN ACCORDANCE WITH AS 1428.1 AND CLAUSE D3.3 OF THE N.C.C. FROM THE DISABLED ACCESSIBLE CARSPACE TO THE ENTRANCE POINTS OF THE BUILDING.

PROVIDE CLEAR & LEGIBLE BRAILLE & TACTILE SIGNAGE IN ACCORDANCE WITH AS1428.1, TO INDENTIFY SANITARY FACILITIES AND PATH OF TRAVEL FROM PRINCIPAL PUBLIC ENTRANCE, TO COMPLY WITH PART D3.6 OF THE N.C.C.

PROVIDE TACTILE GROUND SURFACE INDICATORS WHERE PATH OF TRAVEL MEETING A VEHICULAR WAY ADJACENT TO PRINCIPAL PUBLIC ENTRANCE OF THE BUILDING, IF THERE IS NO KERB OR KERB RAMP, IN ACCORDANCE WITH PART D3.8 OF THE N.C.C.

TO COMPLY WITH PART D3.12 OF THE N.C.C, ON AN ACCESSWAY, WHERE THERE IS NO CHAIR RAIL, HANDRAIL OR TRANSOM, ALL FRAMELESS OR FULLY GLAZED DOORS, SIDELIGHTS OR OTHER GLAZING CAPABLE OF BEING MISTAKEN FOR A DOORWAY OR OPENING, MUST BE CLEARLY MARKED IN ACCORDANCE WITH AS 1428.1

SERVICES AND EQUIPMENT

PROVIDE PORTABLE FIRE EXTINGUISHERS TO COMPLY WITH PART E1.6 OF THE N.C.C.

HEALTH & AMENITY

METAL ROOF COVERING SHALL IN ACCORDANCE WITH AS1562.1, TO COMPLY WITH WITH PART F1.5 OF THE N.C.C.

SARKING MATERIALS MUST COMPLY WITH AS/NZS 4200 Parts 1 & 2 IN ACCORDANCE WITH PART F1.6 OF THE N.C.C.

INSTALL ARTIFICIAL LIGHTING SYSTEM IN ACCORDANCE WITH AS/NZS 1680. TO COMPLY WITH PART F4.4 OF N.C.C.


Project:

PROPOSED OFFICE & AMENITIES BLOCK RYLESTONE CARAVAN PARK CARWELL ST., RYLSTONE

Job No.		DWG. No.	Amdt.	No. in set
21.72		15	Α	5
Scale: AS SHOWN	Date:	14-7-21	File: 21	72.dwa

SUPERVISOR & SUBCONTRACTORS TO CHECK ALL SET OUT DIMENSIONS AGAINST FINAL APPROVED PLANS PRIOR TO COMMENCEMENT OF CONSTRUCTION.

ANY DISCREPANCIES REVEALED IN SET OUT DIMENSIONS TO BE REPORTED IMMEDIATELY TO SURVEYORS PRIOR TO WORK PROCEEDING.

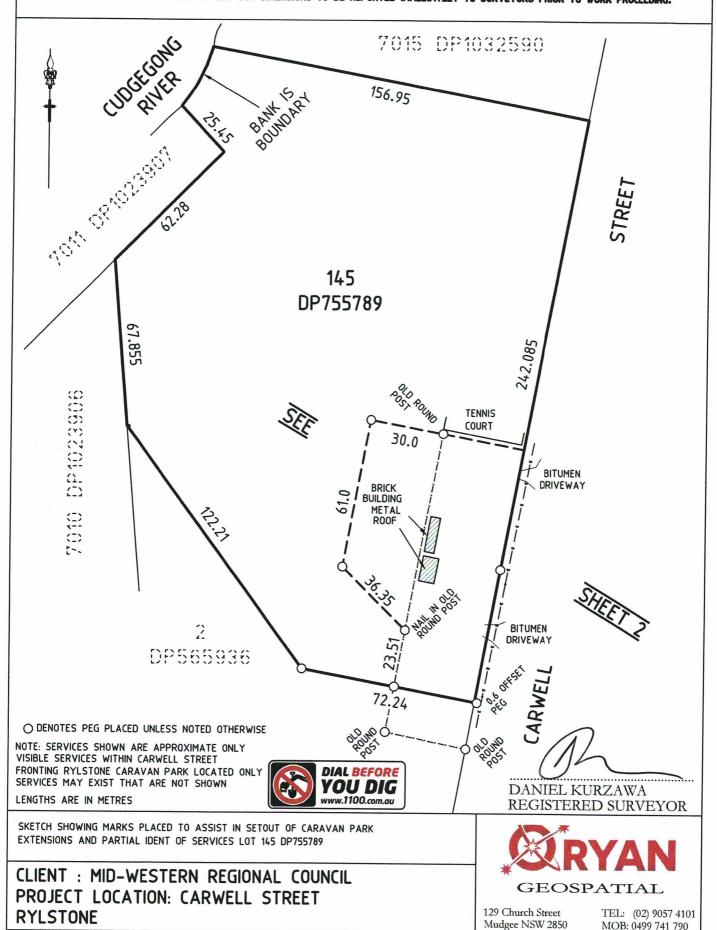

LEBGTHS ARE IN METRES. USE STATED DIMENSIONS. DO NOT SCALE.


REF: 21-657

SHT 1 OF 2

DATE: 26/02/2021

SUPERVISOR & SUBCONTRACTORS TO CHECK ALL SET OUT DIMENSIONS AGAINST FINAL APPROVED PLANS PRIOR TO COMMENCEMENT OF CONSTRUCTION.

ANY DISCREPANCIES REVEALED IN SET OUT DIMENSIONS TO BE REPORTED IMMEDIATELY TO SURVEYORS PRIOR TO WORK PROCEEDING.

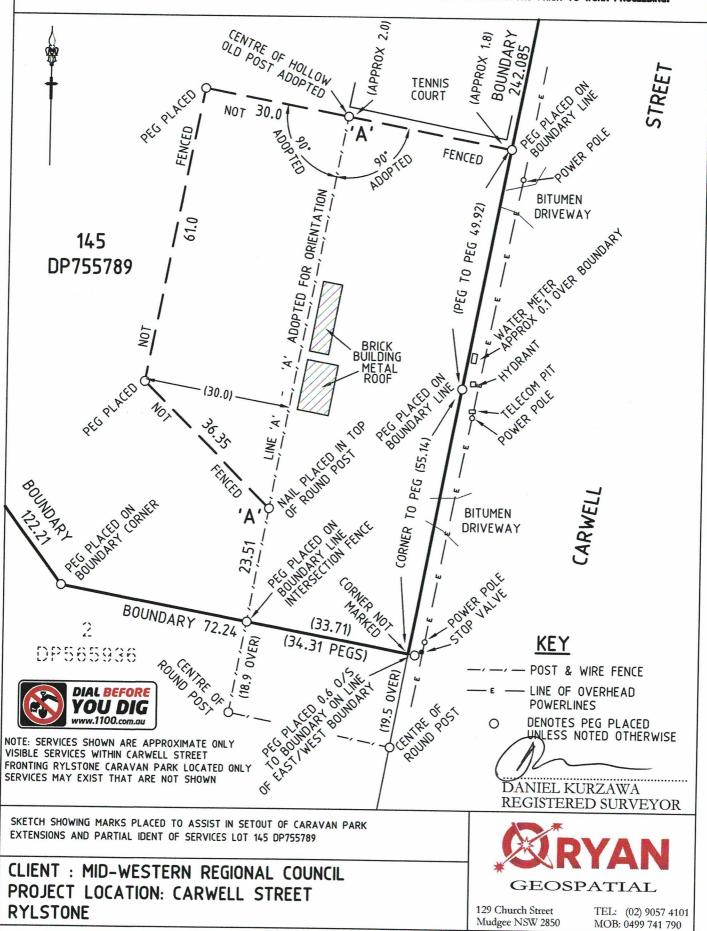

REF: 21-657

SHT 2 OF 2

DATE: 26/02/2021

LENGTHS ARE IN METRES. USE STATED DIMENSIONS. DO NOT SCALE