PROPOSED ALTERATIONS & ADDITIONS 34 Lang Street, Mudgee NSW 2850

| Drav | ving Register DA | |
|------------------|--|-----|
| Sheet Number | Sheet Name | |
| DA 0.1 | Cover Sheet | |
| DA 0.2 | Basix Certificate | |
| DA 0.3 | Spec. & Notes | |
| DA 0.4 | Spec. & Notes | |
| DA 0.5 | Spec. & Notes | |
| DA 1.0 | Survey | |
| DA 1.1 | Site Analysis | |
| DA 1.2 | Site Plan | |
| DA 1.3 | GFA Calculations | |
| DA 1.4 | LSA Calculation | |
| DA 1.5 DA 2.1 | Site Coverage Ground Floor Plan | |
| DA 2.1 DA 2.2 | Roof Plan | |
| DA 2.2 DA 3.1 | Elevations | |
| DA 3.2 | Elevations | |
| DA 3.2 DA 4.1 | Sections | |
| DA 4.1 DA 4.2 | Detail - Party Wall | |
| DA 4.2 DA 5.1 | Shadow Diagram (Existing) | Г |
| DA 5.2 | Shadow Diagram (Existing) | |
| DA 5.3 | Shadow Diagram (Existing) | |
| DA 5.4 | Shadow Diagram (Existing) | 1 |
| DA 5.5 | Shadow Diagram (Existing) | |
| DA 5.6 | Shadow Diagram (Existing) | 11 |
| DA 5.7 | Shadow Diagram (Existing) | |
| DA 5.8 | Shadow Diagram (Existing) | 1 |
| DA 5.9 | Shadow Diagram (Existing) | 11 |
| DA 5.10 | Shadow Diagram (New) | |
| DA 5.11 | Shadow Diagram (New) | |
| DA 5.12 | Shadow Diagram (New) | |
| DA 5.13 | Shadow Diagram (New) | IF |
| DA 5.14 | Shadow Diagram (New) | |
| DA 5.15 | Shadow Diagram (New) | |
| DA 5.16 | Shadow Diagram (New) | |
| DA 5.17 | Shadow Diagram (New) | ╞ |
| DA 5.18 | Shadow Diagram (New) | |
| DA 6.1 | Pool Plan | ┥┟ |
| DA 6.2 DA 6.3 | Pool Sections | |
| DA 6.3 DA 7.0 | Driveway Plan & Section Concept Drainage Plan | |
| DA 7.0 DA 7.1 | Construction Mgmt. Plan | |
| DA 7.2 | Proposed Landscape Plan | ▎┟ |
| DA 7.3 | Landscape Specifications | |
| DA 7.4 | Landscape Specifications | |
| DA 7.5 | Landscape Details | 11 |
| DA 8.0 | Window & Door Schedules | 11 |
| DA 9.1 | External Materials & Finishes | |
| DA 10.1 | Perspective | 11 |
| DA 10.2 | Perspective | |
| DA 10.3 | Perspective | |
| DA 10.4 | Perspective | |
| DA/CDC 1.1 | Site Plan | |
| DA/CDC 1.2 | GFA Calculation | ∣⊦ |
| DA/CDC 2.0 | Lower/Garage Ground Floor Plan | |
| DA/CDC 2.1 | Ground Floor Plan | I L |
| DA/CDC 2.2 | First Floor Plan | |
| DA/CDC 3.2 | Elevation | |
| DA/CDC 3.3 | Elevation | |
| DA/CDC 8.1 | Perspectives | |
| DA/CDC 9.1 | Perspective | |
| DA/CDC 9.2 | Perspective | |
| DA/CDC 9.3 | Perspective | |
| DA/CDC 9.4 | Perspective | I |



| DI ANINIC INCEDIMENTE | Mid-V | Mid-Western Regional Local Environmental Plan 2012 | | | | |
|------------------------|-------|--|--|--|--|--|
| PLANING INSTRUMENTS | Mid-V | Mid-Western Regional Development Control Plan 2013 | | | | |
| SITE IDENTIFICATION | LOT 4 | DP 790409 | | | | |
| ZONE | | R1 - General Residential | | | | |
| SITE AREA | | 964.1 m ² | | | | |
| EXISTING FLOOR AREA | | 149.07 m ² | | | | |
| SITE CONTROLS | | REQUIRED | | | | |
| GROSS FLOOR AREA | | Lot area >920 m ² –1,000 m ² : max. 25% of lot area + 150 m ² = 391.025 m ² | | | | |
| SITE COVERAGE | | max. 35 % | | | | |
| | FRONT | 6.5m to building line 7.5 to the garage | | | | |
| SETBACKS | SIDE | 0.9 m | | | | |
| | REAR | 0.9 m | | | | |
| BUILDING HEIGHT | | max. 8.5 m | | | | |
| PRIVATE OPEN SPACE | | min. 80 m ² | | | | |
| | | | | | | |

SITE & BUILDING CALCULATIONS



COPYRIGHT: ALL WORK IS TO COMPLY WITH THE BUILDING CODE OF AUSTRALIA, RELEVANT AUSTRALIAN STANDARDS & LOCAL AUTHORITY REQUIREMENTS. BUILDING CONTRACTOR & ALL RELEVANT SUB TRADES TO CHECK & VERIFY ALL DIMENSIONS & ASSOCIATED DRAWING PARTS PRIOR TO MANUFACTURE. CONSTRUCTION & INSTALLATION ON SITE. DO NOT SCALE OF DRAWINGS - WRITTEN DIMENSIONS TAKE PRECEDENCE. PLAN LAND ACCEPTS NO LIABILITY OR RESPONSIBILITY RESULTING FROM BUILDERS NEGLECT OR PREFERRED METHOD OF CONSTRUCTION FOR ANY BUILDING DEFECT.

METHOD OF CONSTRUCTION FOR ANY BUILDING DEFECT. THESE DRAWINGS ARE THE PROPERTY OF PLAN LAND. DRAWINGS ARE NOT TO BE REPRODUCED IN PART OR IN WHOLE ON ANY MEDIUM WITHOUT THE WRITTEN PERMISSION OF PLAN LAND.

NOTE: ALL EXISTING & OVERALL DIMENSIONS ARE NOMINAL & SUBJECT TO VERIFICATION ON SITE. WHERE ANY DISCREPANCY OCCURS BETWEEN NEW WORK & EXISTING BETWEEN NEW WORK & EXISTING DIMENSIONS - EXISTING DIMENSIONS/WORK SHOULD TAKE PREPRENCE WHERE NECESSARY - OTHERWISE NOTE:

NOTE: SELECTED TERMITE PROTECTION TO BE USED ON SITE IN ACCORDANCE WITH LOCAL COUNCIL'S REQUIREMENTS, B.C.A. AND ALL RELEVANT AUSTRALIAN STANDARDS

NOTE: SMOKE DETECTORS TO COMPLY WITH REQUIREMENTS SMORE DETECTORS TO COMPLY WITH REQUIREMENTS OF SPECIFICATION EL7 (NSW) FIRE AND SMOKE ALARMS SHALL COMPLY WITH AS 3786 AND BE CONNECTED TO THE MAIN POWER SUPPLY.

INCLUSE STATES IN ACCORDANCE WITH CLAUSE 3.7.5.2 OF THE NCC.

NOTE: STAIRWAY TO HAVE A NON-SLIP FINISH OR NOSING STRIP IN ACCORDANCE WITH CLAUSE 3.9.1.4 AND TABLE 3.9.1.3 OF THE NCC.

NOTE: METHOD OF VENTILATING THE LAUNDRY AND WC AND CONTROLLING CONDENSATION IN ACCORDANCE WITH CLAUSES 3.8.5.2 & 3.8.7.3 OF THE NCC.

34 Lang Street,

Mudgee NSW 2850 Clier

COMPLIES

Drawing: Cover Sheet

| @A3 | 22113 I | DA 0.1 |
|---------------------|--------------------|----------------|
| Scale: | Drawing No.: S | |
| LT | LT | OCT/2022 |
| Drawn: | Approved: | Date: |
| | @planland.com.au | |
| Phone: 040 | 3 993 876 | |
| PO BOX 495 | Gymea NSW | |
| trading as P | lan land | 62 128 716 334 |
| newton teale | consulting pty ltd | ABN: |

PROPOSED

188.09 m²

24.44 %

EXISTING

COMPLIES

COMPLIES

COMPLIES

| BASI | Certificate |
|---------------------|--------------------------------|
| Building Sustainabi | ity Index www.basix.nsw.gov.au |
| Alterations an | nd Additions |

Certificate number: A488430_02

This ostilificate confirms that the proposed development will meet the No government's requirements for sustainability. If it is built in accordance w commitments act out below "Terms used in the correctingte, or in the corre-have the meaning given by the document entitlet! "BABX Alterations no Definitions" dated 60H102017 published by the Department. This docum

revision of certificate number A486430 lodged with the content on 03 Mar 2023 with application 8061486 If is the responsibility of the applicant (i) early with the content subority that the origins, or are responsible or contents with the response of Sun. 1 C129, 14 or 64 of the Environmental Parriety and Assessment Republics 200

Secretary Date of issue: Tuesday, 16, July 2023 To be valid, the certificate must be indged within 3 months of

NSW Planning, Industry & Environment

cale number & 485410_02

ulation requirements The applicant must construct the new or the table below, except that a) additiona is not required for parts of altered constr

norete slab on ground floor otemal wall: brick veneer

flat ceiling, pitched root

Planning, Industry II Smith

| | D Project name | 34 Lang Street, Mudgee_02 |
|------|---------------------------------|--|
| | Street address | 34 Lang Street Mudgee 2850 |
| | Local Government Area | Mid-Western Regional Council |
| | Plan type and number | Deposited Plan 790409 |
| 1.16 | Lot number | 4 |
| | Section number | |
| | Project type | |
| | Dwetting type | Separate dwelling house |
| S | Type of alteration and addition | My renovation work is valued at \$50,000 tr more, and includes a pool (and/or spa). |
| | 0 | |

| Pool and Spa | Show on DA Plans | Show on CC/CDC Plans & specs | Centruct Cristick |
|--|---------------------|---------------------------------------|----------------------|
| Rainwater tank. | | | |
| The applicant must install a rainwater tank of al least 2734 litres on the sile. This rainwater tank must meel, and be installed in accordance with, the requirements of all applicable regulatory authorities. | A. | s. | 1 |
| The applicant must configure the rainwater tank to collect rainwater runolf from at least 200 square metres of roof area. | | 1 | 1 |
| The applicant must connect the rainwater tank to a tap located within 10 metres of the edge of the pool | | 1 | 1 |
| Outdoor swimming pool | | | - |
| The swimming pool must be outdoors. | 1 | 4 | ×. |
| The swimming pool must not have a capacity greater than 51 kilolitres. | 12 | 4 | V. |
| The swimming pool must have a pool cover. | | 1 | 1 |
| The applicant must install a pool pump timer for the swimming pool. | | 1 | V. |
| The applicant must not incorporate any heating system for the swimming pool that is part of this development. | | 1 | 1 |

BASIN Centifically Isamber A488430 02

page 2-7

page 517

1

1

18 10 40

NER POR POR AN

Building Builthimpsity Index

withing Buildsmonity Index www.basis.nine.gov.su

Lighting

The applicant must ensure a minimum of 40% of new or allwred light fotures are fitted with fluorescent, compact fill light-emitting-diode (LED) lamps. ixtures

The applicant must ensure new or altered showerheads have a flow rate no greater than 9 litres per minute or a 3 st The applicant must ensure new or allered foilets have a flow rate no greater than 4 litres per average flush or a minin The applicant must ensure new or altered taps have a flow rate no greater than 9 litres per minute or minimum 3 star

| The date of mean | Certificate Prepared by [please congress before economisting to Council |
|------------------|---|
| | Name / Company Name: Newton Teale Consuming |
| | ABN (If applicable): 62 128 716 334 |
| | |
| | |

ofs) in accordance with the specifications listed in instruction is less than 2m2, b) insulation specified

ady exists

uting construction

celling: R1 95 (up), roof: foil backed blanket medium (solar absorptance 0 475 - 0.70) (55 mm)

R1.15 (or R1.70 incl

| cable): 62 128 71 | 334 | |
|-------------------|-----|--|
| | | |
| | | |
| | | |

page #17

Planning, Industry & Environment

1.95 0 0

NE

Planning, Industry II Document

BASIX Certificate mamber A485430 (3

mber Avestic ID

| | equinemeint | 9 | | | | | DA Plans | Show of CC/CC Ptains |
|--|--|---|---|---|--|---|----------|----------------------|
| Windows | and glazed | doors | _ | | | | | |
| | | | | | hading devices, in accordance with r each window and glazed door. | the specifications listed in the table below | d. | s. |
| The following | ng requirement | nts must also | be satisf | ied in relation | n to each window and plazed duor | | | V. |
| have a U-vi must be cal | alue and a So iculated in an | lar Heat Gail cordance with | n Coeffici h Nationa | ent (SHGC) i Fenestratio | no greater than that listed in the tab | er glazing, ar foned/eir gapiclear glazing must te below, Total system U-values and SHGCs s The description is provided for information | | v |
| For projects above the f | ions described | d in millimetri ndow or glaz | es, the lea | ind no more | f each eave, pergola, verandah, bai Ihan 2400 mm aboye the sill. | cony or awning must be no more than 500 mm | ~ | × |
| | | | | | | | | |
| Pergolas w | th polycarbo | nate root or s | amilar trac | shucent mate | enal must have a shading coefficien | a of less than 0.35. | | 1.12 |
| Pergolas w | in fixed batte | ns must have | e bations | parallel to th | and the state of the sector of the sector | n of less than 0.35. ch they are situated, unless the pergola also | | × × |
| Pergolas w shades a p | in fixed batte | ns must have window. The | e battens spacing t | paraliel to th stiween bath | e window of glazed door above whi ens must not be more than 50 mm. | | | |
| Pergolas w shades a p Windows | inh fixed batte erpendicular v | ns must have window. The ed doors g | e battens spacing t lazing r | parallel to th stiween bath equireme | e window of glazed door above whi ens must not be more than 50 mm. | | | |
| Pergolas w shades a p Windows | erpendicular v | ns must hav window. The d doors g out Are of plant to in | n bations spacing t lazing r Overch bicoli | parallel to th schween bath requireme milowing (Distance | e window or glazed door above wh ens must not be more than 50 mm nts | ch they are situated, unless the pergola also | | |
| Pergolas w shades a p Windows | nn fixed batte erpendicular v s and glaze | ns must hav window The d doors g our Ary of polyna in trans inter inter | e battens spacing b lazing r Qventio Height (m) | peralisi to th stiween balls requireme informo Distance (m) | e window er glazed door above win ens must not be more than 50 mm. Ats Shinting Joyace | ch they are situated, unless the peripole alto | | |
| Pergolas w shades a p Windows Windows / o no Wi Wi | nn fived batte erpendicular s and glaze 20 Content NE | ris must have window. The od doors g on Area of olon are frame (m2a 17.38 | o battens spacing t lazing r Overste bioght (m) 0 | peraliel to the equirement of owners the table | e window or glazed door above vm ens must not be more than 50 mm. IS Similing divects (etive/verandah/pergola/balcony) i=500 mm ceseverandah/pergola/balcony | ch they are situated, unless the peripole alto Finance and plate tryle improved alturninum, single tooed, (U-value: 6.39, SHGC, 0.59) improved alturninum, single toored, | | |
| Pergolas w shades a p Windows | nn fived batte erpendicular s and glaze 220 One fit NE NE | ns must have window. The ed doors g on Anne of room frame (m7) 17.38 5.72 | e battions spacing t lazing r Oversite blockt (m) 0 | perailel to the activeen battle requireme milowents (m) 0 0 | e window or glazed door above with this mat nut be more than 50 mm. Its Edited (device) (elve/verandah/pergota/bakcony >=900 mm (eve/verandah/pergota/bakcony >=900 mm | ch they are situated, unless the peripole alto Finance and plate tryle improved alternative 3.9 (SHGC 0.59) improved attransm. single toxed, (U-value: 6.39, SHGC 0.59) improved attransm. single toxed, (U-value: 6.39, SHGC 0.59) | | |

eave/verand

Planning, Indus

Dissoing Industry & Env

| ASIX Certificate nur | nber: A488430_ | 02 | | | | | | | page 6 |
|----------------------|----------------|---|--------------------------|---------------------------|---|--|---------------------|---------------------------------------|--------------------|
| Glazing requi | irements | | | | | | Show on DA Plans | Show on CC/CDC Plans & specs | Certifier Check |
| Window / door no. | Orientation | Area of glass inc. frame (m2) | Oversha Height (m) | dowing Distance (m) | Shading device | Frame and glass type | | | |
| W6 | SW | 0.96 | 0 | 0 | eave/verandah/pergola/balcony >=450 mm | improved aluminium, single toned, (U-value: 6.39, SHGC: 0.56) | | | |
| W7 | SW | 1.35 | 0 | 0 | eave/verandah/pergola/balcony >=450 mm | improved aluminium, single toned, (U-value: 6.39, SHGC: 0.56) | | | |
| W8 | SW | 1.8 | 0 | 0 | eave/verandah/pergola/balcony >=450 mm | improved aluminium, single toned, (U-value: 6.39, SHGC: 0.56) | | | |
| W9 | sw | 3.52 | 0 | 0 | eave/verandah/pergola/balcony >=450 mm | improved aluminium, single toned, (U-value: 6.39, SHGC: 0.56) | | | |

| Legend | |
|--|--|
| In these commitments, "applicant" means the person carrying out the development: | |
| Commitments identified with a "v ^{-r} in the "Show on DA plans" column must be shown on the plans accompanying the deve development application is to be lodged for the proposed development). | Reprinent application for the proposed development (if a |
| Commitments identified with a ",o" in the "Show on CC/CDC plans & specs" column must be shown in the plans and special certificate / complying development certificate for the proposed development. | ications accompanying the application for a construction |
| Commitments identified with a "up" in the "Certifier check" column must be certified by a certifying authority as liaving been development may be based. | fulfilled, before a final occupation certificate for the |

la/baloony improved aluminium, single loned, (U-value: 6,39, SHGC: 0.56)



| | | | page |
|---------------------------|---------------------|---------------------------------------|--------------------|
| | Show on DA Plans | Show on CC/CDC Plans & spore | Cent ist Ennick |
| wrescent, or | | ×. | 1 |
| star water rating | | 1 | 1 |
| nimum 3 star water raling | | 1 | 4 |
| tar water rating | | 1 | |

page 6 / 7

COPYRIGHT: ALL WORK IS TO COMPLY WITH THE BUILDING CODE OF AUSTRALIA, RELEVANT AUSTRALIAN STANDARDS & LOCAL AUTHORITY REQUIREMENTS. BUILDING CONTRACTOR & ALL RELEVANT SUB TRADES TO CHECK & VERIFY ALL DIMENSIONS & ASSOCIATED DRAWING PARTS PRIOT TO MANUPACTURE, CONSTRUCTION & INSTALLATION ON SITE. DO NOT SCALE OF DRAWINGS - WRITTEN DIMENSIONS TAKE PRECEDENCE. PLAN LAND ACCEPTS NO LIABILITY OR RESPONSIBILITY RESULTING FROM BUILDERS NEGLECT OR PREFERRED METHOD OF CONSTRUCTION FOR ANY BUILDING DEFECT. THESE DRAWINGS ARE THE PROPERTY OF PLAN LAND. DRAWINGS ARE NOT TO BE REPRODUCED IN PART OR IN WHOLE ON ANY MEDIUM WITHOUT THE WRITTEN PREMISSION OF PLAN LAND.

NOTE: ALL EXISTING & OVERALL DIMENSIONS ARE NOMINAL & SUBJECT TO VERIFICATION ON SITE. WHERE ANY DISCREPANCY OCCURS BETWEEN NEW WORK & EXISTING BETWEEN NEW WORK & EXISTING DIMENSIONS - EXISTING DIMENSIONS/WORK SHOULD TAKE PREFERENCE WHERE NECESSARY - OTHERWISE NOTIFY NOTE:

NOTE: SELECTED TERMITE PROTECTION TO BE USED ON SITE IN ACCORDANCE WITH LOCAL COUNCIL'S REQUIREMENTS, B.C.A. AND ALL RELEVANT AUSTRALIAN STANDARDS NOTE:

AUSTRALIAN STANDARDS <u>NOTE:</u> SMOKE DETECTORS TO COMPLY WITH REQUIREMENTS OF SPECIFICATION EL7 (NSW) FIRE AND SMOKE ALARMS SHALL COMPLY WITH AS 3786 AND BE CONNECTED TO THE MAIN POWER SUPPLY. <u>NOTE:</u> LOCATION OF SMOKE ALARMS IN ACCORDANCE WITH CLAUSE 3.7.5.2 OF THE NCC. NOTE:

NOTE: STAIRWAY TO HAVE A NON-SLIP FINISH OR NOSING STRIP IN ACCORDANCE WITH CLAUSE 3.9.1.4 AND TABLE 3.9.1.3 OF THE NCC.

NOTE: METHOD OF VENTILATING THE LAUNDRY AND WC AND CONTROLLING CONDENSATION IN ACCORDANCE WITH CLAUSES 3.8.5.2 & 3.8.7.3 OF THE NCC.

Projec

34 Lang Street, Mudgee NSW 2850 Client

Drawing: **Basix Certificate**

| newton teale o | onsulting pty ltd | ABN: |
|---------------------|-------------------|----------------|
| trading as p | an land | 62 128 716 334 |
| PO BOX 495 0 | Gymea NSW | |
| Phone: 0403 | 3 993 876 | |
| Email: info | @planland.com.au | |
| Drawn: | Approved: | Date: |
| LT | LÏ | OCT/2022 |
| Scale: | Drawing No.: Sh | eet No.: Rev.: |
| @A3 | 22113 D | |

1. FALLS, SLIPS, TRIPS

a) WORKING AT HEIGHTS

DURING CONSTRUCTION

WHEREVER POSSIBLE, COMPONENTS FOR THIS BUILDING SHOULD BE PREFABRICATED OFF-SITE OR AT GROUND LEVEL TO MINIMISE THE RISK OF WORKERS FALLING MORE THAN TWO METRES. HOWEVER, CONSTRUCTION OF THIS

BUILDING WILL REQUIRE WORKERS TO BE WORKING AT HEIGHTS WHERE A FALL IN

EXCESS OF TWO METRES IS POSSIBLE AND INJURY IS LIKELY TO RESULT FROM SUCH A FALL. THE BUILDER SHOULD PROVIDE A SUITABLE BARRIER WHEREVER A

PERSON IS REQUIRED TO WORK IN A SITUATION WHERE FALLING MORE THAN TWO METRES IS A POSSIBILITY.

DURING OPERATION OR MAINTENANCE

FOR HOUSES OR OTHER LOW-RISE BUILDINGS WHERE SCAFFOLDING IS APPROPRIATE.

CLEANING AND MAINTENANCE OF WINDOWS, WALLS, ROOF OR OTHER COMPONENTS OF THIS BUILDING WILL REQUIRE PERSONS TO BE SITUATED WHERE A FALL FROM A HEIGHT IN EXCESS OF TWO METRES IS POSSIBLE. WHERE

THIS TYPE OF ACTIVITY IS REQUIRED. SCAFFOLDING. LADDERS OR TRESTLES SHOULD

BE USED IN ACCORDANCE WITH RELEVANT CODES OF PRACTICE, REGULATIONS OR LEGISLATION

FOR BUILDINGS WHERE SCAFFOLD, LADDERS, TRESTLES ARE NOT APPROPRIATE.

CLEANING AND MAINTENANCE OF WINDOWS, WALLS, ROOF OR OTHER COMPONENTS OF THIS BUILDING WILL REQUIRE PERSONS TO BE SITUATED WHERE A FALL FROM A HEIGHT IN EXCESS OF TWO METRES IS POSSIBLE. WHERE

THIS TYPE OF ACTIVITY IS REQUIRED, SCAFFOLDING, FALL BARRIERS OR

PROTECTIVE EQUIPMENT (PPE) SHOULD BE USED IN ACCORDANCE WITH RELEVANT CODES OF PRACTICE, REGULATIONS OR LEGISLATION.

ANCHORAGE POINTS

ANCHORAGE POINTS FOR PORTABLE SCAFFOLD OR FALL ARREST DEVICES

BEEN INCLUDED IN THE DESIGN FOR USE BY MAINTENANCE WORKERS. ANY PERSONS ENGAGED TO WORK ON THE BUILDING AFTER COMPLETION OF CONSTRUCTION WORK SHOULD BE INFORMED ABOUT THE ANCHORAGE POINTS

b) SLIPPERY OR UNEVEN SURFACES

FLOOR FINISHES SPECIFIED

IF FINISHES HAVE BEEN SPECIFIED BY DESIGNER. THESE HAVE BEEN SELECTED TO MINIMISE THE RISK OF FLOORS AND PAVED AREAS BECOMING SLIPPERY WHEN WET OR WHEN WALKED ON WITH WET SHOES/FEET. ANY CHANGES TO THE SPECIFIED FINISH SHOULD BE MADE IN CONSULTATION WITH THE DESIGNER OR, IF THIS IS NOT PRACTICAL, SURFACES WITH AN FOUIVALENT OR

BETTER SLIP RESISTANCE SHOULD BE CHOSEN.

FLOOR FINISHES BY OWNER

IF DESIGNER HAS NOT NOT BEEN INVOLVED IN THE SELECTION OF SURFACE FINISHES, THE OWNER IS RESPONSIBLE FOR THE SELECTION OF SURFACE FINISHES

IN THE PEDESTRIAN TRAFFICABLE AREAS OF THIS BUILDING. SURFACES SHOULD

BE SELECTED IN ACCORDANCE WITH AS HB 197:1999 AND AS/NZ 4586:2004

STEPS, LOOSE OBJECTS AND UNEVEN SURFACES

DUE TO DESIGN RESTRICTIONS FOR THIS BUILDING, STEPS AND/OR RAMPS ARF

INCLUDED IN THE BUILDING WHICH MAY BE A HAZARD TO WORKERS CARRYING OBJECTS OR OTHERWISE OCCUPIED. STEPS SHOULD BE CLEARLY MARKED WITH

BOTH VISUAL AND TACTILE WARNING DURING CONSTRUCTION, MAINTENANCE, DEMOLITION AND AT ALL TIMES WHEN THE BUILDING OPERATES AS A WORKPI ACE

BUILDING OWNERS AND OCCUPIERS SHOULD MONITOR THE PEDESTRIAN ACCESS WAYS AND IN PARTICULAR ACCESS TO AREAS WHERE MAINTENANCE IS ROUTINELY CARRIED OUT TO ENSURE THAT SURFACES HAVE NOT MOVED

CRACKED SO THAT THEY BECOME UNEVEN AND PRESENT A TRIP HAZARD SPILLS, LOOSE MATERIAL, STRAY OBJECTS OR ANY OTHER MATTER THAT MAY CAUSE A SLIP OR TRIP HAZARD SHOULD BE CLEANED OR REMOVED FROM ACCESS WAYS

CONTRACTORS SHOULD BE REQUIRED TO MAINTAIN A TIDY WORK SITE DURING

CONSTRUCTION, MAINTENANCE OR DEMOLITION TO REDUCE THE RISK OF TRIPS

AND FALLS IN THE WORKPLACE. MATERIALS FOR CONSTRUCTION OR MAINTENANCE SHOULD BE STORED IN DESIGNATED AREAS AWAY FROM ACCESS WAYS AND WORK AREAS.

2. FALLING OBJECTS

LOOSE MATERIALS OR SMALL OBJECTS

CONSTRUCTION, MAINTENANCE OR DEMOLITION WORK ON OR AROUND THIS BUILDING IS LIKELY TO INVOLVE PERSONS WORKING ABOVE GROUND LEVEL

ABOVE FLOOR LEVELS. WHERE THIS OCCURS ONE OR MORE OF THE FOLLOWING

MEASURES SHOULD BE TAKEN TO AVOID OBJECTS FALLING FROM THE AREA WHERE THE WORK IS BEING CARRIED OUT ONTO PERSONS BELOW. 1. PREVENT OR RESTRICT ACCESS TO AREAS BELOW WHERE THE WORK IS BEING CARRIED OUT

2. PROVIDE TOEBOARDS TO SCAFFOLDING OR WORK PLATFORMS. 3. PROVIDE PROTECTIVE STRUCTURE BELOW THE WORK AREA 4. ENSURE THAT ALL PERSONS BELOW THE WORK AREA HAVE PERSONAL PROTECTIVE EQUIPMENT (PPE).

BUILDING COMPONENTS

DURING CONSTRUCTION, RENOVATION OR DEMOLITION OF THIS BUILDING,

PARTS OF THE STRUCTURE INCLUDING FABRICATED STEELWORK, HEAVY PANELS AND

MANY OTHER COMPONENTS WILL REMAIN STANDING PRIOR TO OR AFTER

SUPPORTING

PARTS ARE IN PLACE. CONTRACTORS SHOULD ENSURE THAT TEMPORARY BRACING

OR OTHER REQUIRED SUPPORT IS IN PLACE AT ALL TIMES WHEN COLLAPSE WHICH

MAY INJURE PERSONS IN THE AREA IS A POSSIBILITY MECHANICAL LIFTING OF MATERIALS AND COMPONENTS DURING CONSTRUCTION

MAINTENANCE OR DEMOLITION PRESENTS A RISK OF FALLING OBJECTS. CONTRACTORS SHOULD ENSURE THAT APPROPRIATE LIFTING DEVICES ARE

USED, THAT LOADS ARE PROPERLY SECURED AND THAT ACCESS TO AREAS BELOW

LOAD IS PREVENTED OR RESTRICTED.

3. TRAFFIC MANAGEMENT

FOR BUILDING ON A MAJOR ROAD, NARROW ROAD OR STEEPLY SLOPING

ROAD: PARKING OF VEHICLES OR LOADING/UNLOADING OF VEHICLES ON THIS

ROADWAY MAY CAUSE A TRAFFIC HAZARD. DURING CONSTRUCTION, MAINTENANCE OR DEMOLITION OF THIS BUILDING DESIGNATED PARKING FOR WORKERS AND

LOADING AREAS SHOULD BE PROVIDED. TRAINED TRAFFIC MANAGEMENT PERSONNEL SHOULD BE RESPONSIBLE FOR THE SUPERVISION OF THESE AREAS.

FOR BUILDING WHERE ON-SITE LOADING/UNLOADING IS RESTRICTED CONSTRUCTION OF THIS BUILDING WILL REQUIRE LOADING AND UNLOADING

MATERIALS ON THE ROADWAY. DELIVERIES SHOULD BE WELL PLANNED TO AVOID

CONGESTION OF LOADING AREAS AND TRAINED TRAFFIC MANAGEMENT PERSONNEL SHOULD BE USED TO SUPERVISE LOADING/UNLOADING AREAS. FOR ALL BUILDINGS:

BUSY CONSTRUCTION AND DEMOLITION SITES PRESENT A RISK OF COLLISION WHERE

DELIVERIES AND OTHER TRAFFIC ARE MOVING WITHIN THE SITE. A TRAFFIC MANAGEMENT PLAN SUPERVISED BY TRAINED TRAFFIC MANAGEMENT PERSONNEL SHOULD BE ADOPTED FOR THE WORK SITE.

4. SERVICES

GENERAL

THESE NOTES MUST BE READ AND UNDERSTOOD BY ALL INVOLVED IN THE PROJECT.

RUPTURE OF SERVICES DURING EXCAVATION OR OTHER ACTIVITY CREATES A VARIETY OF RISKS INCLUDING RELEASE OF HAZARDOUS MATERIAL. EXISTING SERVICES ARE LOCATED ON OR AROUND THIS SITE. WHERE KNOWN, THESE ARE

DENTIFIED ON THE PLANS BUT THE EXACT LOCATION AND EXTENT OF SERVICES MAY VARY FROM THAT INDICATED. SERVICES SHOULD BE LOCATED USING AN APPROPRIATE SERVICE (SUCH AS DIAL BEFORE YOU DIG PPROPRIATE EXCAVATION PRACTICE SHOULD BE USED AND, WHERE NECESSARY, SPECIALIST CONTRACTORS SHOULD BE USED.

LOCATIONS WITH UNDERGROUND POWER: UNDERGROUND POWER LINES MAY BE LOCATED IN OR AROUND THIS SITE. ALL UNDERGROUND POWER LINES MUST BE DISCONNECTED OR CAREFULLY LOCATED AND ADEQUATE WARNING SIGNS USED PRIOR TO ANY

CONSTRUCTION, MAINTENANCE OR DEMOLITION COMMENCING

LOCATIONS WITH OVERHEAD POWER LINES: OVERHEAD POWER LINES MAY BE NEAR OR ON THIS SITE. THESE POSE A RISK OF ELECTROCUTION IF STRUCK OR APPROACHED BY LIFTING DEVICES OR

PLANT AND PERSONS WORKING ABOVE GROUND LEVEL. WHERE THERE IS A DANGER OF THIS OCCURRING, POWER LINES SHOULD BE, WHERE PRACTICAL DISCONNECTED OR RELOCATED. WHERE THIS IS NOT PRACTICAL ADEQUATE WARNING IN THE FORM OF BRIGHT COLOURED TAPE OR SIGNAGE SHOULD BE USED OR A PROTECTIVE BARRIER PROVIDED.

THIS INCLUDES (BUT IS NOT EXCLUDED TO): OWNER, BUILDER, SUB-CONTRACTORS, CONSULTANTS, RENOVATORS, OPERATORS, MAINTENORS, DEMOLISHERS.

5. MANUAL TASKS

COMPONENTS WITHIN THIS DESIGN WITH A MASS IN EXCESS OF 25KG SHOULD BE LIFTED BY TWO OR MORE WORKERS OR BY MECHANICAL LIFTING DEVICE, WHERE THIS IS NOT PRACTICAL, SUPPLIERS OR FABRICATORS SHOULD

BE REQUIRED TO LIMIT THE COMPONENT MASS

ALL MATERIAL PACKAGING BUILDING AND MAINTENANCE COMPONENTS SHOULD CLEARLY SHOW THE TOTAL MASS OF PACKAGES AND WHERE PRACTICAL ALL ITEMS SHOULD BE STORED ON SITE IN A WAY WHICH MINIMISES BENDING BEFORE LIFTING. ADVICE SHOULD BE PROVIDED ON SAFE LIFTING METHODS IN ALL AREAS WHERE LIFTING MAY OCCUR. CONSTRUCTION MAINTENANCE AND DEMOLITION OF THIS BUILDING WILL REQUIRE THE USE OF PORTABLE TOOLS AND EQUIPMENT. THESE SHOULD BE FULLY MAINTAINED IN ACCORDANCE WITH MANUFACTURER'S SPECIFICATIONS AND NOT USED WHERE FAULTY OR (IN THE CASE OF ELECTRICAL EQUIPMENT) NOT CARRYING A CURRENT ELECTRICAL SAFETY TAG

ALL SAFETY GUARDS OR DEVICES SHOULD BE REGULARLY CHECKED AND PERSONAL PROTECTIVE EQUIPMENT SHOULD BE USED IN ACCORDANCE WITH MANUFACTURER'S SPECIFICATION.

6. HAZARDOUS SUBSTANCES

ASBESTOS

FOR ALTERATIONS TO A BUILDING CONSTRUCTED PRIOR TO 1990: IF THIS EXISTING BUILDING WAS CONSTRUCTED PRIOR TO 1990 - IT THEREFORE MAY CONTAIN ASBESTOS

1986 - IT THEREFORE IS LIKELY TO CONTAIN ASBESTOS

EITHER IN CLADDING MATERIAL OR IN FIRE RETARDANT INSULATION MATERIAL

ETHER CASE, THE BUILDER SHOULD CHECK AND, IF NECESSARY, TAKE APPROPRIATE ACTION BEFORE DEMOLISHING, CUTTING, SANDING, DRILLING

OTHERWISE DISTURBING THE EXISTING STRUCTURE

POWDERED MATERIALS

MANY MATERIALS USED IN THE CONSTRUCTION OF THIS BUILDING CAN CAUSE HARM IF INHALED IN POWDERED FORM. PERSONS WORKING ON OR IN THE BUILDING DURING CONSTRUCTION, OPERATIONAL MAINTENANCE OR

SHOULD ENSURE GOOD VENTILATION AND WEAR PERSONAL PROTECTIVE EQUIPMENT INCLUDING PROTECTION AGAINST INHALATION WHILE USING POWDERED MATERIAL OR WHEN SANDING, DRILLING, CUTTING OR OTHERWISE

DISTURBING OR CREATING POWDERED MATERIAL

TREATED TIMBER

THE DESIGN OF THIS BUILDING MAY INCLUDE PROVISION FOR THE INCLUSION

TREATED TIMBER WITHIN THE STRUCTURE. DUST OR FUMES FROM THIS MATERIA

CAN BE HARMFUL. PERSONS WORKING ON OR IN THE BUILDING DURING CONSTRUCTION, OPERATIONAL MAINTENANCE OR DEMOLITION SHOULD

GOOD VENTILATION AND WEAR PERSONAL PROTECTIVE EQUIPMENT

INCLUDING PROTECTION AGAINST INHALATION OF HARMFUL MATERIAL WHEN SANDING DRILLING, CUTTING OR USING TREATED TIMBER IN ANY WAY THAT MAY CAUSE HARMFUL MATERIAL TO BE RELEASED. DO NOT BURN TREATED TIMBER.

VOLATILE ORGANIC COMPOUNDS

MANY TYPES OF GLUE, SOLVENTS, SPRAY PACKS, PAINTS, VARNISHES AND SOME CLEANING MATERIALS AND DISINFECTANTS HAVE DANGEROUS EMISSIONS AREAS WHERE THESE ARE LISED SHOULD BE KEPT WELL VENTILATED WHILE THE MATERIAL IS BEING USED AND FOR A PERIOD AFTER INSTALLATION, PERSONAL PROTECTIVE EQUIPMENT MAY ALSO BE REQUIRED THE MANUFACTURER'S RECOMMENDATIONS FOR USE MUST BE CAREFULLY CONSIDERED AT ALL TIMES.

SYNTHETIC MINERAL FIBRE

WHEN

FINISH

DURING

TIMES.

PERSONAL

TIMBER FLOORS

FIBREGLASS, ROCKWOOL, CERAMIC AND OTHER MATERIAL USED FOR

THERMAL OR SOUND INSULATION MAY CONTAIN SYNTHETIC MINERAL FIBRE WHICH MAY BE HARMFUL IF INHALED OR IF IT COMES IN CONTACT WITH THE SKIN, EYES OR

OTHER SENSITIVE PARTS OR THE BODY. PERSONAL PROTECTIVE EQUIPMENT

INCLUDING PROTECTION AGAINST INHALATION OF HARMFUL MATERIAL SHOULD BE USED INSTALLING, REMOVING OR WORKING NEAR BULK INSULATION MATERIAL

THIS BUILDING MAY CONTAIN TIMBER FLOORS WHICH HAVE AN APPLIED

SANDING AND APPLICATION AND FOR A PERIOD AFTER INSTALLATION.

AREAS WHERE FINISHES ARE APPLIED SHOULD BE KEPT WELL VENTILATED

PROTECTIVE EQUIPMENT MAY ALSO BE REQUIRED. THE MANUFACTURER'S RECOMMENDATIONS FOR USE MUST BE CAREFULLY CONSIDERED AT ALL

CONSTRUCTION OF THIS BUILDING AND SOME MAINTENANCE ON THE BUILDING WILL REQUIRE EXCAVATION AND INSTALLATION OF ITEMS WITHIN EXCAVATIONS. WHERE PRACTICAL, INSTALLATION SHOULD BE CARRIED OUT USING METHODS WHICH DO NOT REQUIRE WORKERS TO ENTER THE EXCAVATION. WHERE THIS IS NOT PRACTICAL, ADEQUATE SUPPORT FOR THE EXCAVATED AREA SHOULD BE PROVIDED TO PREVENT COLLAPSE. WARNING SIGNS AND BARRIERS TO PREVENT ACCIDENTAL OR UNAUTHORISED ACCESS

7. CONFINED SPACES

ENCLOSED SPACES

ENCLOSED

ACCES MAY BE REQUIRED

SMALL SPACES

8. PUBLIC ACCESS

SUPERVISED

CODE

STEEL

9. OPERATIONAL USE OF BUILDING

RESIDENTIAL BUILDINGS

10.OTHER HIGH RISK ACTIVITY

3012 AND ALL LICENSING REQUIREMENTS

ACCESS MAY BE REQUIRED:

SHOULD BE PROVIDED

ALL EXCAVATIONS SHOULD BE PROVIDED

FXCAVATION

FOR BUILDINGS WITH ENCLOSED SPACES WHERE MAINTENANCE OR OTHER

ENCLOSED SPACES WITHIN THIS BUILDING MAY PRESENT A RISK TO PERSONS ENTERING FOR CONSTRUCTION, MAINTENANCE OR ANY OTHER PURPOSE. THE DESIGN DOCUMENTATION CALLS FOR WARNING SIGNS AND BARRIERS TO UNAUTHORISED ACCESS. THESE SHOULD BE MAINTAINED THROUGHOUT THE LIFE OF THE BUILDING. WHERE WORKERS ARE REQUIRED TO ENTER

SPACES, AIR TESTING EQUIPMENT AND PERSONAL PROTECTIVE EQUIPMENT

FOR BUILDINGS WITH SMALL SPACES WHERE MAINTENANCE OR OTHER

SOME SMALL SPACES WITHIN THIS BUILDING WILL REQUIRE ACCESS BY CONSTRUCTION OR MAINTENANCE WORKERS. THE DESIGN DOCUMENTATION CALLS FOR WARNING SIGNS AND BARRIERS TO UNAUTHORISED ACCESS

SHOULD BE MAINTAINED THROUGHOUT THE LIFE OF THE BUILDING. WHERE WORKERS ARE REQUIRED TO ENTER SMALL SPACES THEY SHOULD BE SCHEDULED SO THAT ACCESS IS FOR SHORT PERIODS. MANUAL LIFTING AND OTHER MANUAL ACTIVITY SHOULD BE RESTRICTED IN SMALL SPACES

PUBLIC ACCESS TO CONSTRUCTION AND DEMOLITION SITES AND TO AREAS UNDER MAINTENANCE CAUSES RISK TO WORKERS AND PUBLIC. WARNING SIGNS AND SECURE BARRIERS TO UNAUTHORISED ACCESS SHOULD BE PROVIDED. WHERE ELECTRICAL INSTALLATIONS, EXCAVATIONS, PLANT OR

MATERIALS ARE PRESENT THEY SHOULD BE SECURED WHEN NOT FULLY

THIS BUILDING HAS BEEN DESIGNED AS A RESIDENTIAL BUILDING. IF IT, AT A LATER DATE, IT IS USED OR INTENDED TO BE USED AS A WORKPLACE, THE PROVISIONS OF THE WORK HEALTH AND SAFETY ACT 2011 OR SUBSEQUENT REPLACEMENT ACT SHOULD BE APPLIED TO THE NEW USE

ALL ELECTRICAL WORK SHOULD BE CARRIED OUT IN ACCORDANCE WITH

OF PRACTICE: MANAGING ELECTRICAL RISKS AT THE WORKPLACE, AS/NZ

ALL WORK USING PLANT SHOULD BE CARRIED OUT IN ACCORDANCE WITH CODE OF PRACTICE: MANAGING RISKS OF PLANT AT THE WORKPLACE. ALL WORK SHOULD BE CARRIED OUT IN ACCORDANCE WITH CODE OF PRACTICE: MANAGING NOISE AND PREVENTING HEARING LOSS AT WORK DUE TO THE HISTORY OF SERIOUS INCIDENTS IT IS RECOMMENDED THAT PARTICULAR CARE BE EXERCISED WHEN UNDERTAKING WORK INVOLVING

CONSTRUCTION AND CONCRETE PLACEMENT. ALL THE ABOVE APPLIES

COPYRIGHT

ALL WORK IS TO COMPLY WITH THE BUILDING CODE OF AUSTRALIA, RELEVANT AUSTRALIAN STANDARDS & LOCAL AUTHORITY REQUIREMENTS.

LOCAL AUTHORITY REQUIREMENTS. BUILDING CONTRACTOR & ALL RELEVANT SUB TRADES TO CHECK & VERIFY ALL DIMENSIONS & ASSOCIATED DRAWING PARTS PRIOR TO MANUFACTURE. CONSTRUCTION & INSTALLATION ON SITE. DO NOT SCALE OFF DRAWINGS - WRITTEN DIMENSIONS TAKE PRECEDENCE. PLAN LAND ACCEPTS NO LIABILITY OR RESPONSIBILITY RESULTING FROM BUILDERS NEGLECT OR PREFERRED METHOD OF CONSTRUCTION FOR AWN BUILDING

METHOD OF CONSTRUCTION FOR ANY BUILDING

DEFECT. THESE DRAWINGS ARE THE PROPERTY OF PLAN LAND. DRAWINGS ARE NOT TO BE REPRODUCED IN PART OR IN WHOLE ON ANY MEDIUM WITHOUT THE WRITTEN PERMISSION OF PLAN LAND.

NOTE: ALL EXISTING & OVERALL DIMENSIONS ARE NOMINAL & SUBJECT TO VERIFICATION ON SITE. WHERE ANY DISCREPANCY OCCURS BETWEEN NEW WORK & EXISTING BETWEEN NEW WORK & EXISTING DIMENSIONS - EXISTING DIMENSIONS/WORK SHOULD

DIMENSIONS - EXISTING DIMENSIONS/WORK SHOULD TAKE PREFERENCE WHERE NECESSARY - OTHERWISE NOTIFY PLAN LAND

NOTE: SELECTED TERMITE PROTECTION TO BE USED ON SITE IN ACCORDANCE WITH LOCAL COUNCIL'S REQUIREMENTS, B.C.A. AND ALL RELEVANT

AUSTRALIAN STANDARDS

NOTE: SMOKE DETECTORS TO COMPLY WITH REQUIREMENTS OF SPECIFICATION E1.7 (NSW) FIRE AND SMOKE ALARMS SHALL COMPLY WITH AS 3786 AND BE CONNECTED TO E MAIN POWER SUPPLY.

NOTE: LOCATION OF SMOKE ALARMS IN ACCORDANCE WITH CLAUSE 3.7.5.2 OF THE NCC.

NOTE: STAIRWAY TO HAVE A NON-SLIP FINISH OR NOSING STRIP IN ACCORDANCE WITH CLAUSE 3.9.1.4 AND TABLE 3.9.1.3 OF THE NCC.

NOTE: METHOD OF VENTILATING THE LAUNDRY AND WC AND CONTROLLING CONDENSATION IN ACCORDANCE WITH CLAUSES 3.8.5.2 & 3.8.7.3 OF THE NCC.

34 Lang Street, Mudgee NSW 2850

Spec. & Notes

| newton teale o | consulting pty ltd | ABN: |
|---------------------|--------------------|-----------------|
| trading as p | an land | 62 128 716 334 |
| PO BOX 495 | Gymea NSW | |
| Phone: 0403 | 3 993 876 | |
| Email: info | @planland.com.au | |
| Drawn: | Approved: | Date: |
| LT | LT | OCT/2022 |
| Scale: | Drawing No.: S | heet No.: Rev.: |
| @A3 | 22113 I | |

STANDARD SPECIFICATION & GENERAL CONSTRUCTION NOTES

ALL CONTRACTORS & SUPPLIERS ARE TO READ ALL NOTES CONTAINED WITHIN THIS DOCUMENTATION. THE FOLLOWING NOTES BELOW ARE A BRIEF EXTRACT FROM THE NCC 2022 FOR CONVENIENCE & CONTRACTUAL PURPOSES. EVERY EFFORT IS MADE TO PROVIDE ACCURATE, COMPLETE AND UP TO DATE INFORMATION. HOWEVER ALL CONTRACTORS & SUPPLIERS ARE TO ENSURE THEY WORK WITHIN AND COMPLY IN STRICT. ACCORDANCE WITH THE FULL CURRENT NCC, ALL RELEVANT NATIONAL, STATE & LOCAL LAWS, REGULATIONS, LEGISLATION & STANDARD. THESE PLANS ARE TO BE READ IN ACCORDANCE WITH STRUCTURAL ENGINEER'S DRAWINGS & COMPUTATIONS, BUILDING PERMIT CONDITIONS AS WELL AS ANY MANUFACTURES SPECIFICATIONS. ALL CONTRACTORS & SUPPLIERS TO VERIFY ALL DIMENSIONS PRIOR TO COMMENCEMENT OF WORKS & ARE TO USE FIGURED DIMENSIONS ONLY.

THESE ARE NOT TO BE SCALED OFF. IF IN DOUBT, ASK.

TO BE READ IN ACCORDANCE WITH NCC. PART 3 1 1 & PART 3 2

CONTRACTORS ASSOCIATED WITH EARTHWORKS SHALL CHECK AND CONFIRM STRUCTURAL ENGINEERS DRAWINGS/ COMPUTATIONS AND/ OR GEOLOGICAL SURVEY FOR ALL SOIL CLASSIFICATION, SITE CONDITIONS 7 MINIMUM FOOTING DEPTH PRIOR TO COMMENCEMENT OF ANY WORKS. WHERE REQUIRED, APPROPRIATE EMBANKMENT PROTECTION TO BE PROVIDED & MAINTAINED BY ASSOCIATED CONTRACTORS FOR DURATION OF

DRAINAGE

TO BE READ IN ACCORDANCE WITH NCC, PART 3.3, AS/NZS3500.3-2003-STORMWATER DRAINAGE, & AS/NZS3500.5-2000- DOMESTIC INSTALLATIONS, SECTION 5-STORMWATER DRAINAGE.

NEW DRAINAGE SYSTEMS MUST NOT ENCROACH AREAS DEFINED AS LOAD ABSORPTION FROM FOOTINGS. (NCC FIGURE 3.1.2.1) SURFACE WATER DRAINAGE TO BE DIVERTED FROM CLASS 1 & 10 BUILDINGS AT ALL TIMES. (NCC FIGURE 3.1.2.2 & 3.1.2.3) STORM WATER DRAINAGE SYSTEMS, POSITIONS & POINT OF DISCHARGE MUST BE TO THE SATISFACTION OF THE APPROPRIATE AUTHORITY.

FOOTINGS & SLABS

TO BE READ IN ACCORDANCE WITH NCC. PART 4.2. AS2870-1996-RESIDENTIAL SLABS & FOOTINGS & AS2159-1995-PILLING- DESIGN & INSTALLATION. EXCAVATION FOR FOOTINGS INCLUDING THICKENING FOR SLAB & PADS MUST BE CLEAN CUT EITHER VERTICAL SIDES & FLAT BASE WHERE POSSIBLE

FILLING UNDER CONCRETE SLABS MUST BE EITHER CONTROLLED FILL OR ROLLED FILL. MINIMUM 20MM CLEAN QUARRY SAND TO BE PLACED ON TOP OF FILL.

VAPOR / MOISTURE BARRIER MUST BE INSTALLED UNDER SLAB-ON-GROUND CONSTRUCTION. MINIMUM 0.2MM THICKNESS POLYETHYLENE FILM, MEDIUM IMPACT RESISTANCE. JOINTS TO LAP MINIMUM 200MM WITH ALL SERVICES AND PENETRATIONS TO BE SEALED/ TAPED ADEQUATELY. (NCC FIGURE 4.2.2.3)

CONCRETE MUST BE MANUFACTURED TO COMPLY WITH AS3600-2001-CONCRETE STRUCTURES & HAVE A STRENGTH AT 28 DAYS NOT LESS THEN 20MPa (N20 GRADE), HAVE 20MM NOMINAL AGGREGATE SIZE & HAVE NOMINAL 80MM SLUMP. REINFORCEMENT STEEL MUST HAVE LESS THAN 40MM COVER TO EXTERNÁL FACES & 20MM TO AN INTERNAL PROTECTED SURFACE & BAR CHAIRS SPACED AT NOT MORE THAN 800MM CENTRES. MASONR

TO BE READ IN ACCORDANCE WITH NCC. PART 5.6 & AS3700-2001-MASONRY STRUCTURES, MORTAR, JOINTS MUST NOTE EXCEED NOMINAL 10MM & RACKED JOINTS NO DEEPER THAN 10MM. ARTICULATION JOINTS MUST HAVE A WIDTH NOT LESS THAN 10MM & NOT EXCEEDING 20MM & BE CLEAN OF MORTAR & ARE TO BE STRAIGHT.

WALLS WITHOUT OPENINGS AT MAXIMUM 6000MM CENTERS & NOT CLOSER THAN HEIGHT OF THE WALL AWAY FROM CORNERS. WHERE OPENINGS MORE THAN 900x900MM OCCUR, AT MAXIMUM 5000MM CENTERS & POSITIONED AT ONE EDGE OF OPENING. ALL JOINTS ARE TO BE SEALED WITH A COMPRESSIBLE, FLEXIBLE MATERIAL, (REFER TO NCC FIGURE 5.6.1.7)

WALL TIES IN MASONRY VENEER CONSTRUCTION WITH 450C/C STUD WALLS TO BE SPACED 600x450MM, 600C/C STUD WALLS TO BE SPACED 600x600MM, CAVITY MASONRY 600x600MM. NUMBER OR TIES TO BE DOUBLED WITHIN 300MM OF OPENINGS & CONTROL JOINTS. TIES TO BE HOT DIPPED GALVANISED WITH A GRADE OF Z600. FACE FIXING TIES TO BE USED IN MASONRY VENEER TO AVOID HOLES IN FOIL. (NCC FIGURE 5.6.3.1)

HOOP IRON STRAPS TO BE 32x0 8M GAI VANISED AT MAXIMUM 1200MM CENTRES & BE FIXED MINIMUM 900MM TO BRICK WORK (REFER TO NCC FIGURE 5.6.3.3(b)) LINTELS SUPPORTING MASONRY WALLS ABOVE OPENINGS LESS THAN 1000MM TO HAVE MINIMUM BEARING LENGTH OF 100MM AT EACH END.

OPENING GREATER THAN 1000MM TO HAVE MINIMUM BEARING OF 150MM AT EACH END WITH MINIMUM 3 COURSE MASONRY ABOVE ALL OPENINGS (NCC FIGURE 5.6.3.4 TO 5.6.3.5)

WEEPHOLES ARE TO BE AT MAX. 1200MM CENTRES & IMMEDIATLY ABOVE ANY DPC/ FLASHING. CONTRACTOR TO ENSURE THAT WEEPHOLES ABOVE

OPENINGS ARE CENTRED & ALL WEEPHOLES ARE TO BE CLEAN & STRAIGHT. DPC/ FLASHING FOR SUB FLOOR & ABOVE OPENINGS TO BE EMBOSSED BLACK POLYETHYLENE FILM OF HIGH IMPACT RESISTANCE, LOW SLIP WITH NOMINAL THICKNESS OF 0.5MM & MINIMUM 300MM IN WIDTH. DPC/ FLASHING MUST BE TURNED UP MINIMUM 150MM FIXED TO FRAME & JOINTS MUST LAP NOT LESS THAN 150MM. (REFER TO NCC FIGURES 5.6.4.1 TO 5.6.4.5 INCLUSIVE & NCC FIGURES 5.6.4.6 & 5.6.4.7 FOR ROOF/WALL JUNCTIONS)

SUB-FLOOR VENTILATION

TO BE IN ACCORDANCE WITH NCC. PART 6.2

SUB-FLOOR VENTILATION TO BE PROVIDED AT A RATE OF 6000mm2/m OF WALL. SUB-FLOOR CLEARANCE BETWEEN GROUND LEVEL & UNDERSIDE OF BEARERS TO BE A MINIMUM OF 150MM WITHIN 2000MM FROM PERIMETER & AN AVERAGE OF 400MM FOR REMAINDER. SUBFLOOR VENTS TO BE PROVIDED AT 1200MM CENTRES & MAX 600MM FROM CORNERS, (REFER TO NCC FIGURES 6.2.1 & 6.2.2)

STEEL FRAMING & STRUCTURAL MEMBERS

TO BE IN ACCORDANCE WITH NCC, PART 6.3, AS4100-1998-STEEL STRUCTURES, AS/NZS4600-2005-COLD FORMED STEEL STRUCTURES & NASH-RESIDENTIAL & LOW-RISE STEEL FRAMING.

TIMBER FRAMING

TO BE IN ACCORDANCE WITH NCC, PART 6.1 AND AS1684-2006-RESIDENTIAL TIMBER FRAMED CONSTRUCTION. ALL TIMBER STORED ON SITE TO BE STACKED CLEAR FROM GROUND, IN A DRY LOCATION & IN A MANOR TO PREVENT TWISTING & WARPING. ROOF & WALL CLADDING

TO BE IN ACCORDANCE WITH NCC, PART 7.5, AS2049-2002-ROOF TILES, AS2050-2002-INSTALLATION OF ROOF TILES, AS1562.1-1992-DESIGN & INSTALLATION OF SHEET ROOF & WALL CLADDING, AS/NZS1562.2-1999-DESIGN & INSTALLATION OF SHEET ROOF & WALL CLADDING, AS/NZS1562.3-1996-PLASTIC SHEET ROOFING, AS/NZS4256-Pts 1,2,3 & 5-1994-PLASTIC ROOF & WALL CLADDING MATERIAL, AS/NZS4200-1994-INSTALLATION OF PLIABLE MEMBRANE & UNDERLAY, & ASTM D3018-90-1994-ASPHALT SHINGLES.

LEAD FLASHING MUST NOT BE USED ON ANY ROOF THAT IS PART OF PORTABLE WATER CATCHMENT AREA

ALL METAL SHEET ROOFING, FLASHING, CAPPING, FASTENERS & GUTTERING TO BE PROTECTED FROM CORROSION & WHERE DIFFERENT MATERIALS ARE USED IN ANY PART OF THE ROOFING SYSTEM AS NOTED ABOVE, THEY MUST BE COMPATIBLE WITH EACH OTHER TO PREVENT CORROSION DUE TO AN ADVERSE CHEMICAL REACTION.

GUTTERS & DOWNPIPES

TO BE IN ACCORDANCE WITH NCC, PART 7.4, AS/NZS3500.3-2003-STORMWATER DRAINAGE, AS/NZS3500.5-2000- DOMESTIC INSTALLATIONS, AS1273-1991-UPVC DOWNPIPES & FITTINGS FOR RAINWATER & AS/NZS2179.1-1994-METAL SHAPE OR SHEET RAINWATER GOODS AND METAL ACCESSORIES AND EASTENERS

GUTTERS TO BE INSTALLED WITH A FALL NOT LESS THAN 1:500 FOR EAVE GUTTERS UNLESS FIXED TO METAL FASCIA & MUST BE SUPPORTED BY BRACKETS AT MAXIMUM 1200MM CENTRES.

BOX GUTTERS TO HAVE A MINIMUM FALL WIDTH OF 1:100 VALLEY GUTTERS TO HAVE A MINIMUM WIDTH OF 400MM DOWNPIPES MUST BE SECURELY FIXED TO WALLS, BE LOCATED AT MAX 1200MM CENTRES & WHERE POSSIBLE BE PROVIDED AS CLOSE TO VALLEY GUTTERS AS POSSIBLE

ALL ROOF DRAINAGE TO DESIGNED SO THAT OVERFLOW DURING HEAVY RAIN PERIODS IS PREVENTED FROM FLOWING BACK INTO THE BUILDING. DOWNPIPE TYPES & SIZES TO COMPLY WITH NCC TABLES 7.4.2.1 & 7.4.2.2

GLAZING

TO BE IN ACCORDANCE WITH NCC, PART 3.6, AS2047-1999-WINDOWS IN BUILDING-SELECTION & INSTALLATION & AS1288-2006-GLASS IN BUILDINGS-SELECTION & INSTALLATION.

FULLY FRAMED GLAZING GREATER THAN 0.5m2 (OTHER THAN 1200MM FROM FINISHED FLOOR LEVEL TO BE GRADE A TOUGHENED SAFETY GLASS. UNFRAMED DOORS TO BE GRADE A TOUGHENED SAFETY GLASS WITH STANDARD MINIMUM NOMINAL THICKNESS OF 10MM FULL HEIGHT FRAMED GLAZED PANELS LESS THAN 500MM FROM THE HIGHEST ABUTTING FINISHED FLOOR LEVEL GREATER THAN 0.9m2 TO BE GRADE A SAFETY GLASS IN ACCORDANCE WITH NCC TABLE 3.6.5 FRAMED GLAZING FOR SHOWER DOORS, SHOWER SCREEN AND BATH ENCLOSURE AS WELL AS WINDOWS WITHIN 1500MM VERTICAL AND

OR 500MM HORIZONTAL TO THE BASE OF SHOWERS OR BATHS TO BE EITHER GRADE A SAFETY GLASS IN ACCORDANCE WITH NCC TABLE

GRADE B SAFETY GLASS IN ACCORDANCE WITH NCC TABLE 3.6.5 GLAZING WITH EXPOSED EDGE MUST BE TOUGHENED SAFETY GLASS IN ACCORDANCE WITH NCC TABLE 3.6.4 WITH A MINIMUM NOMINAL THICKNESS OF 5MM. ALL EXTERNAL PERIMETER WINDOWS TO BE FLASHED RIGHT ROUND ALL WINDOW SIZES WITHIN THESE PLANS ARE NOMINAL AND MAY

VARY ACCORDING TO MANUFACTURE FIRE SAFETY

TO BE IN ACCORDANCE WITH NCC. PART H3, AS3786-1993-SMOKE ALARMS, AS1691-1985-DOMESTIC OIL-FIRED APPLIANCES-INSTALLATION AS/NZS2918-2001-DOMESTIC SOLID FUEL BURNING APPLIANCES-INSTALLATION & AS3959-1999-CONSTRUCTION OF BUILDING IN BUSHFI PRONE AREAS.

ALL FLOORS BETWEEN OTHERS OCCUPANCIES, PARTY WALLS, WALLS WITHIN 900MM DISTANCE AND FAVES WITHIN 500MM DISTANCE FROM TITLE BOUNDARY OR OTHER ADJOINING BUILDINGS MUST BE CONSTRUCTED WITH A NON- COMBUSTABLE MATERIAL HAVING A FRL OF NOT LESS THAN 60 / 60 / 60

ROOF LIGHTS MUST NOT BE 900MM DISTANCE FROM TITLE BOUNDARY OR ADJOINING BUILDINGS OR WITHIN 1800MM FROM ADJOINING BUILDING ROOF LIGHTS, (REFER TO NCC FIGURE 3.7.1.12)

BOILDING ROOF LIGHTS (REFER TORCE FIGURE 37.1.1.2) SMOKE ALARMS TO BE HARD WIRED TO CONSUMER MAINS & INSTALLED ON OR NEAR THE CEILING (WITH SPECIAL CARE TAKEN TO AVOID DEAD AIR SPACES) OF ANY STOREY CONTAINING BEDROOMS AS SHOWN IN NCC FIGURE 3.7.2.1 AND IN ANY OTHER STOREY NOT CONTAINING BEDROOMS AS IN NCC FIGURE 3722

ALL HEATING APPLIANCES TO BE INSTALLED IN STRICT ACCORDANCE TO MANUFACTURES SPECS AND NCC, PART H3 WET AREAS

TO BE IN ACCORDANCE WITH NCC, PART 10.2 & AS3740-2004-WATERPROOFING OF WET AREAS IN RESIDENTIAL BUILDINGS. ALL WET AREAS MUST BE WATERPROOFED OR WATER RESISTANT IN ACCORDANCE WITH NCC TABLE 10.2.1.1 & NCC FIGURES 10.2.1.1.1 TO 3.8.1.16 ALL INCLUSIVE

ALL PLASTERBOARD USED IN WET AREAS MUST BE WR GRADE (WATER RESISTANT) WITH ALL CORNERS AND EDGES INCLUDING BOTTOM EDGES OVER SHOWER BASE/ HOB, BATH TUBS & BENCHES WITH BASINS, ADEQUATELY WATERPROOFING TO PREVENT MOISTURE PENETRATION. STRICTLY MOULD RESISTANT GROUT AND SILICON TO BE USED IN ALL WET AREAS.

VENTILATION TO BE IN ACCORDANCE WITH NCC, PART 3.8.5 & AS1668.2-1991-MECHANICAL VENTILATION FOR ACCEPTABLE INDOOR-AIR QUALITY. MECHANICAL VENTILATION TO SANITARY ROOMS & RANGE-HOODS ARE TO BE DISCHARGE DIRECTLY TO THE OUTSIDE AIR AT A MINIMUM RATE OF 25L/s MINIMUM.

BALUSTRADE

TO BE IN ACCORDANCE WITH NCC. PART 10.6. AS1170.1-1989-DEAD AND LIVE LOADS AND LOAD COMBINATIONS. & AS/ NZS1170.1-

PERANENT, IMPOSED AND OTHER ACTIONS. BALUSTRADES ARE REQUIRED WHERE ANY LEVEL IS MORE THAN 1000MM ABOVE THE SURFACE BENEATH (REFER TO NCC FIGURE 10.6.2.3) & BE MINIMUM 865MM ABOVE THE FINISHED SURFACE OF THE NOSING ON TREADS & MINIMUM 1000MM ABOVE THE FINISHED SURFACE OF LANDINGS WITH NO PART OF THE BALUSTRADE TO ALLOW A 125MM SPHERE TO PASS THROUGH. (REFER TO NCC FIGURE 10.6.2.1)

BALUSTRADES 4000MM AND GREATER ABOVE ADJOINING SURFACE MUST NOT HAVE ANY PART THAT IS CLIMBABLE. SWIMMING POOL

TO BE IN ACCORDANCE WITH NCC, PART H7 & AS1926.1-1993-FENCING FOR SWIMMING POOLS. SAFETY FENCING LOCATIONS MUST BE IN ACCORDANCE WITH NCC FIGURE H7.02 & IN A MANOR THAT THE MINIMUM HEIGHT OF FENCING IS 1200MM RIGHT ROUND AND MUST NOT BE AFFECTED BY NEARBY OBJECTS. (REFER TO NCC FIGURE H7.3.4) WHERE PERFORATED MESH MATERIAL WITH APERTURE MORE THAN 13MM IS USED BUT LESS THAN 100MM, HEIGHT OF FENCE MUST BE IN ACCORDANCE WITH NCC FIGURE 3.9.3.3

NO PART OF POOL FENCING IS TO BE CLIMBABLE IN ANY WAY WITH MAXIMUM VERTICAL SPACING OF 10MM. GATES ARE TO SWING OUTWARDS

FROM POOL AREA, BE FITTED WITH CLOSING DEVICE & LATCH. WITH LATCH LOCATED AND SHIELDED IN ACCORDANCE WITH NCC FIGURE H7.3.4

STAIR CONSTRUCTION

TO BE IN ACCORDANCE WITH NCC, PART 11.2 AND AS1657-1992-FIXED PLATFORMS, WALKWAYS, STAIRWAYS & LADDERS-DESIGN CONSTRUCTION AND INSTALLATION.

EACH FLIGHT OF STAIRS TO HAVE MAXIMUM 18 RISES, 3 WINDERS IN LIEU OF QUARTER LANDING OR 6 WINDERS IN LIEU OF EACH HALF LANDING. LANDINGS MUST NOT BE LESS THAN 750MM LONG MEASURED 500MM FROM INSIDE EDGE OF LANDING, (REFER TO NCC FIGURE 11.2.1.5) AND HAVE A GRADIENT NOT STEEPER THAN 1:50 RISES (OTHER THAN SPIRAL) TO BE MINIMUM 115MM & MAXIMUM 190MM. GOING OTHER THAN SPIRAL) TO BE MINIMUM 240MM & MAXIMUM 355MM. A 125MM SPHERE MUST NOT PASS THROUGH TREADS. (REFER TO NCC FIGURES 11.2.1.2 TO 11.2.1.4 INCLUSIVE) ENERGY EFFICIENCY

TO BE IN ACCORDANCE WITH NCC, PART H6 & J2, NCC APPENDIX A & AS4859.1-2002-GENERAL CRITERIA AND TECHNICAL PROVISIONS. REFER TO ENERGY EFFICIENCY REPORT BASIX FOR ALL, INSTALLATION LEVELS, WINDOW FRAME & GLAZING TYPES, AND OTHER SPECIFICATIONS REQUIRED TO ACHIEVE STAR RATING

REFLECTIVE FOIL MUST BE INSTALLED ADEQUATLY TO FRAMING MEMBERS WITH JOINS OVERLAPPING MINIMUM 150MM OR ADEQUATELY TAPPED

WHERE REQUIRED, BULK INSULATION SHOULD MAINTAIN ITS POSITION & THICKNESS (OTHER THAN AREAS SUCH AS NOGGINS, BATTENS, SERVICES ETC) & PLACED HARD UP AGAINST ALL STUDS, OPENINGS & THE LIKE TO MINIMISE AIR MOVEMENT & MAINTAIN ITS EFFECTIVE PERFORMANCE INTEGRITY.

ALL GAPS AROUND & WITHIN EXTERNAL DOORS, WINDOWS, ROOF LIGHTS & SERVICES PENETRATING EXTERNAL WALLS TO BE SEALED OR CAPABLE OF BEING SEALED WHEN IN A CLOSED POSITION SO AS TO RESTRICT AIR INFILTRATION



COPYRIGHT: ALL WORK IS TO COMPLY WITH THE BUILDING CODE OF AUSTRALIA, RELEVANT AUSTRALIAN STANDARDS & LOCAL AUTHORITY REQUIREMENTS. BUILDING CONTRACTOR & ALL RELEVANT SUB TRADES

BUILDING CONTRACTOR & ALL RELEVANT SUB TRADES TO CHECK & VERIFY ALL DIMENSIONS & ASSOCIATED DRAWING PARTS PRIOR TO MANUFACTURE. CONSTRUCTION & INSTALLATION ON SITE. DO NOT SCALE OFF DRAWINGS - WRITTEN DIMENSIONS TAKE PRECEDENCE. PLAN LAND ACCEPTS NO LIABILITY OR RESPONSIBILITY RESULTING FROM BUILDERS NEGLECT OR PREFERED METHOD OF CONSTRUCTION FOR ANY BUILDING

METHOD OF CONSTRUCTION FOR ANY BUILDING

DEFECT. THESE DRAWINGS ARE THE PROPERTY OF PLAN LAND. DRAWINGS ARE NOT TO BE REPRODUCED IN PART OR IN WHOLE ON ANY MEDIUM WITHOUT THE WRITTEN PERMISSION OF PLAN LAND.

NOTE: ALL EXISTING & OVERALL DIMENSIONS ARE NOMINAL & SUBJECT TO VERIFICATION ON SITE. WHERE ANY DISCREPANCY OCCURS BETWEEN NEW WORK & EXISTING BETWEEN NEW WORK & EXISTING DMENSIONS - FXISTING DIMENSIONS/WORK SHOULD

DIMENSIONS - EXISTING DIMENSIONS/WORK SHOULD TAKE PREFERENCE WHERE NECESSARY - OTHERWISE NOTIFY PLAN LAND

NOTE: SELECTED TERMITE PROTECTION TO BE USED ON SITE IN ACCORDANCE WITH LOCAL COUNCIL'S

REQUIREMENTS, B.C.A. AND ALL RELEVANT AUSTRALIAN STANDARDS

NOTE: SMOKE DETECTORS TO COMPLY WITH REQUIREMENTS SMORE DEFICATION EL7 (NSW) FIRE AND SMOKE ALARMS SHALL COMPLY WITH AS 3786 AND BE CONNECTED TO MAIN POWER SUPPLY.

NOTE: LOCATION OF SMOKE ALARMS IN ACCORDANCE WITH CLAUSE 3.7.5.2 OF THE NCC.

NOTE: STAIRWAY TO HAVE A NON-SLIP FINISH OR NOSING STRIP IN ACCORDANCE WITH CLAUSE 3.9.1.4 AND TABLE 3.9.1.3 OF THE NCC.

NOTE: METHOD OF VENTILATING THE LAUNDRY AND WC AND CONTROLLING CONDENSATION IN ACCORDANCE WITH CLAUSES 3.8.5.2 & 3.8.7.3 OF THE NCC.

34 Lang Street, Mudgee NSW 2850

Spec. & Notes

| newton teale o | onsulting pty ltd | ABN: | |
|---------------------|-------------------|------------|-----------|
| trading as p | an land | 62 128 | 3 716 334 |
| PO BOX 495 0 | Gymea NSW | | |
| Phone: 0403 | 3 993 876 | | |
| Email: info | @planland.com.au | | |
| Drawn: | Approved: | Date: | |
| LT | LT | OCT/ | 2022 |
| Scale: | Drawing No.: | Sheet No.: | Rev.: |
| @A3 | 22113 | DA 0.4 | |

NCC NATIONAL CONSTRUCTION CODE 2022 ABCB HOUSING PROVISIONS - REFERENCED DOCUMENTS

| NCC NATIONAL CON | STRUCTION CODE 2022 ABCB HOUSING PROVISIONS - REFERENCED DOCUMENTS |
|---|---|
| AS/NZS 1170.2 AS 1288 AS 1397 | The 2021 edition of AS/NZS 1170 Part 2 'Structural design actions — Wind actions' has been referenced. The 2021 edition of AS 1288 'Glass in buildings — Selection and installation' has been referenced. The 2021 edition of AS 1397 'Continuous hot-dip metallic coated steel sheet and strip — Coatings of zinc and zinc alloyed with aluminium |
| AS 1530 Parts 1 to 4 | and magnesium' has been referenced. A note has been included to outline transitional arrangements. The notes to AS 1530 Parts 1 to 4 have been deleted. |
| AS 1530.8.1 AS/NZS 1546.1 | The 2018 edition of AS 1530 Part 8.1 'Methods for fire tests on building materials, components and structures — Tests on elements of construction for buildings exposed to simulated bushfire attack — Radiant heat and small flaming sources' has been referenced. The 2008 edition of AS/NZS 1546 Part 1 'On-site domestic wastewater treatment units — Septic tanks' has been referenced. |
| AS/NZS 1546.2 | The 2008 edition of AS/NZS 1546 Part 2 'On-site domestic wastewater treatment units — Septic tarks has been referenced. |
| AS 1546.3 | Amdt 1 of the 2017 edition of AS 1546 Part 3 'On-site domestic wastewater treatment units — Secondary treatment systems (incorporating amendment 1)' has been referenced. |
| AS 1546.4 | The 2016 edition of AS 1546 Part 4 'On-site domestic wastewater treatment units — Domestic greywater treatment systems' has been referenced. |
| AS/NZS 1547 AS/NZS 1562.2 | The 2012 edition of AS/NZS 1547 'On-site domestic wastewater management' has been referenced. The 1999 edition of AS/NZS 1562 Part 2 'Design and installation of sheet roof and wall cladding — Corrugated fibre-reinforced cement' has been deleted. |
| AS 1562.3 AS 1670.1 | The 2006 edition of AS 1562 Part 3 'Design and installation of sheet roof and wall cladding — Plastic' has been referenced. Amdt 1 of the 2018 edition AS 1670 Part 1 'Fire detection, warning, control and intercom systems — System design, installation and commissioning — Fire (incorporating amendment 1)' has been referenced. Notes to AS 1670 have been amended to outline transitional arrangements. |
| AS 1670.3 | Amdt 1 of the 2018 edition AS 1670 Part 3 'Fire detection, warning, control and intercom systems — System design, installation and commissioning — Fire alarm monitoring (incorporating amendment 1)' has been referenced. Notes to AS 1670 have been amended to |
| AS 1670.4 | outline transitional arrangements. Amdt 1 of the 2018 edition AS 1670 Part 4 'Fire detection, warning, control and intercom systems — System design, installation and commissioning — Emergency warning and intercom systems (incorporating amendment 1)' has been referenced. Notes to AS 1670 have been amended to outline transitional arrangements. |
| AS 1684.2 AS 1684.3 | The 2021 edition of AS 1684 Part 2 'Residential timber-framed construction — Non-cyclonic areas' has been referenced. The 2021 edition of AS 1684 Part 3 'Residential timber-framed construction —Cyclonic areas' has been referenced. |
| AS/NZS 1720.4 AS 1720.5 | The 2019 edition of AS/NZS 1720 Part 4 'Timber structures — Fire resistance of timber elements' has been referenced. Amdt 1 of the 2015 edition of AS 1720 Part 5 'Timber structures — Nailplated timber roof trusses (incorporating amendment 1)' has been referenced. |
| AS/NZS 1859.4 AS 2118.1 | The note to AS/NZS 1859 Part 4 has been deleted. Amdt 2 of the 2017 edition of AS 2118 Part 1 'Automatic fire sprinkler systems — General systems (incorporating amendments 1 and 2)' |
| AS 2118.4 | has been referenced. The 2012 edition of AS 2118 Part 4 'Automatic fire sprinkler systems — Sprinkler protection for accommodation buildings not exceeding four storeys in height'. |
| AS 2118.5 | The 2008 edition of AS 2118 Part 5 'Automatic fire sprinkler systems — Home fire sprinkler systems' has been referenced. |
| AS 2118.6 AS/NZS 2293.1 | The 2012 edition of AS 2118 Part 6 'Automatic fire sprinkler systems — Combined sprinkler and hydrant systems in multistorey buildings.' Amdt 1 of the 2018 edition of AS/NZS 2293 Part 1 'Emergency lighting and exit signs for buildings — System design, installation and operation (incorporating amendment 1)' has been referenced. |
| AS 2312.1 | The 2014 edition of AS 2312 Part 1 'Guide to the protection of structural steel against atmospheric corrosion by the use of protective coatings — Paint coatings' has been referenced. |
| AS/NZS 2312.2 | The 2014 edition of AS 2312/NZS Part 2 'Guide to the protection of structural steel against atmospheric corrosion by the use of protective coatings — Hot dip galvanizing' has been referenced. |
| AS/NZS 2327 | Amdt 1 of the 2017 edition of AS/NZS 2327 'Composite structures — composite steel-concrete construction in buildings (incorporating amendment 1)' has been referenced. |
| AS 2419.1 AS 2699.1 | The 2021 edition of AS 2419 Part 1 'Fire hydrant installations — System design, installation and commissioning' has been referenced. The 2020 edition of AS 2699 Part 1 'Built-in components for masonry construction — Wall ties' has been referenced. A note has been included to outline transitional arrangements. |
| AS 2699.3 | The 2020 edition of AS 2699 Part 3 'Built-in components for masonry construction — Lintels and shelf angles (durability requirements)' has been referenced. A note has been included to outline transitional arrangements. |
| AS/NZS 3500.0 AS/NZS 3500.1 AS/NZS 3500.2 | The 2021 edition of AS 3500 Part 0 'Plumbing and drainage — Glossary of terms' has been referenced. The 2021 edition of AS 3500 Part 1 'Plumbing and drainage — Water services' has been referenced. Amdt 1 of the 2021 edition of AS 3500 Part 2 'Plumbing and drainage — Sanitary plumbing and drainage (incorporating amendment 1)' |
| AS/NZS 3500.3 | has been referenced. The 2021 edition of AS 3500 Part 3 'Plumbing and drainage — Stormwater drainage' has been referenced. A note has been included to |
| AS/NZS 3500.4 AS 3600 | outline transitional arrangements. The 2021 edition of AS 3500 Part 4 'Plumbing and drainage — Heated water services' has been referenced. Amdt 2 of the 2018 edition of AS 3600 'Concrete structures (incorporating amendments 1 and 2)' has been referenced. |
| AS 3000 AS 3740 AS 3959 | The 2021 edition of AS 3740 'Waterproofing of domestic wet areas' has been referenced. The 2021 edition of AS 3740 'Waterproofing of domestic wet areas' has been referenced. Amdts 1 and 2 of the 2018 edition of AS 3959 'Construction of buildings in bushfire-prone areas (incorporating amendments 1 and 2)' has |
| AS 4055 | been referenced. The 2021 edition of AS 4055 'Wind loads for housing' has been referenced. |
| AS 4072.1 AS 4100 | The note to AS 4072 Part 1 has been deleted. The 2020 edition of AS 4100 'Steel structures' has been referenced. |
| AS 4200.1 | Amdt 1 of the 2017 edition of AS 4200 Part 1 'Pliable building membranes and underlays — Materials (incorporating amendment 1)' has been referenced. |
| AS 4200.2 | Amdts 1 and 2 of the 2017 edition of AS 4200 Part 2 'Pliable building membranes and underlays — Installation (incorporating amendments 1 and 2)' has been referenced. |
| AS/NZS 4234 AS 4254.1 | The 2021 edition of AS/NZS 4234 'Heated water systems — Calculation of energy consumption' has been referenced. The 2021 edition of AS 4254 Part 1 'Ductwork for air-handling systems in buildings — Flexible duct' has been referenced. |
| AS/NZS 4256.1 AS/NZS 4256.2 | The 1994 edition of AS/NZS 4256 Part 1 'Plastic roof and wall cladding materials — General requirements' has been deleted. The 1994 edition of AS/NZS 4256 Part 2 'Plastic roof and wall cladding materials — Unplasticized polyvinyl chloride (uPVC) building |
| AS/NZS 4256.3 | sheets' has been deleted. The 1994 edition of AS/NZS 4256 Part 3 'Plastic roof and wall cladding materials — Glass fibre reinforced polyester (GRP)' has been deleted. |
| AS/NZS 4256.5 | The 1996 edition of AS/NZS 4256 Part 5 'Plastic roof and wall cladding materials — Polycarbonate' has been deleted. Amdt 1 of the 2015 edition of AS 4773 Part 2 'Masonry in small buildings — Construction' has been referenced. |
| AS 4773.2 AS/NZS 4858 | The 2004 edition of AS/NZS 4858 'Wet area membranes' has been referenced. |
| AS 5146.3 AS 5216 | The 2018 edition of AS 5146 Part 3 'Reinforced Autoclaved Aerated Concrete — Construction' has been referenced. The 2021 edition of AS 5216 'Design of post-installed and cast-in fastenings in concrete' has been referenced. |
| AS/NZS 5601.1 | The 2013 edition of AS/NZS 5601 Part 1 'Gas installations — General installations' has been referenced. |
| AIRAH-DA07 ASTM E903 | The 2021 edition of AIRAH-DA07 'Criteria for moisture control design analysis in buildings' has been referenced. The 2012 edition of ASTM E903 'Standard Test Method for Solar Absorptance, Reflectance, and Transmittance of Materials Using Integrating Spheres' has been deleted. |
| ASTM E96 ABCB | The 2016 edition of ASTM E96 'Standard Test Methods for Water Vapor Transmission of Materials' has been referenced. The 2022 version of the ABCB 'Fire Safety Verification Method' Standard has been referenced. As a consequence, the FSVM is deleted as a standalone schedule. |
| ABCB | The 2022 version of the ABCB 'Housing Provisions' Standard has been referenced. |
| ABCB ABCB | The 2022 version of the ABCB 'Livable Housing Design' Standard has been referenced. The 2022 version of the ABCB 'Standard for NatHERS Heating and Cooling Load Limits' has been referenced. |
| ABCB FPAA101D | The 2022 version of the ABCB 'Standard for Whole-of-home Efficiency Factors' has been referenced. The 2021 edition of FPAA101D 'Automatic Fire Sprinkler System Design and Installation — Drinking Water Supply' has been referenced. |
| FPAA101H | Amdt 1 of the 2018 edition of FPAA101H 'Automatic Fire Sprinkler System Design and Installation — Hydrant Water Supply (incorporating amendment 1)' has been referenced. |
| NASH Standard NSF/ANSI/CAN 372 | The 2021 edition of NASH Standard 'Steel Framed Construction in Bushfire Areas' has been referenced. The 2020 edition of NSF/ANS/CAN 372 'Drinking Water System Components — Lead Content' has been referenced. |



COPYRIGHT: ALL WORK IS TO COMPLY WITH THE BUILDING CODE OF AUSTRALIA, RELEVANT AUSTRALIAN STANDARDS & LOCAL AUTHORITY REQUIREMENTS. BUILDING CONTRACTOR & ALL RELEVANT SUB TRADES TO CHECK & VERIFY ALL DIMENSIONS & ASSOCIATED DRAWING PARTS PRIOT TO MANUFACTURE, CONSTRUCTION & INSTALLATION ON SITE. DO NOT SCALE OF DRAWINGS - WRITTEN DIMENSIONS TAKE PRECEDENCE. PLAN LAND ACCEPTS NO LIABILITY OR RESPONSIBILITY RESULTING FROM BUILDERS NEGLECT OR PREFERRED METHOD OF CONSTRUCTION FOR ANY BUILDING DEFECT. THESE DRAWINGS ARE THE PROPERTY OF PLAN LAND. DRAWINGS ARE NOT TO BE REPRODUCED IN PART OR IN WHOLE ON ANY MEDIUM WITHOUT THE WRITTEN PREMISSION OF PLAN LAND.

NOTE: ALL EXISTING & OVERALL DIMENSIONS ARE NOMINAL & SUBJECT TO VERIFICATION ON SITE. WHERE ANY DISCREPANCY OCCURS BETWEEN NEW WORK & EXISTING BETWEEN NEW WORK & EXISTING DIMENSIONS - EXISTING DIMENSIONS/WORK SHOULD TAKE PREFERENCE WHERE NECESSARY - OTHERWISE NOTIFY NOTE:

NOTE: SELECTED TERMITE PROTECTION TO BE USED ON SITE IN ACCORDANCE WITH LOCAL COUNCIL'S REQUIREMENTS, B.C.A. AND ALL RELEVANT AUSTRALIAN STANDARDS NOTE:

AUSTRALIAN STANDARDS NOTE: SMOKE DETECTORS TO COMPLY WITH REQUIREMENTS OF SPECIFICATION EL7 (NSW) FIRE AND SMOKE ALARMS SHALL COMPLY WITH AS 3786 AND BE CONNECTED TO THE MAIN POWER SUPPLY. NOTE: LOCATION OF SMOKE ALARMS IN ACCORDANCE WITH CLAUSE 3.7.5.2 OF THE NCC. NOTE:

NOTE: STAIRWAY TO HAVE A NON-SLIP FINISH OR NOSING STRIP IN ACCORDANCE WITH CLAUSE 3.9.1.4 AND TABLE 3.9.1.3 OF THE NCC.

MOTE: METHOD OF VENTILATING THE LAUNDRY AND WC AND CONTROLLING CONDENSATION IN ACCORDANCE WITH CLAUSES 3.8.5.2 & 3.8.7.3 OF THE NCC.

| newton teale c | onsulting pty ltd | ABN: | |
|----------------------|------------------------------|------------|---------|
| trading as pl | an land | 62 128 | 716 334 |
| PO BOX 495 (| Gymea NSW | | |
| Phone: 0403 | 993 876 | | |
| Email: info@ | [®] planland.com.au | | |
| Drawn: | Approved: | Date: | |
| LT | LT | OCT/2 | 2022 |
| Scale: | Drawing No.: | Sheet No.: | Rev.: |
| @A3 | 22113 | DA 0.5 | |


Project

Client

Drawing: Spec. & Notes

34 Lang Street, Mudgee NSW 2850



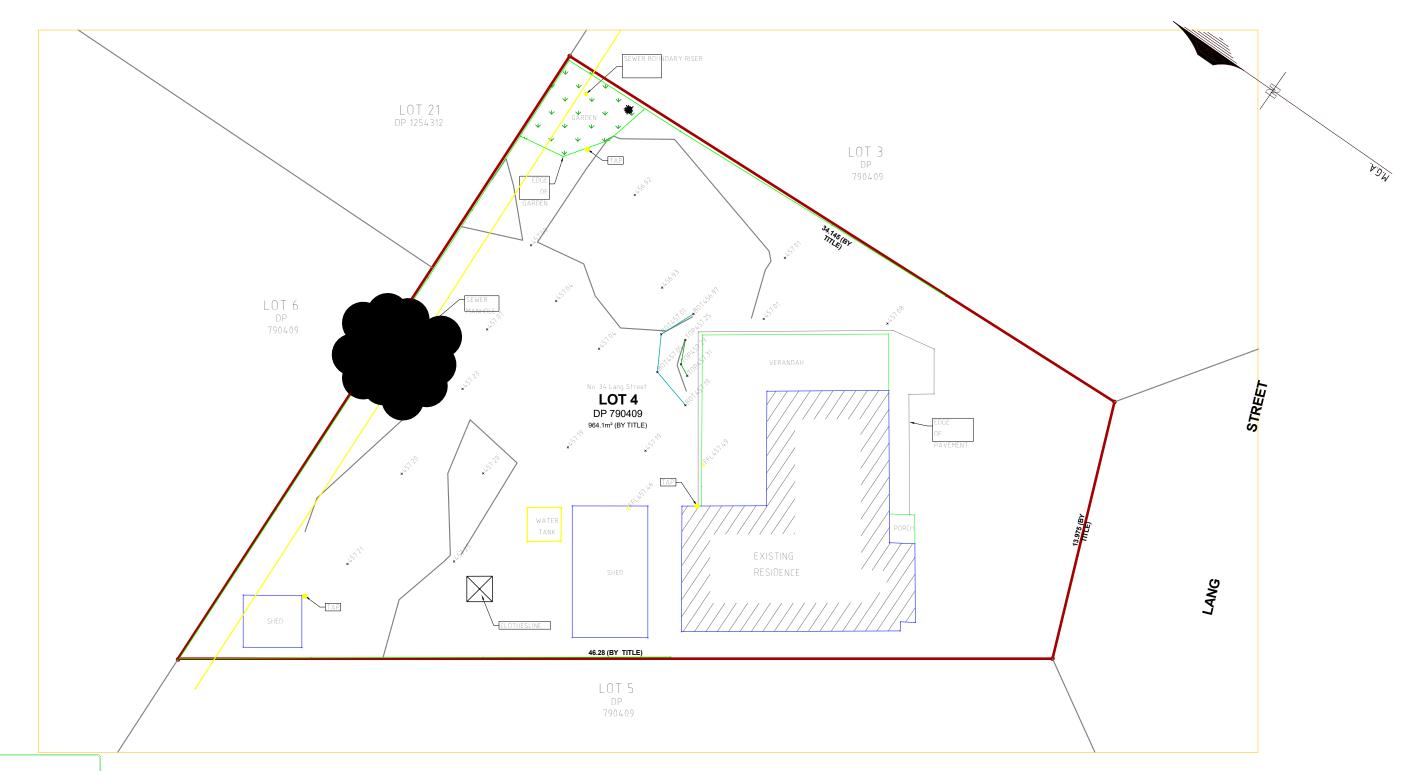

LEVELAND DETAIL SURVEY PLAN REDUCTION RATIO 1:100@A1

SCALE 1:100(A1) 4 6

1200@A3


<u>KEY</u>

| EXISTING SUBJECT CADASTRAL BOUNDARIES |
|---|
| EXISTING FENCE LINE |
| EXISTING UNDERGROUND SEWER PIPE (COUNCIL) |
| TOP OF BANK |
| BOTTOM OF BANK |
| |


- THE BOUNDARY INFORMATION SHOWN ON THIS PLAN BEEN PLOTTED AS REQUIRED UNDER DIVISION 1, SECTION 9 (1) OF THE AND SEAMAL INFORMATION REGULATION 2017". IT HAS NOT BEEN DETERMINED BY AN ACCURATE BOUNDARY
 AND SEAMAL INFORMATION REGULATION 2017". IT HAS NOT BEEN DETERMINED BY AN ACCURATE BOUNDARY
 AND SEAMAL INFORMATION REGULATION 2017". IT HAS NOT BEEN DETERMINET HE SURVEYING AND SPATIAL INFORMATION ACT 2002. IF SURVEYING AND SPATIAL INFORMATION ACT 2002. IF SURVEYING AND DESIGN WORK WHICH RELIES ON CRITICAL SETBACKS FROM THE STREET OR BOUNDARES IS PLANNED, IT WOULD BEEN TIVE TO CARRY OUT FUTTHER SURVEY WORK TO DETERMINE THE BOUNDARY
 AND REPTIVE TO CARRY OUT FUTTHER SURVEY WORK TO DETERMINE THE BOUNDARY
 AND REPTIVE TO CARRY OUT FUTTHER SURVEY WORK TO DETERMINE THE BOUNDARY
 AND REPTIVE TO CARRY OUT FUTTHER SURVEY WORK TO DETERMINE THE BOUNDARY
 AND REPTIVE TO CARRY OUT FUTTHER SURVEY WORK TO DETERMINE THE BOUNDARY
 AND REPTIVE TO CARRY OUT FUTTHER SURVEY WORK TO DETERMINE THE BOUNDARY
 AND REPTIVE TO CARRY OUT FUTTHER SURVEY WORK TO DETERMINE THE BOUNDARY
 AND REPTIVE TO CARRY OUT FUTHER SURVEY SUR

| RNSON. SERVICE AUTHORITIES SHOULD | |
|--|----|
| DATE OF SURVEY : 16th SEPTEMBER 2022 SURVEY BY : R Boylan RSON OR ORGANISATION THAT MAY OCCUR DUE | |
| DATUM : AUSTRALIAN HEIGHT DATUM (A.H.). ORIGIN : PM 2994 RL 460.341m (S.C.I.M.S.) MAJOR CONTOUR INTERVAL : 1 METRE |) |
| MINOD CONTOUR INTERVAL . A 25 MEZ (F) | ć. |

ISSUED TO CLIENT

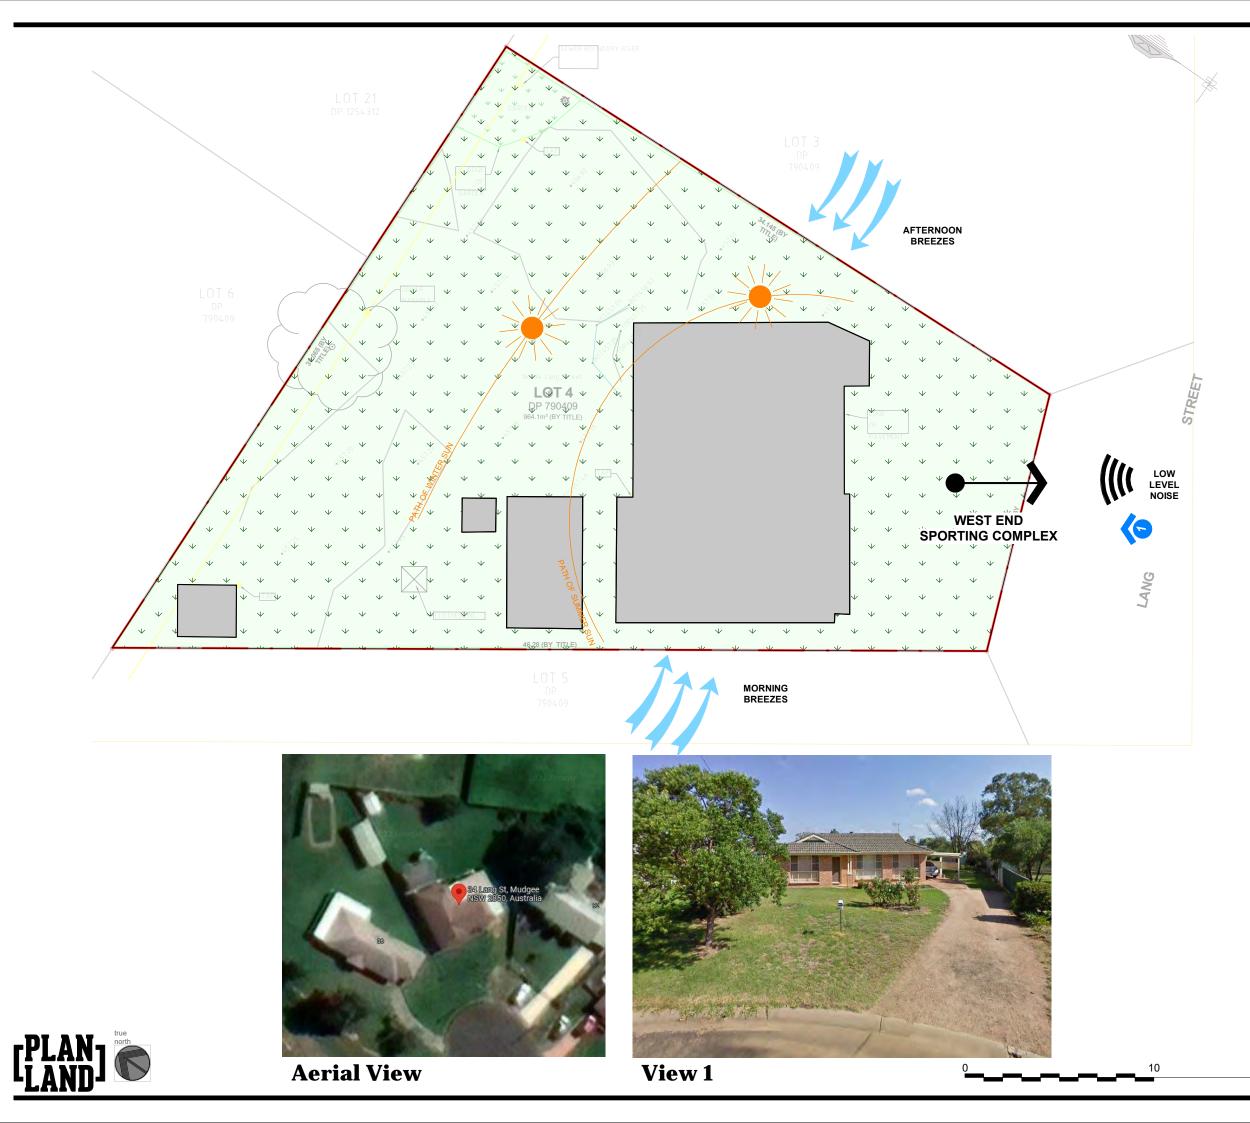

LEGEND:

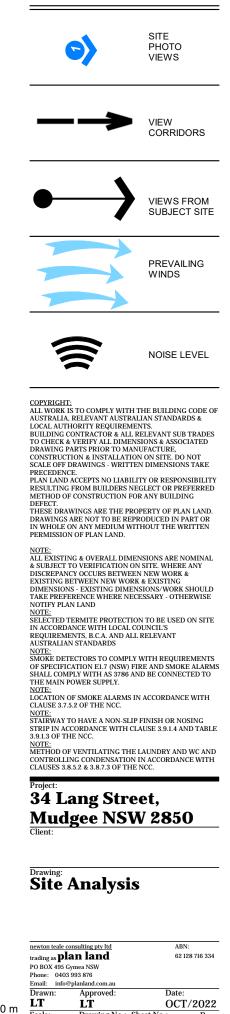


20 m


Approv LT


 Scale:
 Drawing No.:
 Sheet No.:


 1:200@A3
 22113
 DA 1.1

Date: OCT/2022

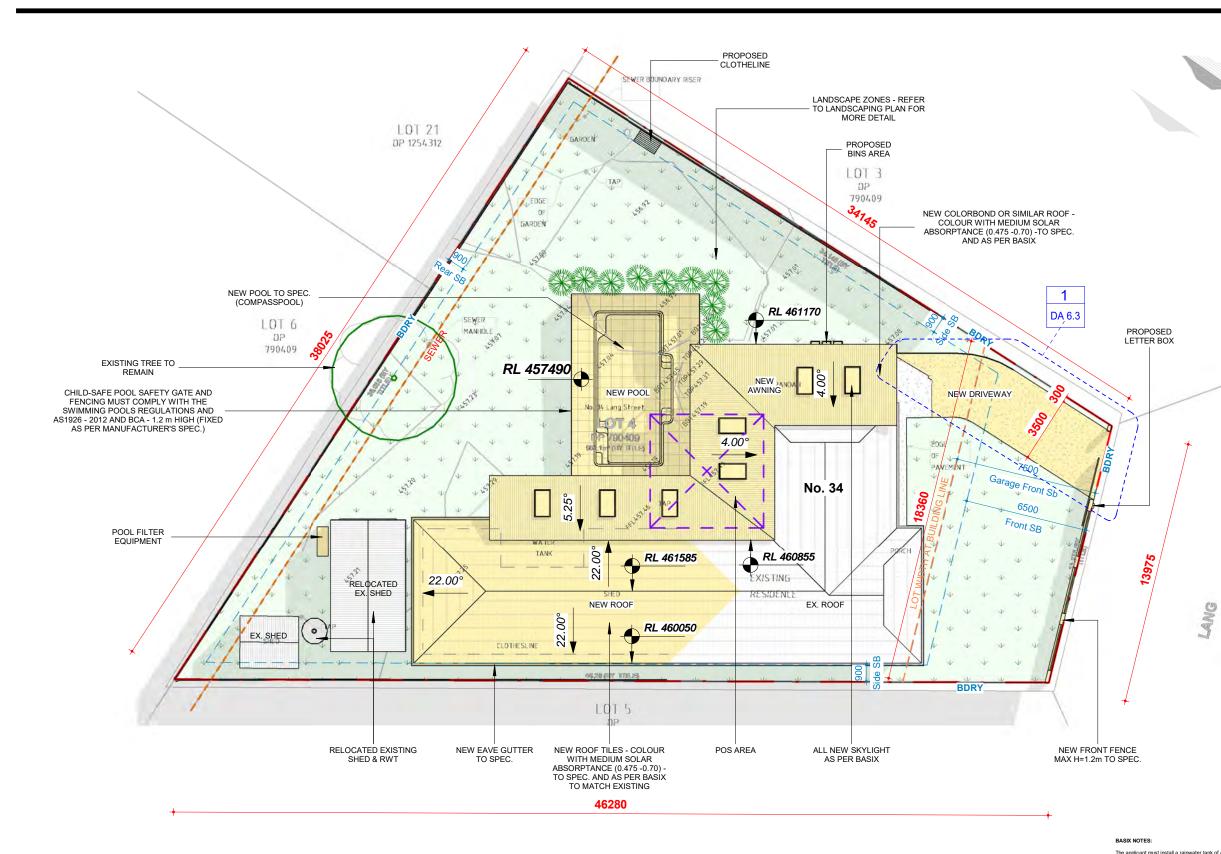

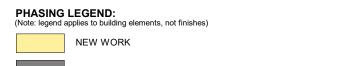

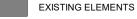

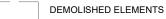



| L | OT AREA | GFA | FSR | LOT AREA | LSA | LSA COVERAGE | |
|----|----------|-----------|------|-----------|-----------|--------------|---|
| 96 | 54.10 m² | 189.84 m² | 0.20 | 964.10 m² | 516.22 m² | 53.54% | (|

10

| | NET AREAS | | | |
|---------------------------------|--------------------|-----------|--|--|
| No. NAME | | AREA | | |
| | | | | |
| 1 | Ex.Entry | 1.65 m² | | |
| 2 | Ex.Family | 16.03 m² | | |
| 3 | Ex. Corridor | 4.54 m² | | |
| 4 | Ex.Kitchen | 6.36 m² | | |
| 5 | New Dining | 26.27 m² | | |
| 1 2 3 4 5 6 7 | New Living | 30.11 m² | | |
| 7 | Ex.Bedroom 1 | 8.90 m² | | |
| 8 | Ex.Bedroom 2 | 13.44 m² | | |
| 9 | Ex.Bath | 5.31 m² | | |
| 10 | Ex.WC | 1.44 m² | | |
| 11 | Ex.Bedroom 3 | 15.57 m² | | |
| 12 | Ex.L'dry | 3.89 m² | | |
| 13 | Ex.Shed | 25.42 m² | | |
| 2.Grou | nd FFL: 13 | 158.93 m² | | |
| Granny | / | | | |
| 14 | New Kitchen/Living | 19.56 m² | | |
| 15 | New Bedroom | 11.65 m² | | |
| 16 | New Bath/L'dry | 6.39 m² | | |
| 17 | New Pantry | 2.56 m² | | |
| 2.Grou | nd FFL: 4 | 40.15 m² | | |
| Grand | total: 17 | 199.08 m² | | |

<u>COPYRIGHT:</u> ALL WORK IS TO COMPLY WITH THE BUILDING CODE OF AUSTRALIA, RELEVANT AUSTRALIAN STANDARDS &

AUSTRALLA, RELEVANT AUSTRALIAN STANDARDS & LOCAL AUTHORTTY REQUIREMENTS. BUILDING CONTRACTOR & ALL RELEVANT SUB TRADES TO CHECK & VERIFY ALL DIMENSIONS & ASSOCIATED DRAWING PARTS PRIOR TO MANUFACTURE, CONSTRUCTION & INSTALLATION ON SITE. DO NOT SCALE OFF DRAWINGS - WRITTEN DIMENSIONS TAKE PRECEDENCE. PLAN LAND ACCEPTS NO LIABILITY OR RESPONSIBILITY RESULTING FROM BUILDERS NEGLECT OR PREFERRED METHOD OF CONSTRUCTION FOR ANY BUILDING DEFECT.

METHOD OF CONSTRUCTION FOR ANY DOLLARS DEFECT. THESE DRAWINGS ARE THE PROPERTY OF PLAN LAND. DRAWINGS ARE NOT TO BE REPRODUCED IN PART OR IN WHOLE ON ANY MEDIUM WITHOUT THE WRITTEN PERMISSION OF PLAN LAND.

NOTE: ALL EXISTING & OVERALL DIMENSIONS ARE NOMINAL & SUBJECT TO VERIFICATION ON SITE. WHERE ANY DISCREPANCY OCCURS BETWEEN NEW WORK & EXISTING BETWEEN NEW WORK & EXISTING DIMENSIONS - EXISTING DIMENSIONS/WORK SHOULD TAKE PREPERENCE WHERE NECESSARY - OTHERWISE NOTE: NOTE:

NOTE: SELECTED TERMITE PROTECTION TO BE USED ON SITE IN ACCORDANCE WITH LOCAL COUNCIL'S REQUIREMENTS, B.C.A. AND ALL RELEVANT

AUSTRALIAN STANDARDS

NOTE: SMOKE DETECTORS TO COMPLY WITH REQUIREMENTS SMORE DETECTORS TO COMPLY WITH REQUIREMENTS OF SPECIFICATION EL7 (NSW) FIRE AND SMOKE ALARMS SHALL COMPLY WITH AS 3786 AND BE CONNECTED TO THE MAIN POWER SUPPLY.

INCLUSE STATES IN ACCORDANCE WITH CLAUSE 3.7.5.2 OF THE NCC.

NOTE: STAIRWAY TO HAVE A NON-SLIP FINISH OR NOSING STRIP IN ACCORDANCE WITH CLAUSE 3.9.1.4 AND TABLE 3.9.1.3 OF THE NCC.

NOTE: METHOD OF VENTILATING THE LAUNDRY AND WC AND CONTROLLING CONDENSATION IN ACCORDANCE WITH CLAUSES 3.8.5.2 & 3.8.7.3 OF THE NCC.

34 Lang Street, Mudgee NSW 2850 Client

Drawing: Site Plan

| newton teale c | onsulting pty ltd | ABN: |
|----------------------|-------------------|----------------|
| trading as pl | an land | 62 128 716 334 |
| PO BOX 495 0 | | |
| Phone: 0403 | 993 876 | |
| Email: info@ | planland.com.au | |
| Drawn: | Approved: | Date: |
| LT | LT | OCT/2022 |
| Scale: | Drawing No.: S | heet No.: Rev. |
| 1:200@A3 | 22113 I | DA 1.2 |


\$

STREET

The applicant must install a rainwater tank of at least 2734 fitres on the site. This rainwater tank must meet, and be instaled in accordance with, the requirements of all applicable regulatory authorities or glazed door above which they are situated, unless the percipa also shades a perpendicular window. The spacing between batters must no be more than 50 mm. The swimming pool must not have a capacity greater than 51 kilotites. The swimming pool must not have a capacity greater than 51 kilotites. The swimming pool must not have a capacity greater than 51 kilotites. The swimming pool must not have a capacity greater than 51 kilotites. The symming and insultants in some site of the table below, except that a) additional insultants in some pacelifications listed in the table below, except insultion already exists. The applicant must install the windows, glazed doors and shading devices, in accordance with the specifications listed in the table below. Relevant overshadowing specifications must be satisfied for each window and glazed door.

door. For projections described in millimetres, the leading edge of each eave, pergola, verandah, balcony or awning must be no more than 500 mm above the head of the window or glazed door and no more than 2400 mm above the sill.

20 m

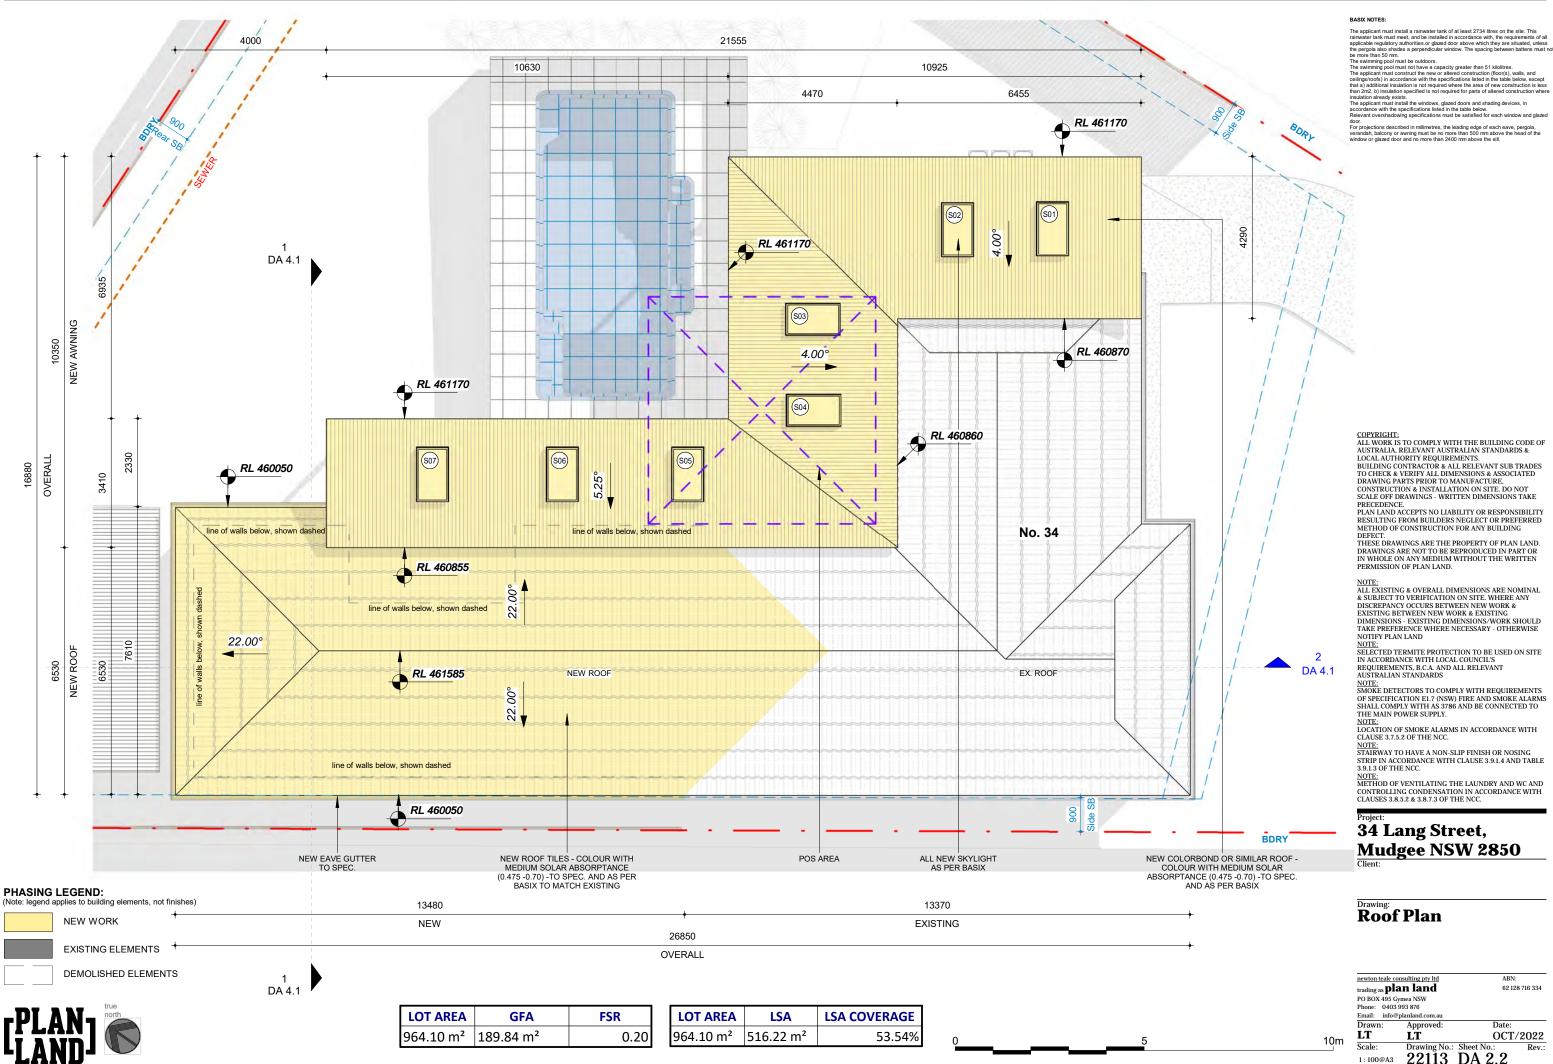



The applicant must install a rainwater tank of at least 2734 litres on the site. This rainwater tank must meet, and be installed in accordance with, the requirements applicable regulatory authorities or glazed door above which they are situated, up the pergola also shades a perpendicular window. The spacing between batters in be more than 50 mm. The swimming pool must be outdoors.

The swimming pool must be outdoors. The swimming pool must not have a capacity greater than 51 kiloitires. The applicant must construct the new or altered construction (floor(s), walls, and collings/roofs) in accordance with the specifications listed in the table below, except that a) additional insulation is not required where the area of new construction is less that na n2m2. b) insulation specified is not required to there to a latered construction.

already exists. ant must install the windows, glazed doors and shading devices, in ons listed in the table below. ications must be satisfied for each window and gla

| newton teale c | onsulting pty ltd | ABN: |
|----------------------|-------------------|----------------|
| trading as pl | an land | 62 128 716 334 |
| PO BOX 495 0 | Symea NSW | |
| Phone: 0403 | 993 876 | |
| Email: info@ | planland.com.au | |
| Drawn: | Approved: | Date: |
| LT | LT | OCT/2022 |
| Scale: | Drawing No.: 5 | Sheet No.: Rev |
| 1:100@A3 | 22113 I | DA 2.2 |

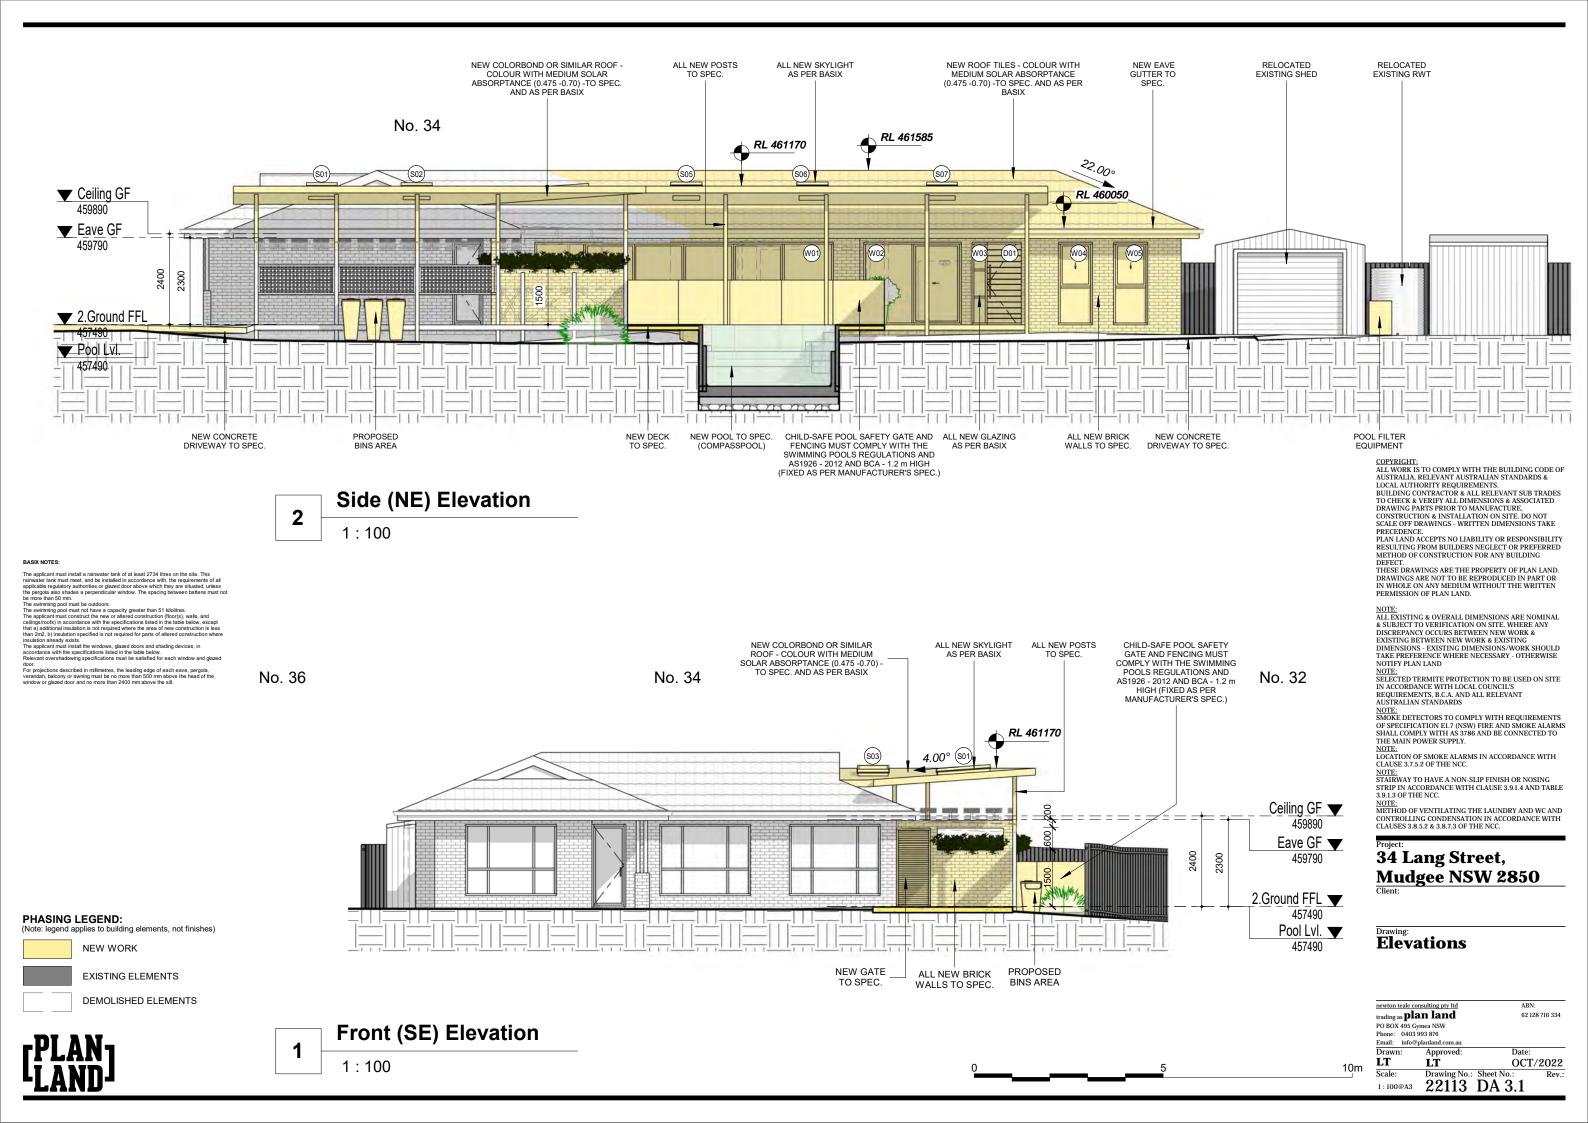

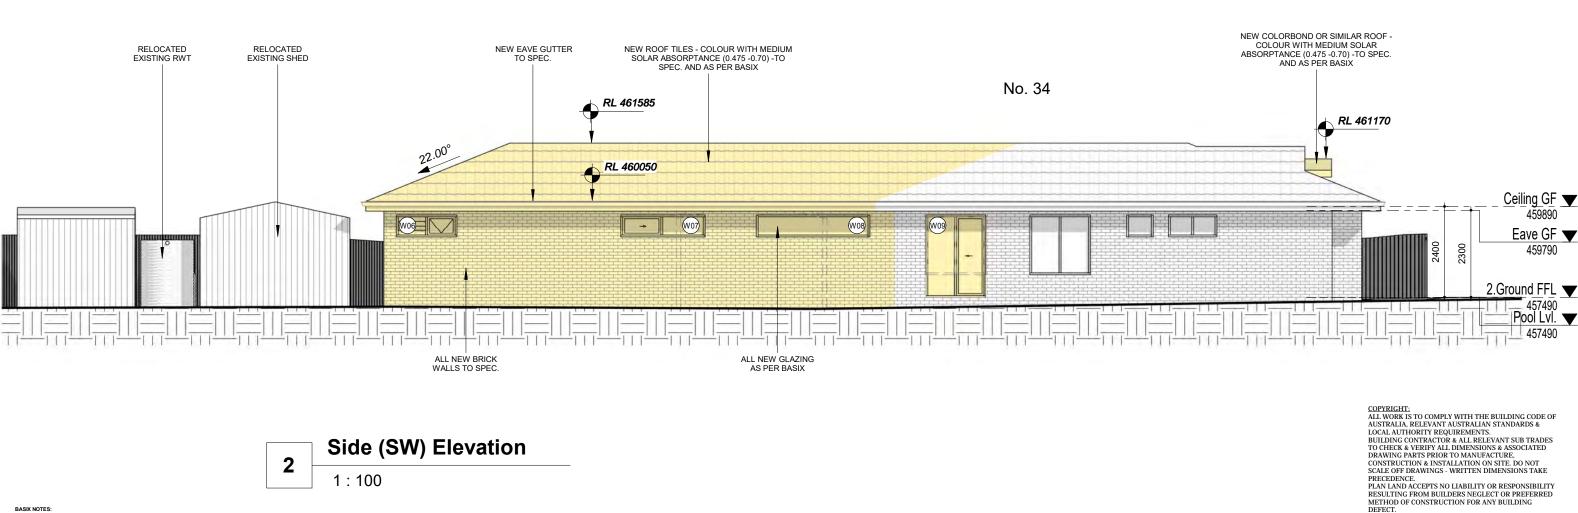




BASIX NOTES:

The applicant must install a rainwater tank of at least 2734 litres on the site. This rainwater tank must meet, and be installed in accordance with, the requirements applicable regulatory authorities or glazad door above which they are situated, un the pergola also shades a perpendicular window. The spacing between batters he more than 50 mm.

be more than 50 mm. The swimming pool must be outdoors. The swimming pool must not have a capacity greater than 51 kiloitres. The applicant must construct the new or altered construction (floor(s), wals, and cellingsfrords) in accordance with the specifications listed in the table below, except that a) additional insulation is not required where the area of new construction is less than 2, b) insulation specified is not required for parts of altered construction in where insulation altered exists. The applicant must instal the windows, glazed doors and shading devices, in accordance with the specifications listed in the table below. Relevant overshadowing specifications must be satisfied for each window and glazed door.

door. For projections described in millimetres, the leading edge of each eave, pergola, verandah, balcony or awning must be no more than 500 mm above the head of the window or glazed door and no more than 2400 mm above the sill.

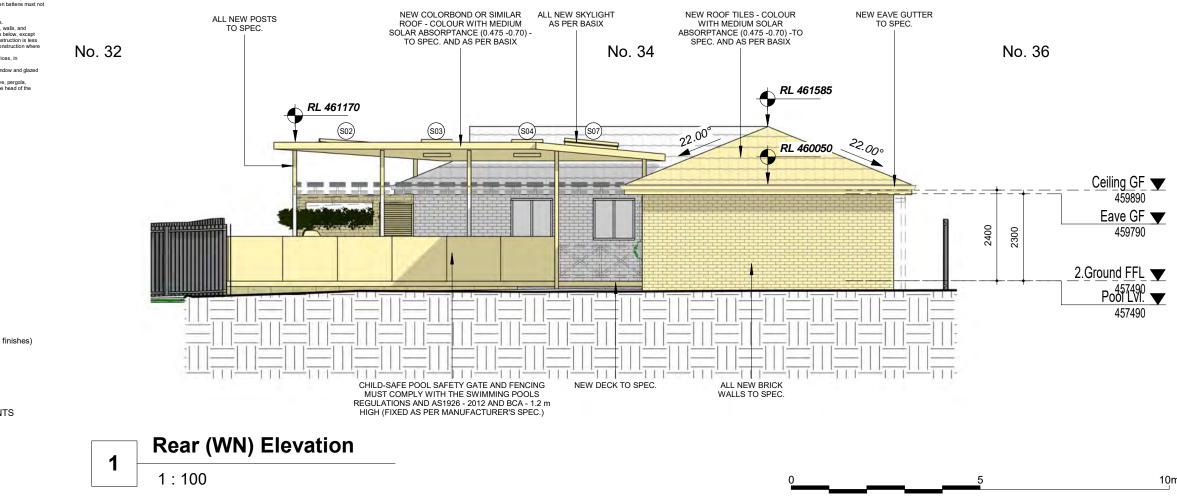

PHASING LEGEND:

ding elements, not finishes) (Note: legend ap



EXISTING ELEMENTS DEMOLISHED ELEMENTS



DEFECT. THESE DRAWINGS ARE THE PROPERTY OF PLAN LAND.

DRAWINGS ARE NOT TO BE REPRODUCED IN PART OR IN WHOLE ON ANY MEDIUM WITHOUT THE WRITTEN PERMISSION OF PLAN LAND.

NOTE: ALL EXISTING & OVERALL DIMENSIONS ARE NOMINAL & SUBJECT TO VERIFICATION ON SITE. WHERE ANY DISCREPANCY OCCURS BETWEEN NEW WORK & EXISTING BETWEEN NEW WORK & EXISTING DIMENSIONS - EXISTING DIMENSIONS/WORK SHOULD TAKE PREPERENCE WHERE NECESSARY - OTHERWISE NOTE: NOTE:

NOTE: SELECTED TERMITE PROTECTION TO BE USED ON SITE IN ACCORDANCE WITH LOCAL COUNCIL'S REQUIREMENTS, B.C.A. AND ALL RELEVANT

AUSTRALIAN STANDARDS

NOTE: SMOKE DETECTORS TO COMPLY WITH REQUIREMENTS SMORE DETECTORS TO COMPLY WITH REQUIREMENTS OF SPECIFICATION EL7 (NSW) FIRE AND SMOKE ALARMS SHALL COMPLY WITH AS 3786 AND BE CONNECTED TO THE MAIN POWER SUPPLY.

INCLUSE STATES IN ACCORDANCE WITH CLAUSE 3.7.5.2 OF THE NCC.


NOTE: STAIRWAY TO HAVE A NON-SLIP FINISH OR NOSING STRIP IN ACCORDANCE WITH CLAUSE 3.9.1.4 AND TABLE 3.9.1.3 OF THE NCC.

NOTE: METHOD OF VENTILATING THE LAUNDRY AND WC AND CONTROLLING CONDENSATION IN ACCORDANCE WITH CLAUSES 3.8.5.2 & 3.8.7.3 OF THE NCC.


34 Lang Street, Mudgee NSW 2850

Drawing: Elevations

| 1:100@A3 | 22113 D | DA 3.2 |
|-----------------|------------------|----------------|
| Scale: | Drawing No.: Sh | |
| LT | LT | OCT/2022 |
| Drawn: | Approved: | Date: |
| Email: info@ | planland.com.au | |
| Phone: 0403 | 993 876 | |
| PO BOX 495 G | /mea NSW | |
| trading as pla | ın land | 62 128 716 334 |
| newton teale co | nsulting pty ltd | ABN: |

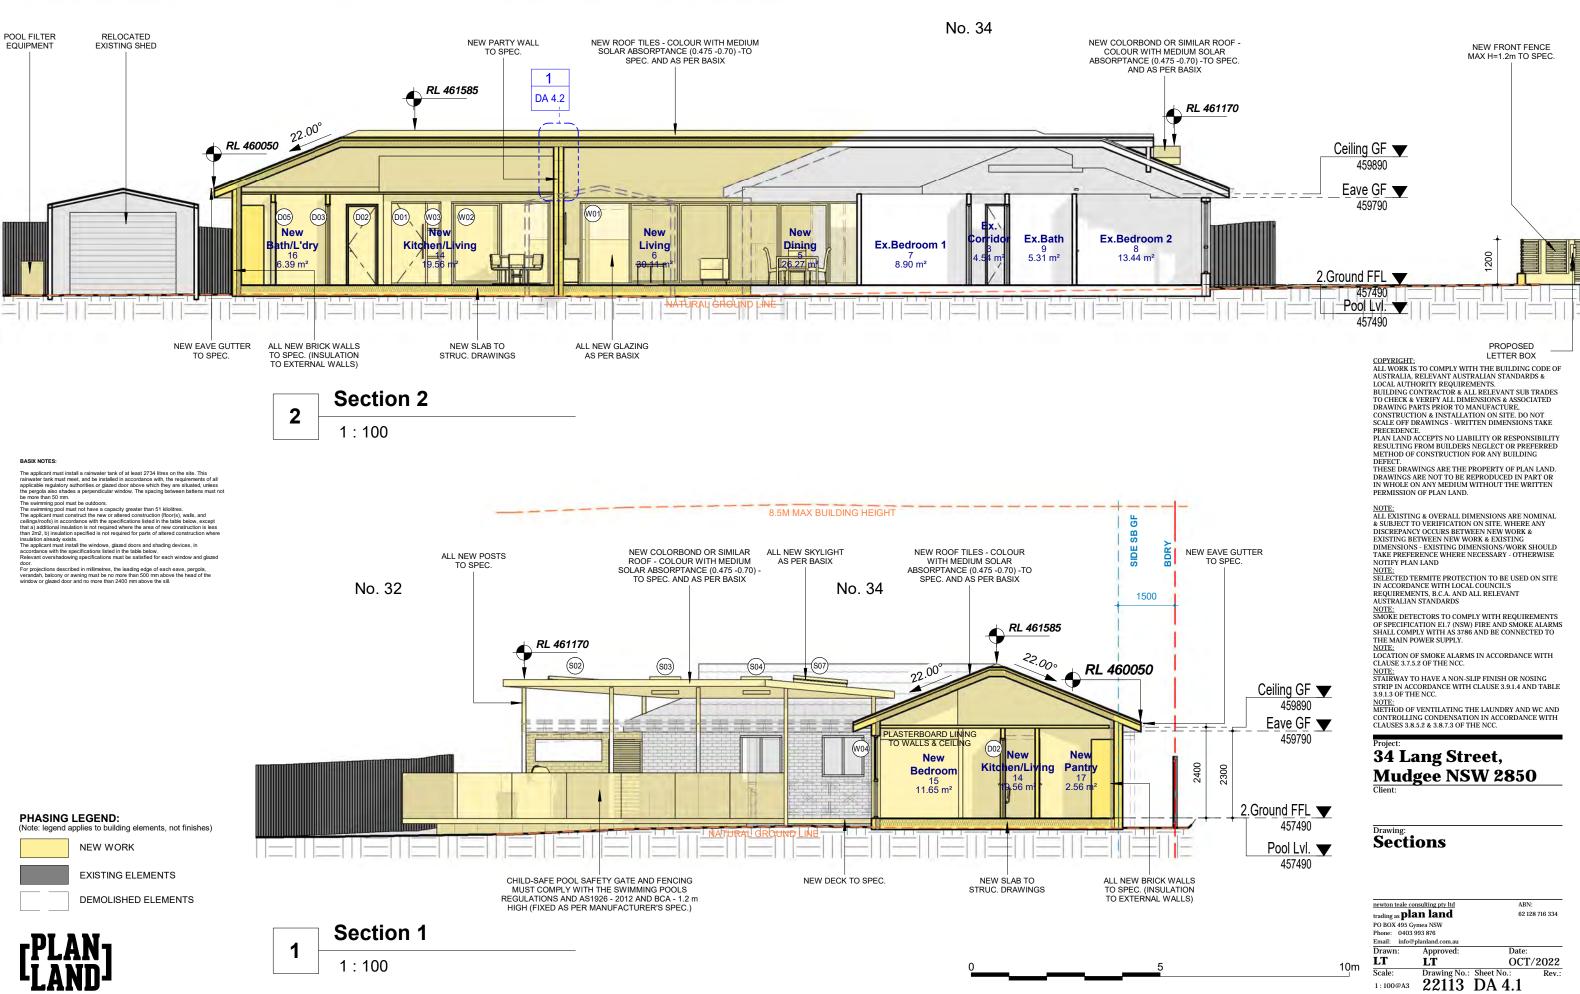


8.5M MAX BUILDING HEIGHT

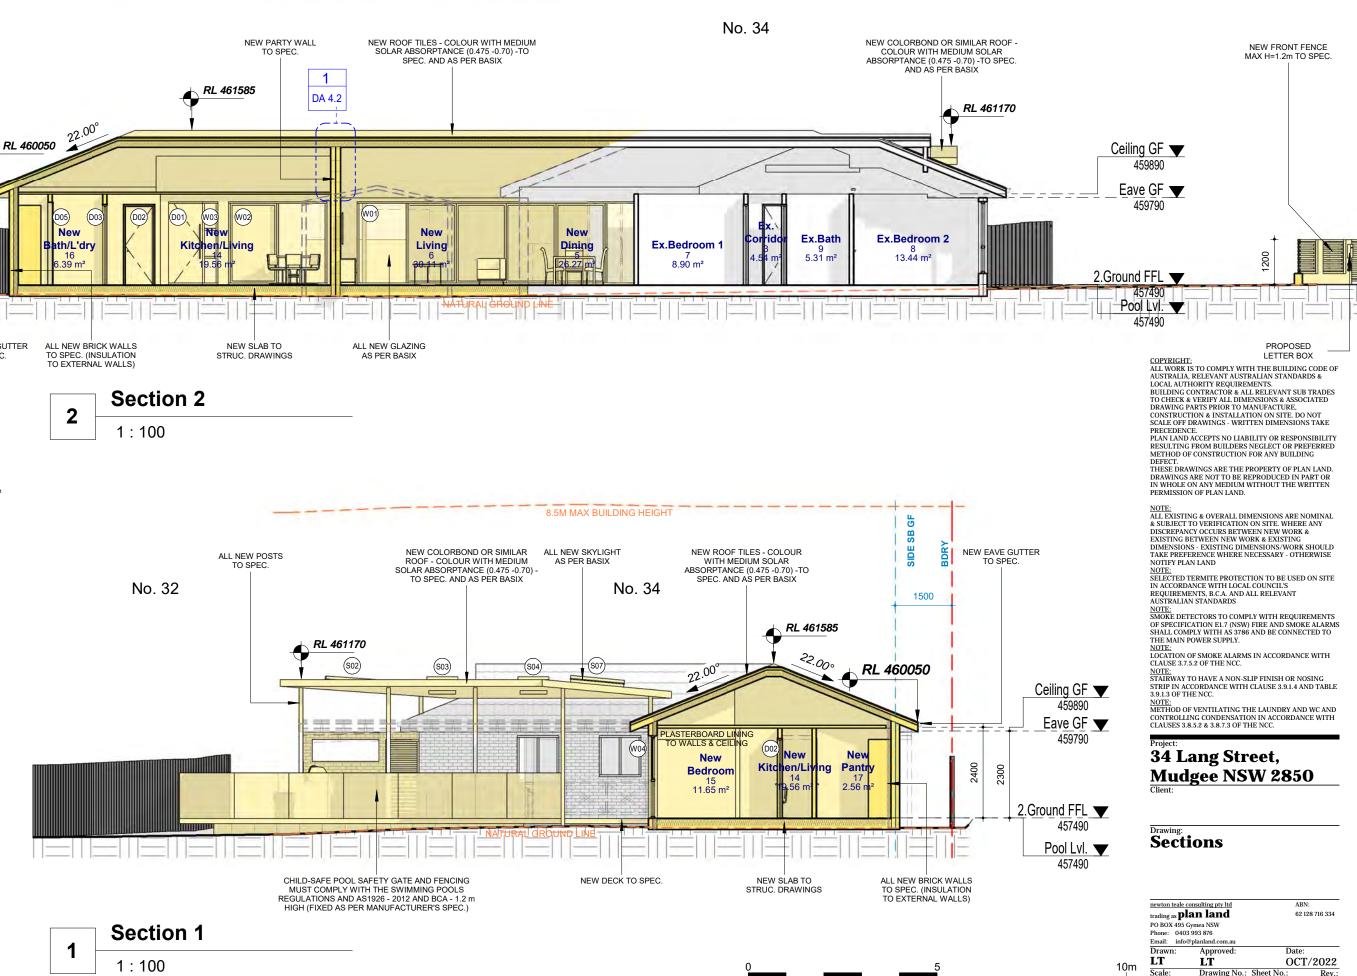





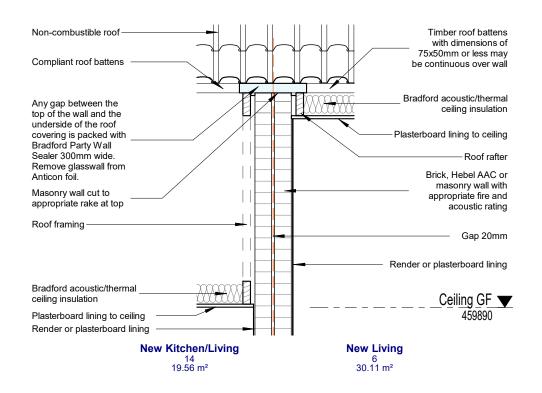



BASK NOTES: The spacicant must install rainwater tank of at least 2734 litres on the site. This rainwater tank must meet, and be installed in accordance with, the requirements of all the pergola also shades on these or global door above which they are suitated, unless the pergola also shades on the original door above which they are suitated, unless the pergola also shades on the original door above which they are suitated, unless the most than 50 mm. The swimming pool must be outdoors. The swimming pool must be have a capacity greater than 51 kiloittes. The splicant must construct the new or altered construction (floor(s), walls, and ceilings/roof(s) in accordance with the specifications listed in that table below, except that a) additional installation is not required where the area of new construction is less the analycent must install the windows, glazed doors and shading devices, in accordance with the specifications itsed in the table below. Relevant overshadowing specifications must be satisfied for each window and glazed door. For projections described in millimetres, the leading edge of each eave, pergola, verandh, balcory or awing must be normed than 500 mm above the all.

COPYRIGHT: ALL WORK IS TO COMPLY WITH THE BUILDING CODE OF AUSTRALIA, RELEVANT AUSTRALIAN STANDARDS &

AUSTRALIA, RELEVANT AUSTRALIAN STANDARDS & LOCAL AUTHORITY REQUIREMENTS. BUILDING CONTRACTOR & ALL RELEVANT SUB TRADES TO CHECK & VERIFY ALL DIMENSIONS & ASSOCIATED DRAWING PARTS PRIOR TO MANUFACTURE. CONSTRUCTION & INSTALLATION ON SITE. DO NOT SCALE OF DRAWINGS - WRITTEN DIMENSIONS TAKE PRECEDENCE. PLAN LAND ACCEPTS NO LIABILITY OR RESPONSIBILITY RESULTING FROM BUILDERS NEGLECT OR PREFERRED METHOD OF CONSTRUCTION FOR ANY BUILDING DEFECT.

DEFECT. THESE DRAWINGS ARE THE PROPERTY OF PLAN LAND.

DRAWINGS ARE NOT TO BE REPRODUCED IN PART OR IN WHOLE ON ANY MEDIUM WITHOUT THE WRITTEN PERMISSION OF PLAN LAND.

NOTE: ALL EXISTING & OVERALL DIMENSIONS ARE NOMINAL & SUBJECT TO VERIFICATION ON SITE. WHERE ANY DISCREPANCY OCCURS BETWEEN NEW WORK & EXISTING BETWEEN NEW WORK & EXISTING DIMENSIONS - EXISTING DIMENSIONS/WORK SHOULD TAKE PREPRENCE WHERE NECESSARY - OTHERWISE NOTE:

NOTE: SELECTED TERMITE PROTECTION TO BE USED ON SITE IN ACCORDANCE WITH LOCAL COUNCIL'S REQUIREMENTS, B.C.A. AND ALL RELEVANT AUSTRALIAN STANDARDS

NOTE: SMOKE DETECTORS TO COMPLY WITH REQUIREMENTS SMORE DETECTORS TO COMPLY WITH REQUIREMENTS OF SPECIFICATION EL7 (NSW) FIRE AND SMOKE ALARMS SHALL COMPLY WITH AS 3786 AND BE CONNECTED TO THE MAIN POWER SUPPLY.

INCLUSE STATES IN ACCORDANCE WITH CLAUSE 3.7.5.2 OF THE NCC.

NOTE: STAIRWAY TO HAVE A NON-SLIP FINISH OR NOSING STRIP IN ACCORDANCE WITH CLAUSE 3.9.1.4 AND TABLE 3.9.1.3 OF THE NCC.


NOTE: METHOD OF VENTILATING THE LAUNDRY AND WC AND CONTROLLING CONDENSATION IN ACCORDANCE WITH CLAUSES 3.8.5.2 & 3.8.7.3 OF THE NCC.

Projec

34 Lang Street, Mudgee NSW 2850 Client

Drawing: Detail - Party Wall

| | newton teal | e consulting pty ltd | ABN: |
|--------|-------------|----------------------|------------------|
| | trading as | olan land | 62 128 716 334 |
| | PO BOX 49 | 5 Gymea NSW | |
| | Phone: 04 | 103 993 876 | |
| | Email: in | fo@planland.com.au | |
| | Drawn: | Approved: | Date: |
| 2.5 m | LT | LT | OCT/2022 |
| 2.5 11 | Scale: | Drawing No.: | Sheet No.: Rev.: |
| | 1:25@A3 | 22113 | DA 4 2 |

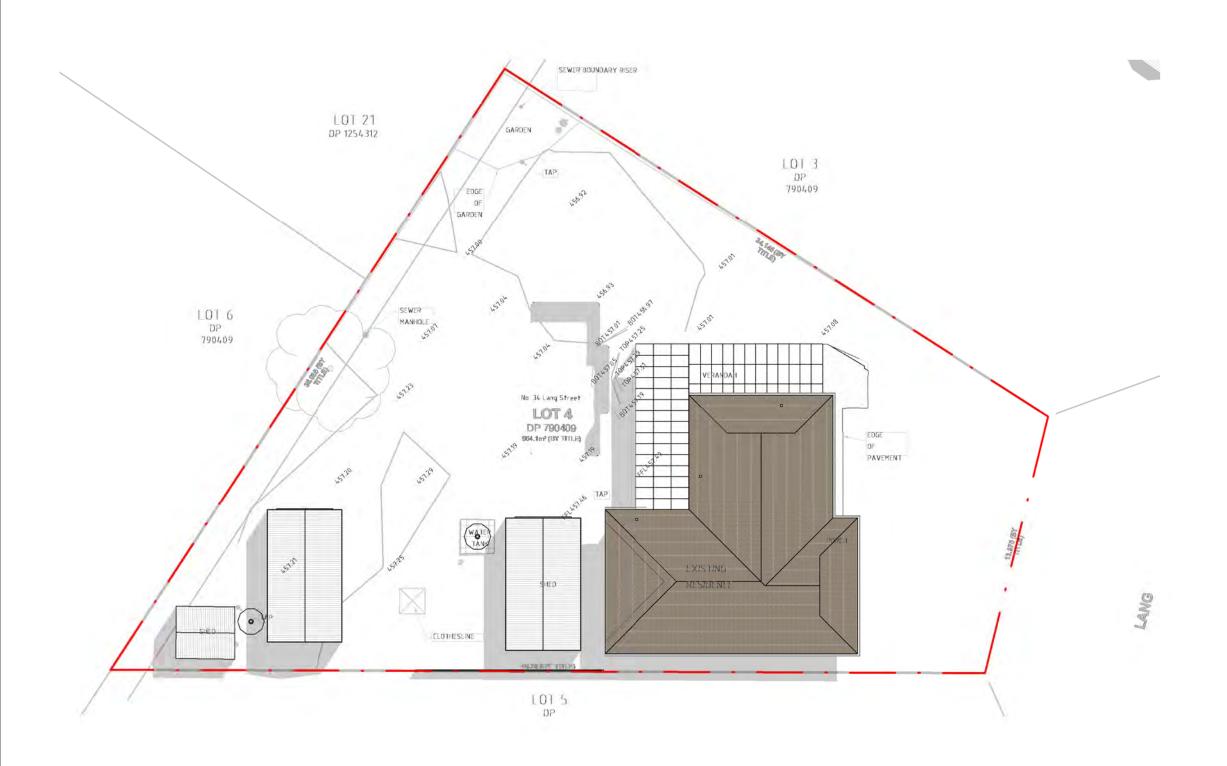





NOTE: ALL EXISTING & OVERALL DIMENSIONS ARE NOMINAL & SUBJECT TO VERIFICATION ON SITE. WHERE ANY DISCREPANCY OCCURS BETWEEN NEW WORK & EXISTING BETWEEN NEW WORK & EXISTING DIMENSIONS - EXISTING DIMENSIONS/WORK SHOULD TAKE PREFERENCE WHERE NECESSARY - OTHERWISE NOTIFY PLAN LAND NOTE:

NOTE: SELECTED TERMITE PROTECTION TO BE USED ON SITE IN ACCORDANCE WITH LOCAL COUNCIL'S REQUIREMENTS, B.C.A. AND ALL RELEVANT AUSTRALIAN STANDARDS

AUSTRALIAN STANDARDS <u>NOTE:</u> SMOKE DETECTORS TO COMPLY WITH REQUIREMENTS OF SPECIFICATION EL7 (NSW) FIRE AND SMOKE ALARMS SHALL COMPLY WITH AS 3786 AND BE CONNECTED TO THE MAIN POWER SUPPLY. <u>NOTE:</u> LOCATION OF SMOKE ALARMS IN ACCORDANCE WITH CLAUSE 3.7.5.2 OF THE NCC. NOTE:

NOTE: STAIRWAY TO HAVE A NON-SLIP FINISH OR NOSING STRIP IN ACCORDANCE WITH CLAUSE 3.9.1.4 AND TABLE 3.9.1.3 OF THE NCC.

NOTE: METHOD OF VENTILATING THE LAUNDRY AND WC AND CONTROLLING CONDENSATION IN ACCORDANCE WITH CLAUSES 3.8.5.2 & 3.8.7.3 OF THE NCC.

Project


34 Lang Street, Mudgee NSW 2850

Client

Drawing: Shadow Diagram (Existing)

| newton teale c | onsulting pty ltd | ABN: | |
|----------------------|-------------------|--------------|------|
| trading as pl | an land | 62 128 716 3 | |
| PO BOX 495 C | ymea NSW | | |
| Phone: 0403 | 993 876 | | |
| Email: info@ | planland.com.au | | |
| Drawn: | Approved: | Date: | |
| LT | LT | OCT | /202 |
| Scale: | Drawing No.: | Sheet No.: | Rev |
| 1:200@A3 | 22113 | DA 51 | |

20 ו

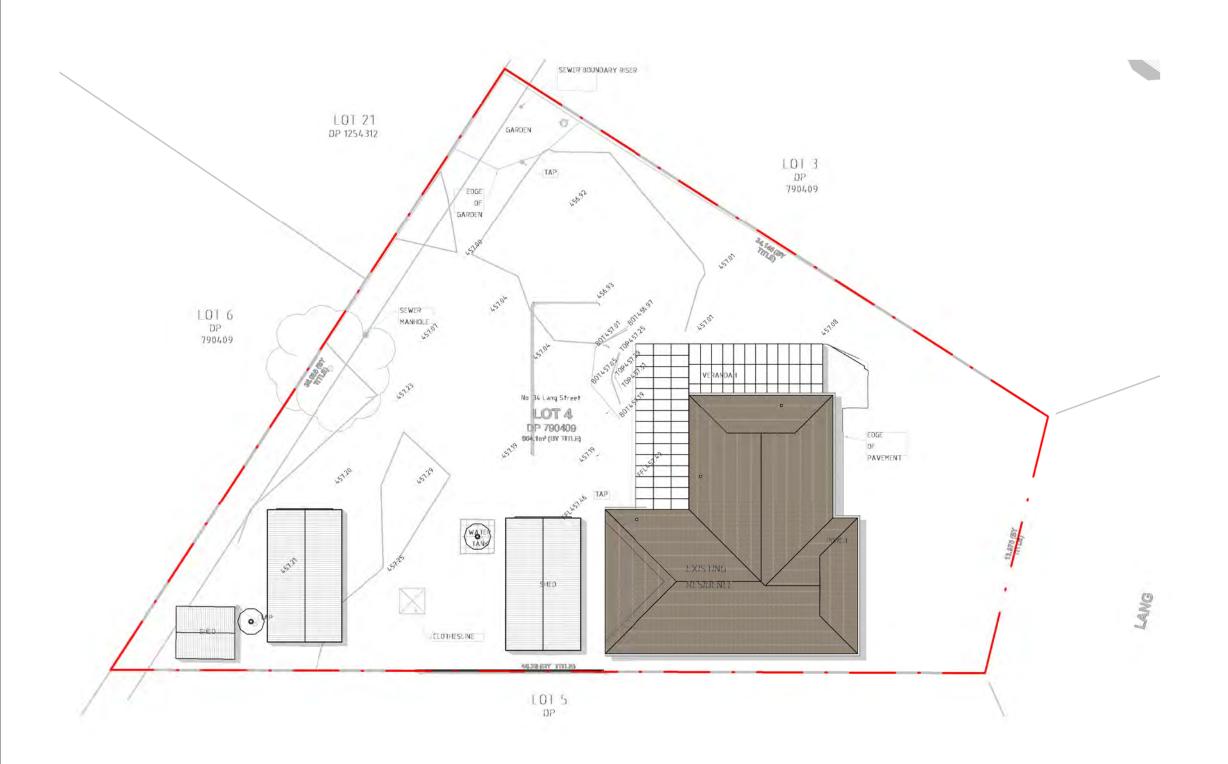





NOTE: ALL EXISTING & OVERALL DIMENSIONS ARE NOMINAL & SUBJECT TO VERIFICATION ON SITE. WHERE ANY DISCREPANCY OCCURS BETWEEN NEW WORK & EXISTING BETWEEN NEW WORK & EXISTING DIMENSIONS - EXISTING DIMENSIONS/WORK SHOULD TAKE PREFERENCE WHERE NECESSARY - OTHERWISE NOTIFY PLAN LAND NOTE:

NOTE: SELECTED TERMITE PROTECTION TO BE USED ON SITE IN ACCORDANCE WITH LOCAL COUNCIL'S REQUIREMENTS, B.C.A. AND ALL RELEVANT AUSTRALIAN STANDARDS

AUSTRALIAN STANDARDS <u>NOTE:</u> SMOKE DETECTORS TO COMPLY WITH REQUIREMENTS OF SPECIFICATION EL7 (NSW) FIRE AND SMOKE ALARMS SHALL COMPLY WITH AS 3786 AND BE CONNECTED TO THE MAIN POWER SUPPLY. <u>NOTE:</u> LOCATION OF SMOKE ALARMS IN ACCORDANCE WITH CLAUSE 3.7.5.2 OF THE NCC. NOTE:

NOTE: STAIRWAY TO HAVE A NON-SLIP FINISH OR NOSING STRIP IN ACCORDANCE WITH CLAUSE 3.9.1.4 AND TABLE 3.9.1.3 OF THE NCC.

NOTE: METHOD OF VENTILATING THE LAUNDRY AND WC AND CONTROLLING CONDENSATION IN ACCORDANCE WITH CLAUSES 3.8.5.2 & 3.8.7.3 OF THE NCC.

Project


34 Lang Street, Mudgee NSW 2850

Client

Drawing: Shadow Diagram (Existing)

| newton teale c | onsulting pty ltd | ABN: | |
|----------------------|-------------------|--------------|------------|
| trading as pl | an land | 62 12 | 28 716 334 |
| PO BOX 495 C | ymea NSW | | |
| Phone: 0403 | 993 876 | | |
| Email: info@ | planland.com.au | | |
| Drawn: | Approved: | Date: | |
| LT | LT | OCT | /202 |
| Scale: | Drawing No.: | Sheet No.: | Rev |
| 1:200@A3 | 22113 | $D\Delta 52$ | |

20 ו

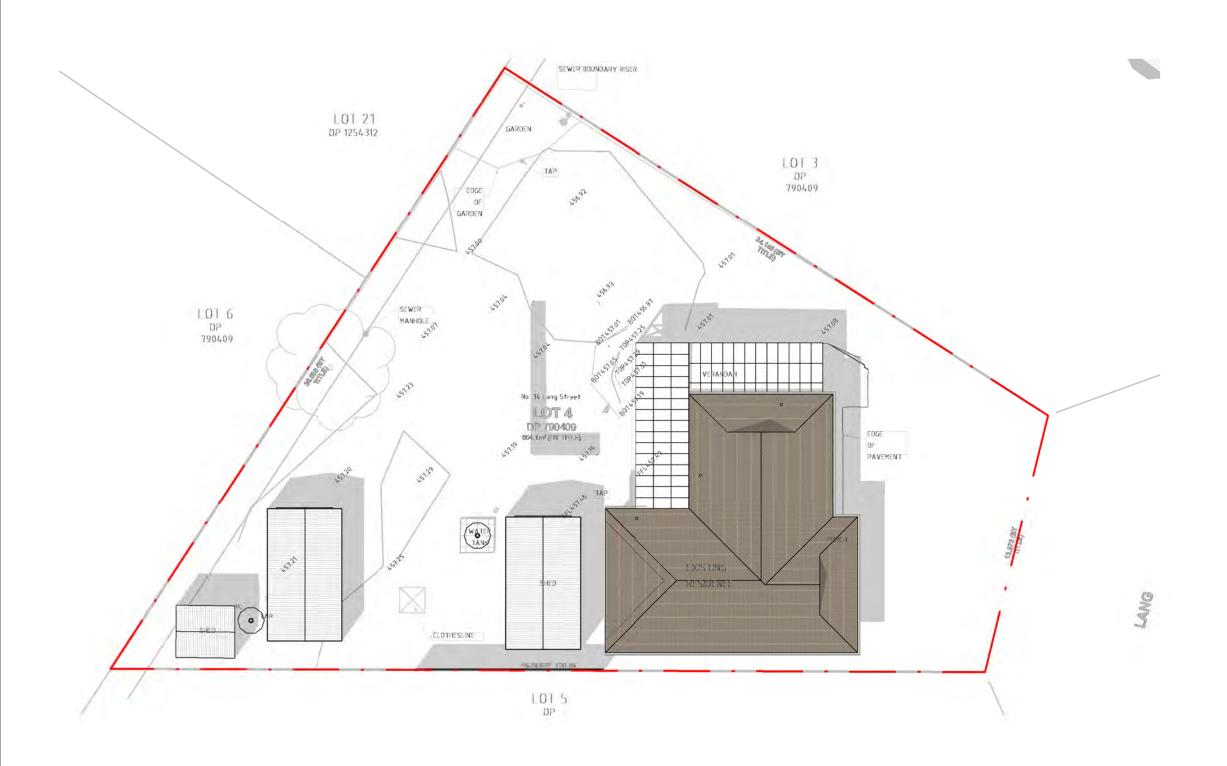





NOTE: ALL EXISTING & OVERALL DIMENSIONS ARE NOMINAL & SUBJECT TO VERIFICATION ON SITE. WHERE ANY DISCREPANCY OCCURS BETWEEN NEW WORK & EXISTING BETWEEN NEW WORK & EXISTING DIMENSIONS - EXISTING DIMENSIONS/WORK SHOULD TAKE PREFERENCE WHERE NECESSARY - OTHERWISE NOTIFY PLAN LAND NOTE:

NOTE: SELECTED TERMITE PROTECTION TO BE USED ON SITE IN ACCORDANCE WITH LOCAL COUNCIL'S REQUIREMENTS, B.C.A. AND ALL RELEVANT AUSTRALIAN STANDARDS

AUSTRALIAN STANDARDS <u>NOTE:</u> SMOKE DETECTORS TO COMPLY WITH REQUIREMENTS OF SPECIFICATION EL7 (NSW) FIRE AND SMOKE ALARMS SHALL COMPLY WITH AS 3786 AND BE CONNECTED TO THE MAIN POWER SUPPLY. <u>NOTE:</u> LOCATION OF SMOKE ALARMS IN ACCORDANCE WITH CLAUSE 3.7.5.2 OF THE NCC. NOTE:

NOTE: STAIRWAY TO HAVE A NON-SLIP FINISH OR NOSING STRIP IN ACCORDANCE WITH CLAUSE 3.9.1.4 AND TABLE 3.9.1.3 OF THE NCC.

NOTE: METHOD OF VENTILATING THE LAUNDRY AND WC AND CONTROLLING CONDENSATION IN ACCORDANCE WITH CLAUSES 3.8.5.2 & 3.8.7.3 OF THE NCC.


Project

34 Lang Street, Mudgee NSW 2850 Client

Drawing: Shadow Diagram (Existing)

| newton teale c | onsulting pty ltd | ABN: | |
|----------------------|-------------------|--------------|------|
| trading as pl | an land | 62 128 716 3 | |
| PO BOX 495 C | ymea NSW | | |
| Phone: 0403 | 993 876 | | |
| Email: info@ | planland.com.au | | |
| Drawn: | Approved: | Date: | |
| LT | LT | OCT | /202 |
| Scale: | Drawing No.: | Sheet No.: | Rev |
| 1:200@A3 | 22113 | DA 53 | |

20 ו

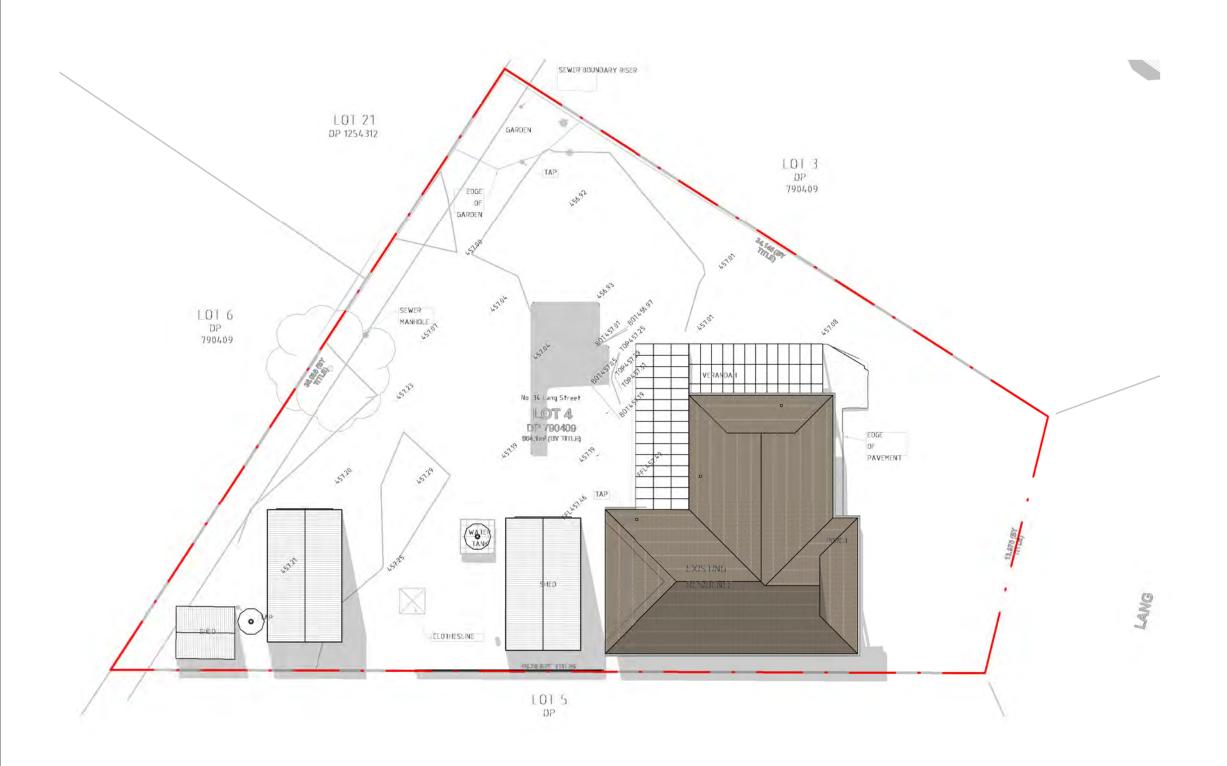





NOTE: ALL EXISTING & OVERALL DIMENSIONS ARE NOMINAL & SUBJECT TO VERIFICATION ON SITE. WHERE ANY DISCREPANCY OCCURS BETWEEN NEW WORK & EXISTING BETWEEN NEW WORK & EXISTING DIMENSIONS - EXISTING DIMENSIONS/WORK SHOULD TAKE PREFERENCE WHERE NECESSARY - OTHERWISE NOTIFY PLAN LAND NOTE:

NOTE: SELECTED TERMITE PROTECTION TO BE USED ON SITE IN ACCORDANCE WITH LOCAL COUNCIL'S REQUIREMENTS, B.C.A. AND ALL RELEVANT AUSTRALIAN STANDARDS

AUSTRALIAN STANDARDS <u>NOTE:</u> SMOKE DETECTORS TO COMPLY WITH REQUIREMENTS OF SPECIFICATION EL7 (NSW) FIRE AND SMOKE ALARMS SHALL COMPLY WITH AS 3786 AND BE CONNECTED TO THE MAIN POWER SUPPLY. <u>NOTE:</u> LOCATION OF SMOKE ALARMS IN ACCORDANCE WITH CLAUSE 3.7.5.2 OF THE NCC. NOTE:

NOTE: STAIRWAY TO HAVE A NON-SLIP FINISH OR NOSING STRIP IN ACCORDANCE WITH CLAUSE 3.9.1.4 AND TABLE 3.9.1.3 OF THE NCC.

NOTE: METHOD OF VENTILATING THE LAUNDRY AND WC AND CONTROLLING CONDENSATION IN ACCORDANCE WITH CLAUSES 3.8.5.2 & 3.8.7.3 OF THE NCC.

Project


34 Lang Street, Mudgee NSW 2850

Client

Drawing: Shadow Diagram (Existing)

| newton teale c | onsulting pty ltd | ABN: | |
|----------------------|-------------------|--------------|------|
| trading as pl | an land | 62 128 716 3 | |
| PO BOX 495 C | ymea NSW | | |
| Phone: 0403 | 993 876 | | |
| Email: info@ | planland.com.au | | |
| Drawn: | Approved: | Date: | |
| LT | LT | OCT | /202 |
| Scale: | Drawing No.: | Sheet No.: | Rev |
| 1:200@A3 | 22113 | DA 54 | |

20 ו

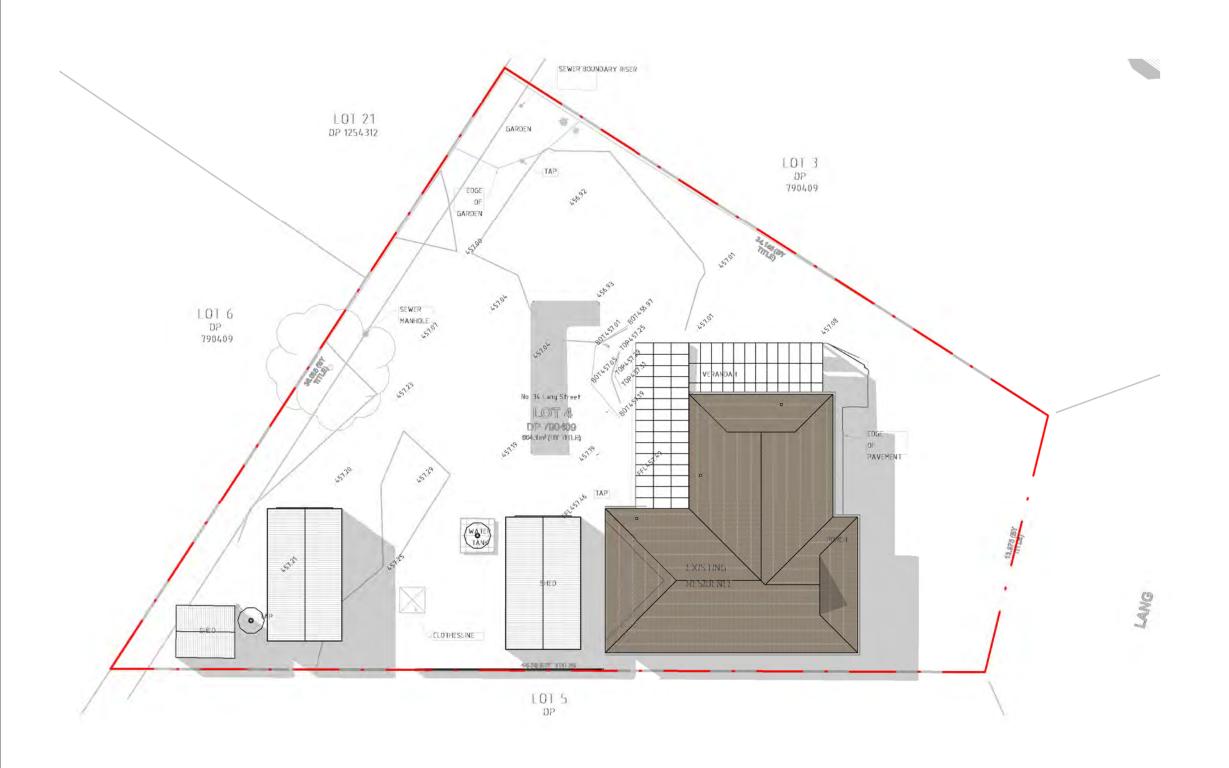



NOTE: ALL EXISTING & OVERALL DIMENSIONS ARE NOMINAL & SUBJECT TO VERIFICATION ON SITE. WHERE ANY DISCREPANCY OCCURS BETWEEN NEW WORK & EXISTING BETWEEN NEW WORK & EXISTING DIMENSIONS - EXISTING DIMENSIONS/WORK SHOULD TAKE PREFERENCE WHERE NECESSARY - OTHERWISE NOTIFY PLAN LAND NOTE:

NOTE: SELECTED TERMITE PROTECTION TO BE USED ON SITE IN ACCORDANCE WITH LOCAL COUNCIL'S REQUIREMENTS, B.C.A. AND ALL RELEVANT AUSTRALIAN STANDARDS

AUSTRALIAN STANDARDS <u>NOTE:</u> SMOKE DETECTORS TO COMPLY WITH REQUIREMENTS OF SPECIFICATION EL7 (NSW) FIRE AND SMOKE ALARMS SHALL COMPLY WITH AS 3786 AND BE CONNECTED TO THE MAIN POWER SUPPLY. <u>NOTE:</u> LOCATION OF SMOKE ALARMS IN ACCORDANCE WITH CLAUSE 3.7.5.2 OF THE NCC. NOTE:

NOTE: STAIRWAY TO HAVE A NON-SLIP FINISH OR NOSING STRIP IN ACCORDANCE WITH CLAUSE 3.9.1.4 AND TABLE 3.9.1.3 OF THE NCC.

NOTE: METHOD OF VENTILATING THE LAUNDRY AND WC AND CONTROLLING CONDENSATION IN ACCORDANCE WITH CLAUSES 3.8.5.2 & 3.8.7.3 OF THE NCC.


Project

34 Lang Street, Mudgee NSW 2850 Client

Drawing: Shadow Diagram (Existing)

| newton teale c | onsulting pty ltd | ABN: |
|----------------------|-------------------|------------------|
| trading as pl | an land | 62 128 716 334 |
| PO BOX 495 C | | |
| Phone: 0403 | 993 876 | |
| Email: info@ | planland.com.au | |
| Drawn: | Approved: | Date: |
| LT | LT | OCT/2022 |
| Scale: | Drawing No.: S | Sheet No.: Rev.: |
| 1:200@A3 | 22113 I | DA55 |

20 ו

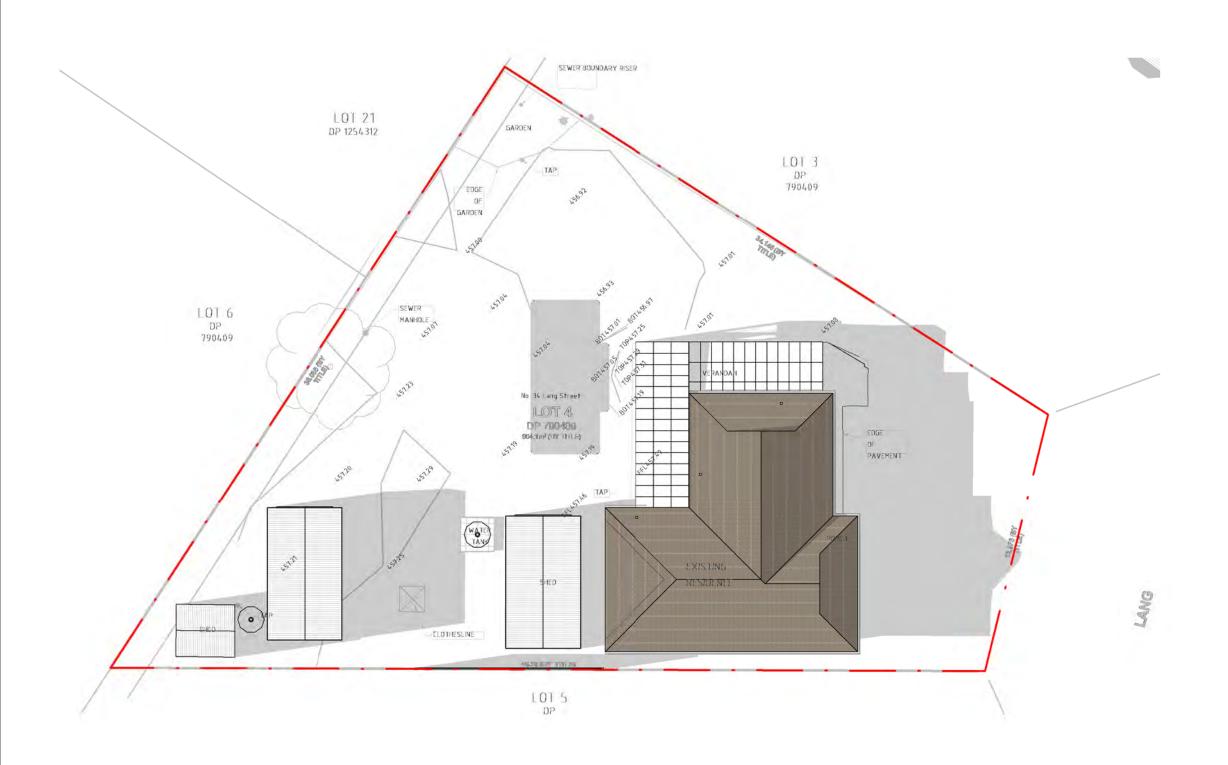



NOTE: ALL EXISTING & OVERALL DIMENSIONS ARE NOMINAL & SUBJECT TO VERIFICATION ON SITE. WHERE ANY DISCREPANCY OCCURS BETWEEN NEW WORK & EXISTING BETWEEN NEW WORK & EXISTING DIMENSIONS - EXISTING DIMENSIONS/WORK SHOULD TAKE PREFERENCE WHERE NECESSARY - OTHERWISE NOTIFY PLAN LAND NOTE:

NOTE: SELECTED TERMITE PROTECTION TO BE USED ON SITE IN ACCORDANCE WITH LOCAL COUNCIL'S REQUIREMENTS, B.C.A. AND ALL RELEVANT AUSTRALIAN STANDARDS

AUSTRALIAN STANDARDS <u>NOTE:</u> SMOKE DETECTORS TO COMPLY WITH REQUIREMENTS OF SPECIFICATION EL7 (NSW) FIRE AND SMOKE ALARMS SHALL COMPLY WITH AS 3786 AND BE CONNECTED TO THE MAIN POWER SUPPLY. <u>NOTE:</u> LOCATION OF SMOKE ALARMS IN ACCORDANCE WITH CLAUSE 3.7.5.2 OF THE NCC. NOTE:

NOTE: STAIRWAY TO HAVE A NON-SLIP FINISH OR NOSING STRIP IN ACCORDANCE WITH CLAUSE 3.9.1.4 AND TABLE 3.9.1.3 OF THE NCC.

NOTE: METHOD OF VENTILATING THE LAUNDRY AND WC AND CONTROLLING CONDENSATION IN ACCORDANCE WITH CLAUSES 3.8.5.2 & 3.8.7.3 OF THE NCC.


Project 34 Lang Street, Mudgee NSW 2850

Client

Drawing: Shadow Diagram (Existing)

| newton teale c | onsulting pty ltd | ABN | : |
|----------------------|-------------------|------------|------------|
| trading as pl | an land | 62 1 | 28 716 334 |
| PO BOX 495 C | ymea NSW | | |
| Phone: 0403 | 993 876 | | |
| Email: info@ | planland.com.au | | |
| Drawn: | Approved: | Date: | |
| LT | LT | OCT | /202 |
| Scale: | Drawing No.: | Sheet No.: | Rev |
| 1:200@A3 | 22112 | DA 5 6 | |

20 ו

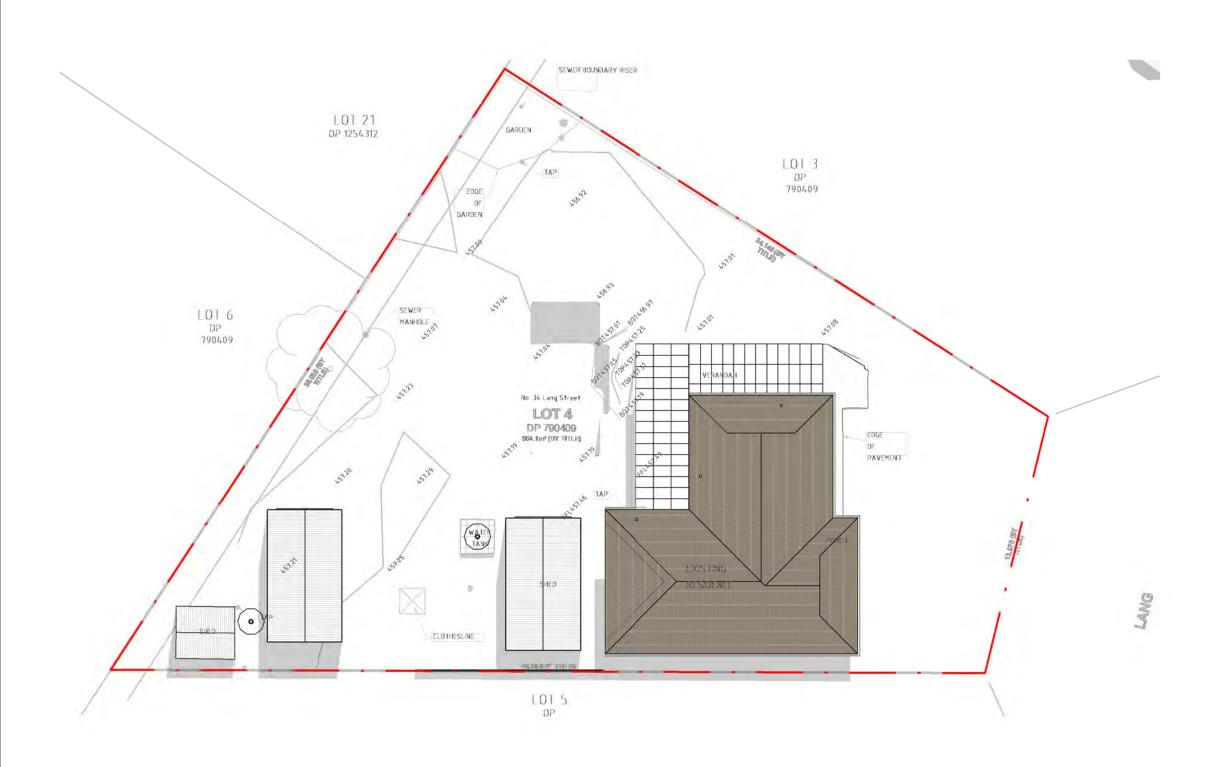





NOTE: ALL EXISTING & OVERALL DIMENSIONS ARE NOMINAL & SUBJECT TO VERIFICATION ON SITE. WHERE ANY DISCREPANCY OCCURS BETWEEN NEW WORK & EXISTING BETWEEN NEW WORK & EXISTING DIMENSIONS - EXISTING DIMENSIONS/WORK SHOULD TAKE PREFERENCE WHERE NECESSARY - OTHERWISE NOTIFY PLAN LAND NOTE:

NOTE: SELECTED TERMITE PROTECTION TO BE USED ON SITE IN ACCORDANCE WITH LOCAL COUNCIL'S REQUIREMENTS, B.C.A. AND ALL RELEVANT AUSTRALIAN STANDARDS

AUSTRALIAN STANDARDS <u>NOTE:</u> SMOKE DETECTORS TO COMPLY WITH REQUIREMENTS OF SPECIFICATION EL7 (NSW) FIRE AND SMOKE ALARMS SHALL COMPLY WITH AS 3786 AND BE CONNECTED TO THE MAIN POWER SUPPLY. <u>NOTE:</u> LOCATION OF SMOKE ALARMS IN ACCORDANCE WITH CLAUSE 3.7.5.2 OF THE NCC. NOTE:

NOTE: STAIRWAY TO HAVE A NON-SLIP FINISH OR NOSING STRIP IN ACCORDANCE WITH CLAUSE 3.9.1.4 AND TABLE 3.9.1.3 OF THE NCC.

NOTE: METHOD OF VENTILATING THE LAUNDRY AND WC AND CONTROLLING CONDENSATION IN ACCORDANCE WITH CLAUSES 3.8.5.2 & 3.8.7.3 OF THE NCC.

Project


34 Lang Street, Mudgee NSW 2850

Client

Drawing: Shadow Diagram (Existing)

| | 1:200@A3 | 22113 | DA 5.7 | |
|---|-----------------------|-----------------|--------|-----------|
| | Scale: | Drawing No.: | | Rev.: |
| n | LT | LT | OCT/ | 2022 |
| | Drawn: | Approved: | Date: | |
| | Email: info@ | olanland.com.au | | |
| | Phone: 0403 | 93 876 | | |
| | PO BOX 495 Gy | mea NSW | | |
| | trading as pla | n land | 62 128 | 8 716 334 |
| | newton teale co | | ABN: | |

20 ו

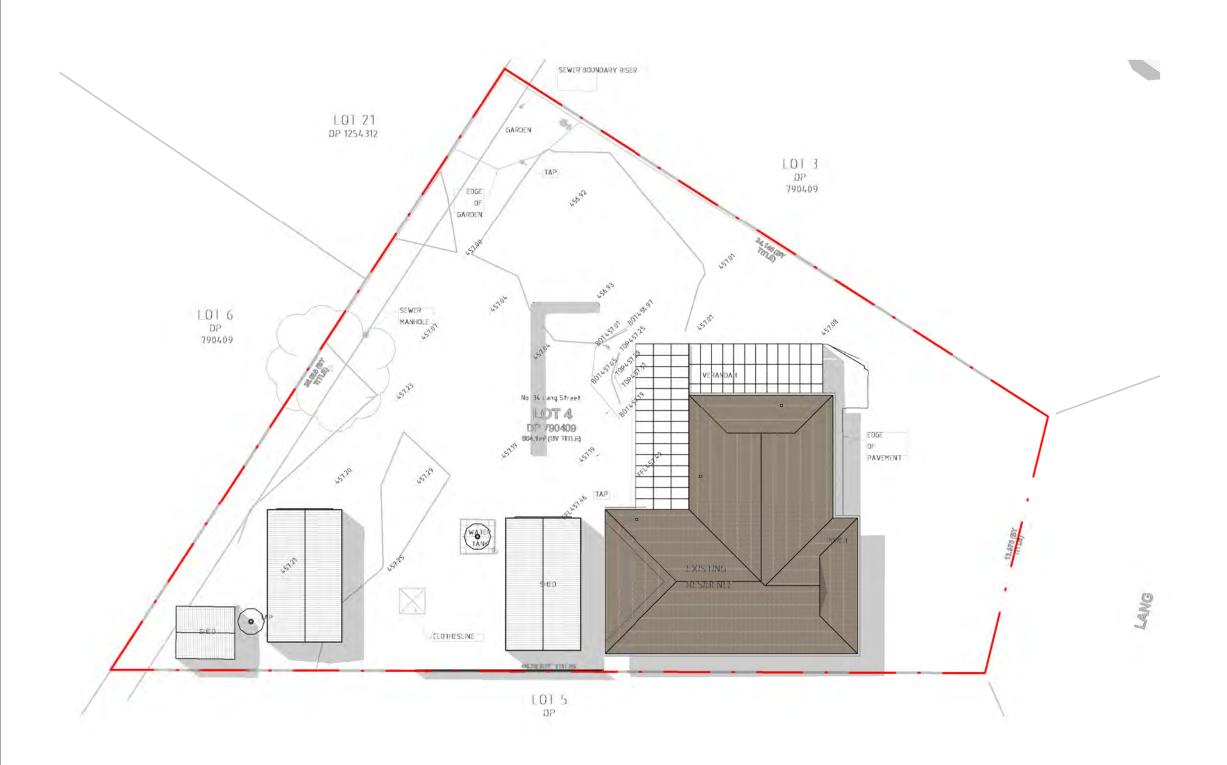





NOTE: ALL EXISTING & OVERALL DIMENSIONS ARE NOMINAL & SUBJECT TO VERIFICATION ON SITE. WHERE ANY DISCREPANCY OCCURS BETWEEN NEW WORK & EXISTING BETWEEN NEW WORK & EXISTING DIMENSIONS - EXISTING DIMENSIONS/WORK SHOULD TAKE PREFERENCE WHERE NECESSARY - OTHERWISE NOTIFY PLAN LAND NOTE:

NOTE: SELECTED TERMITE PROTECTION TO BE USED ON SITE IN ACCORDANCE WITH LOCAL COUNCIL'S REQUIREMENTS, B.C.A. AND ALL RELEVANT AUSTRALIAN STANDARDS

AUSTRALIAN STANDARDS <u>NOTE:</u> SMOKE DETECTORS TO COMPLY WITH REQUIREMENTS OF SPECIFICATION EL7 (NSW) FIRE AND SMOKE ALARMS SHALL COMPLY WITH AS 3786 AND BE CONNECTED TO THE MAIN POWER SUPPLY. <u>NOTE:</u> LOCATION OF SMOKE ALARMS IN ACCORDANCE WITH CLAUSE 3.7.5.2 OF THE NCC. NOTE:

NOTE: STAIRWAY TO HAVE A NON-SLIP FINISH OR NOSING STRIP IN ACCORDANCE WITH CLAUSE 3.9.1.4 AND TABLE 3.9.1.3 OF THE NCC.

NOTE: METHOD OF VENTILATING THE LAUNDRY AND WC AND CONTROLLING CONDENSATION IN ACCORDANCE WITH CLAUSES 3.8.5.2 & 3.8.7.3 OF THE NCC.


Project 34 Lang Street, Mudgee NSW 2850

Client

Drawing: Shadow Diagram (Existing)

| newton teale | consulting pty ltd | ABN: |
|--------------------|--------------------|----------------|
| trading as ${f p}$ | lan land | 62 128 716 334 |
| PO BOX 495 | Gymea NSW | |
| Phone: 040 | 3 993 876 | |
| Email: info | @planland.com.au | |
| Drawn: | Approved: | Date: |
| LT | LT | OCT/2022 |
| Scale: | Drawing No.: | |
| 1:200@A | ³ 22113 | DA58 |

20 ו

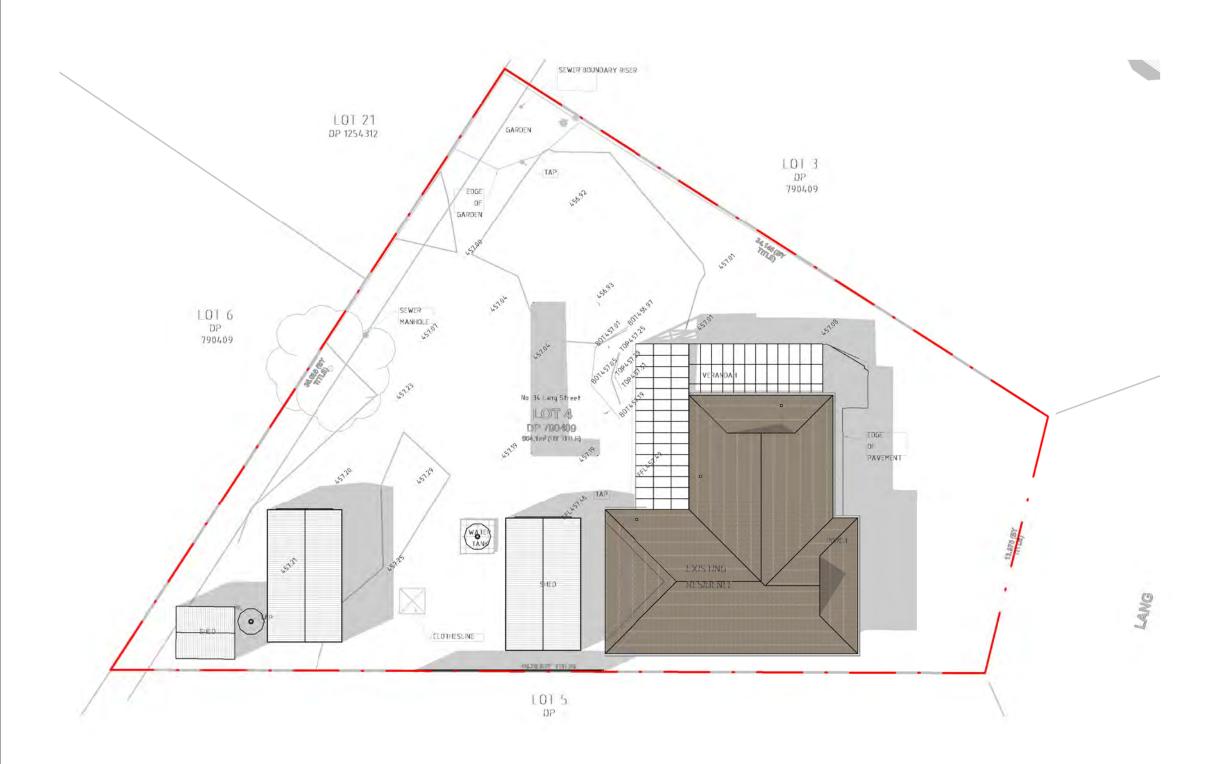





NOTE: ALL EXISTING & OVERALL DIMENSIONS ARE NOMINAL & SUBJECT TO VERIFICATION ON SITE. WHERE ANY DISCREPANCY OCCURS BETWEEN NEW WORK & EXISTING BETWEEN NEW WORK & EXISTING DIMENSIONS - EXISTING DIMENSIONS/WORK SHOULD TAKE PREFERENCE WHERE NECESSARY - OTHERWISE NOTIFY PLAN LAND NOTE:

NOTE: SELECTED TERMITE PROTECTION TO BE USED ON SITE IN ACCORDANCE WITH LOCAL COUNCIL'S REQUIREMENTS, B.C.A. AND ALL RELEVANT AUSTRALIAN STANDARDS

AUSTRALIAN STANDARDS <u>NOTE:</u> SMOKE DETECTORS TO COMPLY WITH REQUIREMENTS OF SPECIFICATION EL7 (NSW) FIRE AND SMOKE ALARMS SHALL COMPLY WITH AS 3786 AND BE CONNECTED TO THE MAIN POWER SUPPLY. <u>NOTE:</u> LOCATION OF SMOKE ALARMS IN ACCORDANCE WITH CLAUSE 3.7.5.2 OF THE NCC. NOTE:

NOTE: STAIRWAY TO HAVE A NON-SLIP FINISH OR NOSING STRIP IN ACCORDANCE WITH CLAUSE 3.9.1.4 AND TABLE 3.9.1.3 OF THE NCC.

NOTE: METHOD OF VENTILATING THE LAUNDRY AND WC AND CONTROLLING CONDENSATION IN ACCORDANCE WITH CLAUSES 3.8.5.2 & 3.8.7.3 OF THE NCC.


Project

34 Lang Street, Mudgee NSW 2850 Client

Drawing: Shadow Diagram (Existing)

| newton teale c | onsulting pty ltd | ABN: | |
|----------------------|-------------------|------------|---------|
| trading as pl | an land | 62 128 7 | 716 334 |
| PO BOX 495 C | ymea NSW | | |
| Phone: 0403 | 993 876 | | |
| Email: info@ | planland.com.au | | |
| Drawn: | Approved: | Date: | |
| LT | LT | OCT/2 | 02 |
| Scale: | Drawing No.: | Sheet No.: | Rev |
| 1:200@A3 | 22113 | DA 5 9 | |

20 ו

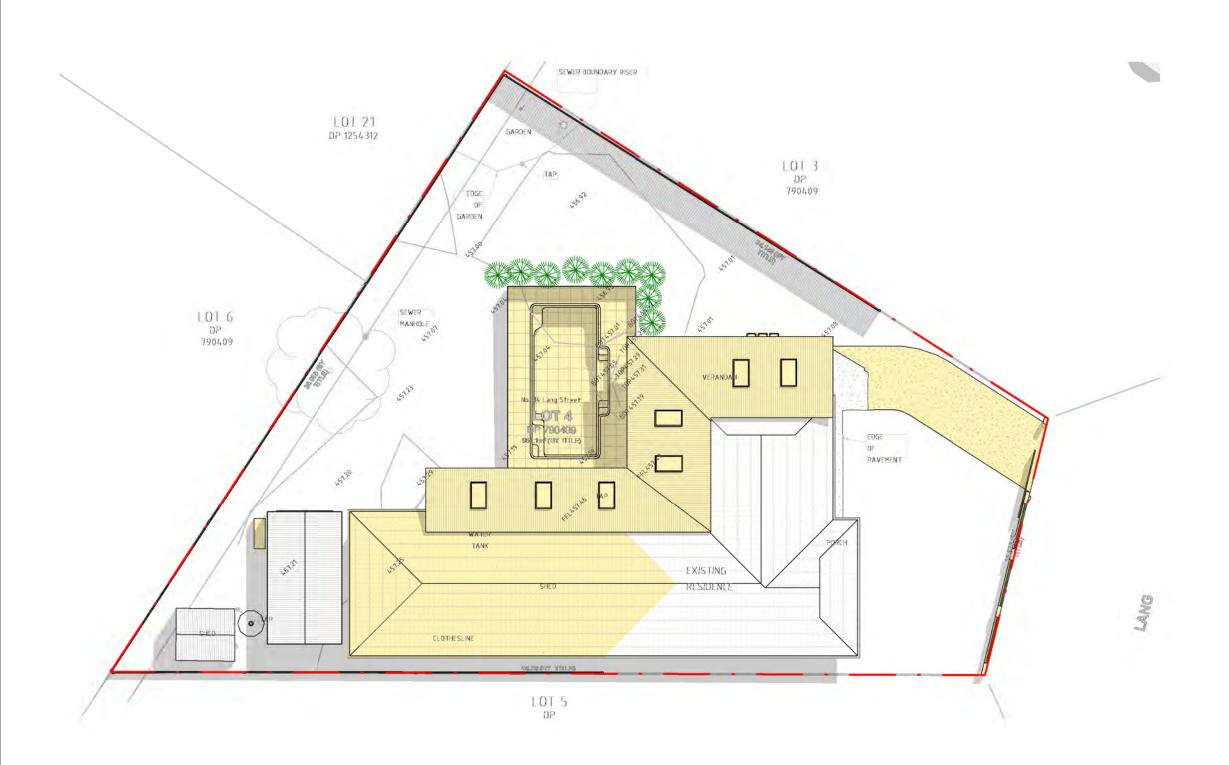



NOTE: ALL EXISTING & OVERALL DIMENSIONS ARE NOMINAL & SUBJECT TO VERIFICATION ON SITE. WHERE ANY DISCREPANCY OCCURS BETWEEN NEW WORK & EXISTING BETWEEN NEW WORK & EXISTING DIMENSIONS - EXISTING DIMENSIONS/WORK SHOULD TAKE PREFERENCE WHERE NECESSARY - OTHERWISE NOTIFY PLAN LAND NOTE:

NOTE: SELECTED TERMITE PROTECTION TO BE USED ON SITE IN ACCORDANCE WITH LOCAL COUNCIL'S REQUIREMENTS, B.C.A. AND ALL RELEVANT AUSTRALIAN STANDARDS

AUSTRALIAN STANDARDS <u>NOTE:</u> SMOKE DETECTORS TO COMPLY WITH REQUIREMENTS OF SPECIFICATION EL7 (NSW) FIRE AND SMOKE ALARMS SHALL COMPLY WITH AS 3786 AND BE CONNECTED TO THE MAIN POWER SUPPLY. <u>NOTE:</u> LOCATION OF SMOKE ALARMS IN ACCORDANCE WITH CLAUSE 3.7.5.2 OF THE NCC. NOTE:

NOTE: STAIRWAY TO HAVE A NON-SLIP FINISH OR NOSING STRIP IN ACCORDANCE WITH CLAUSE 3.9.1.4 AND TABLE 3.9.1.3 OF THE NCC.

NOTE: METHOD OF VENTILATING THE LAUNDRY AND WC AND CONTROLLING CONDENSATION IN ACCORDANCE WITH CLAUSES 3.8.5.2 & 3.8.7.3 OF THE NCC.


Project: 34 Lang Street, Mudgee NSW 2850

Client

Drawing: Shadow Diagram (New)

| - | 1:200@A3 | | DA 5.10 | 1007.1 |
|-----|-----------------------|-----------------|----------|-----------|
| , | Scale: | Drawing No.: | Sheet No | Rev.: |
|) m | LT | LT | OCT | /2022 |
| | Drawn: | Approved: | Date: | |
| | | olanland.com.au | | |
| | Phone: 0403 9 | 93 876 | | |
| | PO BOX 495 Gy | mea NSW | | |
| | trading as pla | n land | 62 12 | 8 716 334 |
| | newton teale con | | ABN: | |

20

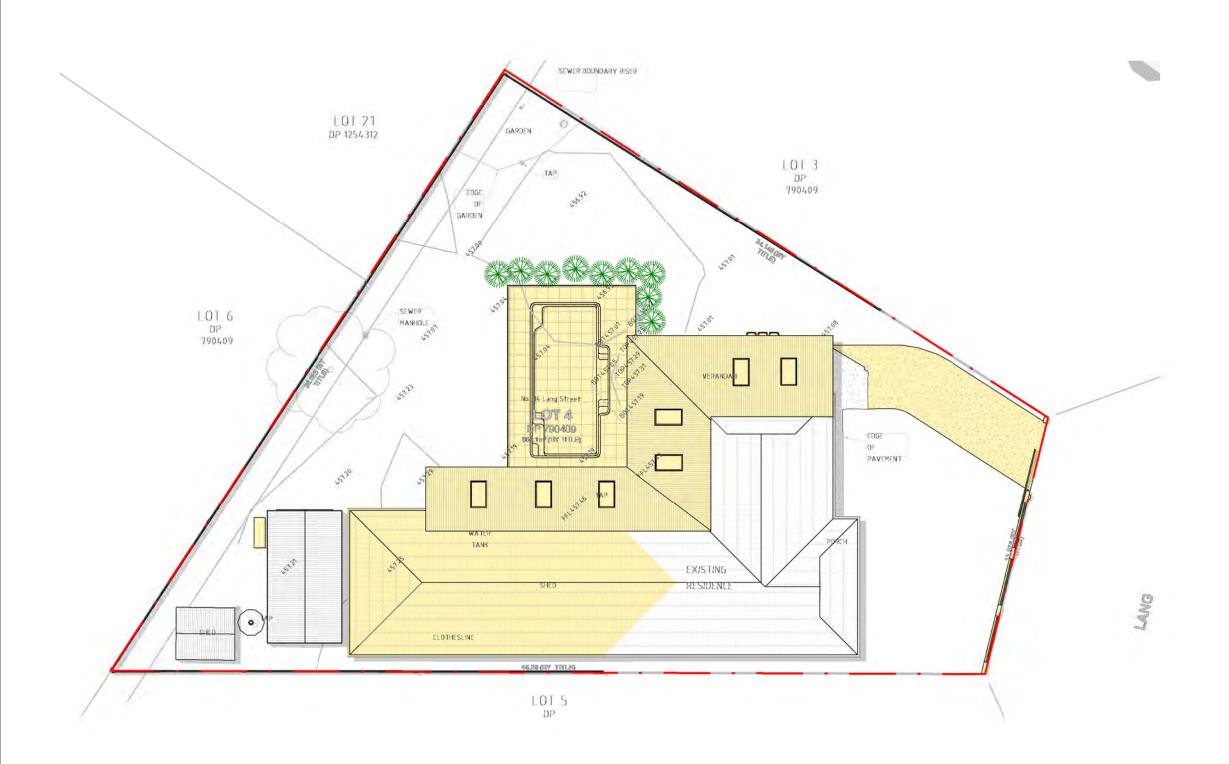





NOTE: ALL EXISTING & OVERALL DIMENSIONS ARE NOMINAL & SUBJECT TO VERIFICATION ON SITE. WHERE ANY DISCREPANCY OCCURS BETWEEN NEW WORK & EXISTING BETWEEN NEW WORK & EXISTING DIMENSIONS - EXISTING DIMENSIONS/WORK SHOULD TAKE PREFERENCE WHERE NECESSARY - OTHERWISE NOTIFY PLAN LAND NOTE:

NOTE: SELECTED TERMITE PROTECTION TO BE USED ON SITE IN ACCORDANCE WITH LOCAL COUNCIL'S REQUIREMENTS, B.C.A. AND ALL RELEVANT AUSTRALIAN STANDARDS

AUSTRALIAN STANDARDS <u>NOTE:</u> SMOKE DETECTORS TO COMPLY WITH REQUIREMENTS OF SPECIFICATION EL7 (NSW) FIRE AND SMOKE ALARMS SHALL COMPLY WITH AS 3786 AND BE CONNECTED TO THE MAIN POWER SUPPLY. <u>NOTE:</u> LOCATION OF SMOKE ALARMS IN ACCORDANCE WITH CLAUSE 3.7.5.2 OF THE NCC. NOTE:

NOTE: STAIRWAY TO HAVE A NON-SLIP FINISH OR NOSING STRIP IN ACCORDANCE WITH CLAUSE 3.9.1.4 AND TABLE 3.9.1.3 OF THE NCC.

NOTE: METHOD OF VENTILATING THE LAUNDRY AND WC AND CONTROLLING CONDENSATION IN ACCORDANCE WITH CLAUSES 3.8.5.2 & 3.8.7.3 OF THE NCC.

Project


34 Lang Street, Mudgee NSW 2850

Client

Drawing: Shadow Diagram (New)

| | | 10 1.1 | 1031 | |
|-----|-----------------------|-----------------|---------|-------|
| | newton teale con | | ABN: | |
| | trading as pla | 62 128 7 | 16 334 | |
| | PO BOX 495 Gy | mea NSW | | |
| | Phone: 0403 9 | 93 876 | | |
| | Email: info@p | olanland.com.au | | |
| | Drawn: | Approved: | Date: | |
|) m | LT | LT | OCT/2 | 022 |
| | Scale: | Drawing No.: | | Rev.: |
| | 1:200@A3 | 22113 | DA 5.11 | |

20

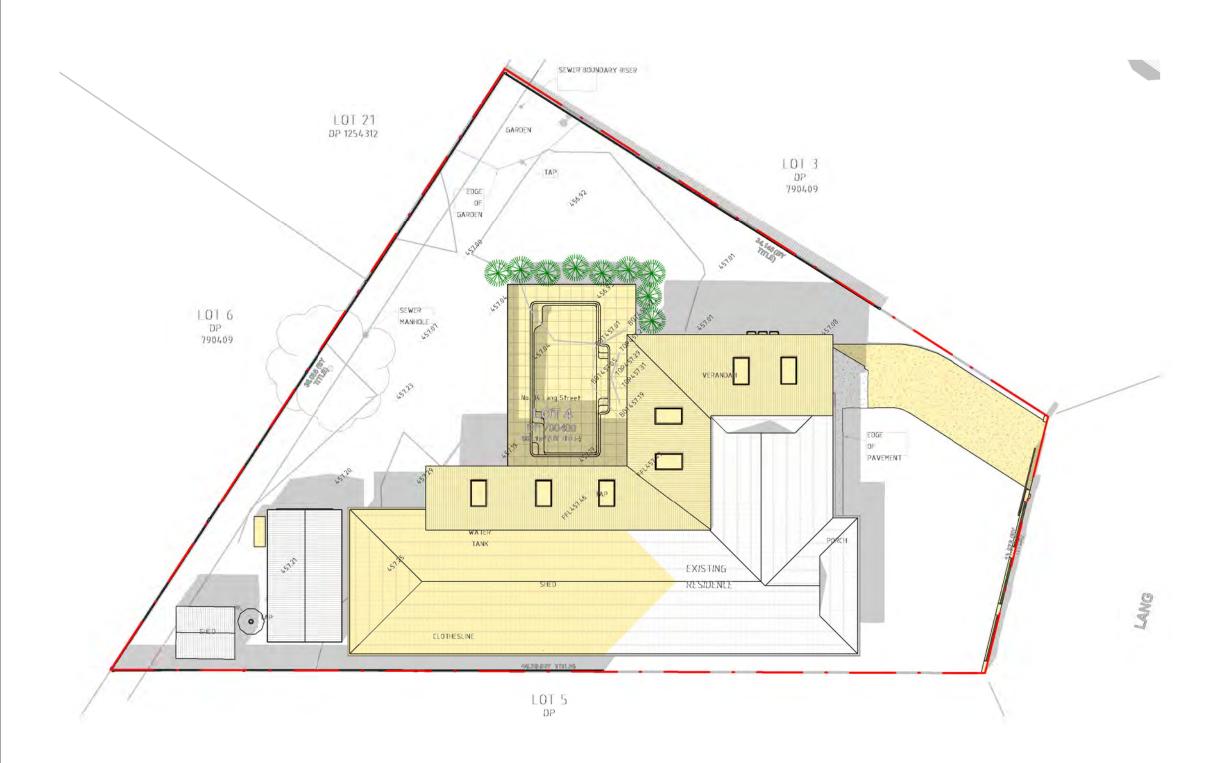



NOTE: ALL EXISTING & OVERALL DIMENSIONS ARE NOMINAL & SUBJECT TO VERIFICATION ON SITE. WHERE ANY DISCREPANCY OCCURS BETWEEN NEW WORK & EXISTING BETWEEN NEW WORK & EXISTING DIMENSIONS - EXISTING DIMENSIONS/WORK SHOULD TAKE PREFERENCE WHERE NECESSARY - OTHERWISE NOTIFY PLAN LAND NOTE:

NOTE: SELECTED TERMITE PROTECTION TO BE USED ON SITE IN ACCORDANCE WITH LOCAL COUNCIL'S REQUIREMENTS, B.C.A. AND ALL RELEVANT AUSTRALIAN STANDARDS NOTE:

AUSTRALIAN STANDARDS <u>NOTE:</u> SMOKE DETECTORS TO COMPLY WITH REQUIREMENTS OF SPECIFICATION EL7 (NSW) FIRE AND SMOKE ALARMS SHALL COMPLY WITH AS 3786 AND BE CONNECTED TO THE MAIN POWER SUPPLY. <u>NOTE:</u> LOCATION OF SMOKE ALARMS IN ACCORDANCE WITH CLAUSE 3.7.5.2 OF THE NCC. NOTE:

NOTE: STAIRWAY TO HAVE A NON-SLIP FINISH OR NOSING STRIP IN ACCORDANCE WITH CLAUSE 3.9.1.4 AND TABLE 3.9.1.3 OF THE NCC.

MOTE: METHOD OF VENTILATING THE LAUNDRY AND WC AND CONTROLLING CONDENSATION IN ACCORDANCE WITH CLAUSES 3.8.5.2 & 3.8.7.3 OF THE NCC.


Project: 34 Lang Street, Mudgee NSW 2850

Client

Drawing: Shadow Diagram (New)

| | 1:200@A3 | 22113 | DA 5.12 | | | |
|-----|-----------------------|-----------------|-----------|-------|--|--|
| | Scale: | Drawing No.: | | Rev.: | | |
|) m | LT | LT | | /2022 | | |
| | Drawn: | Approved: | Date: | | | |
| | Email: info@p | olanland.com.au | | | | |
| | Phone: 0403 9 | 93 876 | | | | |
| | PO BOX 495 Gy | mea NSW | | | | |
| | trading as pla | 62 12 | 8 716 334 | | | |
| | newton teale cor | sulting pty ltd | ABN: | | | |

20

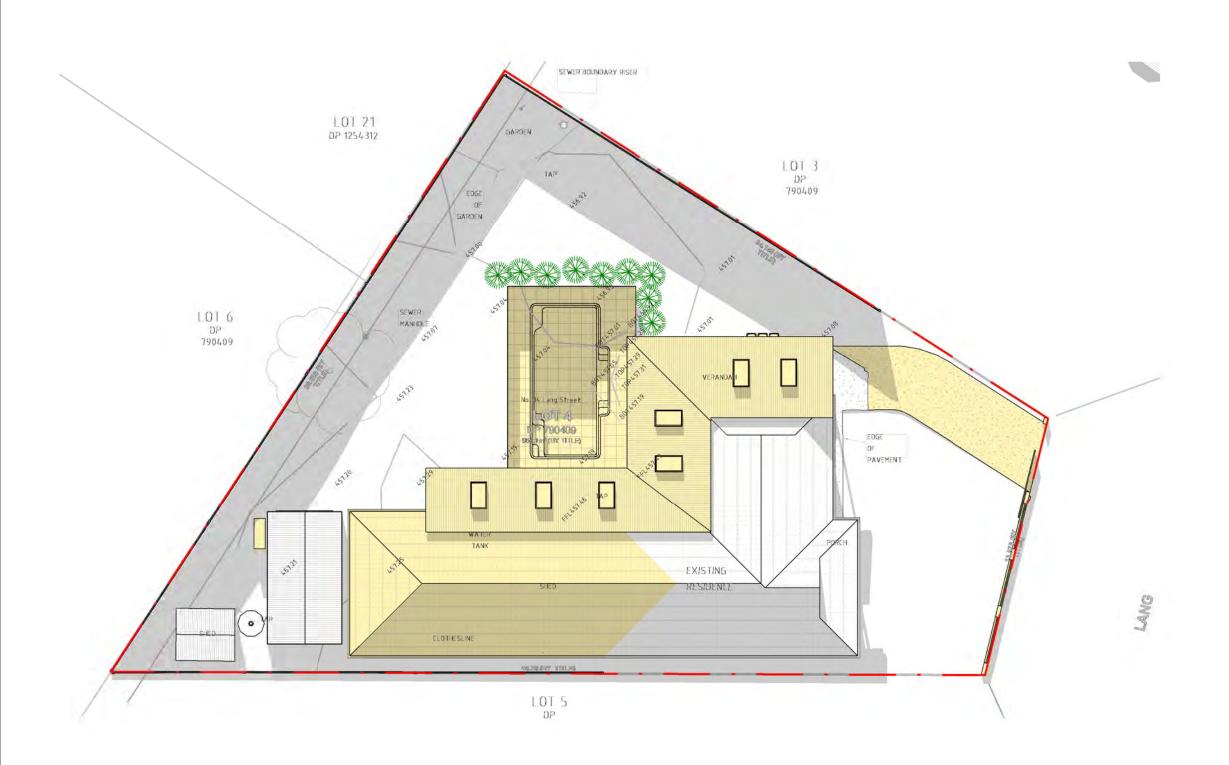





NOTE: ALL EXISTING & OVERALL DIMENSIONS ARE NOMINAL & SUBJECT TO VERIFICATION ON SITE. WHERE ANY DISCREPANCY OCCURS BETWEEN NEW WORK & EXISTING BETWEEN NEW WORK & EXISTING DIMENSIONS - EXISTING DIMENSIONS/WORK SHOULD TAKE PREFERENCE WHERE NECESSARY - OTHERWISE NOTIFY PLAN LAND NOTE:

NOTE: SELECTED TERMITE PROTECTION TO BE USED ON SITE IN ACCORDANCE WITH LOCAL COUNCIL'S REQUIREMENTS, B.C.A. AND ALL RELEVANT AUSTRALIAN STANDARDS

AUSTRALIAN STANDARDS <u>NOTE:</u> SMOKE DETECTORS TO COMPLY WITH REQUIREMENTS OF SPECIFICATION EL7 (NSW) FIRE AND SMOKE ALARMS SHALL COMPLY WITH AS 3786 AND BE CONNECTED TO THE MAIN POWER SUPPLY. <u>NOTE:</u> LOCATION OF SMOKE ALARMS IN ACCORDANCE WITH CLAUSE 3.7.5.2 OF THE NCC. NOTE:

NOTE: STAIRWAY TO HAVE A NON-SLIP FINISH OR NOSING STRIP IN ACCORDANCE WITH CLAUSE 3.9.1.4 AND TABLE 3.9.1.3 OF THE NCC.

MOTE: METHOD OF VENTILATING THE LAUNDRY AND WC AND CONTROLLING CONDENSATION IN ACCORDANCE WITH CLAUSES 3.8.5.2 & 3.8.7.3 OF THE NCC.

Project


34 Lang Street, Mudgee NSW 2850

Client

Drawing: Shadow Diagram (New)

| | newton teale co | nsulting pty ltd | ABN: | _ |
|-----|-----------------------|------------------|---------------|---|
| | trading as pla | in land | 62 128 716 33 | 4 |
| | PO BOX 495 Gy | | | |
| | Phone: 0403 9 | 993 876 | | |
| | Email: info@ | planland.com.au | | |
| | Drawn: | Approved: | Date: | |
| | LT | LT | OCT/202 | 9 |
|) m | LI | LI | 001/202 | ~ |
|) m | Scale: | Drawing No.: | | _ |

20

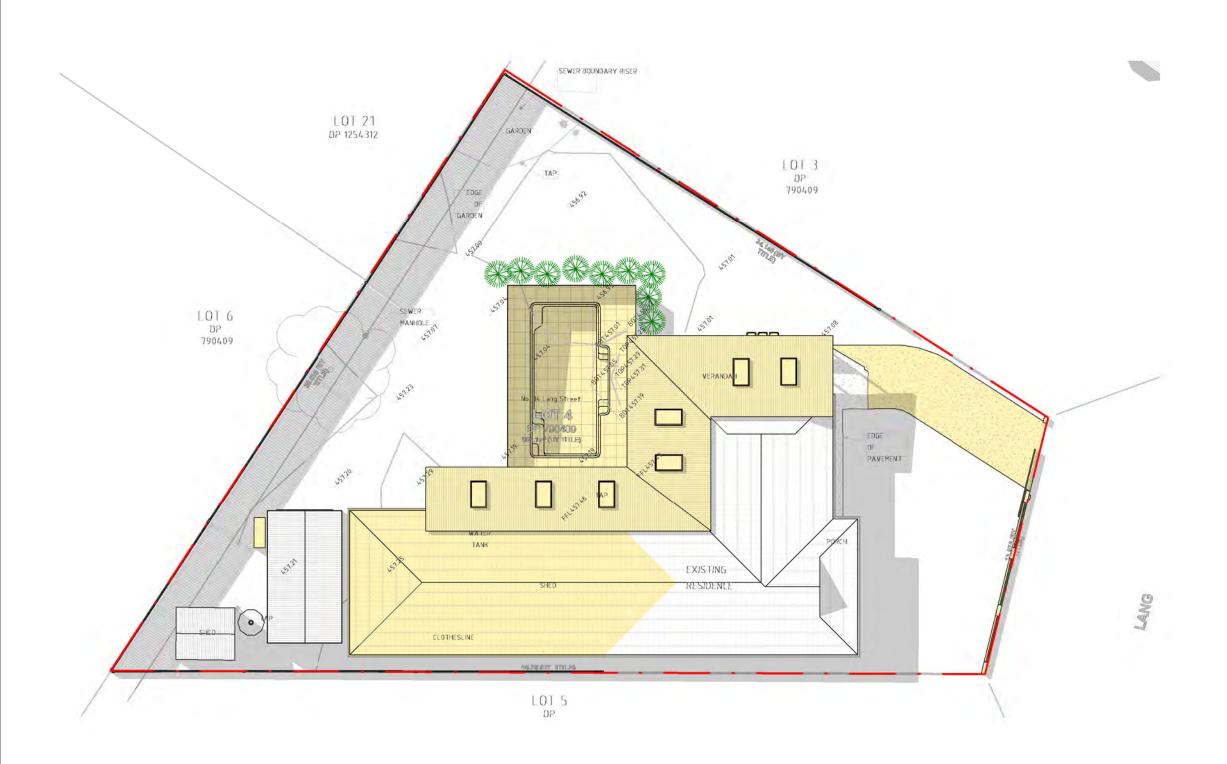





NOTE: ALL EXISTING & OVERALL DIMENSIONS ARE NOMINAL & SUBJECT TO VERIFICATION ON SITE. WHERE ANY DISCREPANCY OCCURS BETWEEN NEW WORK & EXISTING BETWEEN NEW WORK & EXISTING DIMENSIONS - EXISTING DIMENSIONS/WORK SHOULD TAKE PREFERENCE WHERE NECESSARY - OTHERWISE NOTIFY PLAN LAND NOTE:

NOTE: SELECTED TERMITE PROTECTION TO BE USED ON SITE IN ACCORDANCE WITH LOCAL COUNCIL'S REQUIREMENTS, B.C.A. AND ALL RELEVANT AUSTRALIAN STANDARDS

AUSTRALIAN STANDARDS <u>NOTE:</u> SMOKE DETECTORS TO COMPLY WITH REQUIREMENTS OF SPECIFICATION EL7 (NSW) FIRE AND SMOKE ALARMS SHALL COMPLY WITH AS 3786 AND BE CONNECTED TO THE MAIN POWER SUPPLY. <u>NOTE:</u> LOCATION OF SMOKE ALARMS IN ACCORDANCE WITH CLAUSE 3.7.5.2 OF THE NCC. NOTE:

NOTE: STAIRWAY TO HAVE A NON-SLIP FINISH OR NOSING STRIP IN ACCORDANCE WITH CLAUSE 3.9.1.4 AND TABLE 3.9.1.3 OF THE NCC.


NOTE: METHOD OF VENTILATING THE LAUNDRY AND WC AND CONTROLLING CONDENSATION IN ACCORDANCE WITH CLAUSES 3.8.5.2 & 3.8.7.3 OF THE NCC.

Project 34 Lang Street,

Mudgee NSW 2850 Client

Drawing: Shadow Diagram (New)

| | | | | _ |
|--------|-----------------------|-----------------|----------------|----|
| | newton teale co | ABN: | | |
| | trading as pla | ın land | 62 128 716 334 | |
| | PO BOX 495 Gy | mea NSW | | |
| | Phone: 0403 | | | |
| | Email: info@ | planland.com.au | | |
| | Drawn: | Approved: | Date: | _ |
| 20 m | LT | LT | OCT/2022 | 2 |
| 20 111 | Scale: | Drawing No.: S | heet No.: Rev. | .: |
| | 1:200@A3 | 22113 I | DA 5.14 | |

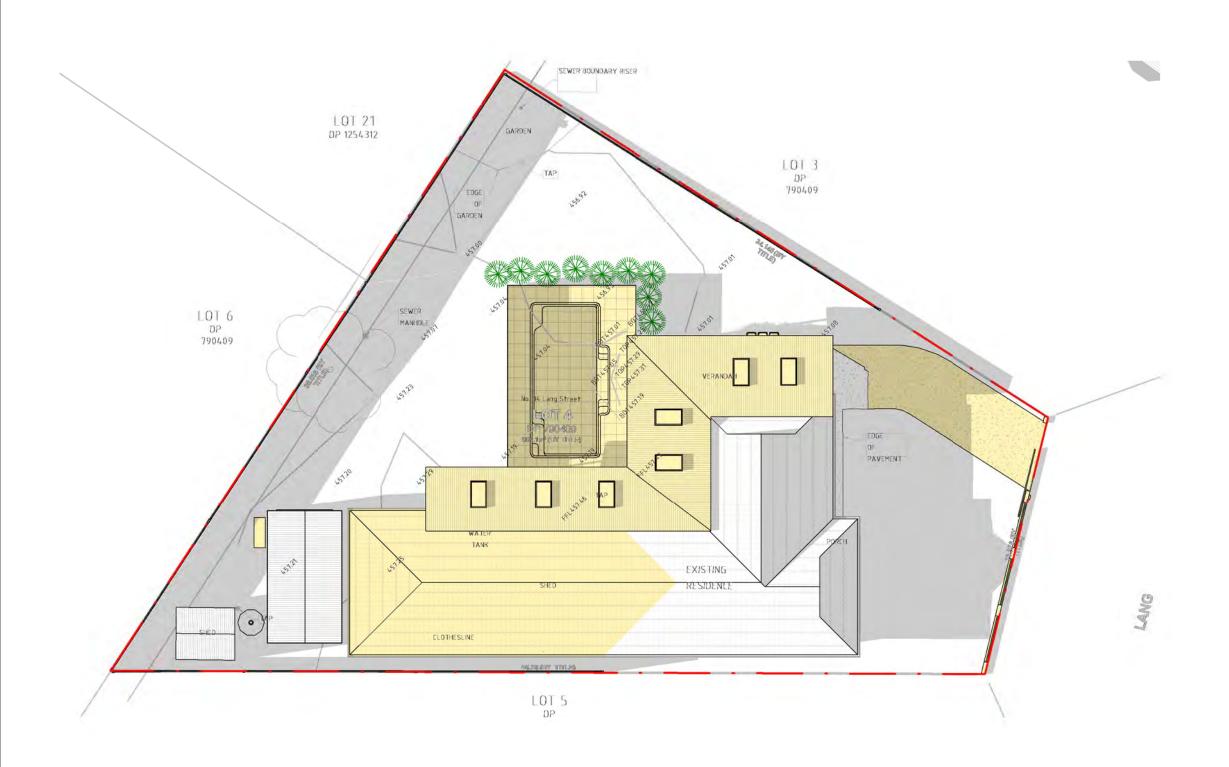





NOTE: ALL EXISTING & OVERALL DIMENSIONS ARE NOMINAL & SUBJECT TO VERIFICATION ON SITE. WHERE ANY DISCREPANCY OCCURS BETWEEN NEW WORK & EXISTING BETWEEN NEW WORK & EXISTING DIMENSIONS - EXISTING DIMENSIONS/WORK SHOULD TAKE PREFERENCE WHERE NECESSARY - OTHERWISE NOTIFY PLAN LAND NOTE:

NOTE: SELECTED TERMITE PROTECTION TO BE USED ON SITE IN ACCORDANCE WITH LOCAL COUNCIL'S REQUIREMENTS, B.C.A. AND ALL RELEVANT AUSTRALIAN STANDARDS

AUSTRALIAN STANDARDS <u>NOTE:</u> SMOKE DETECTORS TO COMPLY WITH REQUIREMENTS OF SPECIFICATION EL7 (NSW) FIRE AND SMOKE ALARMS SHALL COMPLY WITH AS 3786 AND BE CONNECTED TO THE MAIN POWER SUPPLY. <u>NOTE:</u> LOCATION OF SMOKE ALARMS IN ACCORDANCE WITH CLAUSE 3.7.5.2 OF THE NCC. NOTE:

NOTE: STAIRWAY TO HAVE A NON-SLIP FINISH OR NOSING STRIP IN ACCORDANCE WITH CLAUSE 3.9.1.4 AND TABLE 3.9.1.3 OF THE NCC.

NOTE: METHOD OF VENTILATING THE LAUNDRY AND WC AND CONTROLLING CONDENSATION IN ACCORDANCE WITH CLAUSES 3.8.5.2 & 3.8.7.3 OF THE NCC.

Project


34 Lang Street, Mudgee NSW 2850

Client

Drawing: Shadow Diagram (New)

| | newton teale co | sulting pty ltd | ABN: | |
|-----|-----------------------|-----------------|---------|-----------|
| | trading as pla | n land | 62 12 | 8 716 334 |
| | PO BOX 495 Gy | | | |
| | Phone: 0403 9 | 93 876 | | |
| | Email: info@ | olanland.com.au | | |
| | Drawn: | Approved: | Date: | |
|) m | LT | LT | | /2022 |
| | Scale: | Drawing No.: | | Rev.: |
| | 1:200@A3 | 22113 | DA 5.15 | |

20

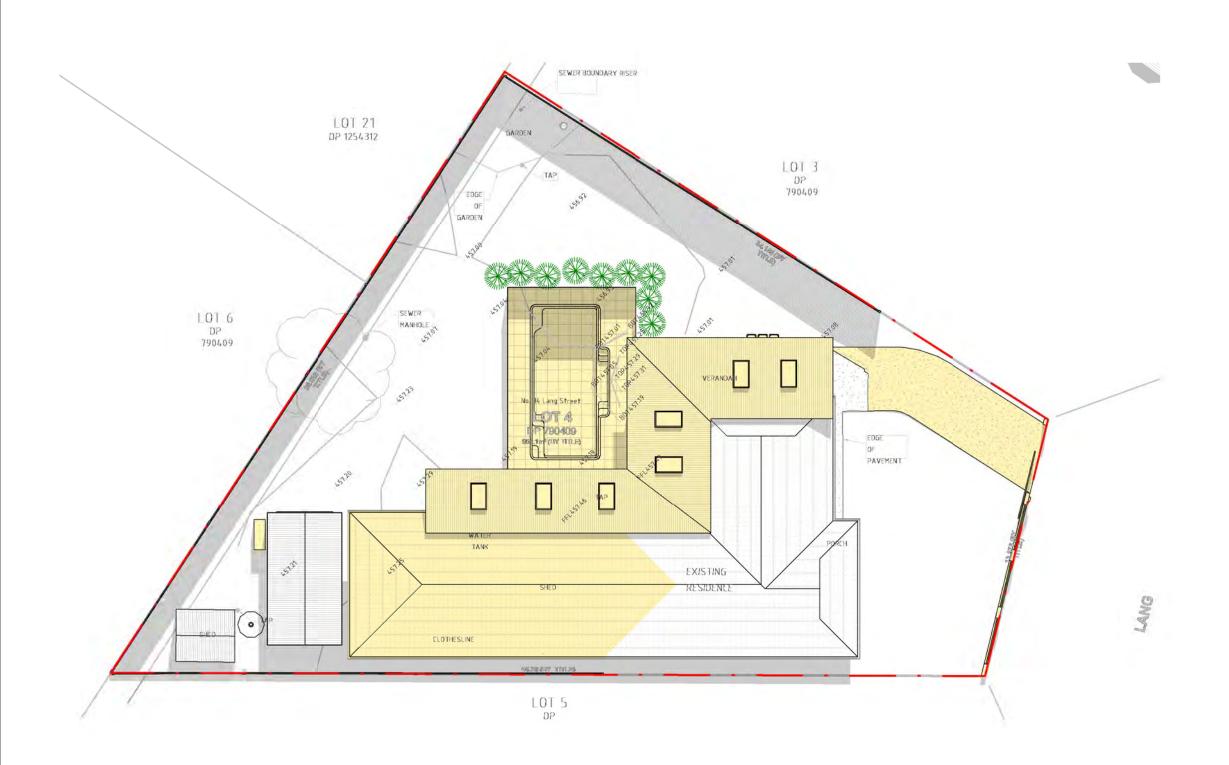





NOTE: ALL EXISTING & OVERALL DIMENSIONS ARE NOMINAL & SUBJECT TO VERIFICATION ON SITE. WHERE ANY DISCREPANCY OCCURS BETWEEN NEW WORK & EXISTING BETWEEN NEW WORK & EXISTING DIMENSIONS - EXISTING DIMENSIONS/WORK SHOULD TAKE PREPRENCE WHERE NECESSARY - OTHERWISE NOTE:

NOTE: SELECTED TERMITE PROTECTION TO BE USED ON SITE IN ACCORDANCE WITH LOCAL COUNCIL'S REQUIREMENTS, B.C.A. AND ALL RELEVANT AUSTRALIAN STANDARDS

AUSTRALIAN STANDARDS <u>NOTE:</u> SMOKE DETECTORS TO COMPLY WITH REQUIREMENTS OF SPECIFICATION EL7 (NSW) FIRE AND SMOKE ALARMS SHALL COMPLY WITH AS 3786 AND BE CONNECTED TO THE MAIN POWER SUPPLY. <u>NOTE:</u> LOCATION OF SMOKE ALARMS IN ACCORDANCE WITH CLAUSE 3.7.5.2 OF THE NCC. NOTE:

NOTE: STAIRWAY TO HAVE A NON-SLIP FINISH OR NOSING STRIP IN ACCORDANCE WITH CLAUSE 3.9.1.4 AND TABLE 3.9.1.3 OF THE NCC.

NOTE: METHOD OF VENTILATING THE LAUNDRY AND WC AND CONTROLLING CONDENSATION IN ACCORDANCE WITH CLAUSES 3.8.5.2 & 3.8.7.3 OF THE NCC.

34 Lang Street, Mudgee NSW 2850

20 m

10

Project

Client


(New) ABN: 62 128 716 334

Drawing: Shadow Diagram

newton teale consulting pty ltd trading as **plan land** PO BOX 495 Gymea NSW Phone: 0403 993 876 Email: info@planland.com.au Drawn: Approved: LT LT Date: OCT/2022

 Scale:
 Drawing No.:
 Sheet No.:

 1:200@A3
 22113
 DA 5.16

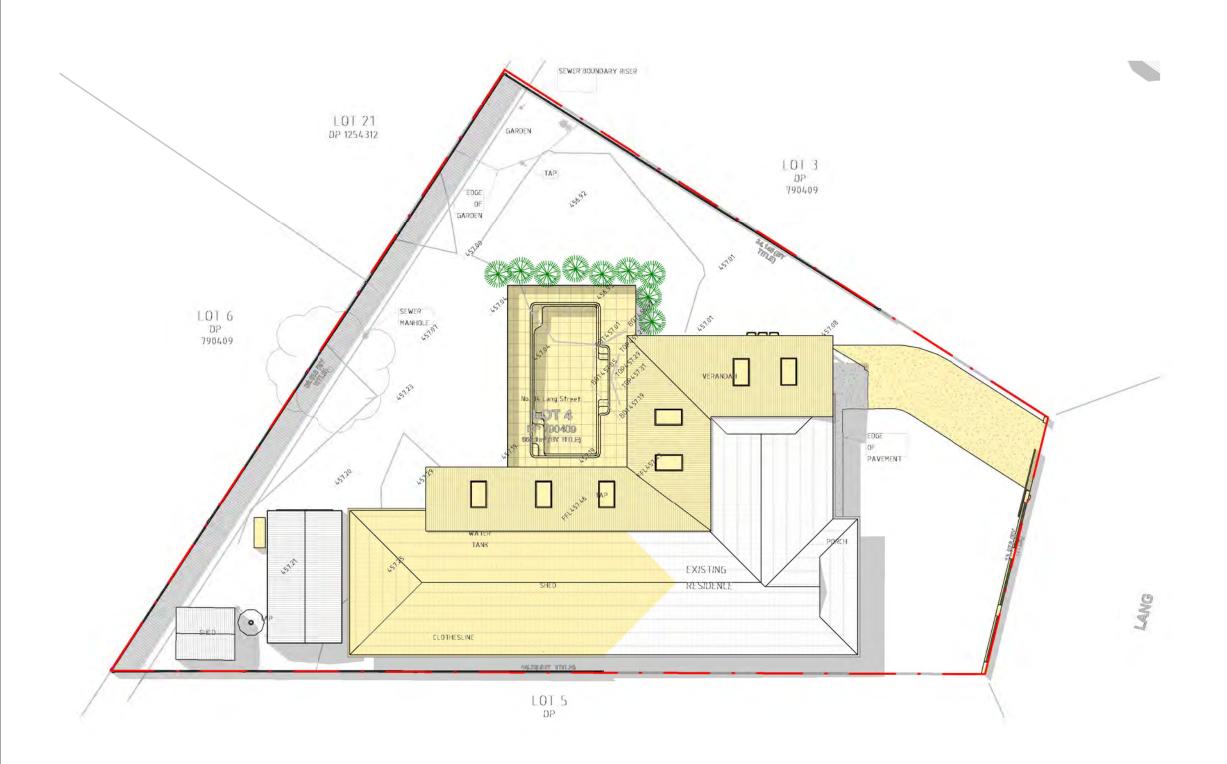





NOTE: ALL EXISTING & OVERALL DIMENSIONS ARE NOMINAL & SUBJECT TO VERIFICATION ON SITE. WHERE ANY DISCREPANCY OCCURS BETWEEN NEW WORK & EXISTING BETWEEN NEW WORK & EXISTING DIMENSIONS - EXISTING DIMENSIONS/WORK SHOULD TAKE PREPRENCE WHERE NECESSARY - OTHERWISE NOTE:

NOTE: SELECTED TERMITE PROTECTION TO BE USED ON SITE IN ACCORDANCE WITH LOCAL COUNCIL'S REQUIREMENTS, B.C.A. AND ALL RELEVANT AUSTRALIAN STANDARDS

AUSTRALIAN STANDARDS <u>NOTE:</u> SMOKE DETECTORS TO COMPLY WITH REQUIREMENTS OF SPECIFICATION EL7 (NSW) FIRE AND SMOKE ALARMS SHALL COMPLY WITH AS 3786 AND BE CONNECTED TO THE MAIN POWER SUPPLY. <u>NOTE:</u> LOCATION OF SMOKE ALARMS IN ACCORDANCE WITH CLAUSE 3.7.5.2 OF THE NCC. NOTE:

NOTE: STAIRWAY TO HAVE A NON-SLIP FINISH OR NOSING STRIP IN ACCORDANCE WITH CLAUSE 3.9.1.4 AND TABLE 3.9.1.3 OF THE NCC.

NOTE: METHOD OF VENTILATING THE LAUNDRY AND WC AND CONTROLLING CONDENSATION IN ACCORDANCE WITH CLAUSES 3.8.5.2 & 3.8.7.3 OF THE NCC.

34 Lang Street, Mudgee NSW 2850

20 m

10

Project

Client


(New) ABN: 62 128 716 334

newton teale consulting pty ltd trading as **plan land** PO BOX 495 Gymea NSW Phone: 0403 993 876 Email: info@planland.com.au Drawn: Approved: LT LT Date: OCT/2022

 Scale:
 Drawing No.:
 Sheet No.:

 1:200@A3
 22113
 DA 5.17

Drawing: Shadow Diagram

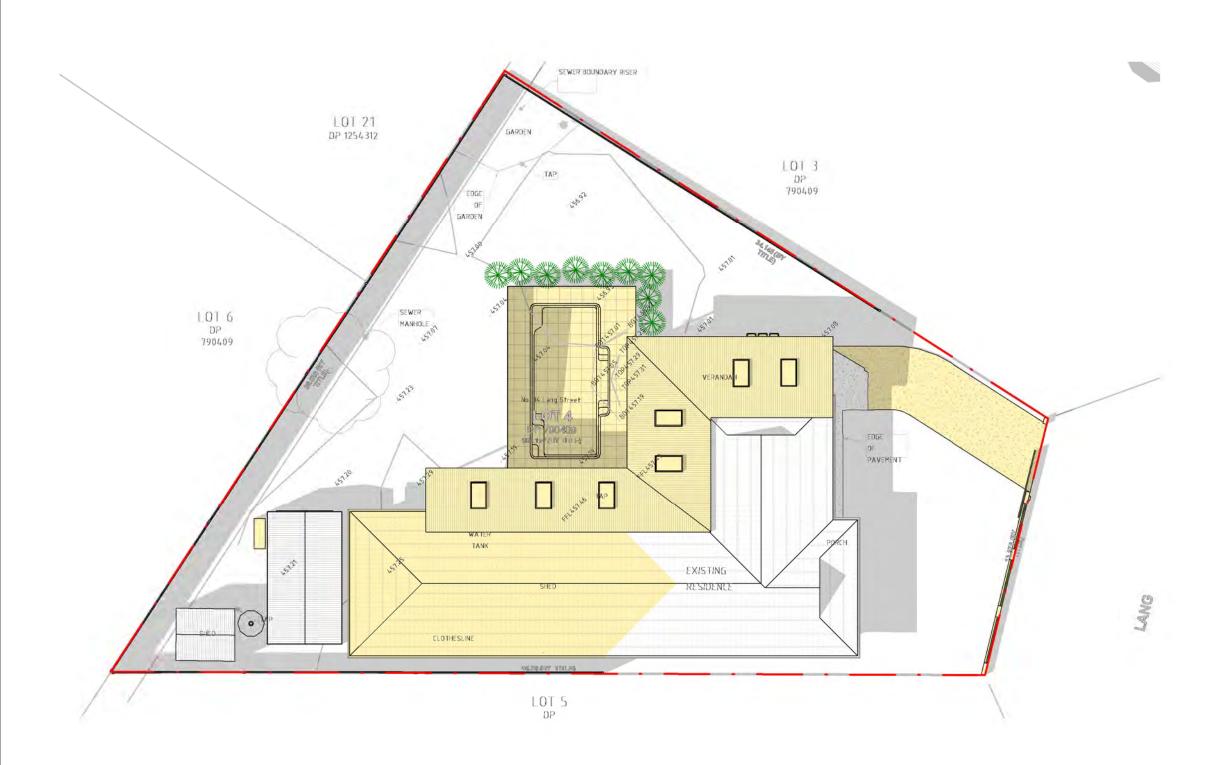





NOTE: ALL EXISTING & OVERALL DIMENSIONS ARE NOMINAL & SUBJECT TO VERIFICATION ON SITE. WHERE ANY DISCREPANCY OCCURS BETWEEN NEW WORK & EXISTING BETWEEN NEW WORK & EXISTING DIMENSIONS - EXISTING DIMENSIONS/WORK SHOULD TAKE PREPRENCE WHERE NECESSARY - OTHERWISE NOTE:

NOTE: SELECTED TERMITE PROTECTION TO BE USED ON SITE IN ACCORDANCE WITH LOCAL COUNCIL'S REQUIREMENTS, B.C.A. AND ALL RELEVANT AUSTRALIAN STANDARDS

AUSTRALIAN STANDARDS <u>NOTE:</u> SMOKE DETECTORS TO COMPLY WITH REQUIREMENTS OF SPECIFICATION EL7 (NSW) FIRE AND SMOKE ALARMS SHALL COMPLY WITH AS 3786 AND BE CONNECTED TO THE MAIN POWER SUPPLY. <u>NOTE:</u> LOCATION OF SMOKE ALARMS IN ACCORDANCE WITH CLAUSE 3.7.5.2 OF THE NCC. NOTE:

NOTE: STAIRWAY TO HAVE A NON-SLIP FINISH OR NOSING STRIP IN ACCORDANCE WITH CLAUSE 3.9.1.4 AND TABLE 3.9.1.3 OF THE NCC.

NOTE: METHOD OF VENTILATING THE LAUNDRY AND WC AND CONTROLLING CONDENSATION IN ACCORDANCE WITH CLAUSES 3.8.5.2 & 3.8.7.3 OF THE NCC.

34 Lang Street, Mudgee NSW 2850

Drawing: Shadow Diagram

 $20 \text{ m} \frac{\text{LT}}{\text{Scale:}}$


10

Project

Client

(New)

| | onsulting pty ltd | ABN: |
|----------------------|------------------------------|----------------|
| trading as pl | an land | 62 128 716 334 |
| PO BOX 495 (| Gymea NSW | |
| Phone: 0403 | 3 993 876 | |
| Email: info@ | [®] planland.com.au | |
| Drawn: | Approved: | Date: |
| LT | LT | OCT/2022 |
| Scale: | Drawing No.: | Sheet No.: Rev |
| 1:200@A3 | 99119 | DA 5.18 |

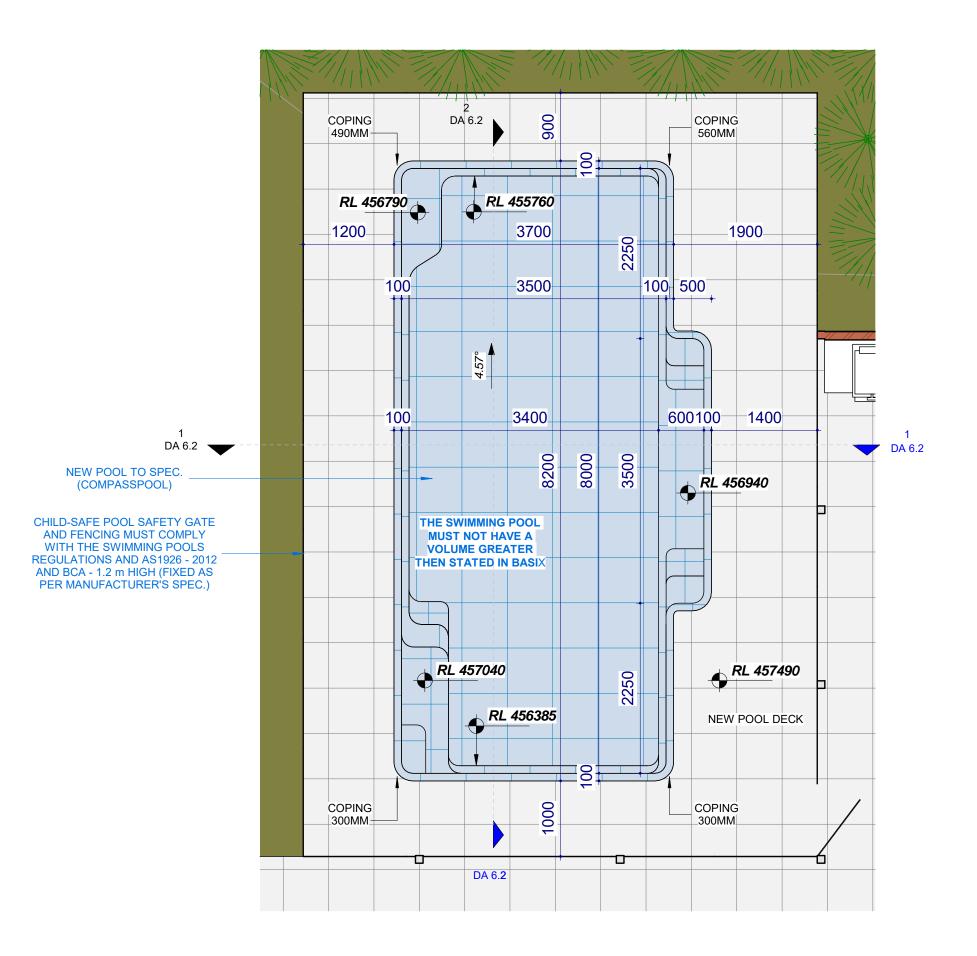



BASK NOTES: The applicant must install, and be installed in accordance with, the requirements of all spectrum of the period basic shared basic spectrum of the spectrum of the spectrum of the period basic shared basic spectrum of the spectrum of the spectrum of the period basic shared basic spectrum of the spectrum of the spectrum of the period basic spectrum of the spectrum of the spectrum of the spectrum of the period basic spectrum of the spectrum of the spectrum of the spectrum of the cellings/roofs in accordance with the specifications listed in the table below, except that a j additional install the windows, glazed doors and shading devices, in accordance with the specifications instand in the table below. Relevant overshadowing specifications must be satisfied for each window and glazed door. For projections described in milimetres, the leading edge of each eave projek. Werandiah basics with the specifications must be astarbited for each window and glazed door. For projections described in milimetres, the leading edge of each eave projek. Werandiah basics of the specifications must be no more than 500 mm above the head of the window or glazed door and no more than 2400 mm above the sail.

<u>COPYRIGHT:</u> ALL WORK IS TO COMPLY WITH THE BUILDING CODE OF AUSTRALIA, RELEVANT AUSTRALIAN STANDARDS &

AUSTRALIA, RELEVANT AUSTRALIAN STANDARDS & LOCAL AUTHORITY REQUIREMENTS. BUILDING CONTRACTOR & ALL RELEVANT SUB TRADES TO CHECK & VERIFY ALL DIMENSIONS & ASSOCIATED DRAWING PARTS PRIOR TO MANUFACTURE. CONSTRUCTION & INSTALLATION ON SITE. DO NOT SCALE OFF DRAWINGS - WRITTEN DIMENSIONS TAKE PRECEDENCE. PLAN LAND ACCEPTS NO LIABILITY OR RESPONSIBILITY RESULTING FROM BUILDERS NEGLECT OR PREFERRED METHOD OF CONSTRUCTION FOR ANY BUILDING DEFECT.

METHOD OF CONSTRUCTION FOR ANY BUILDING DEFECT. THESE DRAWINGS ARE THE PROPERTY OF PLAN LAND. DRAWINGS ARE NOT TO BE REPRODUCED IN PART OR IN WHOLE ON ANY MEDIUM WITHOUT THE WRITTEN PERMISSION OF PLAN LAND.

NOTE: ALL EXISTING & OVERALL DIMENSIONS ARE NOMINAL & SUBJECT TO VERIFICATION ON SITE. WHERE ANY DISCREPANCY OCCURS BETWEEN NEW WORK & EXISTING BETWEEN NEW WORK & EXISTING DIMENSIONS - EXISTING DIMENSIONS/WORK SHOULD TAKE PREPRENCE WHERE NECESSARY - OTHERWISE NOTE:

NUTH F FLAVEND NOTE: SELECTED TERMITE PROTECTION TO BE USED ON SITE IN ACCORDANCE WITH LOCAL COUNCIL'S REQUIREMENTS, B.C.A. AND ALL RELEVANT AUSTRALIAN STANDARDS

NOTE: SMOKE DETECTORS TO COMPLY WITH REQUIREMENTS SMORE DETECTORS TO COMPLY WITH REQUIREMENTS OF SPECIFICATION EL7 (NSW) FIRE AND SMOKE ALARMS SHALL COMPLY WITH AS 3786 AND BE CONNECTED TO THE MAIN POWER SUPPLY.

INCLUSE STATES IN ACCORDANCE WITH CLAUSE 3.7.5.2 OF THE NCC.


NOTE: STAIRWAY TO HAVE A NON-SLIP FINISH OR NOSING STRIP IN ACCORDANCE WITH CLAUSE 3.9.1.4 AND TABLE 3.9.1.3 OF THE NCC.

NOTE: METHOD OF VENTILATING THE LAUNDRY AND WC AND CONTROLLING CONDENSATION IN ACCORDANCE WITH CLAUSES 3.8.5.2 & 3.8.7.3 OF THE NCC.

34 Lang Street, Mudgee NSW 2850 Client

Pool Plan

| newton teale con | sulting pty ltd | ABN: | |
|------------------|--|--|---|
| trading as pla | n land | 62 12 | 8 716 334 |
| PO BOX 495 Gyn | nea NSW | | |
| Phone: 0403 99 | 93 876 | | |
| Email: info@pl | lanland.com.au | | |
| Drawn: | Approved: | Date: | |
| LT | LT | OCT/ | 2022 |
| Scale: | Drawing No.: | Sheet No.: | Rev.: |
| 1:50@A3 | 22113 | DA 6.1 | |
| | trading as pla PO BOX 495 Gyr Phone: 0403 99 Email: info@p Drawn: LT Scale: | Drawn: Approved: LT LT Scale: Drawing No.: | trading as plan land 62 124 PO BOX 495 Gymea NSW Phone: 0403 993 876 Email: info@planland.com.au Drawn: Approved: Date: LT LT OCCT/ Scale: Drawing No.: Sheet No.: |

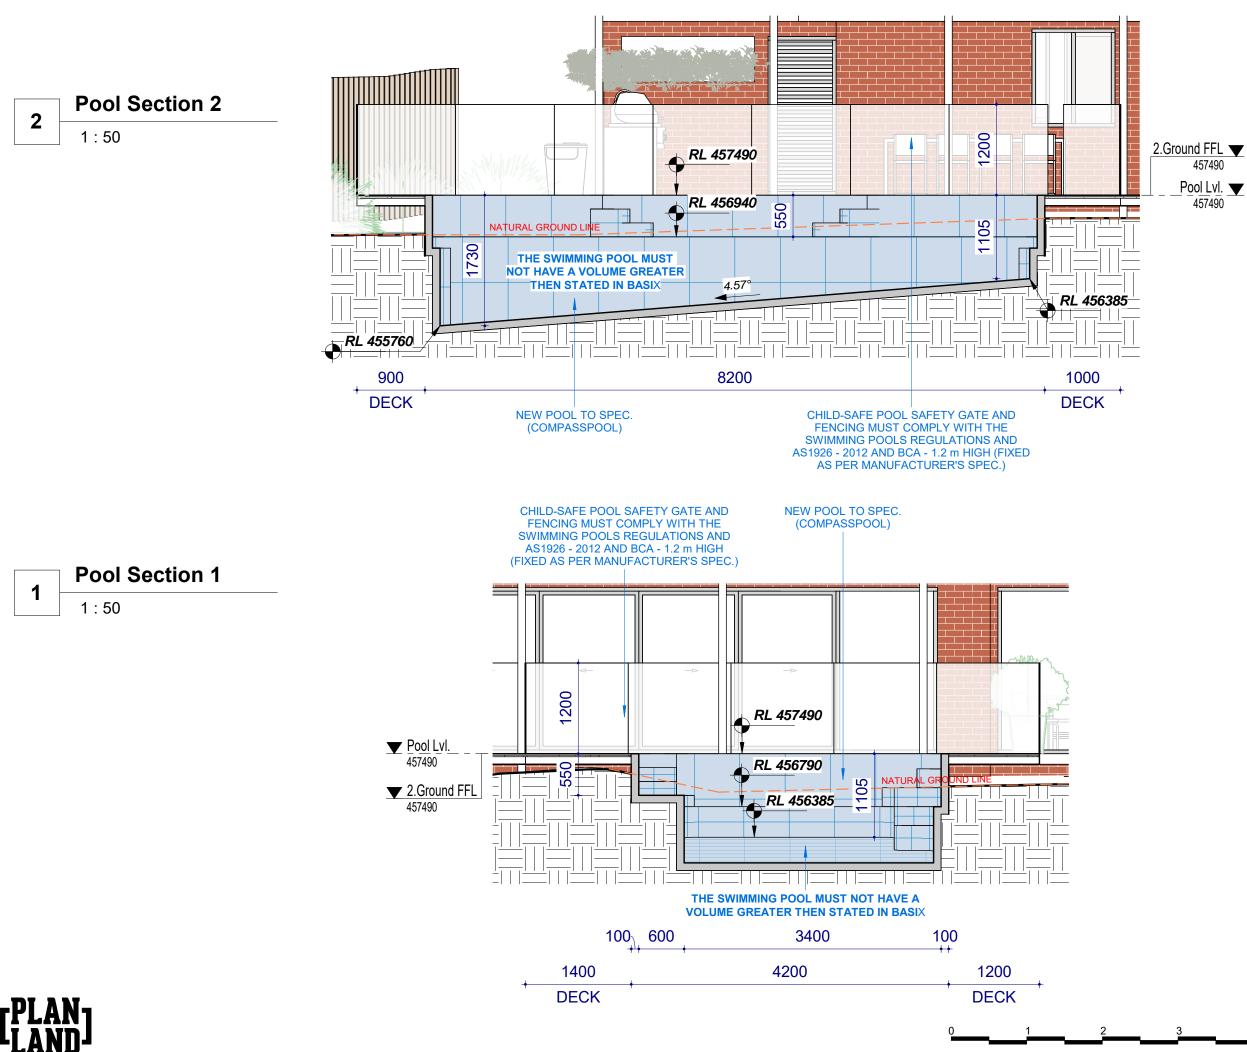

BASIX NOTES:

The applicant must install a rainwater tank of at least 2734 litres on the site. This rainwater tank must meet, and be installed in accordance with, the requirements applicable regulatory authorities or glazed door above which they are situated, up the pergola also shades a perpendicular window. The spacing between batters in be more than 50 mm. The swimming pool must be outdoors.

imming pool must be outdoors. imming pool must be have a capacity greater than 51 kilolitres. plicant must construct the new or altered construction (floor(s), walls, and iroofs) in accordance with the specifications listed in the table below, except additional insulation is not required where the area of new construction is less -0, b) insulation specified is not required to parts of altered construction with the specified is not required to parts of altered construction with the specified is not required to parts of altered construction with the specified is not required to parts of altered construction with the specified is not required to parts of altered construction with the specified is not required to parts of the specified is not specified in the specified is not required to parts of the specified is not specified in the specified in the specified is not specified in the specified in the specified in the specified is not specified in the spec

b) instantion specified is not required on parts of anered construction waited waited with a sheady exists, and must install the windows, glazed doors and shading devices, in e with the specifications listed in the table below. wershadowing specifications must be satisfied for each window and glazed and shading the satisfied for each window and glazed below.

door. For projections described in millimetres, the leading edge of each eave, pergola, verandah, balcony or awning must be no more than 500 mm above the head of the window or glazed door and no more than 2400 mm above the sill.

<u>COPYRIGHT:</u> ALL WORK IS TO COMPLY WITH THE BUILDING CODE OF AUSTRALIA, RELEVANT AUSTRALIAN STANDARDS &

AUSTRALLA, RELEVANT AUSTRALIAN STANDARDS & LOCAL AUTHORITY REQUIREMENTS. BUILDING CONTRACTOR & ALL RELEVANT SUB TRADES TO CHECK & VERIFY ALL DIMENSIONS & ASSOCIATED DRAWING PARTS PRIOR TO MANUFACTURE, CONSTRUCTION & INSTALLATION ON SITE. DO NOT SCALE OFF DRAWINGS - WRITTEN DIMENSIONS TAKE PRECEDENCE. PLAN LAND ACCEPTS NO LIABILITY OR RESPONSIBILITY RESULTING FROM BUILDERS NEGLECT OR PREFERRED METHOD OF CONSTRUCTION FOR ANY BUILDING DEFECT.

DEFECT. THESE DRAWINGS ARE THE PROPERTY OF PLAN LAND.

DRAWINGS ARE NOT TO BE REPRODUCED IN PART OR IN WHOLE ON ANY MEDIUM WITHOUT THE WRITTEN PERMISSION OF PLAN LAND.

NOTE: ALL EXISTING & OVERALL DIMENSIONS ARE NOMINAL & SUBJECT TO VERIFICATION ON SITE. WHERE ANY DISCREPANCY OCCURS BETWEEN NEW WORK & EXISTING BETWEEN NEW WORK & EXISTING DIMENSIONS - EXISTING DIMENSIONS/WORK SHOULD TAKE PREPRENCE WHERE NECESSARY - OTHERWISE NOTE:

NOTE: SELECTED TERMITE PROTECTION TO BE USED ON SITE IN ACCORDANCE WITH LOCAL COUNCIL'S REQUIREMENTS, B.C.A. AND ALL RELEVANT AUSTRALIAN STANDARDS

NOTE: SMOKE DETECTORS TO COMPLY WITH REQUIREMENTS SMORE DETECTORS TO COMPLY WITH REQUIREMENTS OF SPECIFICATION EL7 (NSW) FIRE AND SMOKE ALARMS SHALL COMPLY WITH AS 3786 AND BE CONNECTED TO THE MAIN POWER SUPPLY.

INCLUSE STATES IN ACCORDANCE WITH CLAUSE 3.7.5.2 OF THE NCC.


NOTE: STAIRWAY TO HAVE A NON-SLIP FINISH OR NOSING STRIP IN ACCORDANCE WITH CLAUSE 3.9.1.4 AND TABLE 3.9.1.3 OF THE NCC.

NOTE: METHOD OF VENTILATING THE LAUNDRY AND WC AND CONTROLLING CONDENSATION IN ACCORDANCE WITH CLAUSES 3.8.5.2 & 3.8.7.3 OF THE NCC.

34 Lang Street, Mudgee NSW 2850

Drawing: Pool Sections

| | | | newton teale co | nsulting pty ltd | ABN: | _ |
|---|---|------|-----------------------|------------------|---------------|-----|
| | | | trading as pla | an land | 62 128 716 33 | 4 |
| | | | PO BOX 495 G | /mea NSW | | |
| | | | Phone: 0403 | 993 876 | | |
| | | | Email: info@ | planland.com.au | | |
| | | | Drawn: | Approved: | Date: | _ |
| 2 | 1 | 5m | LT | LT | OCT/202 | 2 |
|) | 4 | JIII | Scale: | Drawing No.: | Sheet No.: Re | v.: |
| | | | 1:50@A3 | 22113 | DA 6.2 | |

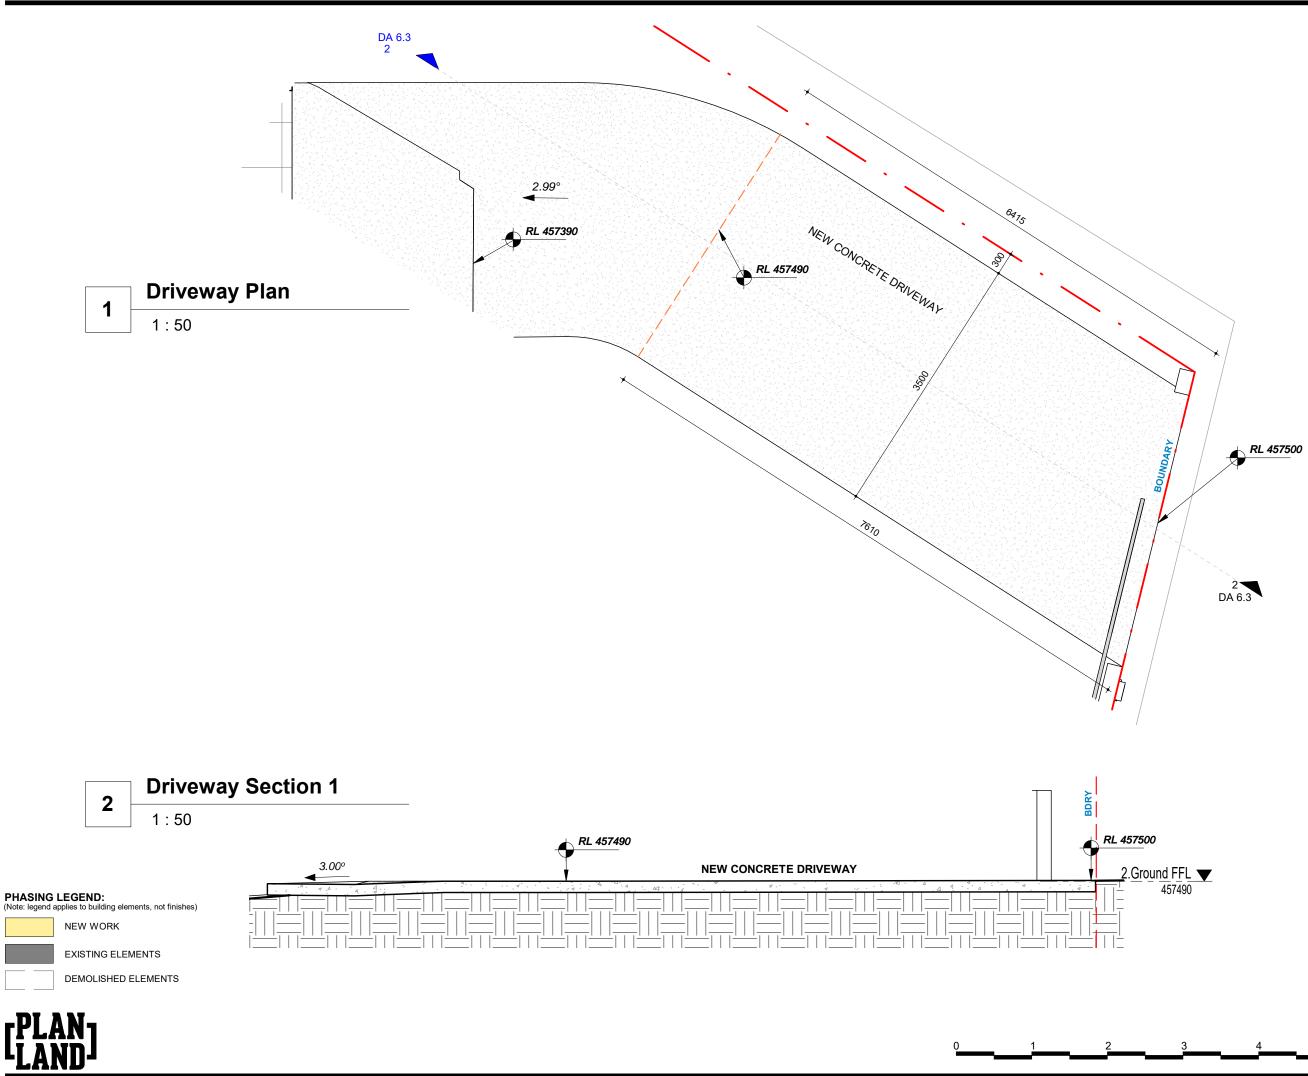

NOTE: ALL EXISTING & OVERALL DIMENSIONS ARE NOMINAL & SUBJECT TO VERIFICATION ON SITE. WHERE ANY DISCREPANCY OCCURS BETWEEN NEW WORK & EXISTING BETWEEN NEW WORK & EXISTING DIMENSIONS - EXISTING DIMENSIONS/WORK SHOULD TAKE PREPRENCE WHERE NECESSARY - OTHERWISE NOTE:

NOTE: SELECTED TERMITE PROTECTION TO BE USED ON SITE IN ACCORDANCE WITH LOCAL COUNCIL'S REQUIREMENTS, B.C.A. AND ALL RELEVANT AUSTRALIAN STANDARDS

AUSTRALIAN STANDARDS <u>NOTE:</u> SMOKE DETECTORS TO COMPLY WITH REQUIREMENTS OF SPECIFICATION EL7 (NSW) FIRE AND SMOKE ALARMS SHALL COMPLY WITH AS 3786 AND BE CONNECTED TO THE MAIN POWER SUPPLY. <u>NOTE:</u> LOCATION OF SMOKE ALARMS IN ACCORDANCE WITH CLAUSE 3.7.5.2 OF THE NCC. NOTE:

NOTE: STAIRWAY TO HAVE A NON-SLIP FINISH OR NOSING STRIP IN ACCORDANCE WITH CLAUSE 3.9.1.4 AND TABLE 3.9.1.3 OF THE NCC.

NOTE: METHOD OF VENTILATING THE LAUNDRY AND WC AND CONTROLLING CONDENSATION IN ACCORDANCE WITH CLAUSES 3.8.5.2 & 3.8.7.3 OF THE NCC.


Projec

34 Lang Street, Mudgee NSW 2850 Client

Drawing: Driveway Plan & Section

| newton teale o | onsulting pty ltd | ABN: | | |
|---------------------|-------------------|------------|-----------|--|
| trading as p | an land | 62 12 | 8 716 334 | |
| PO BOX 495 0 | Gymea NSW | | | |
| Phone: 0403 | 3 993 876 | | | |
| Email: info | @planland.com.au | | | |
| Drawn: | Approved: | Date: | | |
| LT | LT | OCT | 2022 | |
| Scale: | Drawing No.: | Sheet No.: | Rev.: | |
| | 00110 | DA 6.3 | | |

5m

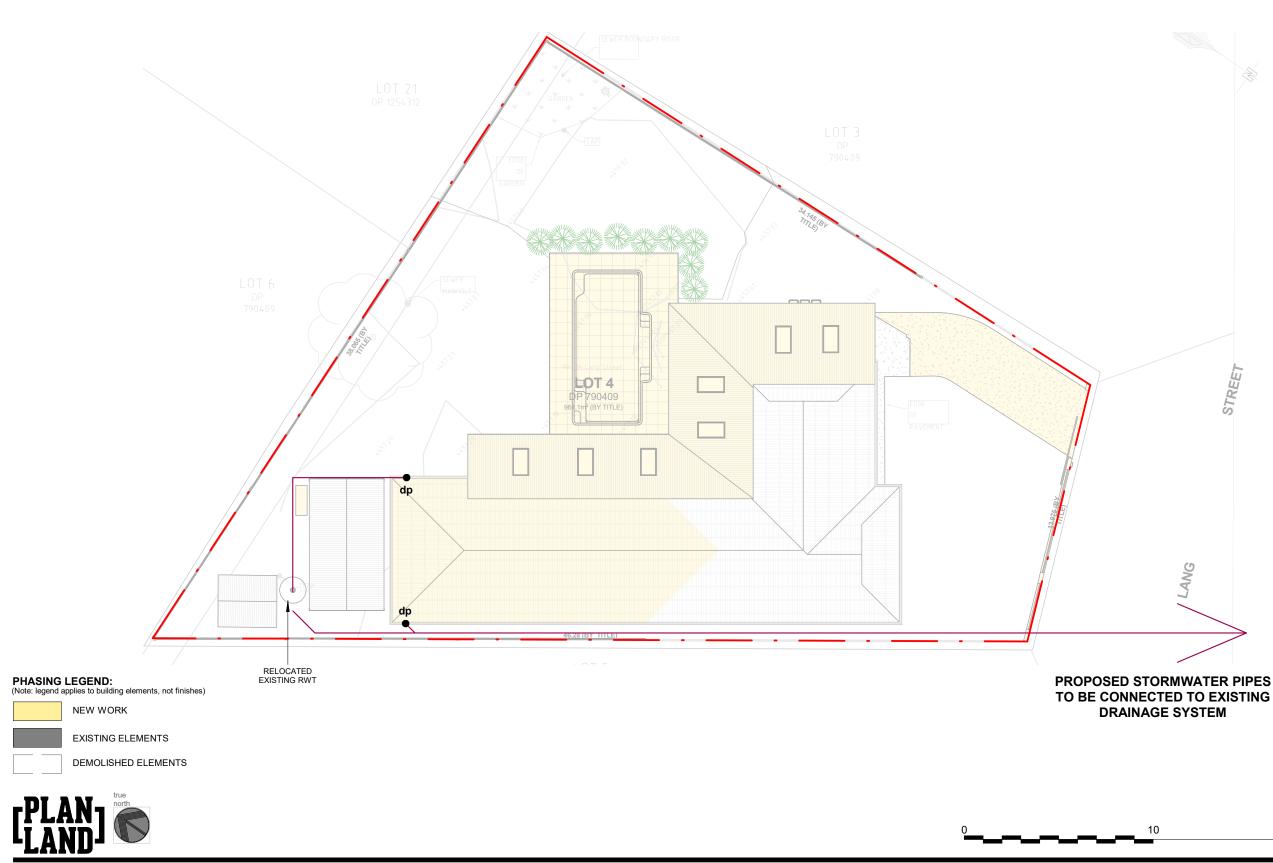

STREET

COPYRIGHT: ALL WORK IS TO COMPLY WITH THE BUILDING CODE OF AUSTRALIA, RELEVANT AUSTRALIAN STANDARDS & LOCAL AUTHORITY REQUIREMENTS. BUILDING CONTRACTOR & ALL RELEVANT SUB TRADES TO CHECK & VERIFY ALL DIMENSIONS & ASSOCIATED DRAWING PARTS PRIOT TO MANUFACTURE, CONSTRUCTION & INSTALLATION ON SITE. DO NOT SCALE OF DRAWINGS - WRITTEN DIMENSIONS TAKE PRECEDENCE. PLAN LAND ACCEPTS NO LIABILITY OR RESPONSIBILITY RESULTING FROM BUILDERS NEGLECT OR PREFERRED METHOD OF CONSTRUCTION FOR ANY BUILDING DEFECT. THESE DRAWINGS ARE THE PROPERTY OF PLAN LAND. DRAWINGS ARE NOT TO BE REPRODUCED IN PART OR IN WHOLE ON ANY MEDIUM WITHOUT THE WRITTEN PREMISSION OF PLAN LAND.

NOTE: ALL EXISTING & OVERALL DIMENSIONS ARE NOMINAL & SUBJECT TO VERIFICATION ON SITE. WHERE ANY DISCREPANCY OCCURS BETWEEN NEW WORK & EXISTING BETWEEN NEW WORK & EXISTING DIMENSIONS - EXISTING DIMENSIONS/WORK SHOULD TAKE PREPRENCE WHERE NECESSARY - OTHERWISE NOTE:

NOTE: SELECTED TERMITE PROTECTION TO BE USED ON SITE IN ACCORDANCE WITH LOCAL COUNCIL'S REQUIREMENTS, B.C.A. AND ALL RELEVANT AUSTRALIAN STANDARDS NOTE:

AUSTRALIAN STANDARDS <u>NOTE:</u> SMOKE DETECTORS TO COMPLY WITH REQUIREMENTS OF SPECIFICATION EL7 (NSW) FIRE AND SMOKE ALARMS SHALL COMPLY WITH AS 3786 AND BE CONNECTED TO THE MAIN POWER SUPPLY. <u>NOTE:</u> LOCATION OF SMOKE ALARMS IN ACCORDANCE WITH CLAUSE 3.7.5.2 OF THE NCC. NOTE:

NOTE: STAIRWAY TO HAVE A NON-SLIP FINISH OR NOSING STRIP IN ACCORDANCE WITH CLAUSE 3.9.1.4 AND TABLE 3.9.1.3 OF THE NCC.

NOTE: METHOD OF VENTILATING THE LAUNDRY AND WC AND CONTROLLING CONDENSATION IN ACCORDANCE WITH CLAUSES 3.8.5.2 & 3.8.7.3 OF THE NCC.


Project: 34 Lang Street, Mudgee NSW 2850

Client

Drawing: Concept Drainage Plan

newton teale consulting pty ltd trading as **plan land** PO BOX 495 Cymea NSW Phone: 0403 993 876 Email: info@planland.com.au Drawn: Approved: LT LT ABN: 62 128 716 334 Date: OCT/2022 Scale: Drawing No.: Sheet No.: 1:200@A3 22113 DA 7.0

20 m

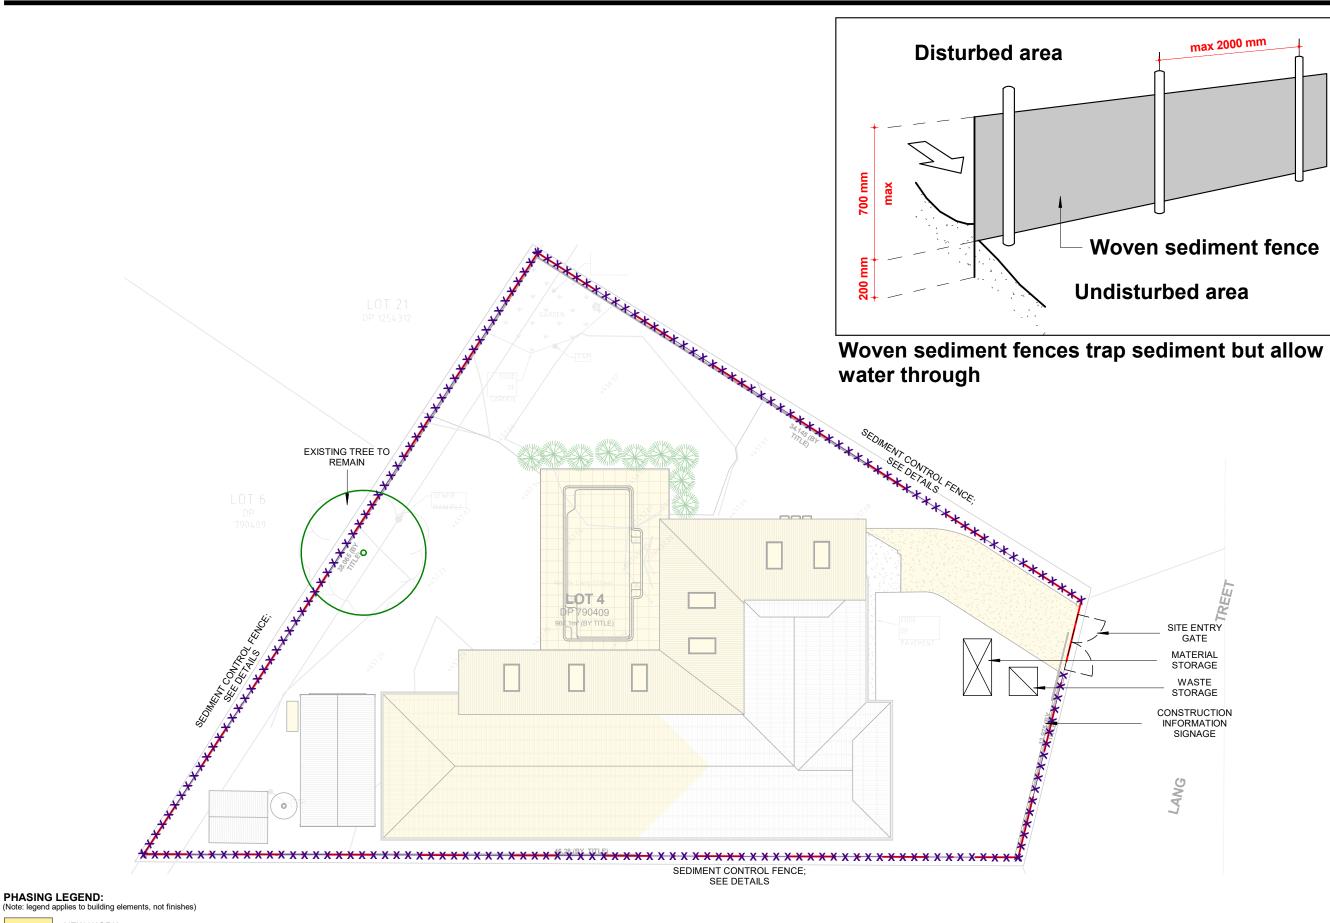


NEW WORK

EXISTING ELEMENTS

DEMOLISHED ELEMENTS



10

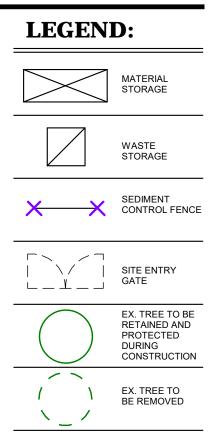

COPYRIGHT: ALL WORK IS TO COMPLY WITH THE BUILDING CODE OF AUSTRALIA, RELEVANT AUSTRALIAN STANDARDS & LOCAL AUTHORITY REQUIREMENTS. BUILDING CONTRACTOR & ALL RELEVANT SUB TRADES TO CHECK & VERIFY ALL DIMENSIONS & ASSOCIATED DRAWING PARTS PRIOR TO MANUFACTURE, CONSTRUCTION & INSTALLATION ON SITE. DO NOT SCALE OF DRAWINGS - WRITTEN DIMENSIONS TAKE PRECEDENCE. PLAN LAND ACCEPTS NO LIABILITY OR RESPONSIBILITY RESULTING FROM BUILDERS NEGLECT OR PREFERRED METHOD OF CONSTRUCTION FOR ANY BUILDING DEFECT.

METHOD OF CONSTRUCTION FOR ANY BUILDING DEFECT. THESE DRAWINGS ARE THE PROPERTY OF PLAN LAND. DRAWINGS ARE NOT TO BE REPRODUCED IN PART OR IN WHOLE ON ANY MEDIUM WITHOUT THE WRITTEN PERMISSION OF PLAN LAND.

NOTE: ALL EXISTING & OVERALL DIMENSIONS ARE NOMINAL & SUBJECT TO VERIFICATION ON SITE. WHERE ANY DISCREPANCY OCCURS BETWEEN NEW WORK & EXISTING BETWEEN NEW WORK & EXISTING DIMENSIONS - EXISTING DIMENSIONS/WORK SHOULD TAKE PREPRENCE WHERE NECESSARY - OTHERWISE NOTE:

NOTE: SELECTED TERMITE PROTECTION TO BE USED ON SITE IN ACCORDANCE WITH LOCAL COUNCIL'S REQUIREMENTS, B.C.A. AND ALL RELEVANT AUSTRALIAN STANDARDS

NOTE: SMOKE DETECTORS TO COMPLY WITH REQUIREMENTS SMORE DETECTORS TO COMPLY WITH REQUIREMENTS OF SPECIFICATION EL7 (NSW) FIRE AND SMOKE ALARMS SHALL COMPLY WITH AS 3786 AND BE CONNECTED TO THE MAIN POWER SUPPLY.

INCLUSE STATES IN ACCORDANCE WITH CLAUSE 3.7.5.2 OF THE NCC.

NOTE: STAIRWAY TO HAVE A NON-SLIP FINISH OR NOSING STRIP IN ACCORDANCE WITH CLAUSE 3.9.1.4 AND TABLE 3.9.1.3 OF THE NCC.

NOTE: METHOD OF VENTILATING THE LAUNDRY AND WC AND CONTROLLING CONDENSATION IN ACCORDANCE WITH CLAUSES 3.8.5.2 & 3.8.7.3 OF THE NCC.

34 Lang Street, Mudgee NSW 2850

Drawing: Construction Mgmt. Plan

| | newton teale c | onsulting pty ltd | ABN: |
|--------|----------------------|-------------------------------------|----------------|
| | trading as pl | an land | 62 128 716 334 |
| | PO BOX 495 C | Jymea NSW | |
| | Phone: 0403 | 993 876 | |
| | Email: info@ | planland.com.au | |
| | Drawn: | Approved: | Date: |
| 20 m | LT | LT | OCT/2022 |
| 20 111 | Scale: | Drawing No.: She | et No.: Rev.: |
| | As indicated | [∞] A ² 22113 D | A 7.1 |

| 1 LANDSCAPE PRELIMINARIES | 2.2 RELATED SPECIFICATION DETAIL | Laboratory Certificate, including test results, certifying material compliance with | If boring under pavements is required, <i>provide</i> a tight fit of service pipes. | |
|--|--|---|---|--|
| I LANDOGAPE PRELIMINARIES | *** Refer to this page header note*** | intended use as determined by the NATA Certifier. | Pressure grout fill voids. | |
| | | Test completed <i>base</i> & <i>subbase</i> : <i>Min</i> 1 test per layer per 200m ² . Refer 'Geotechnical Testing' below. | Trench Backfill | |
| 1 GENERAL | 2.3 MISCELLANEOUS MATERIALS | Lay in 75-150mm finished layers, with equal layers in multilayer courses. | Services Marking: <i>Min</i> 350mm above services, lay underground marking tape (to <i>AS/NZS</i> 2648.1). | |
| 1.1 GENERAL | Refer to the applicable Specification SECT/ONS for description of <i>external</i> products & materials. | | Bedding Material: For bed & haunch zones to be granular material, grading as | |
| This preliminary Specification is not for Tender or construction. | | 1.4 SITE STORMWATER Comply with the following Standards: | per AS 1141. | |
| The Specification Generally | 2.4 TOPSOIL | Joining: Up-stream pipes socket into down-stream pipes. Cap in-complete, open | Fill (General): Well graded, inorganic, non-perishable material, <i>max</i> size 75mm, | |
| This Landscape Specification is to be read with the Architectural Specification. | General Topsoil to comply with AS 4419 'Soils for Landscaping' & ASTM D5268-07 | pipe ends. | plasticity index to be under 55%. No stones more than 25mm size within 150mm of services. | |
| Any Specification detail not in this Landscape Specification is to be taken from the Architectural Specification, then taken from other <i>documents</i> as appropriate. | Standard Spec for Topsoil'. Potting Mix to comply with AS 3743. Soil | Anchor Blocks: In-situ concrete, to pipe junctions & changes of grade or direction. | Fill under roads & paved areas & within 4000mm of structures to be coarse | |
| This Landscape Specification <u>must</u> be read with the Architectural Specification | conditioner to AS 4454 'Composts, Soil Conditioners & Mulches'. | Before backfilling or concealing, conduct air or water pressure tests to AS 3500. Test each run or line, UDO. Clean & flush the stormwater system. | sand, controlled low strength material or 'B' grade fine crushed rock. Compact | |
| including common SECTIONS 1 Preliminaries, 2 Fixing & Sealing, & 3 Metalwork. | | Subsoil Slotted Pipe/Cell Drainage: <i>Provide if required</i> for drainage. <i>Min</i> area = to | to achieve 95% solidified compaction test as per AS 1289 at optimum moisture content. | |
| Maintenance & Establishment Refer to the Soft Landscaping SECTION of this Landscape Specification for | <i>provide</i> high performance lightweight soil mix. Test both imported & <i>Site</i> obtained topsoil & potting mixes to <i>AS</i> 1289 (Methods | a 100mm dia pipe to AS 2439, geotextile fabric (to AS 3706) wrapped (no soil to | Fill In Topsoil Areas: Compact to <i>min</i> equal to that of adjacent | |
| detail of soft landscaping maintenance & establishment. | of Testing Soil) & AS 3743. Provide 1 test per 10 m ³ . Provide Soil Supplier Test | enter the system), laid to fall, run in free draining granular fill (eg 5-10mm gravel) which is also geotextile fabric wrapped, connected to the stormwater system. | | |
| Maintain & establish all Work after Practical Completion for 12 months at 1 Month | Compliance Certificate. | Provide drains behind all retaining walls at wall base. Min depth 250mm below | 3 SOFT LANDSCAPING | |
| ntervals. Immediately make good to any <i>Work</i> of which quality has become less | Topsoil to contain organic matter 6-8% by mass & have sandy loam texture to AS 4419. | finished surface. | | |
| han that <i>documented.</i> SUBMIT inspection log immediately after each inspection. | Soil organic matter to be 6-8% by mass. | Prevent erosion, contamination & sedimentation of Site/adjacent | 1 GENERAL | |
| | Imported topsoil mix to comply with the following: | areas/stockpiles/drainage systems. Keep <i>Works</i> free of ponding water. Maintain surfaces/excavations/drains to allow | 1.1 GENERAL Provide Work as per this SECTION & as doc elsewhere. | |
| | -Contain organic matter which supports plant life. | drainage. Do not place materials, <i>including</i> fill, on water logged ground. Prevent | | |
| 2 GROUND WORKS | -Components to be evenly distributed throughout the mix. -Mixes to be mechanically screened prior to despatch using screen size: | water flow over new Work. Obtain relevant Statutory Authority approvals. | 1.2 REFERENCED DOCUMENTS | |
| | <25mm. | | Cross References | |
| | -The mix is to be moist but still free flowing & of such moisture content that | 2 EXECUTION | Read with Architectural Specification SECTIONS 1 Preliminaries, 2 Fixing & Sealing, 3 Metalwork & all related SECTIONS & other documents. | |
| 1 GENERAL | water cannot be squeezed from it by hand. -Material to be void of ingredients which display high shrinkage tendencies. | 2.1 EXECUTION COMMON DETAIL | For detail in this specification of the following, refer: | |
| 1.1 GENERAL | -Free of acrid odours (<i>including</i> those caused by excessive ammonia or | General | -Excavation – Ground Works SECTION. | |
| Provide Work as per this SECTION & as doc elsewhere. | organic acids), chemicals & toxins detrimental to plants & human touch contact. | Read with Architectural Specification SECTIONS 1 Preliminaries, 2 Fixing & | -Topsoil – Ground Works SECTION. | |
| | -Free of stones, clay lumps, weeds and weed propagules <i>including</i> Cyperus | Sealing, 3 Metalwork. Refer Sub-SECTION 2 'Materials' (above), for <u>specific</u> material execution detail. | Standards Provide to documented A/O Standards including associated Parts, if those Parts | |
| 1.2 REFERENCED DOCUMENTS Cross References | Rotundus (nut-grass tubers), tree roots, sticks, rubbish, sharp items & other foreign matter. | Control weeds by non-chemical means. Mow grassed areas to height <i>min</i> 75mm | are <i>Work</i> related. Refer also the Architectural Specification Preliminaries | |
| Read with Architectural Specification SECTIONS 1 Preliminaries, 2 Fixing | -Free of pests and diseases such as pathogenic organisms e.g. Phytophthora | & <i>max</i> 200mm. | SECTION, Sub-SECTION 1, Clause 'Referenced Documents (RD)'. | |
| & Sealing, 3 Metalwork & all related SECTIONS & other documents. | spp and the larval stage of insect pests. | NOTIFY upon un-doc or un-expected ground work discoveries including cavities, water, rock, contaminated or hazardous materials, land-fill, archaeological | 1.3 INTERPRETATION | |
| For detail in this specification of the following, refer: | SUBMIT 1 kg sample of imported of test-passed topsoil & 1 kg of test-passed potting mix with the Soil Supplier Test Compliance Certificate. | materials. | Refer Architectural Specification Preliminaries SECTION, Sub-SECTION 1, for | |
| -Fertilizer – Soft Landscaping SECTION. - Mulch – Soft Landscaping SECTION. | SUBMIT detail of soil additives. | External surfaces to fall away from buildings & structures. NOTIFY to confirm falls | definition of <i>italicized</i> text. | |
| Standards | Topsoil Spreading | if they are not <i>doc</i> . | | |
| Provide to documented A/O Standards including associated Parts, if those Parts | Topsoil to grassed and turfed areas: 100mm (<i>min</i>) thick. | NOTIFY on finding a hazardous material which <i>include</i> : Refer Architectural Specification Preliminaries SECTION, Sub-SECTION 4 | 1.4 INSPECTION & TESTING Refer Architectural Specification Preliminaries SECTION, Sub-SECTION 4 | <u>COPYRIGHT:</u> ALL WORK IS TO COMPLY WITH THE BUILDING CODE OF |
| are <i>Work</i> related. Refer also the Architectural Specification Preliminaries SECTION, Sub-SECTION 1, Clause 'Referenced Documents (RD)'. | Topsoil to planting areas: 300mm (<i>min</i>) thick (add 75mm to this <i>min</i> thickness for planting area crown). | 'Building Work' for more execution detail. | 'Inspection & Testing'. Refer also Specification text. SUBMIT results of tests & | AUSTRALIA, RELEVANT AUSTRALIAN STANDARDS & LOCAL AUTHORITY REQUIREMENTS. |
| SECTION, Sub-SECTION 1, Clause Relefenced Documents (ND). | Crown topsoil in planting areas. | | inspections. NOTIFY for inspection of: | BUILDING CONTRACTOR & ALL RELEVANT SUB TRADES |
| 1.3 INTERPRETATION | Lightly consolidate topsoil to a smooth surface, free from lumps of soil and roots, | 2.2 GEOTECHNICAL TESTING | -Plants at Nursery ready for delivery to <i>Site</i> . -Plant materials delivered to the <i>Site</i> . | TO CHECK & VERIFY ALL DIMENSIONS & ASSOCIATED DRAWING PARTS PRIOR TO MANUFACTURE, |
| Refer Architectural Specification Preliminaries SECTION, Sub-SECTION 1, for | ready for planting. Progressively layer (max 100mm compacted thickness) & tamp topsoil to prevent | Test (as <i>doc, min</i> 2 tests) excavations, fill, <i>subbases</i> & <i>Bases</i> to <i>AS</i> 3798 by a <i>NATA</i> registered Geotechnical Test Authority. Test against requirements for | -Grassing bed prepared prior to turfing or seeding. | CONSTRUCTION & INSTALLATION ON SITE. DO NOT SCALE OFF DRAWINGS - WRITTEN DIMENSIONS TAKE |
| definition of other <i>italicized</i> text. -Bad ground: Includes ground contaminated, soft, liable to subside, containing | voids & subsidence. Prevent excess compaction. | intended use as determined by the NATA Certifier. | -Garden bed/grassed area edge set-out. | PRECEDENCE. PLAN LAND ACCEPTS NO LIABILITY OR RESPONSIBILITY |
| cavities/faults/fissures. | Add topsoil (including during the Defects Liability Period) to bring subsided topsoil | SUBMIT Geotechnical Engineer certification of completed formation & ground | -Planting set out before planting. | RESULTING FROM BUILDERS NEGLECT OR PREFERRED |
| -Base: One or more layers of material on which surface pavement may be | back up to <i>doc</i> levels. | bearing capacity (both natural & fill) is as <i>doc</i> or adequate to support building | -Planting start. -Staking and tying completed. | METHOD OF CONSTRUCTION FOR ANY BUILDING DEFECT. |
| placed, composed of either, fine crushed <i>rock</i> , natural gravel, broken stone, | 1.1 CULTIVATION | loads. Proof roll all excavations (except trenching), fill, subbases & Bases, to determine | -End of establishment period. | THESE DRAWINGS ARE THE PROPERTY OF PLAN LAND. DRAWINGS ARE NOT TO BE REPRODUCED IN PART OR |
| stabilised material, asphalt or concrete. -Formation: Surface of the finished earthworks, excluding batters & | Cultivate to loosen the existing ground to receive topsoil. | extent of <i>bad ground</i> as <i>advised</i> by <i>NATA</i> registered Geotechnical Test Authority. | | IN WHOLE ON ANY MEDIUM WITHOUT THE WRITTEN PERMISSION OF PLAN LAND. |
| subbase/Base. | Cultivation depth for grassed areas: 150mm deep. | Remove & reinstate bad ground. | 1.5 SUBMISSIONS Refer items written SUBMIT, in text. Refer Architectural Specification | NOTE |
| -Line of influence: A line extending down & out approx 45 deg from footing/slab | Cultivation depth for plants & planting areas: 300mm deep. Break-up cultivated earth so that pieces are less than 50mm. Remove stones | 2.3 SITE CLEARING & EXCAVATION | Preliminaries SECTION, Sub-SECTION 5. | NOTE: ALL EXISTING & OVERALL DIMENSIONS ARE NOMINAL |
| bottom outside edge, defining the extent of foundation material supporting the footing or slab. To be confirmed by a Geotechnical <i>Engineer</i> . | exceeding 50mm, and any other deleterious material from cultivated earth | Site clear as doc, as min for Work. Dispose of off-Site, excess excavations, | | & SUBJECT TO VERIFICATION ON SITE. WHERE ANY DISCREPANCY OCCURS BETWEEN NEW WORK & |
| <i>-Rock</i> : Monolithic material, pre-excavation (in-ground) volume more than | including roots, sticks, weeds. | rubbish, grass, vegetable/ | 2 MATERIALS | EXISTING BETWEEN NEW WORK & EXISTING DIMENSIONS - EXISTING DIMENSIONS/WORK SHOULD |
| 1.5m ³ , which can't be removed until broken up by percussion tools. | | organic debris, stumps, rocks/rubble & disused built elements, <i>including</i> slabs, | 2.1 MATERIAL COMMON DETAIL | TAKE PREFERENCE WHERE NECESSARY - OTHERWISE |
| -Subbase: The material laid on the subgrade below the Base to make up | 1.2 BULK FILL Bulk fill may be imported or obtained from Site. | footings, paving, <i>UDO</i> . In areas to be cleared & where <i>doc</i> to remove trees/plants, remove stumps & | 2.1 MATERIAL COMMON DETAIL Read with Architectural Specification SECTIONS 1 Preliminaries, 2 Fixing | NOTIFY PLAN LAND NOTE: |
| additional thickness, to prevent <i>subgrade</i> intrusion into the <i>Base</i> & to transfer odd to the <i>subgrade</i> . | Material Records: SUBMIT Supplier name, material detail & source. SUBMIT | remove roots over 15mm <i>dia</i> within 200mm below ground surface. Backfill | & Sealing, 3 Metalwork. | SELECTED TERMITE PROTECTION TO BE USED ON SITE IN ACCORDANCE WITH LOCAL COUNCIL'S |
| -Subgrade: The prepared portion of the formation on which the subbase then | NATA Registered Laboratory Certificate, including test results, certifying material | grubbing holes with sandy loam, compacted to the relative density of the adjacent | Provide plant life in healthy condition, without scarring or deformations. | REQUIREMENTS, B.C.A. AND ALL RELEVANT AUSTRALIAN STANDARDS |
| Base, is constructed. | compliance with intended use as determined by the NATA Certifier. <i>Min</i> 1 test per 50m ³ , <i>min</i> 2 tests. | ground. Terme regility at a skin to be skin to see the Mark and the Mark and the Mark and the Mark and the State of the | Establish plant life for optimum growth for the environmental conditions. | NOTE: |
| | Remove materials that will prevent satisfactory filling. Do not <i>provide</i> fill with | Temporarily stockpile on-Site topsoil excavated from the Work area, UDO. Remove excess excavations from Site. | Continuously <i>Work</i> to keep plant life free of disease, and free of plant (weeds) & animal pests. Immediately replace failed planting. | SMOKE DETECTORS TO COMPLY WITH REQUIREMENTS OF SPECIFICATION E1.7 (NSW) FIRE AND SMOKE ALARMS |
| 1.4 INSPECTION & TESTING Refer Architectural Specification Preliminaries SECTION, Sub-SECTION 4 | sulphur content exceeding 0.5%. Max rock & lump size: 2/3 compacted layer | Do not use explosives. | Refer Architectural Specification Preliminaries SECTION, Sub-SECTION 3 | SHALL COMPLY WITH AS 3786 AND BE CONNECTED TO THE MAIN POWER SUPPLY. |
| Inspection & Testing'. Refer also Specification text. SUBMIT results of tests & | thickness. | Excavation Tolerance: +0 -20mm. Finish self-draining, no ponding, scraper blade | 'Materials' for more materials detail. | NOTE: LOCATION OF SMOKE ALARMS IN ACCORDANCE WITH |
| nspections. NOTIFY for inspection of: | Do not fill with: a) organic soils, top soil, silt or silt-like materials, b) | finish to even plane. Record excavation & fill quantities, <i>including rock</i> quantities by Licensed Surveyor. | 2.2 RELATED SPECIFICATION DETAIL | CLAUSE 3.7.5.2 OF THE NCC. |
| -Initial set-out of paving, garden beds, features, structures. -Services laid in trenches, ready for backfilling. | worked or wet, c) fill containing contaminants, wood, metal, plastic or other | Pre-excavation (in-ground) volume applies for excavation measurement. | *** Refer to this page header note*** | NOTE: STAIRWAY TO HAVE A NON-SLIP FINISH OR NOSING |
| -Completed excavation, ready for laying of subsequent materials. | deleterious, organic or perishable material. | Rock Excavation: No Contract variation given for rock excavation. | | STRIP IN ACCORDANCE WITH CLAUSE 3.9.1.4 AND TABLE 3.9.1.3 OF THE NCC. |
| -Completed proof roll of subgrade before filling. | Spray water to obtain moisture content, uniformly in controlled quantities over uniform lane widths. | Compact excavations/formations. Test finished excavations: Min 1 test per 200m ² . | 2.3 MULCH | NOTE: METHOD OF VENTU ATING THE LAUNDRY AND WC AND |
| -Fill completion. -Cultivated ground ready for topsoil. | Do not place material or equipment on surfaces weakened by moisture. | Refer 'Geotechnical Testing' above. If excavation exceeds required depth, deteriorates or has <i>bad ground</i> removed, | <i>Provide</i> mulch to AS 4454 'Composts, Soil Conditioners & Mulches'. Mulch to be free of deleterious and extraneous matter <i>including</i> soil, weeds, sticks, roots. | CONTROLLING CONDENSATION IN ACCORDANCE WITH CLAUSES 3.8.5.2 & 3.8.7.3 OF THE NCC. |
| -Outivated ground ready for topsoll. | Commence compacting close to structures & compact away from structures. | reinstate to doc depth & bearing capacity. Prevent void formation. Fill & compact | Mulch to be sieved to size to prevent accumulation of mulch fines. | CERCIES 3.6.3.2 & 3.6.7.3 UP THE NUC. |
| 1.5 SUBMISSIONS | Batter Faces: Compact separately or overfill & cut back. Form roughened | voids to match surrounding material. | SUBMIT 1 kg samples of each mulch type. | Project: |
| Refer items written SUBMIT , in text. Refer Architectural Specification | surfaces. Test completed fill: 1 test per layer per 200m ² . Refer 'Geotechnical Testing' | Provide temporary excavation support & remove when not required. Provide temporary then permanent excavation support below line of influence as | Spread mulches evenly to a <i>min</i> depth of 100mm, <i>UDO</i> . Grade the finished | 34 Lang Street, |
| Preliminaries SECTION, Sub-SECTION 5. SUBMIT also: | below. | <i>doc.</i> If not <i>doc</i> , allow this support as <i>advised</i> by the Geotechnical <i>Engineer</i> & | surface events. I to not place mulch in contact with stome of plants | Mudgee NSW 2850 |
| -Erosion & Sediment Control Plan. | Lay in 200mm finished layers. Mix fill uniformly. Place fill in near-horizontal layers | NOTIFY. | 2.4 CHEMICALS | Client: |
| | of uniform thickness, systematically deposited. Do not feather edges at junctions | | SUBMIT a Schedule of proposed chemicals to be used in landscape | |
| 2 MATERIALS | of fill & existing surfaces. | 2.4 TRENCHING General | construction & maintenance including additives, pesticides, herbicides, un-doc | |
| 2.1 MATERIAL COMMON DETAIL | 1.3 PAVEMENT BASE & SUBBASE | Excavate trenches: a) to uniform grades, b) in straight lines between | fertilizer, disease treatments. | Drawing: |
| Read with Architectural Specification SECTIONS 1 Preliminaries, 2 Fixing | Extent: Provide under pavements. | pits/inspection points/junctions, c) sides stable & supported, d) widths <i>min</i> & | 2.5 FERTILIZER | Landscape |
| & Sealing, 3 Metalwork. | Material Records: SUBMIT Supplier name, material detail & source. SUBMIT NATA Registered Laboratory Certificate, <i>including</i> test results, certifying material | consistent, e) clean, no projections, no obstructions, no water, f) with a firm base. | I Deliver tertilizer to Site in sealed bads, branded with the tertilizer type X. | - |
| Pedestrian/vehicle surfaces & their edges (nosing) to be slip-resistant. | compliance with intended use as determined by the NATA Certifier. <i>Min</i> 1 test per | Cut tree roots within 600mm of services. No access over open trenches. Over-excavation: Reinstate to correct depth & bearing value using compacted | Manufacturer name. | Specifications |
| Provide anti-tamper fixings as per Architectural Specification Fixing & Sealing SECTION. | 50m ³ , <i>min</i> 2 tests. | bedding material or sand stabilised with 1 part of cement to 20 parts of sand by | 2.6 TURFING | |
| Refer Architectural Specification Preliminaries SECTION, Sub-SECTION 3 | Base & Subbase: Crushed rock or natural gravel. SUBMIT NATA Registered | weight. | Turf to be comprised of consistently thick grass & root (fully soiled) parts. Grass | |
| Materials' for more materials detail. | | Trenches open for <i>min</i> time. Backfill as soon as possible after service laid & badded if possible same day. Place backfill in layers may 150mm compacted | part to be 20mm thick, root part to be 25mm thick. | newton teale consulting pty ltd ABN: trading as plan land 62 128 716 334 |
| | | bedded, if possible, same day. Place backfill in layers max 150mm compacted thickness. | Evenly mix fertilizer into the topsoil before placing the turf. Lay turf within 24 hours of cutting. Prevent turf from drying out between cutting | PO BOX 495 Gymea NSW |
| | 1 | | | Phone: 0403 993 876 Email: info@planland.com.au |
| rPLAN ₁ | | | | Drawn: Approved: Date: |
| | | | | LT LT OCT/2022 |
| | | | | Scale: Drawing No.: Sheet No.: Rev.: |
| | | | | 1:1@A3 22113 DA 7.3 |

| . г | | | | | | | | | | | |
|------------|------------------------------------|---|--|-----------------------------|--------------|--|--|--------------------------|--|-----------------------|--|
| | and laying. | | | Thoroughly water | plants in | mediately before | planting. Thoroughly | water the | | 1.1 | THE IRRIGATION SYSTEM |
| | | | ed, butt joints. Immediately after laying, | planting hole imme | | | | | | General The system | n will be comprised of: |
| | | m roller. Fill joints & c evenly tamp the turf. | depressions with topsoil. On slopes | Bemove plants fro | | | loss & root disturban | ice. Lightly | 1 GENERAL | • | Water piping & connection to a p |
| | | | e spray so that the soil is moist to a | | | | s. Set plants plumb & | k at a level for | | | instructed), pressure rating of mi |
| | depth of 100mm. | | | natural relationship | o of the p | plant with the grou | nd surface. | | 1.1 GENERAL | ! • | Electrical cabling (in conduits) & supply. |
| | | | de falls evenly. Turf surface to be | Backfill with topso | il to be fii | m around the plai | nt without air pockets | . Dish the soil | 1.2 REFERENCED DOCUMENTS | | Controllers. |
| | smooth & consistent | | bove soil level, remove cuttings & top | | | | er to match pot diam ertilizer around plants | | Cross References | • | Valves (including RPZ, isolating, |
| | | | oints and correct surface unevenness. | planting. | protong | led release type le | | at the time of | Read with Architectural Specification. | | 2845) prevention) & valve boxes. |
| | | | ninimum of 10 g/m2 of sulphate of | | /er 2000 | mm tall at maturity | , vertically embed in | the backfill, a | Standards | | Water delivery outlet devices (spi Automatic rain switching (sensor |
| | | ver the whole of the ar | | | | | otted agricultural drai | | Provide to documented A/O Standards including associated Parts, if those Parts are Work related. Refer also the Architectural Specification Preliminaries | ľ | rainfall obstructions). |
| | height of 30mm. | ablished, mow at regu | lar intervals to maintain an average | Place mulch to 50 | | | as a deep watering | mechanism. | SECTION, Sub-SECTION 1, Clause 'Referenced Documents (RD)'. | • | Separate programmable stations |
| | | eds that emerge in the | e turfed areas. Where necessary spray | Commence planti | | | | | | | irrigation zones. |
| | with a selective broa | d leaf weed herbicide | | If unforeseen plan | ting dela | y occurs, transpla | nt plants into larger p | | 1.3 INTERPRETATION | · | Cabinets, access/valve/housing tagged keys per lock. |
| | Tolerance: Max 15r | mm under a 3000mm | straight edge any direction. | 1 1 | suitable v | weather conditions | s <i>including</i> extreme h | eat, cold, wind, | Refer Architectural Specification Preliminaries SECTION, Sub-SECTION 1, for definition of <i>italicized</i> text. | | Access/valve/housing boxes to b |
| | 2.7 GRASS | SEEDING | | rain. | off Sitor | alant quantitios to | allow for on-Site plan | t failuras ta | | | anticipated traffic loads. |
| | | | with product & Supplier name. | avoid delay. | 011-3/10 1 | | | | 1.4 INSPECTION & TESTING | The system | |
| | | | purity, of <i>min</i> 85% germination | | lying plaı | nts up to the end o | of the Defects Liability | y Period. | Refer Architectural Specification Preliminaries SECTION, Sub-SECTION 4 | ! • | Weather resistant & components resistant. |
| | | | ertificate of these seed characteristics. | Replace damaged | plants u | p to Practical Cor | npletion. | | 'Inspection & Testing'. Refer also Specification text. SUBMIT results of tests & | | Concealed except for valve box l |
| | Sow seeds for even cover seeds. | spread by mechanica | al means. Lightly rake seeds into soil to | Transplanting | lonting [| lon including one | rational detail, timing | hall diamator | inspections. NOTIFY for inspection of: - Irrigation system set-out. | | devices, access panels to compo |
| | | dermination at 3 wee | eks after sowing will be deemed | | | | , watering program, p | | - Trenching. | | access. Concealment is under-g |
| | | | rass coverage at 12 weeks after | monitoring. NOTI | | | | ant noutri | - Fully test the completed system over a 7 day period including a | | Underground piping location to a marker tape installed <i>min</i> 150mm |
| | | ed seeding failure. R | eplace failed seeded grass with Site | Use only nylon en | | | | | pressure testing. | Exposed to | to view components to be in garde |
| | delivered turf. | lad grass to be nomin | ally 50mm high may 20% off groop | | | | ssible with holes and | | - Completed system to be inspected by an Hydraulic <i>Engineer</i> & an Electrical <i>Engineer</i> . | | irrounding land profiles (except for |
| | height in a 2 week p | | ally 50mm high, <i>max</i> 30% off grass | time of extraction. | | arry out the plantin | ig procedure, ready & | x prepared at | | outlet devic | |
| | | | straight edge any direction. | Stakes & Ties | | | | | 1.5 SUBMISSIONS | | rrigation <i>Works</i> shop drawings clos |
| | | | | | | | ive plant support. St | akes to be | Refer items written SUBMIT, in text. Refer Architectural Specification | to resolve (| coordination issues as early as po Component Manufacturer advice |
| | 2.8 PLANTI | NG | | | | | pinted driving ends. | | Preliminaries SECTION, Sub-SECTION 5. SUBMIT also: | | List of local spare parts Suppliers |
| | Plant Quality | alanced branching fo | liage typical of their species for the | black, brown) which | | | neutral & natural colo | bur (le grey, | Shop drawings as described in 'Materials' below. Work as Executed drawings. | • | Proposed watering flow rates for |
| | season. | balanced branching to | hage typical of their species for the | | | | eutral & natural colou | ired wired-on | - Operation & Maintenance Manual. | · | Cabinet & box details (and rating |
| | | | ysiological disorder & nutritional | plastic safety caps | | | | | | : | Irrigation zones. Diagrams of water coverage of e |
| | | | evidence of any previous disorder. | | | | (ie opposite the likely | | 2 MATERIALS | | Electrical & Hydraulic Engineer |
| | | | containers in environmental conditions be planted, for <i>min</i> 42 days before | | | | venly apart & parallel itioned evenly apart v | | 2.1 MATERIAL COMMON DETAIL | • | Australian & New Zealand Stand |
| | Site delivery. | | be planted, for min 42 days before | | | | ikely pedestrian traffic | | Read with Architectural Specification SECTIONS 1 Preliminaries, 2 Fixing | · | Local Authority Regulations, Coc |
| | | in the sun are to be p | previously 'sun grown' or 'sun | Position stakes ou | tside of t | the topsoil zone pa | art of the planting hol | e. | & Sealing, 3 Metalwork. | Controller | Warranty details. |
| | | 2 days before Site de | | | | | exposed to view sta | ke. Tie also as | The irrigation system is to be a fully automatic system, either a proprietary | | s positioned at nominally 1600mm |
| | | pathogen free, weed | | required to straigh | | | support the plant, at t | he end of the | system, or an Electrical & Hydraulic Engineer Certified system made up of | • | 1 to 4 start times per day. |
| | | uitable for transplantat | d, well-proportioned in relation to the tion | Defects Liability Pe | | liger required to a | support the plant, at t | | <i>proprietary</i> components. It is to supply water to all plant life which is part of the <i>Work</i> , at a rate & consistency to promote that plant life health. | · | Timer settings to cover a 24 hour |
| | | | ant by botanical name, common name | Stakes to comply | | following table, <i>UL</i> | 00: | | The irrigation system is to be designed & installed by a specialist Irrigation | | minute timings. Program to cater for changes in |
| | & characteristics. | | 6 | Plant Height (at time | Stake | Stake Size (mm) & | Stake In-ground Depth/ | Ties | Subcontractor. SUBMIT proposed Irrigation Subcontractor details of experience | | Ability to separately program eac |
| | | | crown foliage symmetry. SUBMIT t (at Contractors expense) that plant | of planting - mm) | Number | Туре | Exposed Height (mm) | | & capability. | • | Pump/master valve circuit. |
| | | mpliant with that docu | | 0-300 300-600 | 1 | 25x25 HWD 25x25 HWD | 150/200 200/400 | Plastic Plastic | Refer Architectural Specification Preliminaries SECTION 'Hardware & Operational Components' and 'Motorized Components'. | • | Battery back-up support for pow |
| | Plant Containers | | | 600-900 | 2 | 25x25 HWD | 250/700 | Plastic | Provide anti-tamper fixings as per Architectural Specification Fixing & Sealing | · | Manual or semi-manual over-ride |
| | | | d polypropylene containers or | 900-1500 | 2 | 38x38 HWD | 300/1000 | Plastic | SECTION. | 2 | EXECUTION |
| | polythene bags of po | otting media volumes, | sized as follows, UDO: | 1500-1800 | 3 | 50x50 HWD | 400/1200 | Plastic | Refer Architectural Specification Preliminaries SECTION, Sub-SECTION 3 | | |
| | 1000 0 0000 00 00 | | | 1800-2400 2400-3600 | 3 | Steel star picket Steel 65x 65 RHS in | 600/1800 | Steel rope Steel rope | 'Materials' for more materials detail. | 2.1 | EXECUTION COMMON DETAIL |
| | Height (mm) | Pot Diameter (mm) | Potting Media Volume (litres dry) | 2400-3600 | 3 | concrete footing | 600/1600 | Steerrope | 2.2 RELATED SPECIFICATION DETAIL | | Architectural Specification SE |
| | 150 200 | 140 200 | 2 | Over 3600 | 3 | To Engineer advice | To Engineer advice | To Engineer | *** Refer to this page header note*** | | , 3 Metalwork. Refer Sub-SECT aterial execution detail. |
| | 300 | 300 | 13 | Plastic ties: Proprietary | ties | | | advice | | | omprehensive personal instruction |
| | 400 | 400 | 45 | Steel rope ties: 3mm dia | a galv steel | wire rope, cut ends stee | el clamped, turnbuckle tensi | on adjustment, | | the irrigatio | on system by an experienced Irriga |
| | 450 | 400 | 76 | plastic guards against to | unk, the loo | op <i>dia</i> around trunk to b | e 3 times the <i>dia</i> of the trun | c at that tie point. | | | to include physical on-Site demor |
| | 500 | 500 | 104 | 1.1 MAIN [.] | TENANO | E & ESTABLISH | IMENT | | | | em in conjunction with referring to SUBMIT proposed instructional pro |
| | | | | | | | ce Document is to be | part of the | | | vered by the irrigation system is no |
| | Planting | | | Contract, this can | be refer | red to here & the | following text edited | or deleted as | | | on non-soft landscaping areas & n |
| | | | ws the following <i>min</i> amount of | | Mainten | ance or establish | ment is different fron | n the Defects | | | outside of the area of planting. |
| | topsoli backili benea | ath & around the plant | t root system, <i>ODO</i> : | Liability Period] | | sa 'Maintonanco A | & Establishment' in th | o Proliminarios | | | hitectural Specification Prelimin g Work' for more execution deta |
| | Plant Height at tim | ne of planting | Thickness/depth of topsoil | SECTION of this I | | | | | | | g work for more execution det |
| | (excluding the roo | | around the root ball | | | | all soft landscaping w | hich <i>includes</i> : | | | |
| | 0-300 | | 100 | | | izing, pest & disea | | | | | |
| | 300-500 | | 150 | | | ing, aerating, remo | | o maintain | | | |
| | 500-1000 | | 200 | | | or remove damag | on of pruning being t ied arowth. | | | | |
| | 1000-2000 | | 250 | | | ikes & ties. | | | | | |
| | 2000-2500 | | 350 | Replace | cing dam | aged or failed pla | | | | | |
| | | | 4 | Top di SUBMIT detail of | | | / re-topping, mulch m | aintenance. | | | |
| | 2500-3000 | | 450 | | | it replacement. | | | | | |
| | Over 3000 | | 550 | | urgery V | | | | | | |
| | | | | | icals to b | | | | | | |
| | | | | 2 EVEO | UTION | | | | | | |
| | | | | 1 3 FXFC | | | | | | 1 | |

3 EXECUTION

EXECUTION COMMON DETAIL 3.1

Read with Architectural Specification SECTIONS 1 Preliminaries, 2 Fixing & Sealing, 3 Metalwork. Refer Sub-SECTION 2 'Materials' (above), for specific material execution detail.

Refer Architectural Specification Preliminaries SECTION, Sub-SECTION 4 'Building Work' for more execution detail.



a primary or central supply (as doc or *min* 1033 Kpa.) & connection to the electrical mains

ng, control & back-flow (to AS/NZS

(sprinklers, drippers, sprayers). sors positioned free of overhead

ons & programmable to the different ng boxes & panels to be lockable, 3

to be *min* heavy duty suitable for the

ents are to be highly corrosion

ox lids, controllers, water delivery outlet mponents requiring maintenance er-ground or within structures.

to be identified using underground mm above pipes.

rden beds where possible & be flush for garden bed raised water delivery

close to the start of the Head Contract possible. Shop drawings to include: vice & specifications.

liers & availability of spare parts.

for the 4 seasons.

tings for traffic loads if applicable).

of each water delivery outlet device. er Design Certification.

andards compiled with.

Codes & Guidelines complied with.

nm above FFL. Controllers to include:

nour day, 7 days a week, settings to

in setting for the 4 yearly seasons. each irrigation zone.

ower failure (solid state). ride provision.

TAIL

SECTIONS 1 Preliminaries, 2 Fixing CTION 2 'Materials' (above), for

ion to the Owner on the operation of rigation Installation Technician. monstration

to the Operation & Maintenance program details.

not to create run-off or erosion, and is not to fall on non-soft landscaping

minaries SECTION, Sub-SECTION detail.

COPYRIGHT: ALL WORK IS TO COMPLY WITH THE BUILDING CODE OF AUSTRALIA, RELEVANT AUSTRALIAN STANDARDS &

AUSTRALIA, RELEVANT AUSTRALIAN STANDARDS & LOCAL AUTHORITY REQUIREMENTS. BUILDING CONTRACTOR & ALL RELEVANT SUB TRADES TO CHECK & VERIFY ALL DIMENSIONS & ASSOCIATED DRAWING PARTS PRIOR TO MANUFACTURE. CONSTRUCTION & INSTALLATION ON SITE. DO NOT SCALE OFF DRAWINGS - WRITTEN DIMENSIONS TAKE PRECEDENCE. PLAN LAND ACCEPTS NO LIABILITY OR RESPONSIBILITY RESULTING FROM BUILDERS NEGLECT OR PREFERRED METHOD OF CONSTRUCTION FOR ANY BUILDING DEFECT.

DEFECT. THESE DRAWINGS ARE THE PROPERTY OF PLAN LAND.

DRAWINGS ARE NOT TO BE REPRODUCED IN PART OR IN WHOLE ON ANY MEDIUM WITHOUT THE WRITTEN PERMISSION OF PLAN LAND.

NOTE: ALL EXISTING & OVERALL DIMENSIONS ARE NOMINAL & SUBJECT TO VERIFICATION ON SITE. WHERE ANY DISCREPANCY OCCURS BETWEEN NEW WORK & EXISTING BETWEEN NEW WORK & EXISTING DIMENSIONS - EXISTING DIMENSIONS/WORK SHOULD TAKE PREFERENCE WHERE NECESSARY - OTHERWISE NOTE: NOTE:

NOTE: SELECTED TERMITE PROTECTION TO BE USED ON SITE IN ACCORDANCE WITH LOCAL COUNCIL'S REQUIREMENTS, B.C.A. AND ALL RELEVANT AUSTRALIAN STANDARDS

NOTE: SMOKE DETECTORS TO COMPLY WITH REQUIREMENTS SMOKE DETECTORS TO COMPLY WITH REQUIREMENTS OF SPECIFICATION EL7 (NSW) FIRE AND SMOKE ALARMS SHALL COMPLY WITH AS 3786 AND BE CONNECTED TO THE MAIN POWER SUPPLY.

NOTE: LOCATION OF SMOKE ALARMS IN ACCORDANCE WITH CLAUSE 3.7.5.2 OF THE NCC.


NOTE: STAIRWAY TO HAVE A NON-SLIP FINISH OR NOSING STRIP IN ACCORDANCE WITH CLAUSE 3.9.1.4 AND TABLE 3.9.1.3 OF THE NCC.

<u>NOTE:</u> METHOD OF VENTILATING THE LAUNDRY AND WC AND CONTROLLING CONDENSATION IN ACCORDANCE WITH CLAUSES 3.8.5.2 & 3.8.7.3 OF THE NCC.

34 Lang Street, Mudgee NSW 2850

Drawing: Landscape **Specifications**

| 1:1@A3 | 22113 | DA 7.4 | |
|------------|----------------------|---------------|-----|
| Scale: | Drawing No.: | | v.: |
| LT | LT | OCT/202 | 2 |
| Drawn: | Approved: | Date: | |
| | fo@planland.com.au | | |
| Phone: 04 | 03 993 876 | | |
| PO BOX 49 | 5 Gymea NSW | | |
| trading as | olan land | 62 128 716 33 | 4 |
| | e consulting pty ltd | ABN: | |

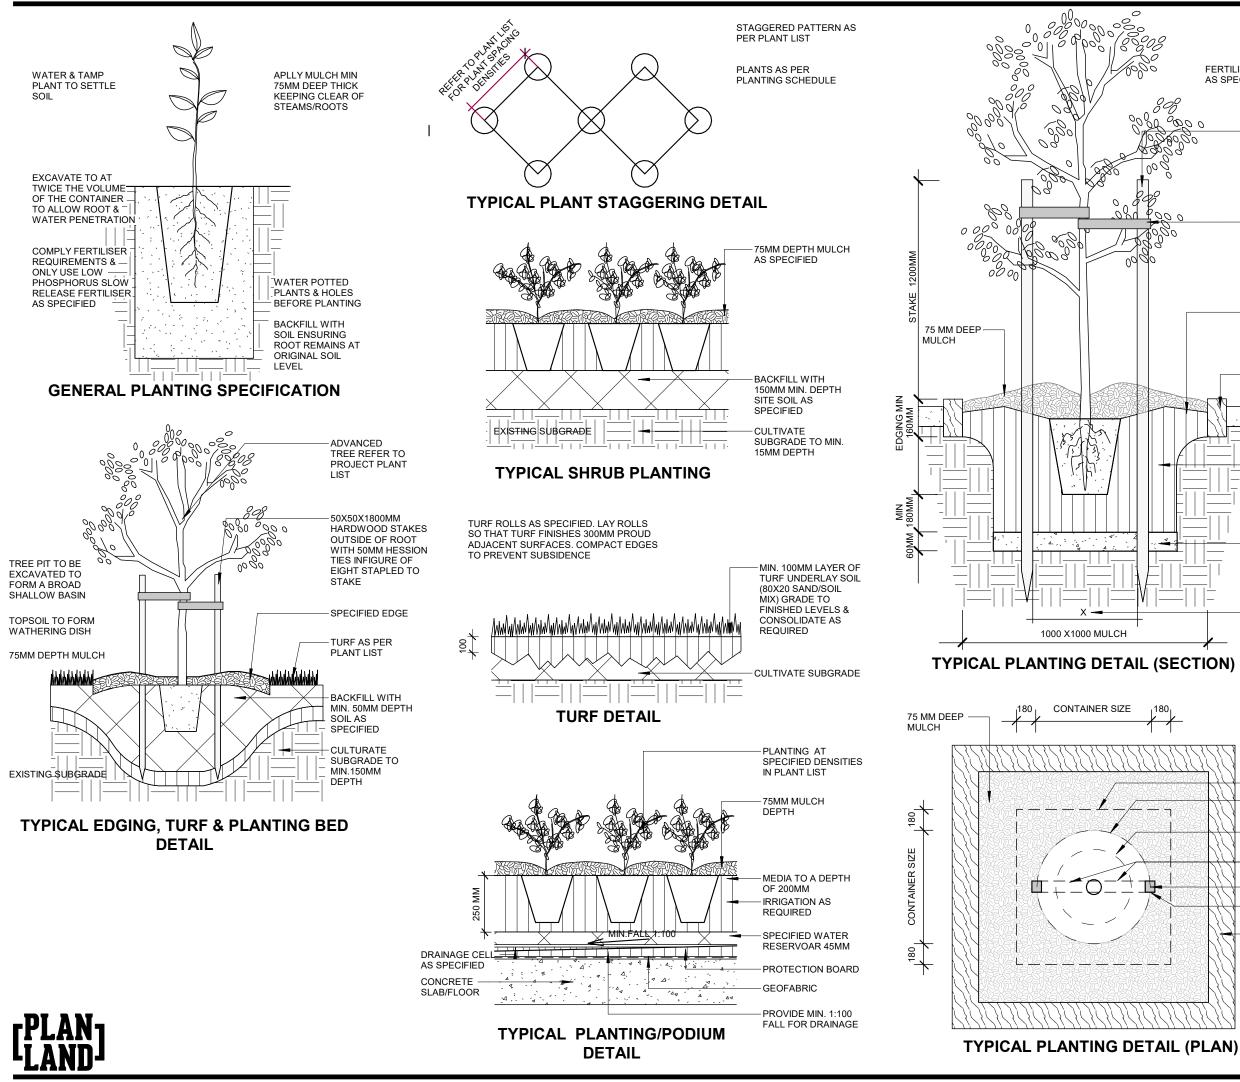

FERTILISER AT PLANTING AS SPECIFIED

| 00 | -MIN TWO OFF 38 | |
|--------------|--|--|
| 30 | X 38MM X 2.0M HIGHT POINTED HARDWOOD | |
| | STAKES | |
| | | |
| | -50MM WIDE JUTE MESH WEBBING | |
| | STAPLED/ FIXED TO STAKES | |
| | | |
| [| -160MM DEEP | |
| | TOPSOIL MIX. FORM SHALLOW | |
| | DISH TO HOLD WATER. | |
| | EDGING WHERE | |
| | PLANTING PIT | |
| | | COPYRIGHT: |
| | -COMPOSTED TOP | ALL WORK IS TO COMPLY WITH THE BUILDING CODE OF AUSTRALIA, RELEVANT AUSTRALIAN STANDARDS & LOCAL AUTHORITY REQUIREMENTS. |
| | SOIL AS REQURED | BUILDING CONTRACTOR & ALL RELEVANT SUB TRADES TO CHECK & VERIFY ALL DIMENSIONS & ASSOCIATED DRAWING PARTS PRIOR TO MANUFACTURE, CONSTRUCTION & INSTALLATION ON SITE. DO NOT |
| | | SCALE OFF DRAWINGS - WRITTEN DIMENSIONS TAKE PRECEDENCE. PLAN LAND ACCEPTS NO LIABILITY OR RESPONSIBILITY |
| +++= | -CULTIVATED SUB- | RESULTING FROM BUILDERS NEGLECT OR PREFERRED METHOD OF CONSTRUCTION FOR ANY BUILDING DEFECT. |
| <u>-</u> | BASE AS SPECIFIED | THESE DRAWINGS ARE THE PROPERTY OF PLAN LAND. DRAWINGS ARE NOT TO BE REPRODUCED IN PART OR IN WHOLE ON ANY MEDIUM WITHOUT THE WRITTEN PERMISSION OF PLAN LAND. |
| | | <u>NOTE:</u> ALL EXISTING & OVERALL DIMENSIONS ARE NOMINAL & SUBJECT TO VERIFICATION ON SITE. WHERE ANY |
| | - AS PER PLANT LIST | DISCREPANCY OCCURS BETWEEN NEW WORK & EXISTING BETWEEN NEW WORK & EXISTING DIMENSIONS - EXISTING DIMENSIONS/WORK SHOULD TAKE PREFERENCE WHERE NECESSARY - OTHERWISE |
| | | NOTIFY PLAN LAND NOTE: SELECTED TERMITE PROTECTION TO BE USED ON SITE |
| CTION) | | IN ACCORDANCE WITH LOCAL COUNCIL'S REQUIREMENTS, B.C.A. AND ALL RELEVANT AUSTRALIAN STANDARDS |
| | | NOTE: SMOKE DETECTORS TO COMPLY WITH REQUIREMENTS OF SPECIFICATION E1.7 (NSW) FIRE AND SMOKE ALARMS SHALL COMPLY WITH AS 3786 AND BE CONNECTED TO |
| | | THE MAIN POWER SUPPLY. <u>NOTE:</u> LOCATION OF SMOKE ALARMS IN ACCORDANCE WITH |
| 8888 | | CLAUSE 3.7.5.2 OF THE NCC. <u>NOTE:</u> STAIRWAY TO HAVE A NON-SLIP FINISH OR NOSING STRIP IN ACCORDANCE WITH CLAUSE 3.9.1.4 AND TABLE |
| | | 3.9.1.3 OF THE NCC. <u>NOTE:</u> METHOD OF VENTILATING THE LAUNDRY AND WC AND |
| | PLANT CENTERED ON PLANTING PIT | CONTROLLING CONDENSATION IN ACCORDANCE WITH CLAUSES 3.8.5.2 & 3.8.7.3 OF THE NCC. |
| | | Project: 34 Lang Street, |
| | — TIES | Mudgee NSW 2850 |
| | — STAKES | chenti |
| | | Drawing: Landsoana Datails |
| | | Landscape Details |
| | | |

| newton teal | e consulting pty ltd | ABN: |
|-------------|----------------------|------------------|
| trading as | olan land | 62 128 716 334 |
| PO BOX 49 | 5 Gymea NSW | |
| Phone: 04 | 403 993 876 | |
| Email: in | fo@planland.com.au | |
| Drawn: | Approved: | Date: |
| LT | LT | OCT/2022 |
| Scale: | Drawing No.: | Sheet No.: Rev.: |
| 1:1@A3 | 22113 | DA 7.5 |

| | | DOOR SCHEDULE | | | | | | |
|------|-------|---------------|--------------|--------------------|----------------|-----------------------------|--|--|
| MARK | WIDTH | HEIGHT | LEVEL | FROM ROOM: NAME | TO ROOM: NAME | DESCRIPTION | | |
| D01 | 900 | 2100 | 2.Ground FFL | New Kitchen/Living | | ENTRY DOOR | | |
| D02 | 820 | 2125 | 2.Ground FFL | New Kitchen/Living | New Bedroom | INTERIOR SINGLE HINGED DOOR | | |
| D03 | 720 | 2125 | 2.Ground FFL | New Kitchen/Living | New Bath/L'dry | INTERIOR SINGLE HINGED DOOR | | |
| D04 | 720 | 2125 | 2.Ground FFL | New Kitchen/Living | New Pantry | INTERIOR SINGLE HINGED DOOR | | |
| D05 | 1780 | 2180 | 2.Ground FFL | New Bath/L'dry | New Bath/L'dry | INTERIOR ACCORDION DOOR | | |

| GLAZING BASIX | | | | | | |
|---------------|--------|------|-------|--------|----------|------------------------------------|
| MARK | ASPECT | SILL | WIDTH | HEIGHT | AREA | EXTERIOR GLAZING DESCRIPTION |
| W01 | NE | 0 | 7900 | 2200 | 17.38 m² | SLIDING DOOR |
| W02 | NE | 0 | 2600 | 2200 | 5.72 m² | SLIDING DOOR |
| W03 | NE | 0 | 400 | 2200 | 0.88 m² | FIXED WINDOW |
| W04 | NE | 0 | 900 | 2200 | 1.98 m² | HUNG DOWN WINDOW |
| W05 | NE | 0 | 900 | 2200 | 1.98 m² | HUNG DOWN WINDOW |
| W06 | SW | 1600 | 1600 | 600 | 0.96 m² | AWNING/GLASS LOUVRE FROSTED WINDOW |
| W07 | SW | 1600 | 2245 | 600 | 1.35 m² | SLIDING WINDOW |
| W08 | SW | 1600 | 3000 | 600 | 1.80 m² | FIXED WINDOW |
| W09 | SW | 0 | 1600 | 2200 | 3.52 m² | SLIDING DOOR |
| Grand total: | 9 | | | | | |

| SKYLIGHT SCHEDULE | | | | | | |
|-------------------|----------------|-------|---------------------|--|--|--|
| MARK | HEIGHT | WIDTH | AREA | | | |
| S01 | 1400 | 800 | 1.12 m ² | | | |
| S02 | 1400 | 800 | 1.12 m ² | | | |
| S03 | 1400 | 800 | 1.12 m ² | | | |
| S04 | 1400 | 800 | 1.12 m ² | | | |
| S05 | 1400 | 800 | 1.12 m ² | | | |
| S06 | 1400 | 800 | 1.12 m ² | | | |
| S07 | 1400 | 800 | 1.12 m ² | | | |
| Grand total: 7 | Grand total: 7 | | | | | |



BASIX NOTES:

BASK NOTES: The applicant must install a rainwater tank of at least 2734 litres on the site. This rainwater tank must meet, and be installed in accordance with, the requirements of all applicative regulatory authorities or glazed door above which they are situated, unless the porgola allow of the more tank of the site. The spacing between batters must not be obtained and the site of the

COPYRIGHT: ALL WORK IS TO COMPLY WITH THE BUILDING CODE OF AUSTRALIA, RELEVANT AUSTRALIAN STANDARDS & LOCAL AUTHORITY REQUIREMENTS. BUILDING CONTRACTOR & ALL RELEVANT SUB TRADES TO CHECK & VERIFY ALL DIMENSIONS & ASSOCIATED DRAWING PARTS PRIOT TO MANUFACTURE, CONSTRUCTION & INSTALLATION ON SITE. DO NOT SCALE OF DRAWINGS - WRITTEN DIMENSIONS TAKE PRECEDENCE. PLAN LAND ACCEPTS NO LIABILITY OR RESPONSIBILITY RESULTING FROM BUILDERS NEGLECT OR PREFERRED METHOD OF CONSTRUCTION FOR ANY BUILDING DEFECT. THESE DRAWINGS ARE THE PROPERTY OF PLAN LAND. DRAWINGS ARE NOT TO BE REPRODUCED IN PART OR IN WHOLE ON ANY MEDIUM WITHOUT THE WRITTEN PERISSION OF PLAN LAND.

NOTE: ALL EXISTING & OVERALL DIMENSIONS ARE NOMINAL & SUBJECT TO VERIFICATION ON SITE. WHERE ANY DISCREPANCY OCCURS BETWEEN NEW WORK & EXISTING BETWEEN NEW WORK & EXISTING DIMENSIONS - EXISTING DIMENSIONS/WORK SHOULD TAKE PREPERENCE WHERE NECESSARY - OTHERWISE NOTF: NOTF:

NOTE: SELECTED TERMITE PROTECTION TO BE USED ON SITE IN ACCORDANCE WITH LOCAL COUNCIL'S REQUIREMENTS, B.C.A. AND ALL RELEVANT AUSTRALIAN STANDARDS

AUSTRALIAN STANDARDS NOTE: SMOKE DETECTORS TO COMPLY WITH REQUIREMENTS OF SPECIFICATION E1.7 (NSW) FIRE AND SMOKE ALARMS SHALL COMPLY WITH AS 3786 AND BE CONNECTED TO THE MAIN POWER SUPPLY. NOTE: LOCATION OF SMOKE ALARMS IN ACCORDANCE WITH CLAUSE 3.7.5.2 OF THE NCC. NOTE:

NOTE: STAIRWAY TO HAVE A NON-SLIP FINISH OR NOSING STRIP IN ACCORDANCE WITH CLAUSE 3.9.1.4 AND TABLE 3.9.1.3 OF THE NCC.

NOTE: METHOD OF VENTILATING THE LAUNDRY AND WC AND CONTROLLING CONDENSATION IN ACCORDANCE WITH CLAUSES 3.8.5.2 & 3.8.7.3 OF THE NCC.

Project

34 Lang Street, Mudgee NSW 2850 Client

Window & Door **Schedules**

| | consulting pty ltd | ABN: |
|---------------------|--------------------|-----------------|
| trading as p | an land | 62 128 716 334 |
| PO BOX 495 | Gymea NSW | |
| Phone: 0403 | 3 993 876 | |
| Email: info | @planland.com.au | |
| Drawn: | Approved: | Date: |
| LT | LT | OCT/2022 |
| Scale: | Drawing No.: S | neet No.: Rev.: |
| @A3 | 22113 I | DA 8.0 |





RECYCLED BRICK WALL: TO MATCH EXISTING



ROOF TILES:



COLORBOND STEEL MATT



DECK TILES





GLASS POOL FENCE


POWDER COATED WHITE ALUMINIUM DOORS/WINDOWS



| | - | | | | |
|---|---|---|--|--|--|
| | | | | | |
| | | - | | | |
| 2 | | | | | |
| | | | | | |
| | | | | | |
| | 7 | | | | |

SINGLE PANEL SLIDING



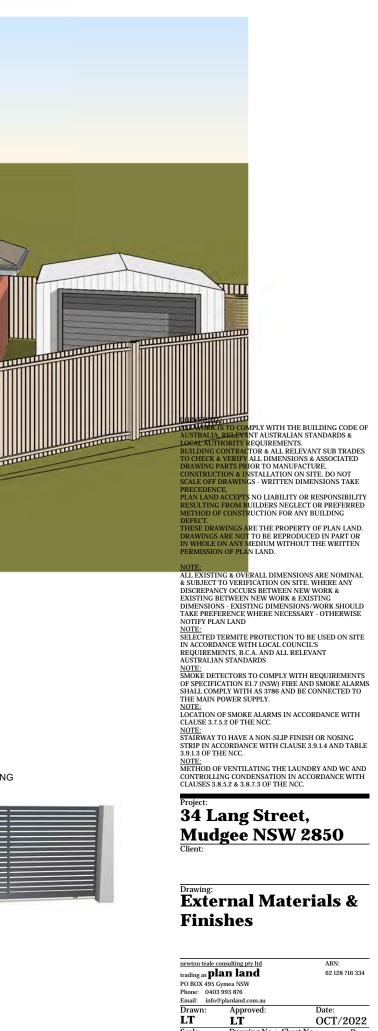

OCT/2022

Scale: Drawing No.: Sheet No.: 1:20@A3 22113 DA 9.1



PHASING LEGEND:

(Note: legend applies to building elements, not finishes)

NEW WORK

EXISTING ELEMENTS

DEMOLISHED ELEMENTS



| newton teale o | onsulting pty ltd | ABN: |
|---------------------|-------------------|----------------|
| trading as p | an land | 62 128 716 334 |
| PO BOX 495 0 | Gymea NSW | |
| Phone: 0403 | 3 993 876 | |
| Email: info | @planland.com.au | |
| Drawn: | Approved: | Date: |
| LT | LÏ | OCT/2022 |
| Scale: | Drawing No.: Sh | eet No.: Rev.: |
| @A3 | 22113 D | A 10.1 |

Drawing: Perspective

Mudgee NSW 2850 Client

Project **34 Lang Street**,

NOTE: METHOD OF VENTILATING THE LAUNDRY AND WC AND CONTROLLING CONDENSATION IN ACCORDANCE WITH CLAUSES 3.8.5.2 & 3.8.7.3 OF THE NCC.

NOTE: STAIRWAY TO HAVE A NON-SLIP FINISH OR NOSING STRIP IN ACCORDANCE WITH CLAUSE 3.9.1.4 AND TABLE 3.9.1.3 OF THE NCC.

AUSTRALIAN STANDARDS <u>NOTE:</u> SMOKE DETECTORS TO COMPLY WITH REQUIREMENTS OF SPECIFICATION EL7 (NSW) FIRE AND SMOKE ALARMS SHALL COMPLY WITH AS 3786 AND BE CONNECTED TO THE MAIN POWER SUPPLY. <u>NOTE:</u> LOCATION OF SMOKE ALARMS IN ACCORDANCE WITH CLAUSE 3.7.5.2 OF THE NCC. NOTE:

NOTE: - SELECTED TERMITE PROTECTION TO BE USED ON SITE IN ACCORDANCE WITH LOCAL COUNCIL'S REQUIREMENTS, B.C.A. AND ALL RELEVANT AUSTRALIAN STANDARDS NOTE:

NOTE: ALL EXISTING & OVERALL DIMENSIONS ARE NOMINAL & SUBJECT TO VERIFICATION ON SITE. WHERE ANY DISCREPANCY OCCURS BETWEEN NEW WORK & EXISTING BETWEEN NEW WORK & EXISTING DIMENSIONS - EXISTING DIMENSIONS/WORK SHOULD TAKE PREPRENCE WHERE NECESSARY - OTHERWISE NOTIFY PLAN LAND NOTE:

ME HOU OF CONSTRUCTION COLLECTION DEFECT. THESE DRAWINGS ARE THE PROPERTY OF PLAN LAND. DRAWINGS ARE NOT TO BE REPRODUCED IN PART OR IN WHOLE ON ANY MEDIUM WITHOUT THE WRITTEN PERMISSION OF PLAN LAND.

COPYRIGHT: ALL WORK IS TO COMPLY WITH THE BUILDING CODE OF AUSTRALLA, RELEVANT AUSTRALLAN STANDARDS & LOCAL AUTHORITY REQUIREMENTS. BUILDING CONTRACTOR & ALL RELEVANT SUB TRADES TO CHECK & VERIFY ALL DIMENSIONS & ASSOCIATED DRAWING PARTS PRIOR TO MANUFACTURE, CONSTRUCTION & INSTALLATION ON SITE. DO NOT SCALE OFF DRAWINGS - WRITTEN DIMENSIONS TAKE PRECEDENCE. PLAN LAND ACCEPTS NO LIABILITY OR RESPONSIBILITY RESULTING FROM BUILDERS NEGLECT OR PREFERRED METHOD OF CONSTRUCTION FOR ANY BUILDING DEFECT.





| CONVECTOR ALS PALLA, PELLAWATACS, VALLAN ST ANDARDS & Degal attributive regime under the building code of ALS PALLA, PELLAWATACS, VALLAN ST ANDARDS & Degal attributive regime under the second statement Degal attributive regime under the second statement DEGINARE CONTRACTOR & ALLAN ST ANDARDS & Second statement attributive regime to second statement DEGINARE CONTRACTOR & SECOND ST TO CHECK & STREET ATTRIBUTION ON SIDE SECOND ST DEGINARE TRACTOR TO AN ADDRESS & SECOND |
|---|
| SCALE OFF PRAWINGS WITTEN DIMENSIONS TAKE PRICEDENCE. PLAN LAND ACCEPTS NO THE DIMENSIONS THE RESULTIVE FROM BUILDERS NEGLECT OR PREFERRED METHOD OF CONSTRUCTION FOR ANY BUILDING DEFECT. THESE DRAWINGS ARE THE PROPERTY OF FLAN LAND. DRAWINGS ARE NOT TO BE REPRODUCED IN PART OR IN WHOLE ON ANY MEDIUM WITHOUT THE WRITTEN |
| PERMISSION OF PLAN LAND. NOTE: ALL EXISTING & OVERALL DIMENSIONS ARE NOMINAL & SUBJECT TO VERIFICATION ON SITE. WHERE ANY DISCREPANCY OCCURS BETWEEN NEW WORK & EXISTING BETWEEN NEW WORK & EXISTING DIMENSIONS - EXISTING DIMENSIONS/WORK SHOULD TAKE PREFERENCE WHERE NECESSARY - OTHERWISE DIMENSIONS - EXISTING DIMENSIONS/WORK SHOULD TAKE PREFERENCE WHERE NECESSARY - OTHERWISE NOTEY LAND LAND DIMENSIONS - EXISTING DIMENSIONS/WORK SHOULD TAKE PREFERENCE WHERE NECESSARY - OTHERWISE NOTEY LAND LAND DISCREPTERTING E OTHER NECESSARY - OTHERWISE NOTEY LAND LAND SELECTED TERMITE PROTECTION TO BE USED ON SITE IN ACCORDANCE WITH LOCAL COUNCILS REQUERENTS, B.C.A. AND ALL RELEVANT AUSTRALIAN STANDARDS NOTEY NOKE DETECTORS TO COMPLY WITH REQUIREMENTS OF SPECIFICATION E 1.7 (NSW) FIRE AND SMOKE ALARMS SHALL COMPLY WITH AS 3786 AND BE CONNECTED TO THE MAIN POWER SUPPLY. NOTE DICATION OF SMOKE ALARMS IN ACCORDANCE WITH CLAUSE 3.7.5.2 OF THE NCC. NOTE! NOTE! METHOD OF VENTILATING THE LAUNDRY AND WC AND CONTODLING CONDENSATION IN ACCORDANCE WITH CLAUSES 3.8.5.2 & 3.8.7.3 OF THE NCC. NOTE! BALALANG SETUPING DISTING FURCE SALS AND AND AND AND AND METHOD OF VENTILATING THE LAUNDRY AND WC AND CONTOLLING CONDENSATION IN ACCORDANCE WITH CLAUSES 3.8.5.2 & 3.8.7.3 OF THE NCC. NOTE! BALALANG SETUPING DISTING AND AND AND AND AND AND AND AND DISTING AND |
| Drawing: Perspective newton teale consulting pty ltd ABN: |
| trading as plan land 62 128 716 334 PO BOX 495 Gymea NSW Phone: 0403 993 876 Email: info@plantand.com.au Drawn: Approved: Date: LT LT OCT/2022 Scale: Drawing No.: Sheet No.: @A3 221113 DAA 10.2 |



NOTE: NOTE: ALL EXISTING & OVERALL DIMENSIONS ARE NOMINAL & SUBJECT TO VERIFICATION ON SITE. WHERE ANY DISCREPANCY OCCURS BETWEEN NEW WORK & EXISTING BETWEEN NEW WORK & EXISTING DIMENSIONS - EXISTING DIMENSIONS/WORK SHOULD TAKE PREFERENCE WHERE NECESSARY - OTHERWISE NOTIFY PLAN LAND NOTE: SELECTED TERMITE PROTECTION TO BE USED ON SITE IN ACCORDANCE WITH LOCAL COUNCIL'S REQUIREMENTS, B.C.A. AND ALL RELEVANT AUSTRALIAN STANDARDS NOTE:

AUSTRALIAN STANDARDS <u>NOTE:</u> SMOKE DETECTORS TO COMPLY WITH REQUIREMENTS OF SPECIFICATION EL.7 (NSW) FIRE AND SMOKE ALARMS SHALL COMPLY WITH AS 3786 AND BE CONNECTED TO THE MAIN POWER SUPPLY. <u>NOTE:</u> LOCATION OF SMOKE ALARMS IN ACCORDANCE WITH CLAUSE 3.7.5.2 OF THE NCC. NOTE:

NOTE: STAIRWAY TO HAVE A NON-SLIP FINISH OR NOSING STRIP IN ACCORDANCE WITH CLAUSE 3.9.1.4 AND TABLE 3.9.1.3 OF THE NCC.

MOTE: METHOD OF VENTILATING THE LAUNDRY AND WC AND CONTROLLING CONDENSATION IN ACCORDANCE WITH CLAUSES 3.8.5.2 & 3.8.7.3 OF THE NCC.

Project: 34 Lang Street, Mudgee NSW 2850 Client

Drawing: Perspective

| newton teale | consulting pty ltd | ABN: |
|---------------------|--------------------|------------------|
| trading as p | an land | 62 128 716 334 |
| PO BOX 495 | Gymea NSW | |
| Phone: 0403 | 3 993 876 | |
| Email: info | @planland.com.au | |
| Drawn: | Approved: | Date: |
| LT | LT | OCT/2022 |
| Scale: | Drawing No.: | Sheet No.: Rev.: |
| @A3 | 22113 | DA 10.3 |





| @A3 | 22113 | DA 10.4 |
|------------|------------------------|----------------|
| Scale: | Drawing No.: | |
| LT | LT | OCT/2022 |
| Drawn: | Approved: | Date: |
| Email: i | nfo@planland.com.au | |
| Phone: 0 | 403 993 876 | |
| PO BOX 4 | 95 Gymea NSW | |
| trading as | plan land | 62 128 716 334 |
| newton tea | ale consulting pty ltd | ABN: |