

Beer Project Proposed Detached Dual Occupancy Lot 613, 37 Knox Crescent Caerleon NSW 2850

DRAWING	SCHEDULE - FILE NO: 0446-A01
0446-A01	TITLE SHEET & BASIX COMMITMENTS
0446-A02	LOCATION, SITE, SUBDIVISION & LANDSCAPE PLAN
0446-A03	FLOOR PLAN - DWELLING ONE
0446-A04	FLOOR PLAN - DWELLING TWO
0446-A05	ELEVATIONS - DWELLING ONE
0446-A06	ELEVATIONS - DWELLING TWO
0446-A07	SECTION & GENERAL NOTES
0446-A08	ELECTRICAL & MECHANICAL PLANS - DWELLING ONE
0446-A09	ELECTRICAL & MECHANICAL PLANS - DWELLING TWO

BASIX COMMITMENTS - Dwelling One & Two

CERTIFICATE

> Dwelling One Cert No.

> Dwelling Two Cert No.

THERMAL COMFORT

> See Typical Section, Floor Plan and Basix Certificate for further Thermal Comfort Commitments.

> The proposed construction must have the following applied to the floors, walls and ceiling / roof of the dwelling.

CONSTRUCTION	ADDITIONAL INSULATION REQUIRED	OTHER
Floor - concrete slab on ground	Nil	
External wall - brick veneer/framed \$ cladded	R2.06 (or R2.60 including construction)	
Internal wall shared with Garage - plasterboard	Nil	
Ceiling and roof - flat ceiling / pitched roof	Ceiling: R4.0 (up), Roof: foil / sarking	Unventilated; Dark (solar absorptance >0.70)

ENERGY

HOT WATER	ARTIFICIAL
> A Gas Instantaneous Hot Water System must be installed with 4 star rating	> The p
COOLING & HEATING SYSTEM:	-
> Living Area - 1-phase air conditioning, 3.5 Star (cold zone)	
> Bedroom - I-phase air conditioning, 3.5 Star (cold zone)	-
VENTILATION EXHAUST SYSTEMS:	OTHER:
> At least Bathroom - individual fan not ducted - manual on/off	> Each
> Kitchen - individual fan, not ducted - manual on/off	> A fixe
> Laundry - natural ventilation only.	2 // 11/0
NATURAL LIGHTING:	

> A window and / or skylight must be installed in 3 bathrooms / toilet(s) of the development

GLAZING REQUIREMENTS

WINDOWS & GLAZED DOORS

> The applicant must install all proposed windows, glazed doors and shading devices as listed below.

WINDOW/DOOR NO.	ORIENTATION	MAX. SIZE		SHADING (mm)	ТҮРЕ
Lounge	Ν	1.8x0.6	0	E-0.6, A/H-0.0	Aluminium, single, clear
Bed 2, Bed 3, Living	Ν	.2x .5 (X2), .8x .8	0	E-0.6, A/H-0.0	Aluminium, single, clear
Bed I, Ensuite	Ν	0.6x1.5, 1.5x1.8	0	None	Aluminium, single, clear
Living	E	1.8x2.4	0	E-0.6, A/H-0.0	Aluminium, single, clear
Dining	E	2.0x2.4	0	E-3.52, A/H-O.14	Aluminium, single, clear
Laundry	5	2.0x1.5	0	E-1.51, A/H-O.14	Aluminium, single, clear
WC, Bath	5	0.9x0.6, 0.9x1.5	0	E-1.51, A/H-O.O	Aluminium, single, clear
Lounge	W	1.8x0.6 (x3)	0	E-0.6, A/H-0.48	Aluminium, single, clear

> Note: E = Eave | A/H = Above Head | S/O = Solid Overhang | A/B = Above Base

WATER

FIXTURES

- > Showerheads 4 Star (>4.5 <= 6L/min)
- > Toilet Flushing System 4 Star Rating
- > Kitchen Taps 4 Star Rating
- > Bathroom Basın Taps 4 Star Ratıng

LANDSCAPING

> Minimum of 3m2 of low water use species used

BASIX NOTES:

1 THE APPLICANT MUST COMPLY WITH THE BASIX COMMITMENTS WITHIN BASIX CERTIFICATE PROVIDED DURING THE CONSTRUCTION OF THIS PROPOSED DEVELOPMENT.

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DATE DESCRIPTION 25/05/2021 INITIAL CONCEPT PRESENTED | 5/07/202 | 21/10/2022 08/02/2023 FINAL PCA SUBMISSION PLANS

CONTRACT PLANS FOR REVIEW PRELIMINARY CONTRACT PLANS NOTE

ALL DRAWINGS TO BE READ IN CONJUNCTION MITH -ALL SHEETS TO THIS SET OF PLANS SEPERATE SPECIFICATION DOCUMENTS STRUCTURAL ENGINEERS DOCUMENTATION PCA DOCUMENTS (WHERE APPLICABLE) BASIX CERTIFICATE ALL RELEVANT CODES, STANDARDS & APPROVALS



LYNCH BUILDING GROUP BEER PROJECT CLIENT PROPOSED DETACHED DUAL OCCUPANCY LOT G I 3 KNOX CRESCENT CAERLEON NSW 2850





OSTAL O BOX 1298 Mudgee NSW 2850 CONTACT US: 0411 761 934 . projects@lynchbuilding ww.lynchbuildinggroup.c

- in the development



AL LIGHTING:

- primary type of lighting in the following rooms must be fluorescent or LED:
- At least 3 of the bedrooms / study (dedicated)
- At least 3 of the living / dining rooms (dedicated)
- The kitchen (dedicated) - All hallways (dedicated)
- The laundry (dedicated)

refrigerator space must be constructed so that it is well ventilated xed outdoor clothes drying line must be installed

RAINWATER TANK

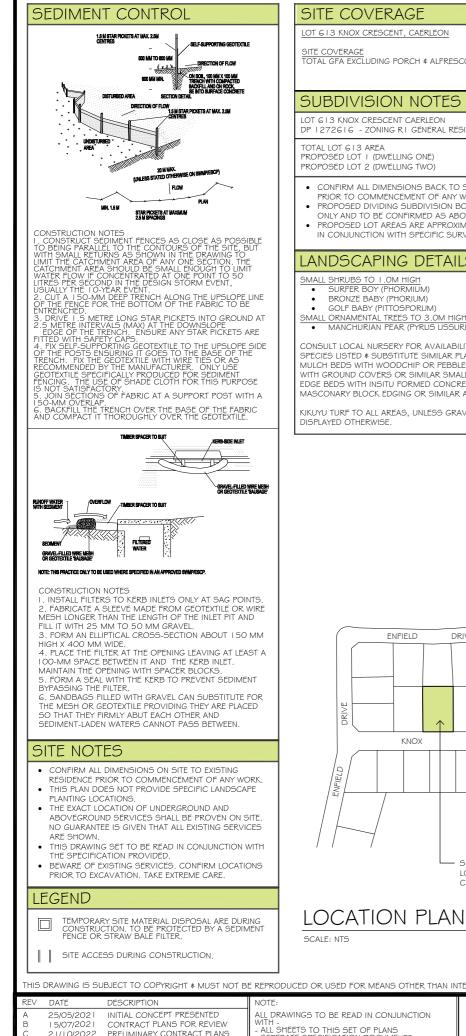
> A rainwater tank of at least 2,000L capacity must be installed

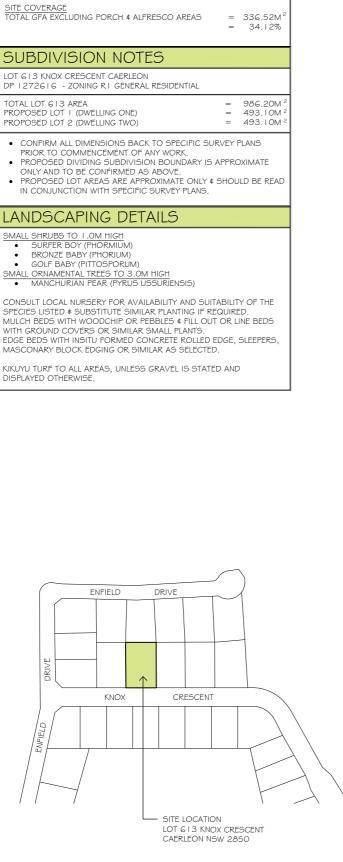
> The rainwater tank must collect rainwater from at least 150m2 of the roof area > The rainwater tank must be connected to:

- The cold water tap that supplies each clothes washer, and at least

one outdoor tap in the development

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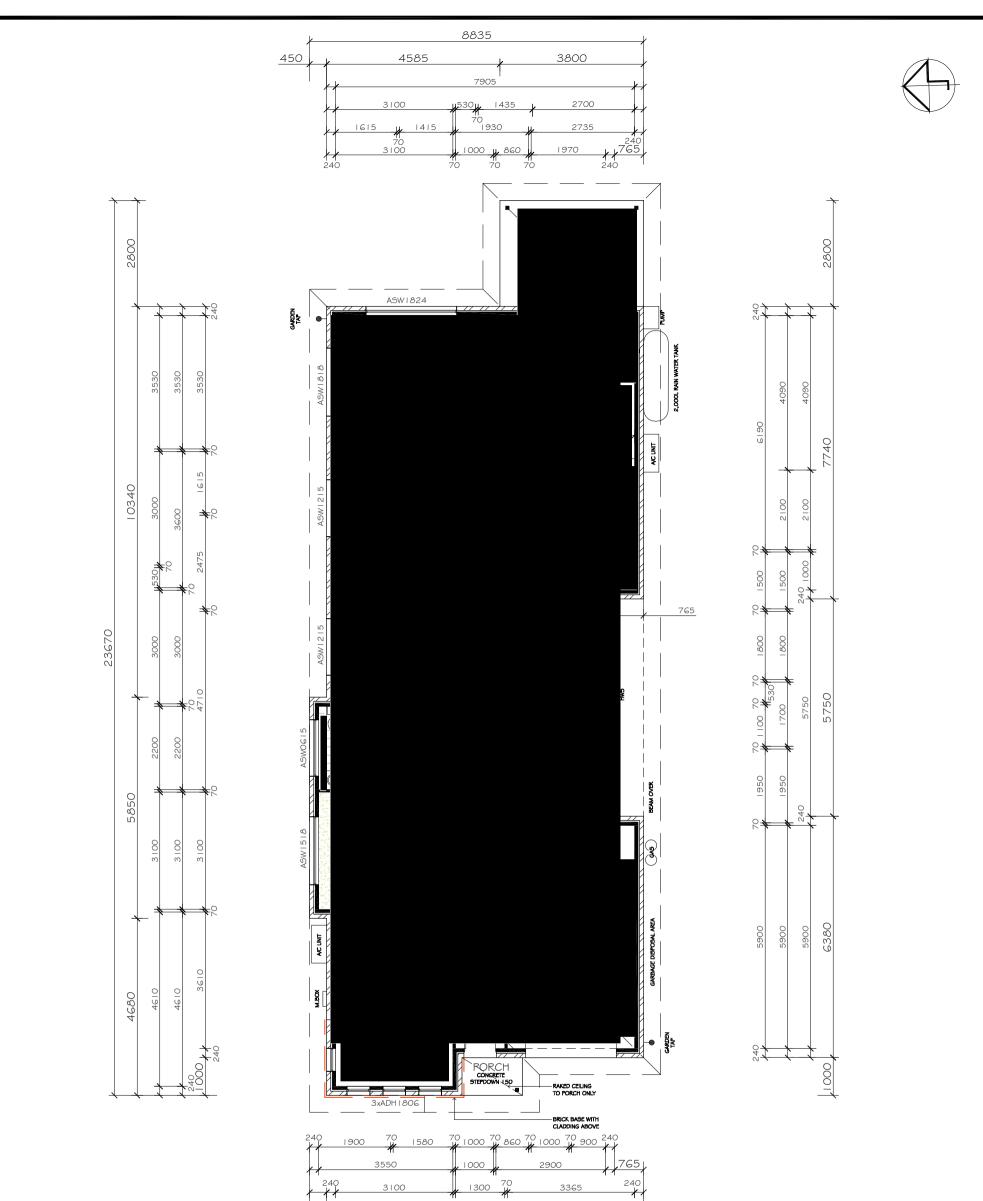
ALL DRAWINGS TO BE READ IN CONJUNCTION ALL SHEETS TO THIS SET OF PLANS PRELIMINARY CONTRACT PLANS SEPERATE SPECIFICATION DOCUMENTS STRUCTURAL ENGINEERS DOCUMENTATION PCA DOCUMENTS (WHERE APPLICABLE) 08/02/2023 FINAL PCA SUBMISSION PLANS BASIX CERTIFICATE

BUILDING DESIGNERS ASSOCIATION OF AUSTRALIA ALL RELEVANT CODES STANDARDS & APPROVAL

LYNCH BUILDING GROUP BEER PROJECT CLIENT PROPOSED DETACHED DUAL OCCUPANCY LOT GI 3 KNOX CRESCENT CAERLEON NSW 2850









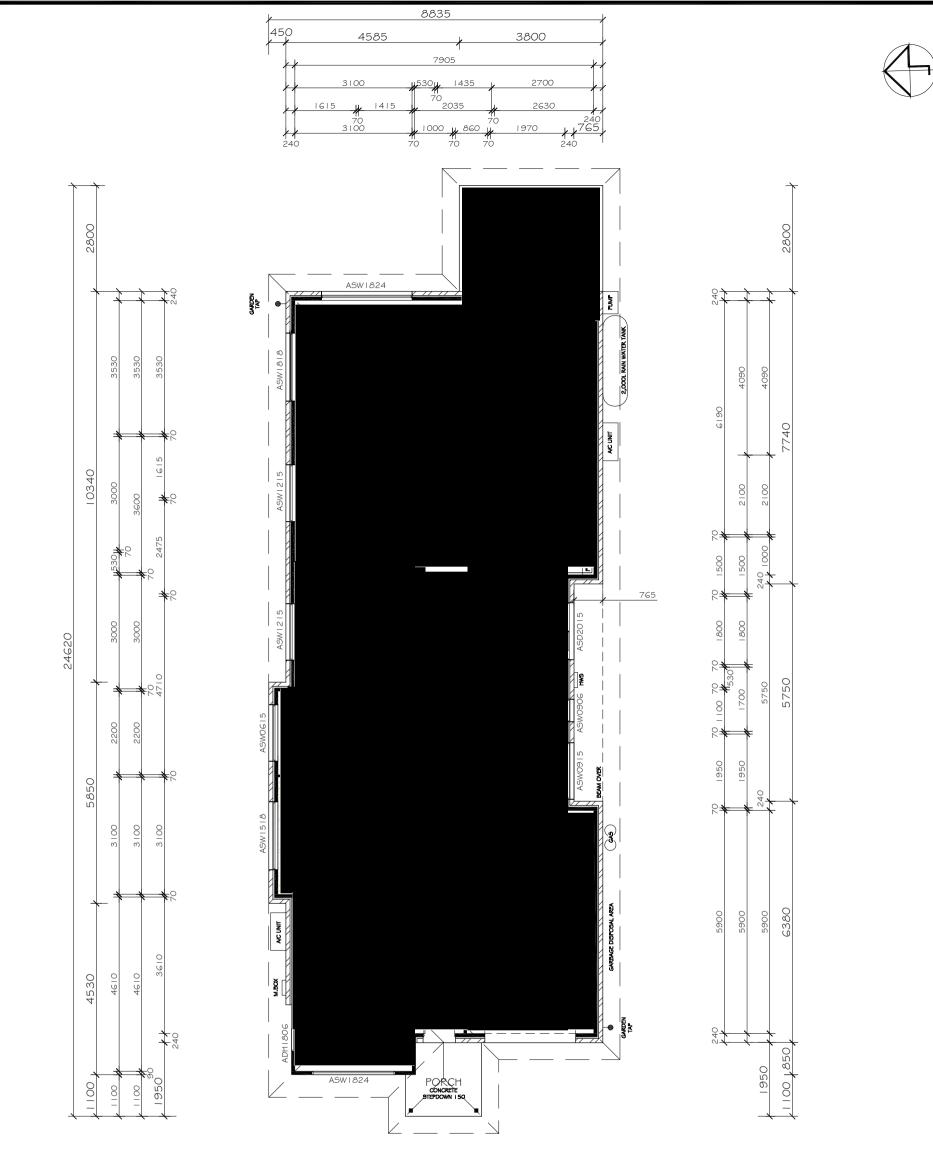
FLOOR PLAN - DWELLING ONE

SCALE: 1:100

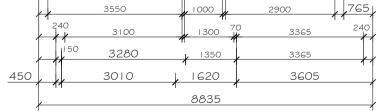
FLOOR AREAS		NOTES
DWELLING ONE - LIVING - GARAGE	$= 46. 0 M^{2}$ $= 22.3 M^{2}$	 PORCH & ALFRESCO POST POSITION(5) MAY VARY THROUGH ENGINEERS DESIGNS & DURING CONSTRUCTION.
TOTAL - PORCH	$= 168.41 \text{ M}^2$ $= 1.60 \text{ M}^2$	MH = MAN HOLE LOCATION
- ALFRESCO	$= 10.64 \text{ M}^2$ $= 180.65 \text{ M}^2$	ALL OPENINGS ARE SHOWN WITH WIDTH DISPLAYED ON FLOOR PLAN. HEAD HEIGHTS SHALL BE NO LESS THAN 2.2M FROM F.F.L. UNLESS STATED OTHERWISE

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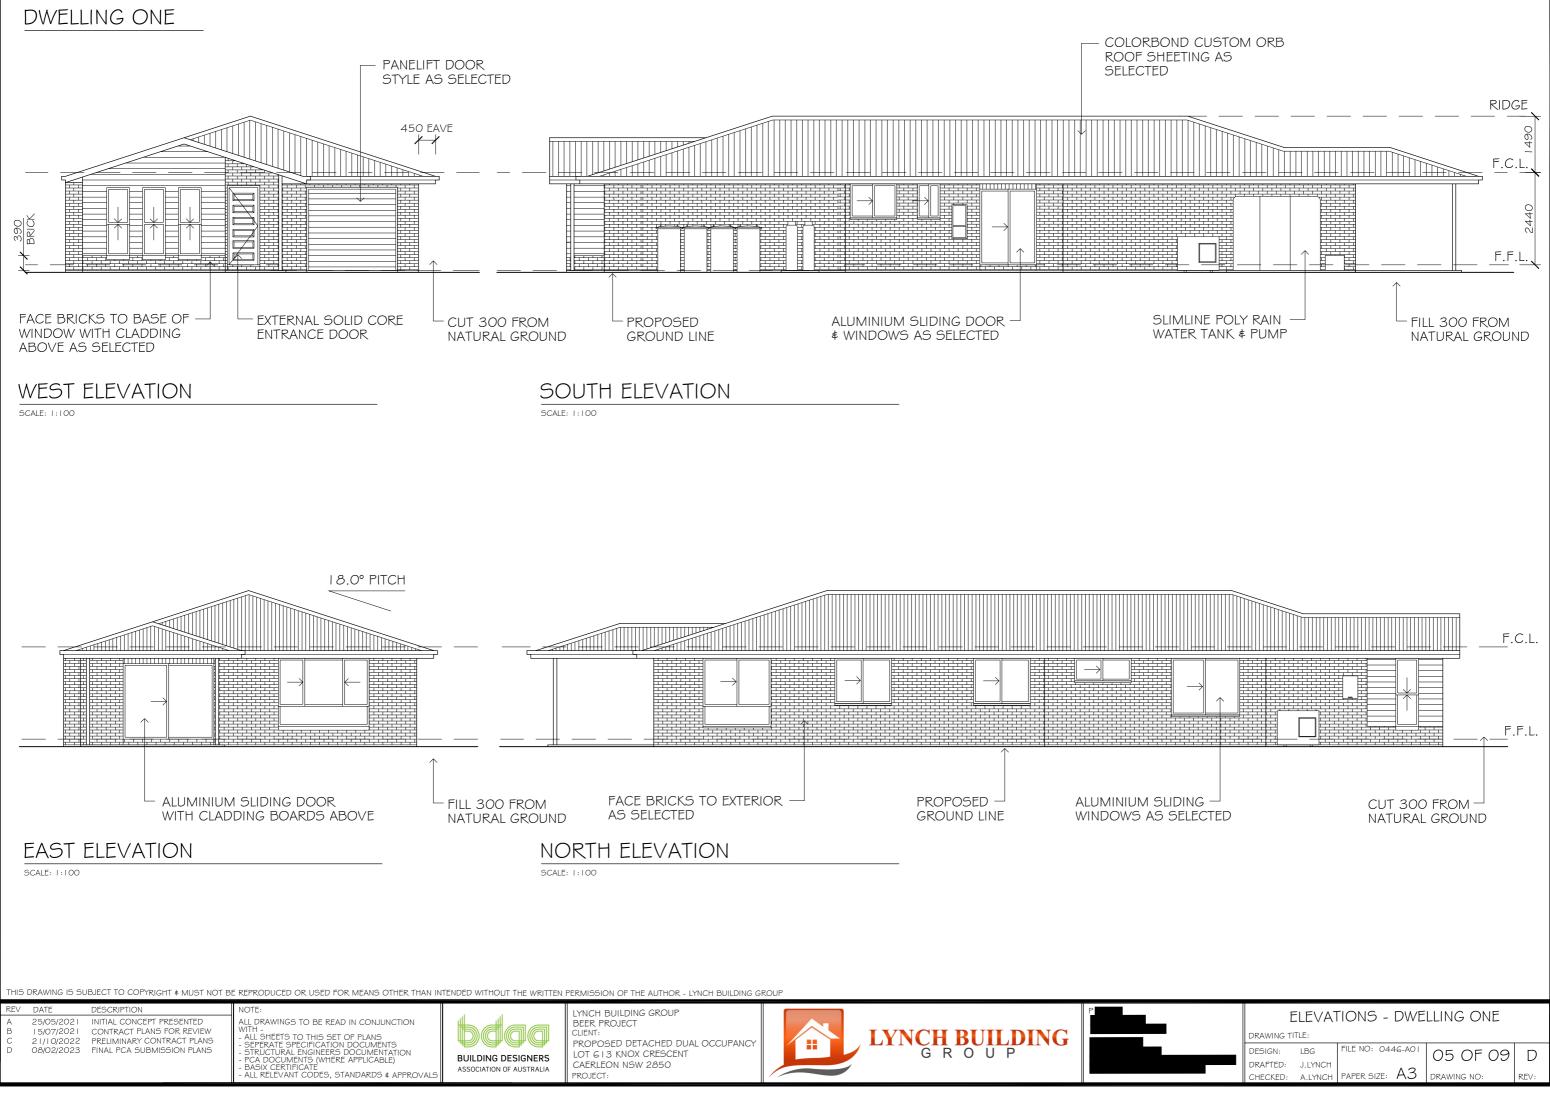
FLOOR PLAN - DWELLING TWO

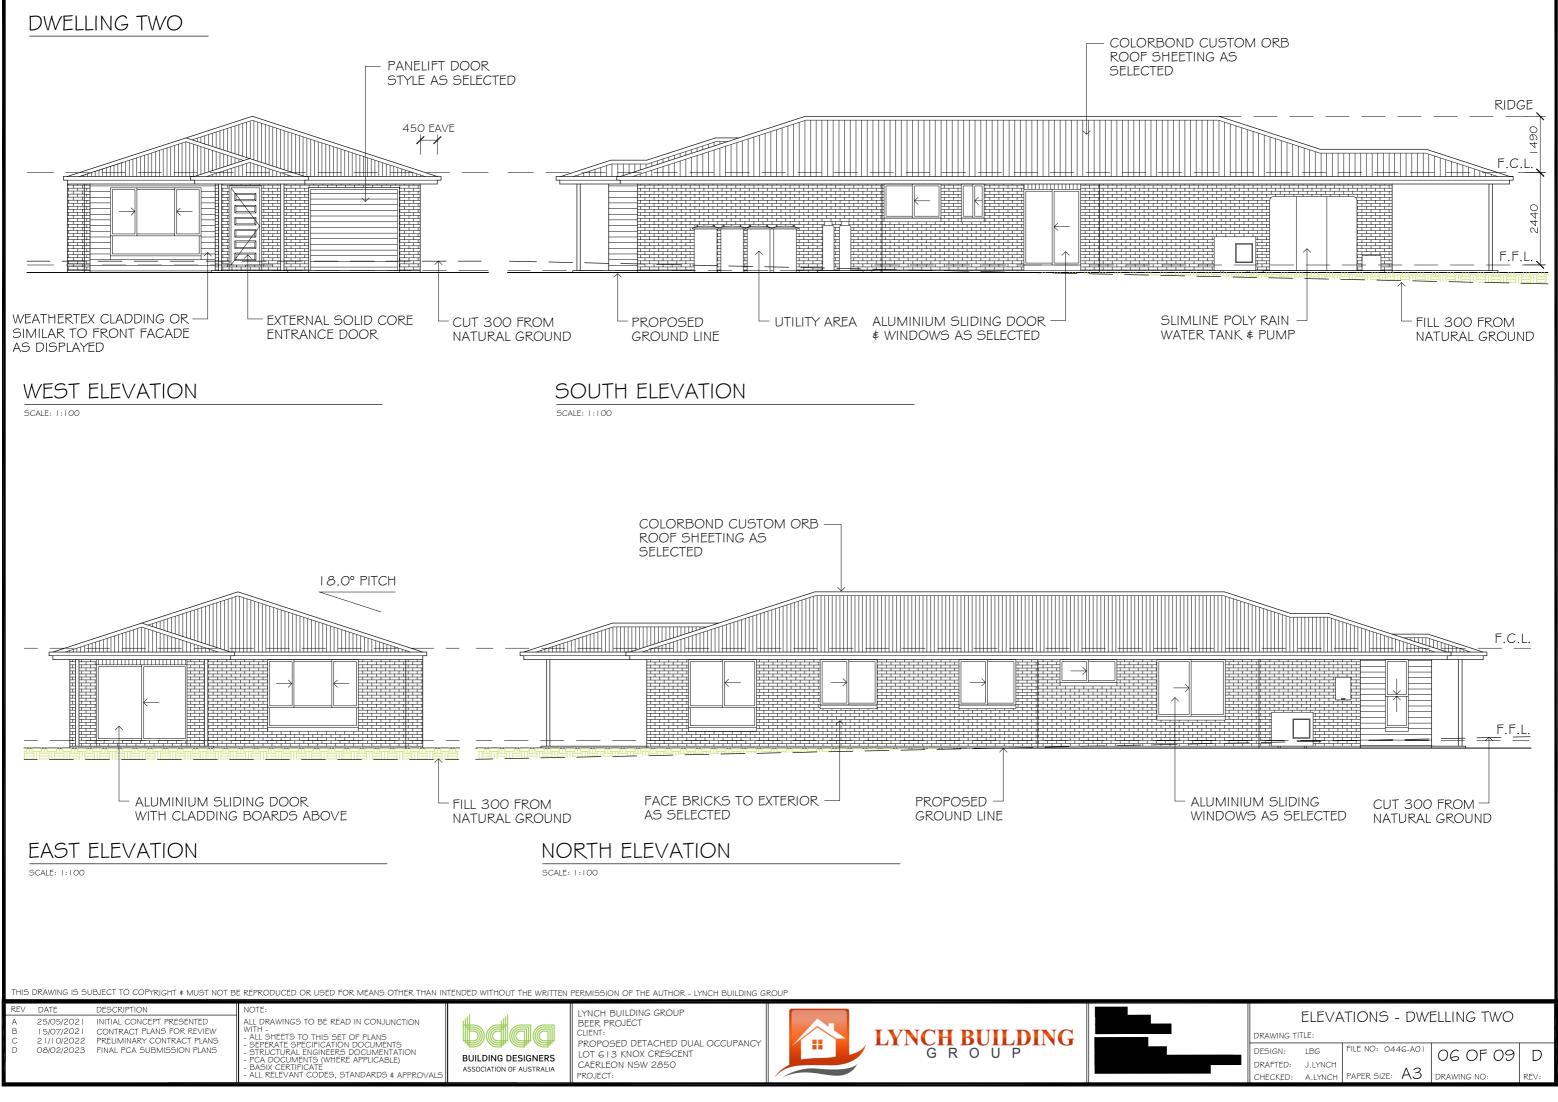
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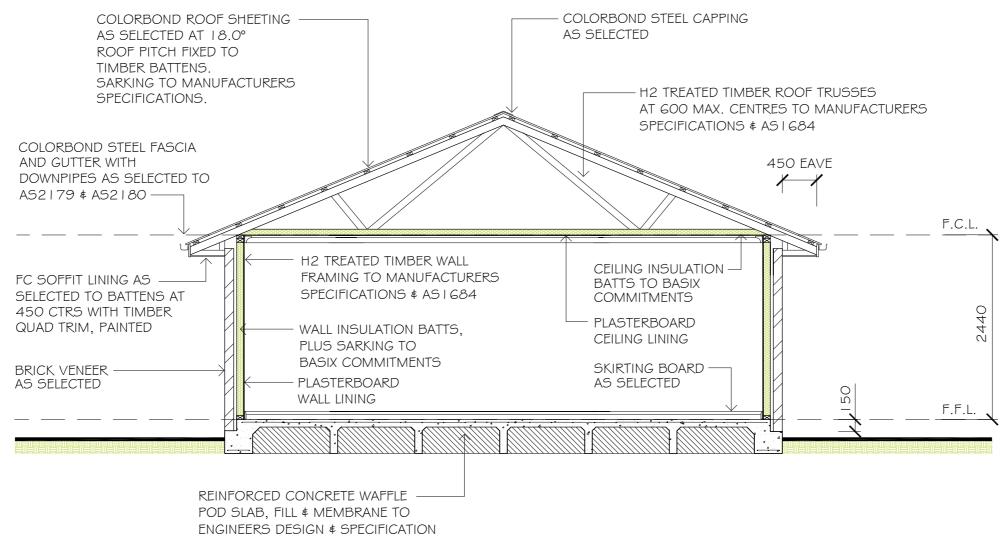
FLOOR AREAS		NOTES
DWELLING TWO - LIVING - GARAGE	$= 46. 0 M^{2}$ $= 22.3 M^{2}$	 PORCH & ALFRESCO POST POSITION(S) MAY VARY THROUGH ENGINEERS DESIGNS & DURING CONSTRUCTION.
TOTAL	$= 68.4 M^2$	MH = MAN HOLE LOCATION
- PORCH - ALFRESCO	$= 3.51 \text{ M}^2 \\ = 10.64 \text{ M}^2$	ALL OPENINGS ARE SHOWN WITH WIDTH DISPLAYED ON FLOOR PLAN, HEAD HEIGHTS SHALL BE NO LESS
TOTAL DWELLING TWO	= 182.56 M ²	THAN 2.2M FROM F.F.L. UNLESS STATED OTHERWISE

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REV DATE DESCRIPTION A 25/05/2021 INITIAL CONCEPT PRESENTED B 15/07/2021 CONTRACT PLANS FOR REVIEW C 21/10/2022 PRELIMINARY CONTRACT PLANS	NOTE: ALL DRAWINGS TO BE READ IN CONJUNCTION WITH	LYNCH BUILDING GROUP BEER PROJECT CLIENT: PROPOSED DETACHED DUAL OCCUPANCY		FLOOR PLAN - DWELLING TWO drawing title:
D 08/02/2023 FINAL PCA SUBMISSION PLANS	SEPERATE SPECIFICATION DOCUMENTS STRUCTURAL ENGINEERS DOCUMENTATION PCA DOCUMENTS (WHERE APPLICABLE) BASIX CERTIFICATE ALL RELEVANT CODES, STANDARDS # APPROVALS	LOT G13 KNOX CRESCENT CAERLEON NSW 2850 PROJECT:	GROOF	DESIGN: LBG FILE NO: 0446-A01 04 OF 09 D DRAFTED: J.LYNCH PAPER SIZE: A3 DRAWING NO: REV:







TYPICAL SECTION

GENERAL NOTES

WITH THE WORK

SCALE 1.50

31

SECTION NOTES

- FOR COMPLETE SLAB DETAILS & DESIGN REFER TO ENGINEERS SPECIFICATIONS & DESIGNS
- 2 TERMITE TREATMENT SHALL BE INCLUDED TO PROTECT AGAINST INFESTATION TO AS3660, I-2000
- 3 PARTY WALL DETAILS -
 - SEPARATING PARTY WALL MUST NOT BE CROSSED BY TIMBER OR OTHER COMBUSTIBLE BUILDING ELEMENTS WITH THE EXCEPTION OF STEEL ROOFING BATTENS WITH DIMENSIONS 75x50MM OR ROOF SARKING, MUST ALSO BE PACKED USING FIRE RESISTANT MATERIAL IN ACCORDANCE WITH THE B.C.A. - 25MM GYPROCK SHAFT LINER PANEL BETWEEN STEEL "H" WITH 20-40MM OF SEPERATION BETWEEN FRAMES & GYPROCK SHAF LINER PANEL
 - STUDS AT GOOMM MAXIMUM CENTRES
 - IOMM GYPROCK "SUPERCHEK" PLASTERBOARD WALL LINING TO FACE OF PARTY WALL (GYPROCK EWFA 45743 CSR 360 PARTY WALL SYSTEM)
- SELECT WALL FRAMING WITH R2.7 GOLD WALL INSULATION BATTS TO BE INSTALLED
- FIRE RESISTANT MINERAL FIRE BLANKET TO BE INSTALLED DIRECTLY ABOVE PARTY WALL TO UNDERSIDE OF ROOFING IN ACCORDANCE WITH THE B.C.A.

THE RELEVANT SERVICE AUTHORITIES SHALL BE CONSULTED IN REGARDS TO CONFIRMING / CHECKING ALL DIMENSIONS, LEVELS, SERVICES & SITE CONDITIONS PRIOR TO CONSTRUCTION

- THE RELEVANT STATUTORY AUTHORITIES SHALL BE NOTIFIED & 8| APPROVAL SORT FROM / OBTAINED PRIOR TO CONSTRUCTION. IF & WHEN NECESSARY
- 9| STUD WALL & TRUSSED ROOF DESIGN, BRACING & TIE DOWN TO SELECTED FRAME & TRUSS MANUFACTURERS ENGINEERED SPECIFICATIONS & TO AS I 684 WHERE APPLICABLE.
- IO SHALL NO WIND CLASSIFICATION BE NOTED, CLIENT TO BE ADVISED BY PCA OR ENGINEERING CONSULTANT.
- II SITE CLASSIFICATION TO BE DETERMINED BY QUALIFIED GEOTECHNICAL ENGINEER & ALL REINFORCED CONCRETE FOOTINGS & SLABS TO BE CONSTRUCTED TO AS2870.
- ALL STORM WATER FROM ROOF TO BE DISPURSED TO REQUIRED DOWNPIPES & TO STREET / RAIN WATER TANK TO AUSTRALIAN STANDARDS & PCA REQUIREMENTS
- HIS DRAWING IS SUBJECT TO COPYRIGHT & MUST NOT BE REPRODUCED OR USED FOR MEANS OTHER THAN INTENDED WITHOUT THE WRITTEN PERMISSION OF THE AUTHOR LYNCH BUILDING GROUP

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REV	DATE	DESCRIPTION	
А	25/05/2021	INITIAL CONCEPT PRESENTED	
В	5/07/202	CONTRACT PLANS FOR REVIEW	
С	21/10/2022	PRELIMINARY CONTRACT PLANS	
D	08/02/2023	FINAL PCA SUBMISSION PLANS	



PLANS DOCUMENTED FOR THE EXCLUSIVE USE OF THE

2 ALL DIMENSIONS ≰ INFORMATION WITHIN THESE SET OF PLANS

ARE DOCUMENTED WITH DUE CARE.

NOTED CLIENTS BELOW ONLY & SUBJECT TO COPYRIGHT LAWS.

ALL DRAWINGS WITHIN THIS SET OF PLANS SHALL BE READ IN

ALL DISCREPANCIES SHALL BE REFERRED TO IN WRITING TO

JHL BUILDING DESIGNS FOR A DECISION BEFORE PROCEEDING

ALL DIMENSIONS ARE IN MILLIMETRES UNLESS STATED OTHERWISE.

DIMENSIONS ARE TO STRUCTURAL ELEMENTS OF THE DRAWING #

NOT TO FINISHED SURFACES IE. TILING, PLASTERBOARD ETC.

WITH REGARDS TO ONSITE & OFF SITE REQUIREMENTS & WORK.

ALL RELEVANT DIMENSIONS ARE TO BE CONFIRMED BY THE

CONTRACTOR PRIOR TO CONSTRUCTION & FABRICATION

CONJUNCTION WITH OTHER CONSULTANTS DRAWINGS. DESIGNS €

SPECIFICATIONS & WITH OTHER WRITTEN INSTRUCTIONS ISSUED

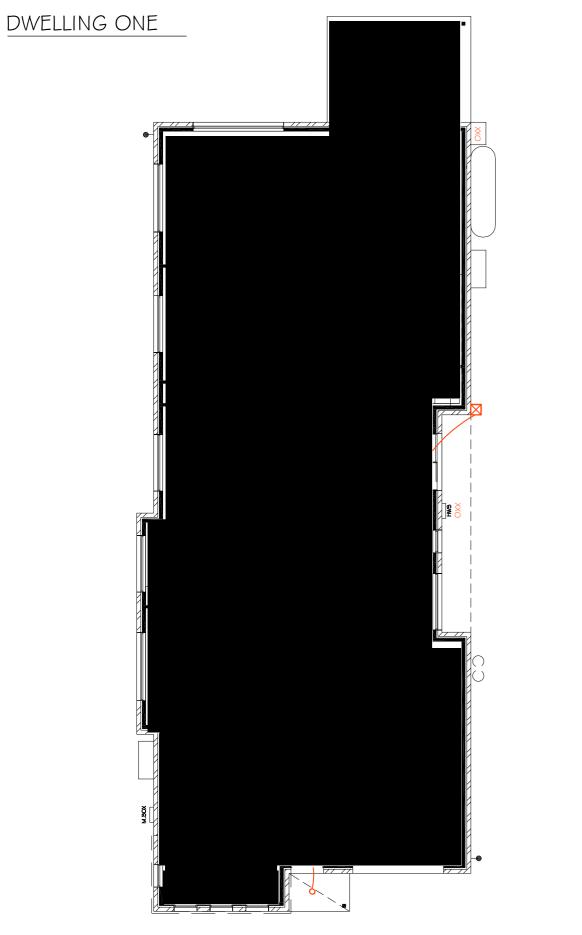
DURING ESTIMATIONS & CONSTRUCTION WITH SELECTED BUILDER.

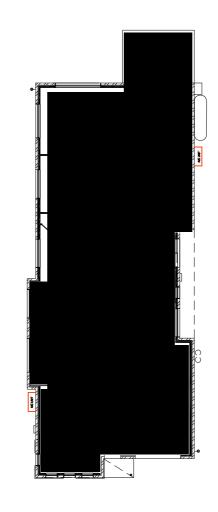
LYNCH BUILDING GROUP BEER PROJECT CLIENT PROPOSED DETACHED DUAL OCCUPANCY LOT G I 3 KNOX CRESCENT CAERLEON NSW 2850





13	A MINIMUM WATER ALLOWANCE SHALL BE PROVIDED FOR RURAL PROPERTIES FOR FIRE FIGHTING PURPOSES AS SPECIFIED BY PCA.	17	THE HOT WATER SYSTEM IS AS SPECIFIED WITHIN THE BASIX CERTIFICATE & LOCATION NOTED OF FLOOR PLAN.
4	WHERE A SITE REQUIRES CUT ¢ FILL TO OCCUR OR RETAINING WALLS CONSTRUCTED, ENGINEERS SHALL BE CONSULTED WHERE NECESSARY ¢ BUILDING CONTRACTOR TO ENSURE ALL FINAL LEVELS, GROUND LINES ¢ GRADIENTS DIVERT ALL SURFACE STORM WATER FROM THE PROPOSED RESIDENCE EITHER BY MEANS OF PIPES, DETENTION AREAS OR GRADING TO KERB. NEIGHBOURING PROPERTIES MUST BE TAKEN INTO CONSIDERATION WITH THE DESIGN OF THE FLOW OF STORM WATER.	18 19	TERMITE PROTECTION SHALL BE IN ACCORDANCE WITH AS3660. WHERE BRICK VENEER CONSTRUCTION IS SPECIFIED, CONTROL JOINTS FOR ARTICULATION MUST BE PROVIDED AT NOMINAL G.OM MAX. CENTRES OR TO STRUCTURAL ENGINEERS DETAILS.
	SEWER DRAINAGE LINES TO BE CONNECTED TO SEWER MAIN OR IN THE CASE OF A RURAL PROPERTY, CONNECTED TO A SEPTIC SYSTEM, IN ACCORDANCE WITH THE RELEVANT AUSTRALIAN STANDARDS & LOCAL PCA. A QUALIFIED CONTRACTOR SHALL COMPLETE THE FINAL DRAINAGE LAYOUT TO BE SUBMITTED TO THE LOCAL PCA FOR THEIR RECORDS & APPROVAL.		
Ή	BUILDING	DR	TYPICAL SECTION AWING TITLE:
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MECHANICAL PLAN

ELECTRICAL PLAN

SCALE: NTS

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REV	DATE	DESCRIPTION	NOTE:
A B C D	25/05/202 5/07/202 2 / 0/2022 08/02/2023	INITIAL CONCEPT PRESENTED CONTRACT PLANS FOR REVIEW PRELIMINARY CONTRACT PLANS FINAL PCA SUBMISSION PLANS	ALL DR. WITH - - ALL S - SEPEF - STRU - PCA E - BASIX





LYNCH BUILDING GROUP BEER PROJECT CLIENT: PROPOSED DETACHED DUAL OCCUPANCY LOT G I 3 KNOX CRESCENT CAERLEON NSW 2850 PROJECT:



	_				
LEGEN	D				
X 300	SINGLE POWER POINT (DISTANCE ABOVE F.F.L.)	(4)			
XX 300	DOUBLE POWER POINT (DISTANCE ABOVE F.F.L.)	(5)			
	FLUORESCENT LIGHTS - SINGLE	(1)			
0	DOWN LIGHT	(23)			
	EXTERNAL WALL LIGHT	(-)			
\boxtimes	SENSOR LIGHT	(1)			
\otimes	STANDARD BATTEN	(7)			
83	TASTIC LIGHT - 4 LIGHT	(1)			
8	TASTIC LIGHT - 2 LIGHT	(1)			
TV	TELEVISION OUTLET	(2)			
PH	NBN POINT LOCATION	(1)			
-	2-WAY SWITCH	(-)			
ρ	PENDANT LIGHT	(-)			
OXX	EXTERNAL DOUBLE POWER POINT	(2)			
×	CEILING FAN - WITH LIGHT	(1)			
ELECT	RICAL NOTES				
 ALL ELECTRICAL WORK SHALL BE CARRIED OUT BY A LICENSED CONTRACTOR. ALL WORK SHALL BE IN ACCORDANCE WITH AS/NZ3012 \$ ALL LINENSING REQUIREMENTS. 					
	SELECTION OF FITTINGS AND THE LAYOUT TO BE CARR HE BUILDER & DESIGNED TO THE CLIENT'S REQUIREMEN	·			

3 ALL APPROVED SMOKE ALARMS / DETECTORS TO BE INSTALLED TO AS3786 BY A LICENSED CONTRACTOR.

LEGEND OUTDOOR AIR CONDITIONER UNIT ZONES SUPPLY AIR GRILLS RETURN AIR GRILLS AIR CONDITIONER UNIT IN ROOF SPACE AIR CONDITIONER CONTROL PANEL INDOOR WALL MOUNTED SPLIT SYSTEM

MECHANICAL NOTES

 ALL MECHANICAL WORKS REGARDING AIR CONDITIONING SHALL BE CARRIED OUT BY A LICENSED CONTRACTOR. ALL WORK SHALL BE IN ACCORDANCE WITH AS STANDARDS ¢ ALL LINENSING REQUIREMENTS.
 THE SELECTION OF FITTINGS AND THE LAYOUT TO BE CONFIRMED BY THE BUILDER ¢ DESIGNED TO THE CLIENT'S REQUIREMENTS.
 GENERAL LAYOUT OF SUPPLY AIR GRILLS ETC IS TO BE VIEWED AS AN EXAMPLE ONLY ¢ CAN CHANGE THROUGHOUT INSTALLATION

ELECTR	ELECTRICAL & MECHANICAL PLANS - DWELLING ONE							
DRAWING TI	TLE:							
 DESIGN:	LBG	FILE NO: (0446	S-AO I	08 OF (79	D	
DRAFTED:	J.LYNCH							
CHECKED:	A.LYNCH	PAPER SIZ	:E: /	43	DRAWING NO:		REV:	



 REV
 DATE
 DESCRIPTION
 NOTE:

 A
 25/05/2021
 INITIAL CONCEPT PRESENTED
 ALL DRAWINGS

 B
 15/07/2021
 CONTRACT PLANS FOR REVIEW
 ALL SHEETS TC

 C
 21/10/2022
 PRELIMINARY CONTRACT PLANS
 - ALL SHEETS TC

 D
 08/02/2023
 FINAL PCA SUBMISSION PLANS
 - STRUCTURAL E

NOTE: ALL DRAWINGS TO BE READ IN CONJUNCTION WITH -- ALL SHEETS TO THIS SET OF PLANS - SEPERATE SPECIFICATION DOCUMENTS - STRUCTURAL ENGINEERS DOCUMENTATION - PCA DOCUMENTS (WHERE APPLICABLE) - BASIX CERTIFICATE - ALL RELEVANT CODES, STANDARDS & APPROVALS

LYNCH BUILDING GROUP BEER PROJECT CLIENT: PROPOSED DETACHED DUAL OCCUPANCY LOT 6 I 3 KNOX CRESCENT CAERLEON NSW 2850 PROJECT:





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88	TASTIC LIGHT - 4 LIGHT	(1)			
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1	THE SELECTION OF FITTINGS AND THE LAYOUT TO BE CARRIED OUT BY THE BUILDER & DESIGNED TO THE CLIENT'S REQUIREMENTS.				

3 ALL APPROVED SMOKE ALARMS / DETECTORS TO BE INSTALLED TO AS3786 BY A LICENSED CONTRACTOR.

LEGEND OUTDOOR AIR CONDITIONER UNIT ZONES SUPPLY AIR GRILLS RETURN AIR GRILLS AIR CONDITIONER UNIT IN ROOF SPACE AIR CONDITIONER CONTROL PANEL

MECHANICAL NOTES

1	ALL MECHANICAL WORKS REGARDING AIR CONDITIONING SHALL BE CARRIED OUT BY A LICENSED CONTRACTOR. ALL WORK SHALL BE IN ACCORDANCE WITH AS STANDARDS & ALL LINENSING REQUIREMENTS.
2	THE SELECTION OF FITTINGS AND THE LAYOUT TO BE CONFIRMED

BY THE BUILDER ¢ DESIGNED TO THE CLIENT'S REQUIREMENTS.

INDOOR WALL MOUNTED SPLIT SYSTEM

ELECTRICAL & MECHANICAL PLANS - DWELLING TWO							
DRAWING TITLE:							
DESIGN:	LBG	FILE NO: 0446-	401	09 OF 09	D		
DRAFTED:	J.LYNCH		~	00 01 00			
CHECKED:	A.LYNCH	PAPER SIZE: A	3	DRAWING NO:	REV:		