

DRAWING LIST	
DA-01	SITE & ROOF PLAN
DA-02	UPPER FLOOR PLAN
DA-03	LOWER FLOOR PLAN
DA-04	ELEVATIONS
DA-05	ELEVATIONS
DA-06	SECTIONS
DA-07	SECTION
DA-08	DETAILED SECTION
DA-09	POOL FENCING PERSPECTIVE
SCH-01	WINDOW SCHEDULE
SCH-02	WINDOW SCHEDULE
ANX-01	BASIX Commitments
ANX-02	BASIX Commitments
ANX-03	BASIX Commitments



UNDERWOOD RESIDENCE

10 AVISFORD COURT, MUDGEE, QLD.

DATE: JULY 2014

JOB No: 1414

ISSUE F DEVELOPMENT APPLICATION



(02) 6674 0488 0419 259 426 570 Casuarina Way, Casuarina Beach, NSW, 2487 scott@scottcarpenterarchitect.com.au www.scottcarpenterarchitect.com.au




NSW Country Division

NOTES: ISS DO NOT SCALE OFF DRAWINGS Refer any discrepancies to the Architect prior to commencement of work. Verify all dimension on alle prior to commencement of All materials and workmanship shall be in accordance with E

UE	DATE
	04 / 07 / '1 08 / 07 / '1 15 / 07 / '1 12 / 08 / '1 05 / 09 / '1 22 / 09 / '1

Aaster Plan Wmended Master Plan Wmended Master Plan Schematic Design Development Application

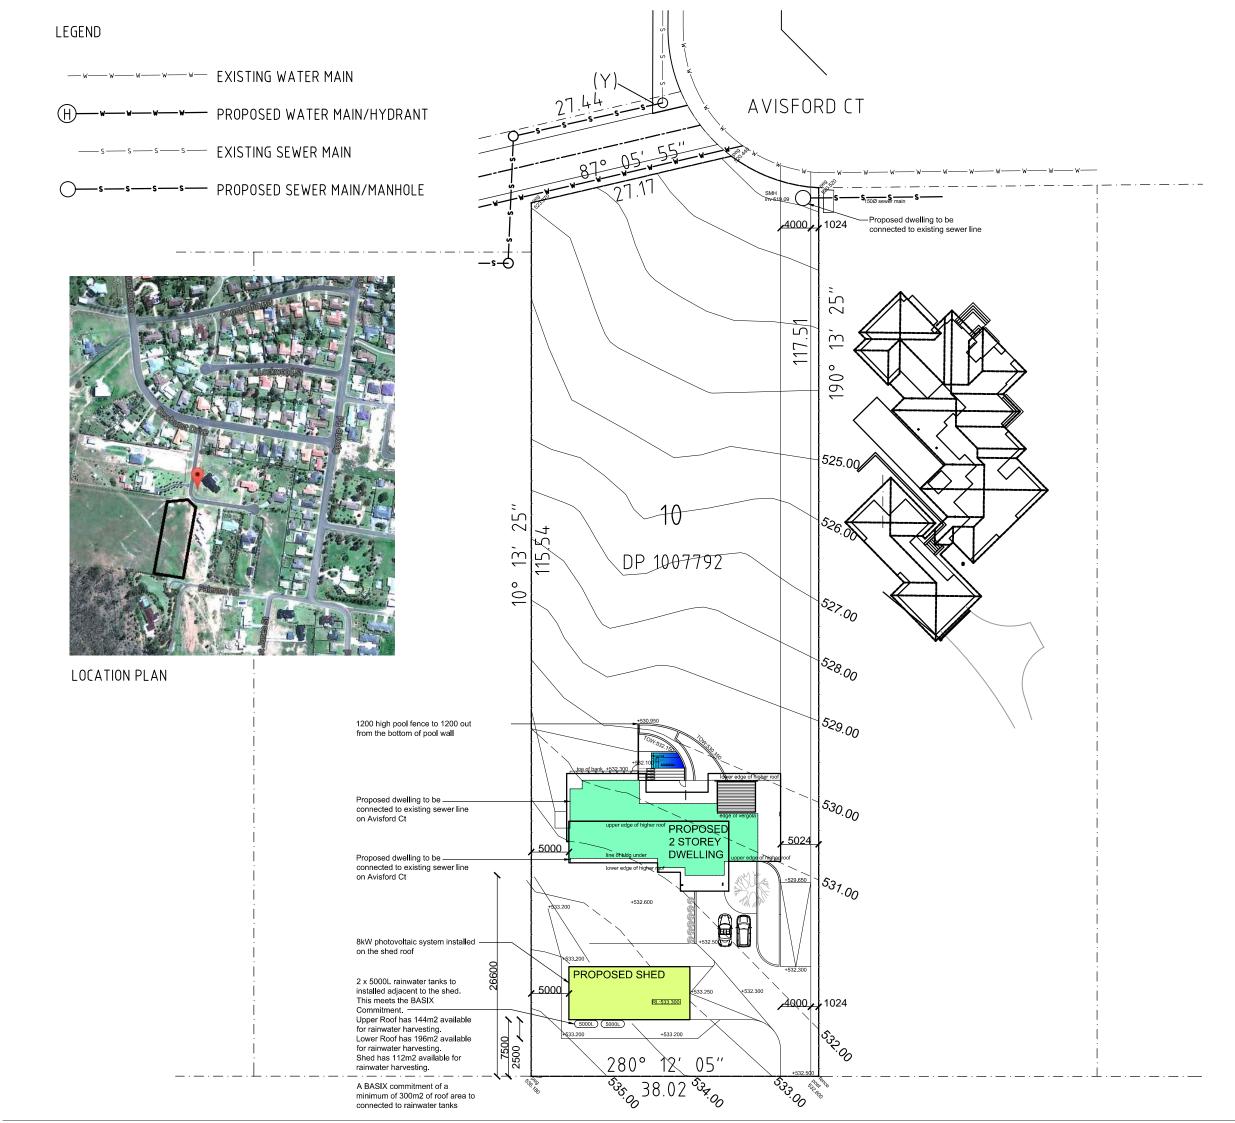

NOTES:

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All materials and workmanship shall be in accordance with the specification.

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ISSUE	DATE	DISTRIBUTION	
A B C D E F	04 / 07 / '14 08 / 07 / '14 15 / 07 / '14 12 / 08 / '14 05 / 09 / '14 22 / 09 / '14	Master Plan Amended Master Plan Amended Master Plan Schematic Design Estimation Issue Development Applicatio	on
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DEVELOPMEN PRELIMINARY	IT APPLICATIO	HE PURPOSE OF THE N, ESTIMATING AND ONLY. THE DETAIL OR CONSTRUCTION.	
N O C O N	T S T R U	F O R C T I O N	



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	ARB: 7017 3539

ARB: 7017 3539 AIA No. 22721









 DATE:
 JULY 2014
 JOB No:
 1414

 SCALE:
 1:500(A3), 1:250(A1) DWG No:
 DA-01

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SECTION C-C / NORTH ELEVATION

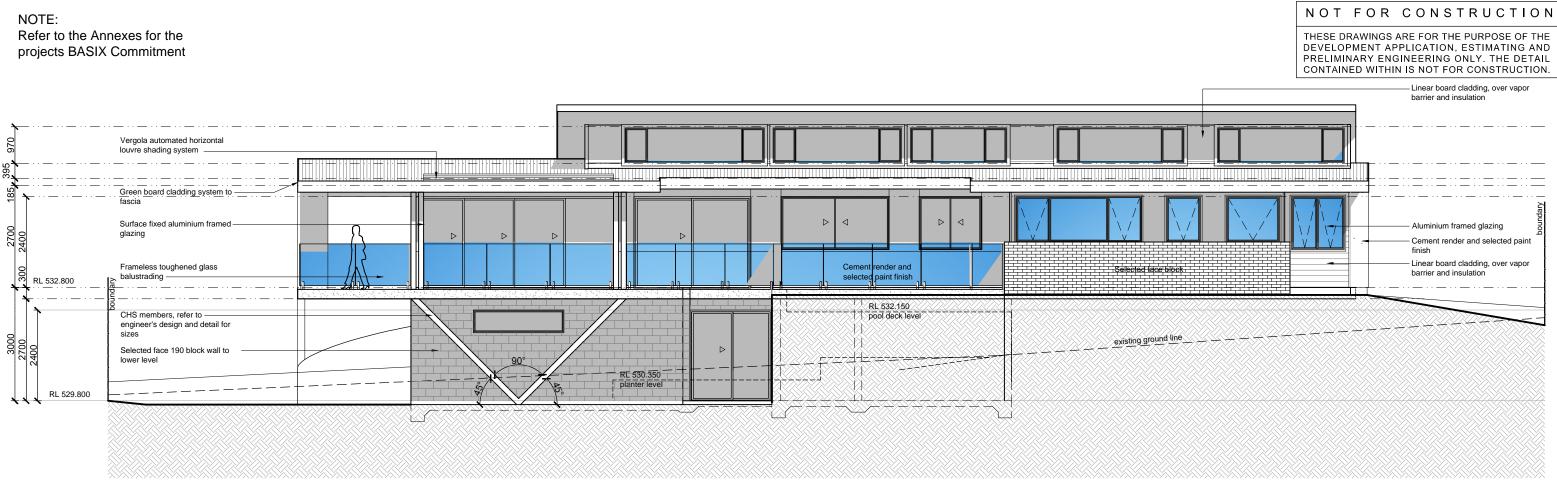

SECTION D-D / SOUTH ELEVATION
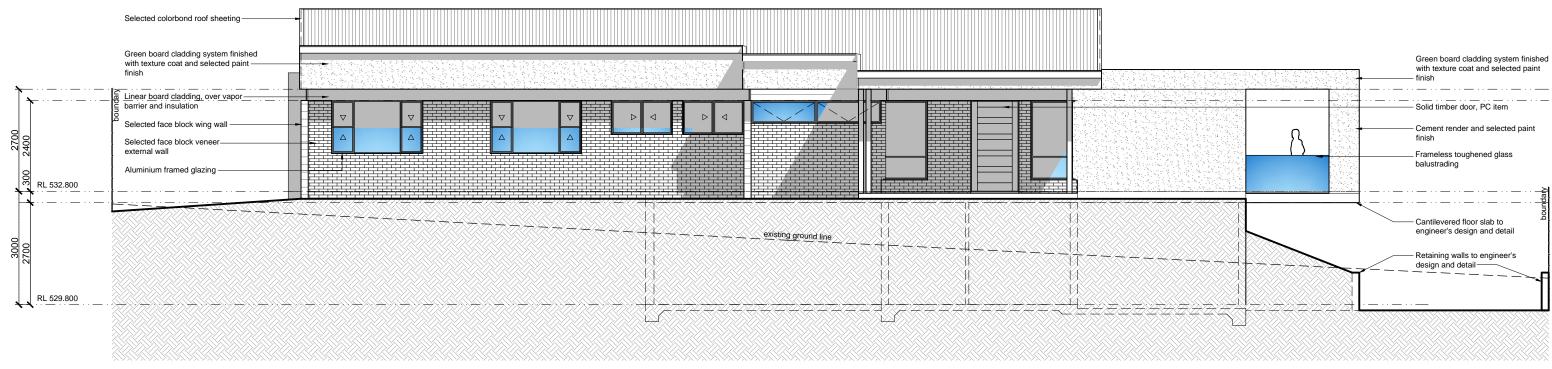
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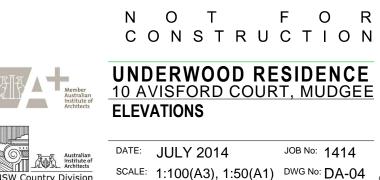


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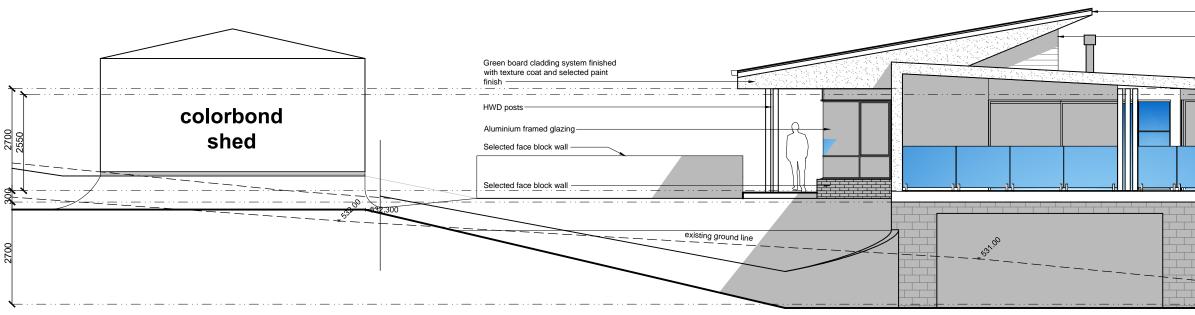
(02) 6674 0488 0419 259 426

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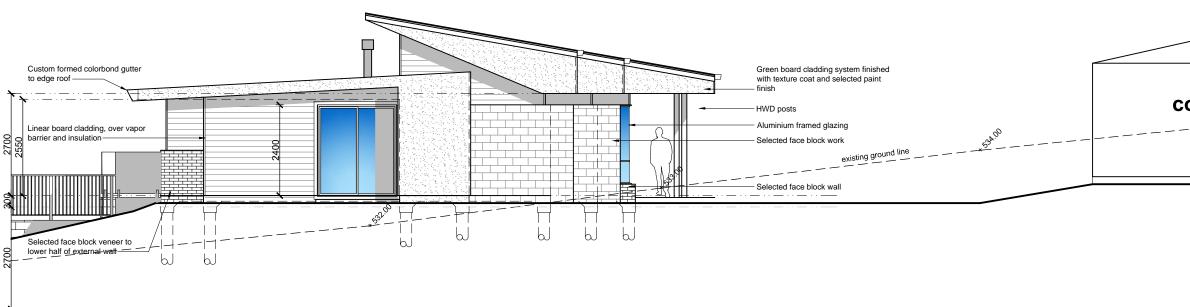




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SECTION A-A / EAST ELEVATION



SECTION B-B / WEST ELEVATION


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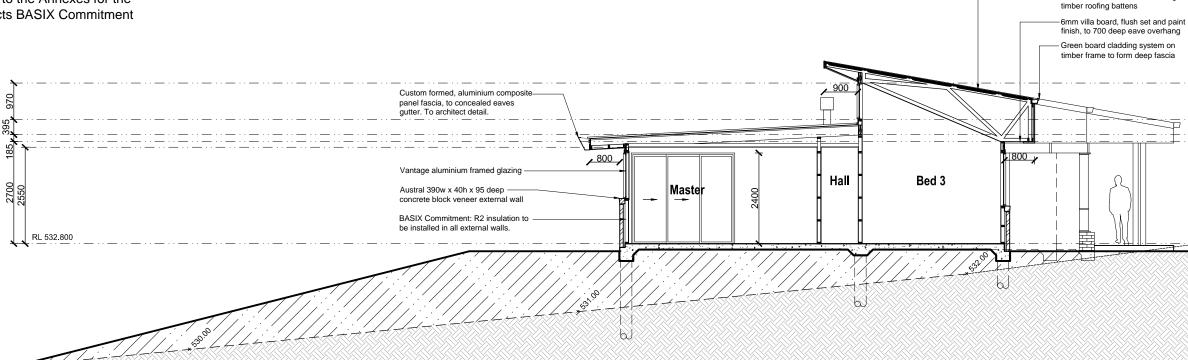





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SECTION E-E




SECTION F-F

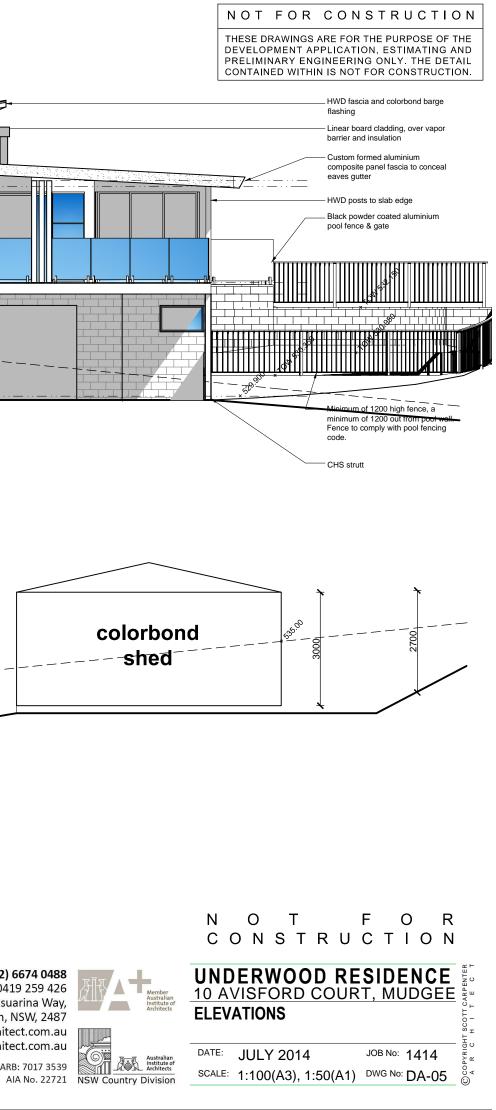NOTES:	ISSUE	DATE	DISTRIBUTION
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 DATE:
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 SCALE:
 1:100(A3), 1:50(A1)
 DWG No:
 DA-06

SECTIONS

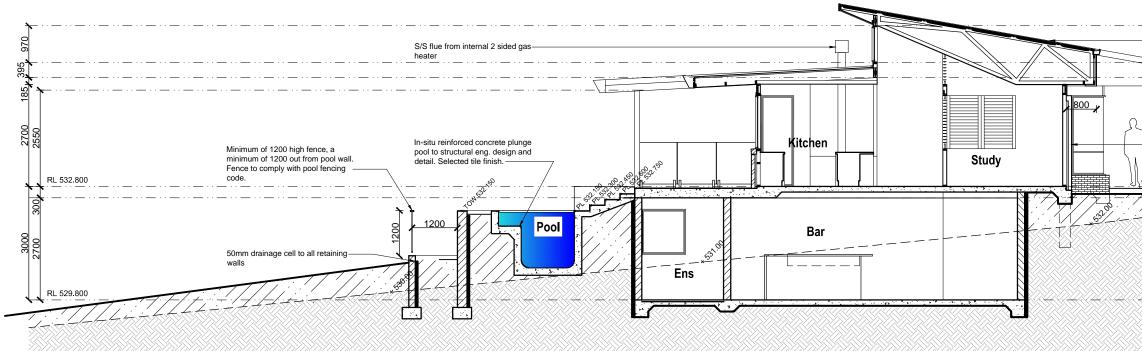ARB: 7017 3539 AIA No. 22721 NSW Country Division

×580× 970 ×	Selected colorbond roof sheeting	
2700	Frameless glazed balustrade with powder coated mini posts supporting the bottom edge of the panels only RL 532.800	
3000	Selected sectional panel lift garage	
	RL 529.800	

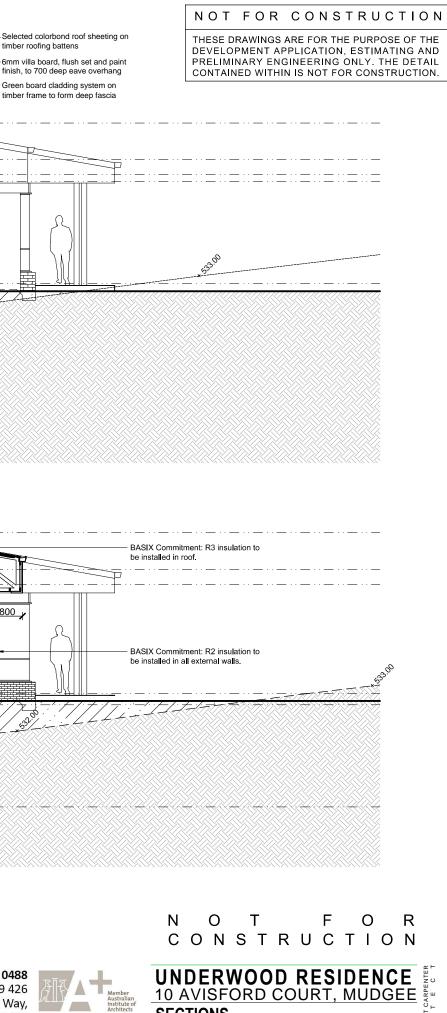SECTION G-G

NOTES:	ISSUE	DATE	DISTRIBUTION
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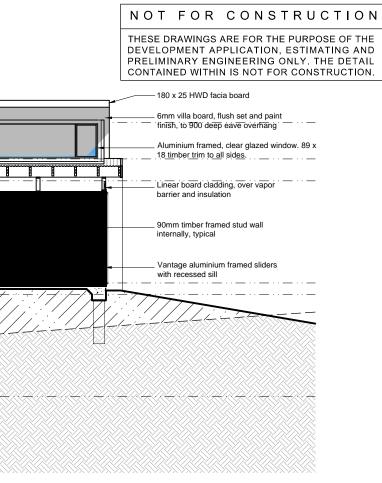



ARB: 7017 3539 ARB: 7017 3539 AIA No. 22721 NSW Country Division




Member Australian Institute of Architects

Australian Institute of Architects



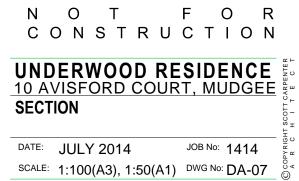



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SECTION H-H

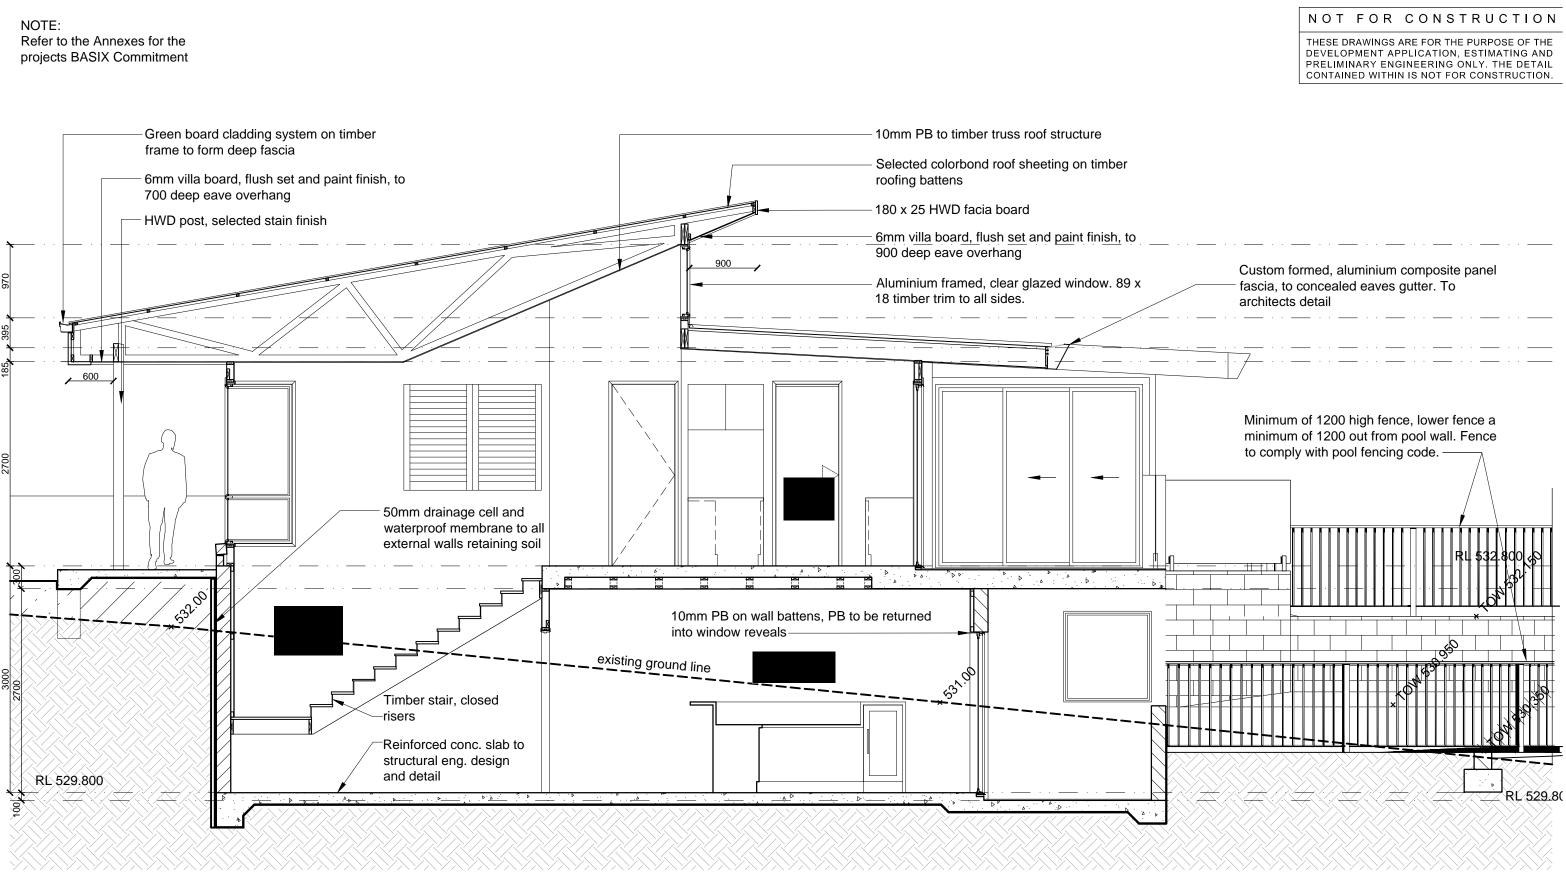
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DATE: JULY 2014 JOB No: 1414 SCALE: 1:50(A3), 1:25(A1) DWG No: DA-08



LINE DRAWING
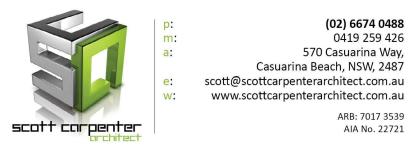
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e: w: (02) 6674 0488 0419 259 426 570 Casuarina Way, Casuarina Beach, NSW, 2487 scott@scottcarpenterarchitect.com.au www.scottcarpenterarchitect.com.au ARB: 7017 3539

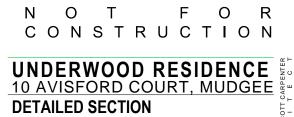

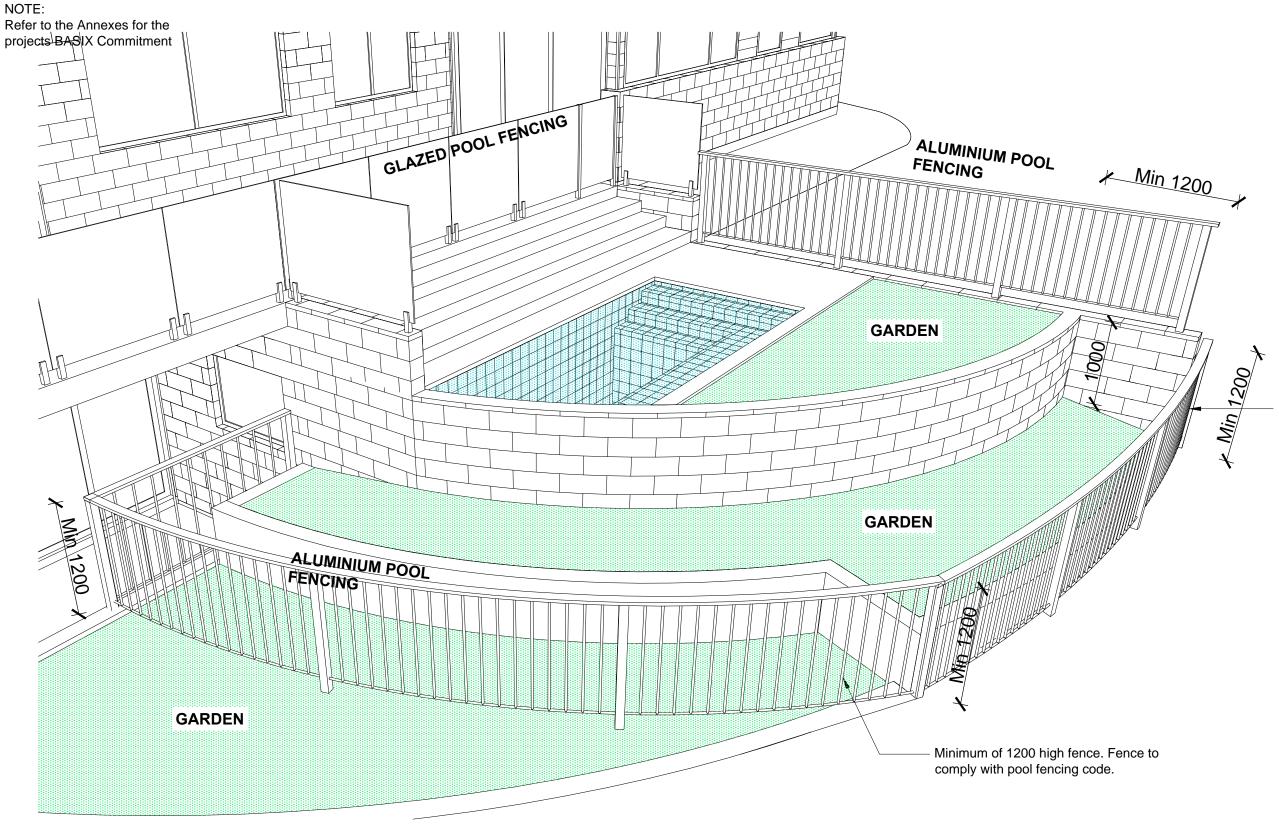NOT FOR CONSTRUCTION

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Minimum of 1200 high fence, a minimum of 1200 out from pool wall. Fence to comply with pool fencing code. Fence to follow the fall of the land. Offset from the retaining wall behind such that no foot hold is possible.







UNDERWOOD RESIDENCE 10 AVISFORD COURT, MUDGEE POOL FENCING PERSPECTIVE


ARB: 7017 3539 AIA No. 22721 NSW Country Division
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 DWG No:
 DA-09

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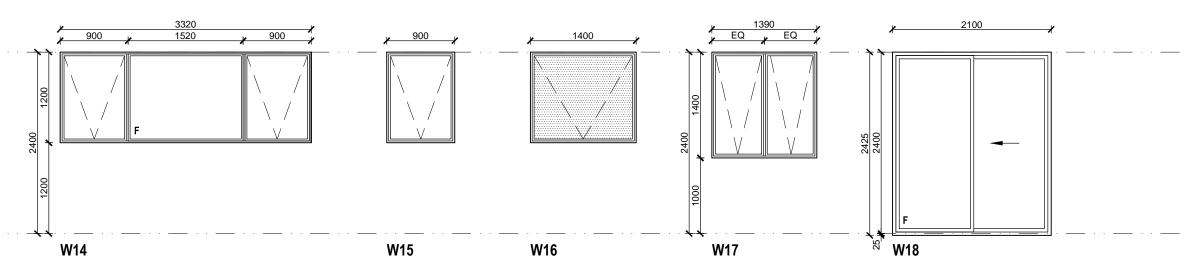



commencement of work. C 15 / 07 / '14 Amended Master P Verify all dimensions on site prior to commencement of work. D 12 / 08 / '14 Schematic Design All materials and workmanship shall be in accordance with E 05 / 09 / '14 Estimation Issue				
Refer any discrepancies to the Architect prior to commencement of work. B 08 / 07 / '14 Amended Master P Verify all dimensions on site prior to commencement of work. D 15 / 07 / '14 Amended Master P All materials and workmanship shall be in accordance with E 05 / 09 / '14 Schematic Design	NOTES:	ISSUE	DATE	DISTRIBUTION
	Refer any discrepancies to the Architect prior to commencement of work. Verify all dimensions on site prior to commencement of work. All materials and workmanship shall be in accordance with	B C D E	08 / 07 / '14 15 / 07 / '14 12 / 08 / '14 05 / 09 / '14	Amended Master PI Amended Master PI Schematic Design

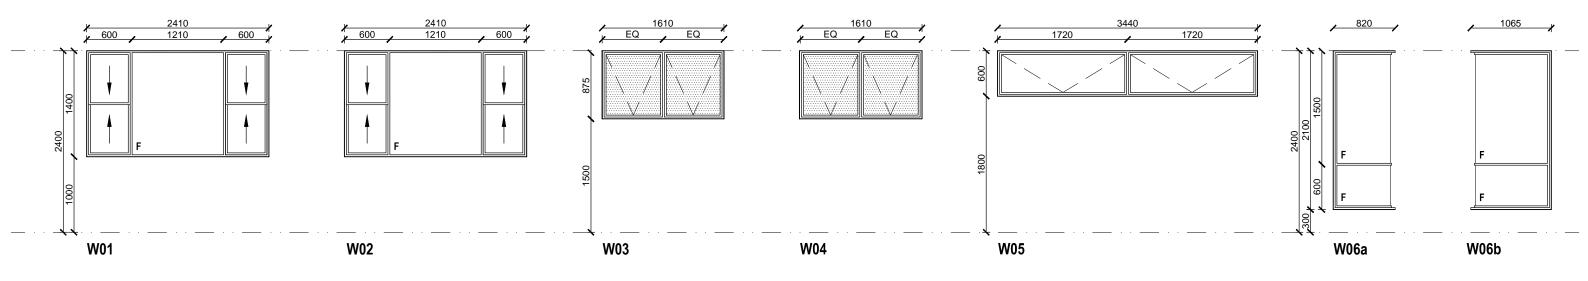

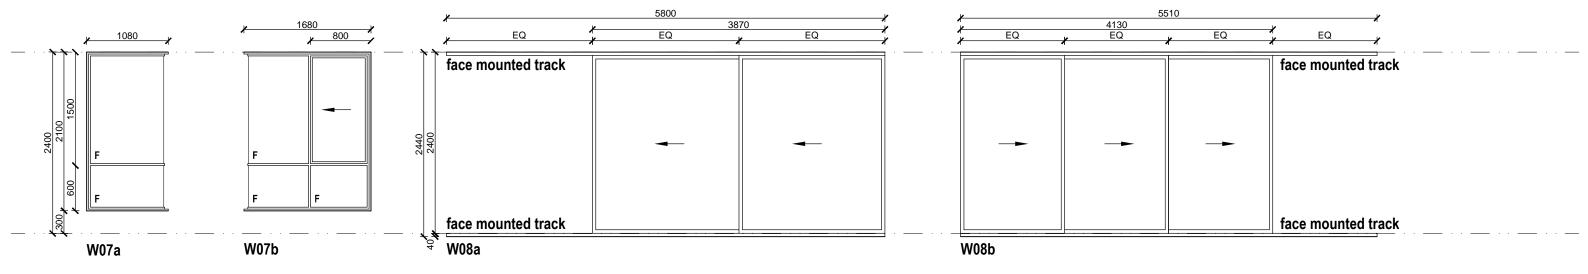

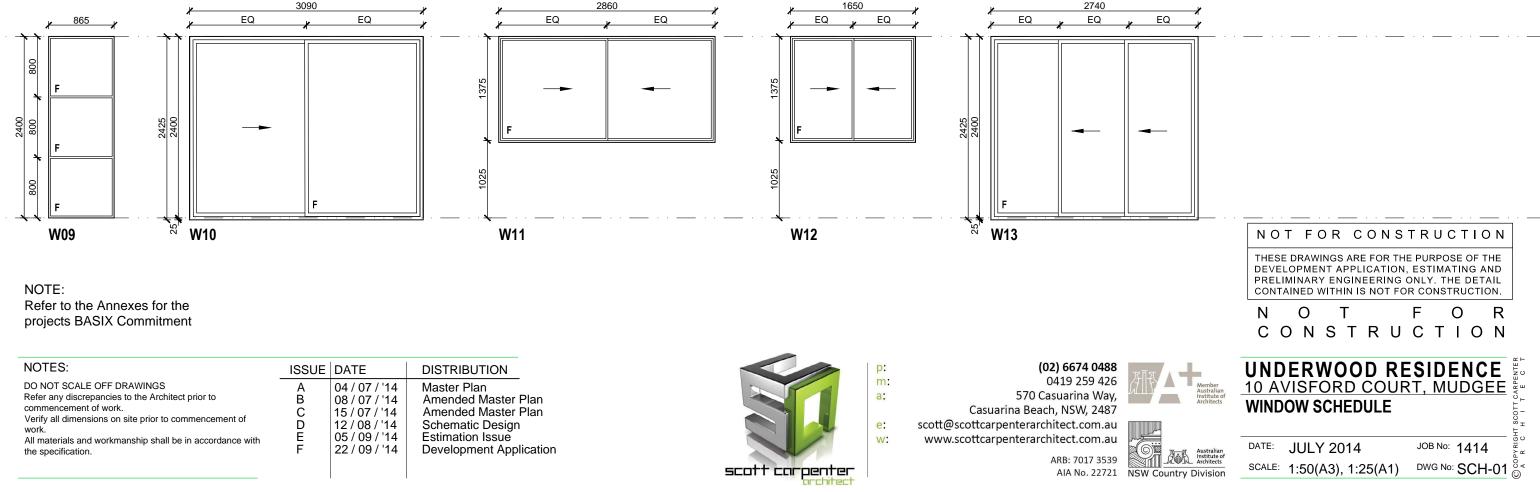



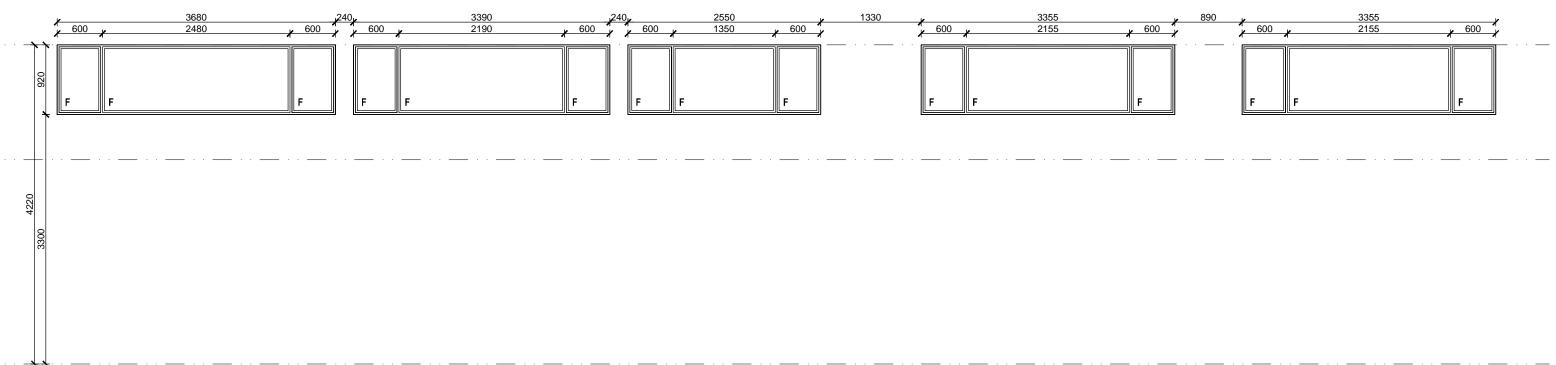


W19

W20

W21

W22

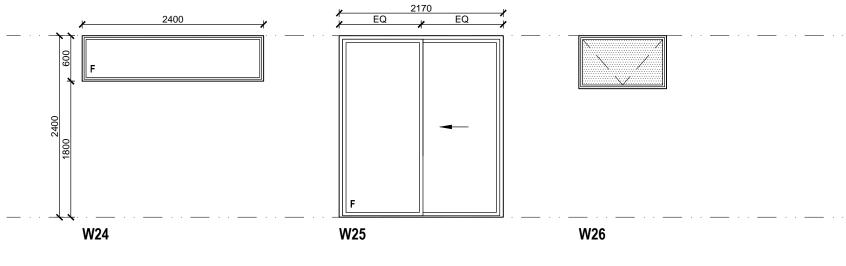

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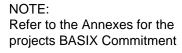
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BASIX Certificate

Building Sustainability Index www.basix.nsw.gov.au

Single Dwelling

Certificate number: 576355S

This certificate confirms that the proposed development will meet the NSW government's requirements for sustainability, if it is built in accordance with the commitments set out below. Terms used in this certificate, or in the commitments, have the meaning given by the document entitled "BASIX Definitions" dated 18/09/2014 published by Planning & Infrastructure. This document is available at water before provide a set of the www.basix.nsw.gov.au

Director-General Date of issue: Thursday, 18 September 2014 To be valid, this certificate must be lodged within 3 months of the date of issue.



Project name	Kathy & Craig Under	erwood
Street address	Avisford Court Mud	gee 2850
Local Government Area	Mid-Western Regio	nal Council
Plan type and plan number	deposited 1007792	
Lot no.	10	
Section no.	-	
Project type	separate dwelling h	ouse
No. of bedrooms	3	
Project score		
Water	y 31	Target 30
Thermal Comfort	V Pass	Target Pass
Energy	99	Target 35

Certificate Prepared by
Name / Company Name: Gabrielle O'Sullivan
ABN (if applicable): N/A

page 1/10

BASIX Planning & Infrastructure www.basix.nsw.gov.au Version: 6.32 / CASUARINA_2_27_6 Certificate No.: 576355S Thursday, 18 September 2014

Schedule of BASIX commitments

The commitments set out below regulate how the proposed development is to be carried out. It is a condition of any development consent granted, or complying development certificate issued, for the proposed development, that BASIX commitments be complied with.

	DA plans	plans & specs	check
ixtures			
he applicant must install showerheads with a minimum rating of 3 star (> 7.5 but <= 9 L/min) in all showers in the development.		v	~
he applicant must install a toilet flushing system with a minimum rating of 4 star in each toilet in the development.		V	~
he applicant must install taps with a minimum rating of 4 star in the kitchen in the development.		V	
he applicant must install basin taps with a minimum rating of 4 star in each bathroom in the development.		v	
Iternative water			
tainwater tank			
he applicant must install a rainwater tank of at least 10000 litres on the site. This rainwater tank must meet, and be installed in ccordance with, the requirements of all applicable regulatory authorities.	~	 ✓ 	~
he applicant must configure the rainwater tank to collect rain runoff from at least 300 square metres of the roof area of the evelopment (excluding the area of the roof which drains to any stormwater tank or private dam).		v	~
he applicant must connect the rainwater tank to:			
all toilets in the development		v	v
the cold water tap that supplies each clothes washer in the development		 Image: A set of the set of the	v .
 at least one outdoor tap in the development (Note: NSW Health does not recommend that rainwater be used for human consumption in areas with potable water supply.) 		 Image: A set of the set of the	v .
all hot water systems in the development		 ✓ 	V
all indoor cold water taps (not including taps that supply clothes washers) in the development		v	v .

NOTES:		DATE	DISTRIBUTION
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Project address			
Project name		aig Underwood	
Street address		d Court Mudgee 2850	
Local Government Area		n Regional Council	
Plan type and plan number		Plan 1007792	
Lot no.	10		
Section no.	-		
Project type			
Project type	separate d	velling house	
No. of bedrooms	3		
Site details			
Site area (m²)	4511		
Roof area (m²)	300		
Conditioned floor area (m2)	225		
Unconditioned floor area (m2)	60		
Total area of garden and lawn (m	12) 850		
X Planning & Infrastructure	www.basix.nsw.gov.au	Version: 6.32 / CASUARINA	2_27_

Water Commitments

BASIX

Swimming pool

The swimming pool must not have a volume greater than 11 kilolitres.

The swimming pool must have a pool cover.

The swimming pool must be outdoors.

0419 259 426 570 Casuarina Way, 🧧 Casuarina Beach, NSW, 2487 scott@scottcarpenterarchitect.com.au www.scottcarpenterarchitect.com.au

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(02) 6674 0488



scott corpenter architect

p:

m:

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A	lleede		
Assessor details and therma Assessor number	n/a		
Certificate number	n/a		
Climate zone Area adjusted cooling load (MJ/m².year)	n/a n/a		
Area adjusted heating load (MJ/m².year)	n/a		
Other			
none Project score	n/a		
Water	V 31	Target 30	
Thermal Comfort	V Pass	Target Pass	
Energy	✓ 99		
	9 9	Target 35	
Certificate No.: 576355S Thurse	day, 18 September 2014	page 2/10	
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	Show on Show on DA plans plans s	CC/CDC Certifier pecs check	
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Certificate No.: 576355S Thurs	day, 18 September 2014	page 4/10	
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Institute of Architects BASIX	REQUIREN	MENTS	
Architects	JULY 2014	JOB No: •	1414 ¥
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Thermal Comfort Commitments			Show on DA plans	Show on CC/CDC plans & specs	Certifier check
loor, walls and ceiling/roof					
'he applicant must construct the floor(s), walls, and ceiling/r elow.	oof of the dwelling in accordance with the specifications listed in	the table	v	¥	v
Construction	Additional insulation required (R-Value)	Other sp	ecifications		
oor - concrete slab on ground	nil				
oor - suspended floor above garage, concrete	0.4 (or 1 including construction) (down)				
xternal wall - brick veneer	1.66 (or 2.20 including construction)				
xternal wall - framed (weatherboard, fibre cement, metal lad)	1.80 (or 2.20 including construction)				
xternal wall - concrete block/plasterboard	1.68 (or 2.20 including construction)				
nternal wall shared with garage - 200 mm AAC block	nil				
eiling and roof - raked ceiling / pitched or skillion roof, ramed	ceiling: 3 (up), roof: foil/sarking	framed; d	ark (solar abs	orptance > 0.70)	
Insulation specified in this Certificate must be installe	d in accordance with Part 3.12.1.1 of the Building Code of Austr	ralia.			

Window/glazed door no.	Orientation	Maximum area (square metres)	Туре	Shading	Overshadowing
W8B	N	13.20	improved aluminium, double clear (U-value:4.12, SHGC:0.66)	eave/verandah/pergola/balcony >2,000 mm	not overshadowed
W9	E	2.07	improved aluminium, double clear (U-value:4.12, SHGC:0.66)	eave/verandah/pergola/balcony >2,000 mm	not overshadowed
W10, 11 & 12	N	13.56	improved aluminium, double clear (U-value:4.12, SHGC:0.66)	eave/verandah/pergola/balcony >2,000 mm	not overshadowed
W13	E	6.57	improved aluminium, double clear (U-value:4.12, SHGC:0.66)	eave/verandah/pergola/balcony >2,000 mm	not overshadowed
W14, 15, 16 & 17	N	9.44	improved aluminium, double clear (U-value:4.12, SHGC:0.66)	eave/verandah/pergola/balcony 751-900 mm	not overshadowed
W18	w	5.04	improved aluminium, double clear (U-value:4.12, SHGC:0.66)	eave/verandah/pergola/balcony 451-600 mm	not overshadowed
W19, 20, 21, 22 & 23	N	15.00	improved aluminium, double clear (U-value:4.12, SHGC:0.66)	eave/verandah/pergola/balcony 751-900 mm	not overshadowed
W24 & 25	N	6.64	improved aluminium, double clear (U-value:4.12, SHGC:0.66)	eave/verandah/pergola/balcony >2,000 mm	not overshadowed
W26	E	0.72	improved aluminium, double clear (U-value:4.12, SHGC:0.66)	eave/verandah/pergola/balcony >2,000 mm	not overshadowed

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lows, glazed doors and skylights	
mal Comfort Commitments	

tows, glazed doors and skylights pplicant must install the windows, glazed doors and shading devices described in the table below, in accordance with the ications listed in the table. Relevant overshadowing specifications must be satisfied for each window and glazed door. welling may have 1 skylight (<0.7 square metres) and up to 2 windows/glazed doors (<0.7 square metres) which are not liste ble.			check
welling may have 1 skylight (<0.7 square metres) and up to 2 windows/glazed doors (<0.7 square metres) which are not liste ble. sllowing requirements must also be satisfied in relation to each window and glazed door:			
illowing requirements must also be satisfied in relation to each window and glazed door:	ted in	✓	✓
	· · · ·	✓	
cept where the glass is single clear or 'single toned', each window and glazed door must have a U-value no greater than th	hat	×	
sted and a Solar Heat Gain Coefficient (SHGC) +/-10% of that listed. Total system U-values and SHGC must be calculated ccordance with National Fenestration Rating Council (NFRC) conditions.			
Ie leading edge of each eave, pergola, verandah, balcony or awning must be no more than 500 millimetres above the head vindow or glazed door, except that a projection greater than 500 mm and up to 1500 mm above the head must be twice the vinthe table.		~	~
rgolas with polycarbonate roof or similar translucent material must have a shading coefficient of less than 0.35.		_	
less they have adjustable shading, pergolas must have fixed battens parallel to the window or glazed door above which the ituated, unless the pergola also shades a perpendicular window. The spacing between battens must not be more than 50 m		v .	~
ow/glazed door no. Orientation Maximum area Type Shading (square metres)		Overshadowing	
2 S 6.72 improved aluminium, double clear (U-value:4.12, SHGC:0.66) 451-600 mm	-	not overshadowed	
& 5 S 4.86 improved aluminium, double clear (U-value:4.12, SHGC:0.66) eave/verandah/pergol 451-600 mm		not overshadowed	
W 1.70 improved aluminium, double clear (U-value:4.12, SHGC:0.66) eave/verandah/pergol 451-600 mm	ola/balcony	not overshadowed	
& 7A S 4.46 improved aluminium, double clear eave/verandah/pergol >2,000 mm	ola/balcony	not overshadowed	
E 3.52 improved aluminium, double clear (U-value:4.12, SHGC:0.66) eave/verandah/pergol 451-600 mm	ola/balcony	not overshadowed	
E 6.72 improved aluminium, double clear eave/verandah/pergol (U-value:4.12, SHGC:0.66) >2,000 mm	ola/balcony	not overshadowed	
gy Commitments water	Show on DA plans		Certifier check
gy Commitments water pplicant must install the following hot water system in the development, or a system with a higher energy rating: solar (gas ad) with a performance of 31 to 35 RECs or better.			
water pplicant must install the following hot water system in the development, or a system with a higher energy rating: solar (gas ad) with a performance of 31 to 35 RECs or better. ing system			
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iergy	Commitments	
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B



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Energy Commitments	Show on DA plans	Show on CC/CDC plans & specs	Certifier check
all bathrooms/toilets;		v	~
• the laundry;			U.
all hallways;			U.
latural lighting			
he applicant must install a window and/or skylight in the kitchen of the dwelling for natural lighting.		_	~
he applicant must install a window and/or skylight in 3 bathroom(s)/toilet(s) in the development for natural lighting.		~	V
Swimming pool			
he applicant must install the following heating system for the swimming pool in the development (or alternatively must not install an eating system for the swimming pool): solar only	4	v	
he applicant must install a timer for the swimming pool pump in the development.		v	
Nternative energy			1
he applicant must install a photovoltaic system with the capacity to generate at least 5 peak kilowatts of electricity as part of the evelopment. The applicant must connect this system to the development's electrical system.	~	~	~
Dther			
he applicant must install an induction cooktop & electric oven in the kitchen of the dwelling.		v	
he applicant must install a fixed outdoor clothes drying line as part of the development.		v	
	Thursday, 18 Septe		

In these commitment	s, "applicant" means the	person carrying out the de	evelopment.
		w on DA plans" column m e proposed development)	
		w on CC/CDC plans and s for the proposed develop	
Commitments identifi final) for the develop		ifier check" column must b	e certified by a cert

NOTES:		DATE	DISTRIBUTION
DO NOT SCALE OFF DRAWINGS Refer any discrepancies to the Architect prior to commencement of work. Verify all dimensions on site prior to commencement of work. All materials and workmanship shall be in accordance with the specification.	B C	04 / 07 / '14 08 / 07 / '14 15 / 07 / '14 12 / 08 / '14 05 / 09 / '14 22 / 09 / '14	Master Plan Amended Master I Amended Master I Schematic Design Estimation Issue Development Appl



p:

m: a:

e: W:

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