



LOCALITY PLAN

PROPOSED AREA OF WORKS



# **GENERAL NOTES:**

- 1. FIGURED DIMENSIONS ARE TO BE TAKEN IN PREFERENCE TO SCALED DIMENSIONS UNLESS OTHERWISE STATED. ALL DIMENSIONS ARE NOMINAL IE. DIMENSIONS ARE TO STRUCTURAL ELEMENTS AND DO NOT INCLUDE FINISHED SURFACES SUCH AS PLASTERBOARD, TILING ETC. ALL DIMENSIONS RELEVANT TO SETTING OUT & OFF-SITE WORK SHALL BE VERIFIED BY THE CONTRACTOR BEFORE CONSTRUCTION & FABRICATION.
- ALL DISCREPANCIES SHALL BE REFERRED TO 'ON POINT BUILDING DESIGN' FOR A DECISION BEFORE PROCEEDING WITH THE WORK
- 3. WORKMANSHIP & MATERIALS ARE TO BE IN ACCORDANCE WITH THE RELEVANT CURRENT S.A.A. CODES INCLUDING ALL AMENDMENTS, THE 'BUILDING CODE OF AUSTRALIA - VOLUME 2, 2016 '; POLICY REQUIREMENTS OF 'MID WESTERN REGIONAL COUNCIL';
- 4. ALL DIMENSIONS ARE IN MILLIMETRES UNLESS STATED OTHERWISE & LEVELS ARE EXPRESSED
- 5. ALL LEVELS, DIMENSIONS, SITE CONDITIONS & SERVICES, TO BE CHECKED & CONFIRMED ON SITE & WITH RELEVANT SERVICE AUTHORITIES, PRIOR TO CONSTRUCTION.
- 6. THE RELEVANT STATUTORY AUTHORITIES SHALL BE NOTIFIED IN ADVANCE & THEIR APPROVALS OR SERVICES, IF NECESSARY SHALL BE OBTAINED.

# CONSTRUCTION NOTES:

- ALL INTERNAL WALLS U.N.O TO BE 90mm TIMBER STUD FRAMED LINED WITH 10mm "GYPROCK -PLASTERBOARD CD' INTERNALLY & 10mm 'GYPROCK - AQUACHEK PLASTERBOARD' TO WET AREAS.
- 2. WET AREAS OF THE BUILDING IE. NEW BATHROOMS ARE TO BE PROTECTED BY THE INSTALLATION OF A WATER PROOFING SYSTEM COMPLYING WITH AS3740 - "WATERPROOFING OF WET AREAS".
- WALL FRAME BRACING, ROOF BRACING, & ALL 'TIE DOWN' FIXING DETAILS TO BE AS SPECIFIED & DETAILED BY TRUSS/FRAME MANUFACTURER.
- 4 ROOF WATER TO BE COLLECTED BY EAVES GUTTER & DISCHARGED TO DOWNPIPES THRU SUBSOIL PVE PIPES TO TANKS POSITIONED BY CLIENT, OVERFLOW TO BE DETERMINED ON SITE.
- 5. WATER TEMPERATURE TO ALL OUTLETS (EXCEPT LAUNDRY & KITCHEN) NOT TO EXCEED 50°C.
- 6. THE BUILDING IS TO BE PROTECTED AGAINST SUBTERRANEAN TERMITES, IN ACCORDANCE WITH 'AS, 3660'. A DURABLE NOTICE MUST BE PERMANENTLY FIXED TO THE BUILDING IN A PROMINENT POSITION SHOWING METHOD OF RISK MANAGEMENT, DATE OF INSTALLATION & INSTALLERS OR MANUFACTURER'S RECOMMENDATIONS FOR THE SCOPE & FREQUENCY OF FUTURE INSPECTIONS FOR TERMITE ACTIVITY.
- 7. ALL PLUMBING WORKS ARE TO BE IN ACCORDANCE WITH THE PLUMBING CODE OF AUSTRALIA (PCA), THE NEW SOUTH WALES CODE OF PRACTICE FOR PLUMBING & DRAINAGE 2006 (NSW PLUMBING CODE) & AS/NZS3500.

# PROPOSED EXTENSION

TO EXISTING RESIDENCE AT 144 MORTIMER STREET, MUDGEE

# DRAWING SCHEDULE

1259-A 01 3D PERSPECTIVES, LOCALITY PLAN & NOTES

1259-A 02 SITE LAYOUT

1259-A 03 SITE NOTES

1259-A 04 EXISTING & DEMOLITION FLOOR LAYOUT

1259-A 05 PROPOSED FLOOR LAYOUT

1259-A 06 ELEVATIONS 1/2

1259-A 07 ELEVATIONS 2/2

1259-A 08 TYPICAL SECTION & BASIX COMMITMENTS

1259-A 09 SAFE DESIGN OF STRUCTURES NOTES

ISSUED FOR APPROVAL



# **CONTACT DETAILS**

Gabrielle Hacket M. 0437 762 740

E. gabrielle@onpointbuildingdesign.com.au A. 17 Church Street, Mudgee NSW 2850

THIS DRAWING IS AND ALWAYS SHALL REMAIN THE

DO NOT ICALE
DIMENSIONS TO BE CHECKED ON SITE BEFORE
COMMERCEMENT OF WORK

ARLAN FAHEY-LEIGH

PROPOSED EXTENSION AT

144 MORTIMER STREET, MUDGEE

Drawing litle.

3D PERSPECTIVES, LOCALITY PLAN & NOTES

11/08/21 PRELIMINARY DRAWINGS 12/08/21 PRELIMINARY DRAWINGS 7/11/21 ISSUED FOR APPROVAL D 11/01/22 ISSUED FOR APPROVAL




**BUILDING DESIGNERS** ASSOCIATION OF AUSTRALIA


1259 - A01

D

Sheet 01 of 09

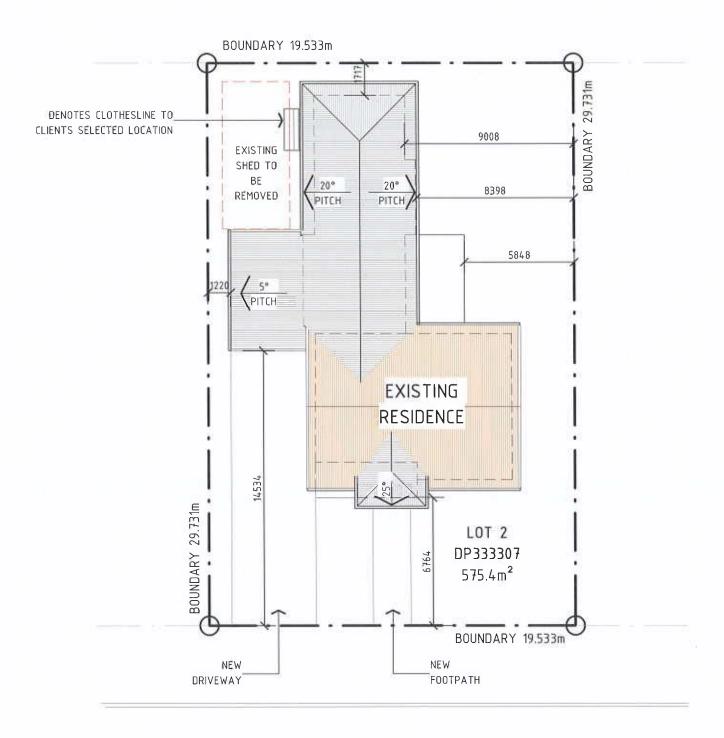

# MORTIMER STREET

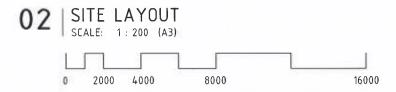





# CONTACT DETAILS

**M.** 0437 762 740

E. gabrielle@onpointbuildingdesign.com.auA. 17 Church Street, Mudgee NSW 2850

THE DRAWING IS AND ALWAYS SHALL REMAIN THE PROPERTY OF ON POINT BUILDING DESIGN AND MUST HOT BELENT GIVEN 300D, REPRODUCED OR VARIED IN ARY WAY WISHOUT WRITTEN CONSENS.

ALL DIMENSIONS ARE IN MILLIMETRES.

DO NOT SCALE.

DIMENSIONS TO SE CHECKED ON SITE BEFORE

COMMENCEMENT OF WORK.

Client:

ARLAN FAHEY-LEIGH

PROPOSED EXTENSION AT 144 MORTIMER STREET, MUDGEE

Drawing Title:

SITE LAYOUT

-	2000	
Rev	Date	Amendment
A	11/08/21	PRELIMINARY DRAWINGS
В	12/08/21	PRELIMINARY DRAWINGS
C	7/11/21	ISSUED FOR APPROVAL
D	11/01/00	ICCUED FOR ADDROVAL




Job Number

Revision


1259 - A02

D


Sheet 02 of 09

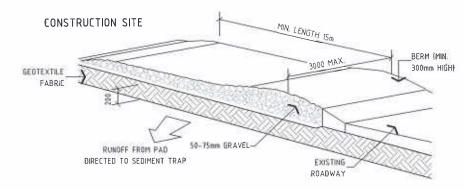

DETAIL PLAN: CONSTRUCTION ENTRY / EXIT NOT TO SCALE

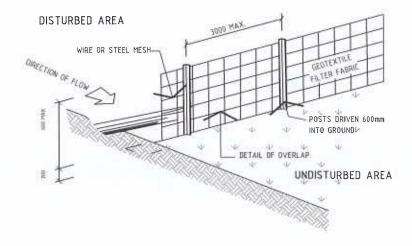

DETAIL PLAN: SEDIMENT FENCE NOT TO SCALE

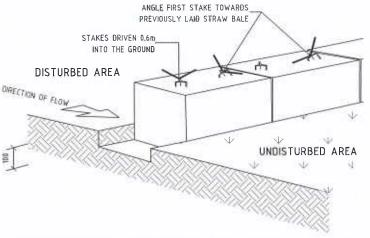

DETAIL PLAN: STRAWBALE FILTER NOT TO SCALE

# SITEWORK NOTES:

- 1. THIS PLAN IS PREPARED FROM A COMBINATION OF FIELD SURVEY & EXISTING RECORDS FOR THE PURPOSE OF DESIGNING NEW CONSTRUCTIONS ON THE LAND & SHOULD NOT BE USED FOR ANY OTHER PURPOSE. THE TITLE BOUNDARIES AS SHOWN HEREON WERE NOT MARKED AT THE TIME OF SURVEY & HAVE BEEN DETERMINED BY PLAN DIMENSIONS ONLY & NOT BY FIELD SURVEY.
- 2. SERVICES SHOWN HEREON HAVE BEEN LOCATED WHERE POSSIBLE BY FIELD SURVEY. IF NOT ABLE TO BE SO LOCATED SERVICES HAVE BEEN PLOTTED FROM THE RECORDS OF RELEVANT AUTHORITIES WHERE AVAILABLE & HAVE BEEN NOTED ACCORDINGLY ON THIS PLAN. WHERE SUCH RECORDS EITHER DO NOT EXIST OR ARE INADEQUATE A NOTATION HAS BEEN MADE HEREON.
- 3. PRIOR TO ANY DEMOLITION, EXCAVATION OR CONSTRUCTION ON THE SITE, THE RELEVANT AUTHORITY SHOULD BE CONTACTED FOR POSSIBLE LOCATION OF FURTHER UNDERGROUND SERVICES & DETAILED LOCATIONS OF ALL SERVICES.
- 4. SUBSEQUENT REGISTERED OR OTHER SURVEYS IN THIS AREA MAY AFFECT THE BOUNDARY DEFINITION SHOWN ON THIS PLAN, ANY DIFFERENCES SO CAUSED TO THE BOUNDARY DEFINITION SHOWN ON THIS PLAN ARE BEYOND THE CONTROL OF ON POINT BUILDING DESIGN WHO CAN ACCEPT NO RESPONSIBILITY FOR SUCH DIFFERENCES.
- 5. ALL WORK TO BE UNDERTAKEN IN ACCORDANCE WITH THE DETAILS SHOWN ON THE DRAWINGS, THE SPECIFICATIONS & THE DIRECTIONS OF THE SUPERINTENDENT. CONTRACTORS MUST VERIFY ALL DIMENSIONS & EXISTING LEVELS ON SITE PRIOR TO COMMENCEMENT OF WORK.
- 6. WHERE NEW WORKS ABUT EXISTING THE CONTRACTOR SHALL ENSURE THAT A SMOOTH EVEN PROFILE FREE FROM ABRUPT CHANGES IS OBTAINED.
- 7. CARE IS TO BE TAKEN WHEN EXCAVATING NEAR EXISTING SERVICES. NO MECHANICAL EXCAVATIONS ARE TO BE UNDERTAKEN OVER TELSTRA OR ELECTIRCAL SERVICES. HAND EXCAVATE IN THE THESE AREAS.

# **EROSION & SEDIMENT CONTROL NOTES:**

- 1. ALL EROSION & SEDIMENT CONTROL STRUCTURES ARE TO BE INSTALLED PRIOR TO SITE DISTURBANCE.
- 2. ALL SEDIMENT CONTROL STRUCTURES TO BE INSPECTED & MAINTAINED BY THE BUILDER AT LEAST WEEKLY, IF STRUCTURES ARE TO BE REMOVED, THEY ARE TO BE REINSTALLED & INSPECTED BY
- 3. ALL SEDIMENT RETAINING STRUCTURES TO BE CLEANED ON REACHING 50% STORAGE CAPACITY & SPREAD ON DISTURBED AREA.
- 4. ACCESS TO SITE IS TO BE THROUGH USE OF THE ENTRY/EXIT SHOWN
- 5. ALL VEGETATION OUTSIDE OF THE CONSTRUCTION AREA IS TO BE RETAINED WHERE POSSIBLE (VEGETATION BUFFER)
- 6. STOCKPILES OF ERODIBLE BUILDING MATERIALS INCLUDING SAND & SOIL MUST BE LOCATED WITHIN THE DESIGNATED MATERIAL STOCKPILE AREA (MSA) & PROTECTED WITH SEDIMENT FENCE OR
- 7. STRAW BALE SEDIMENT FILTERS. THE BUILDER MAY NOMINATE FURTHER STORAGE AREAS WITHIN THE SITE.
- 8. NO STORAGE OF MATERIALS OR VECHICLE MOVEMENTS ARE TO OCCUR OUTSIDE THE SITE BOUNDARIES.
- 9. TEMPORARY EROSION CONTROL MEASURES ARE SHOWN IN THIS PLAN.

# ROOFING PLAN NOTES:

- SELECTED 'COLORBOND' STEEL CORRUGATED ROOF CLADDING TO BE INSTALLED IN ACCORDANCE WITH MANUFACTURES INSTALLATION INSTRUCTIONIS & AS1562.1 DESIGN & INSTALLATION OF SHEET ROOF & WALL CLADDING - METAL (NCC VOL2 P3.5.1.0 (b))
- ROOFING TO BE INSTALLED AS PER AS/NZS3500.3
- DOWNPIPES ARE TO BE LOCATED WHERE THEY WILL NOT CREATE A HAZARD TO BUILDING USERS NOR IMPEDE WINDOW & DOOR OPENINGS & THE LIKE, THEY ARE TO BE INSTALLED AS CLOSE AS PRACTICABLE TO THE SUPPORTING STRUCTURE WHILE MAINTAING TERMITE INSPECTION CLEARANCES OF 25mm. DOWNPIPES ARE TO BE PROTECTED FROM POTENTIAL MECHANICAL DAMAGE, BE INSTALLED NO LESS THAN 100mm FROM ELECTRICAL CABLES & CABLES & GAS PIPES & NO LESS THAN 50mm FROM OTHER SERVICES (AS/NZS3500.3.2 S4.11)
- DOWNPIPES ARE TO SERVICE 12m MAXIMUM GUTTER LENGTH & BE WITHIN 1.2m FROM EACH VALLEY UNLESS OVERFLOW IS PROVIDED FOR (NCC VOL2P3.5.2.4 (b))
- THE PROPOSED ROOFING MUST BE INSTALLED TO PREVENT WATER PENETRATION INTO THE BUILDING STRUCTURE (NCC VOL2P2.2.2)
- ALL SARKING MATERIAL TO BE INSTALLED ACCORDING TO MAUFACTURERS INSTALLATION INSTRUCTIONS & AS/NZS400 INSTALLATION OF PLIABLE MEMBRANE AND UNDERLAY (NCC VOL2P3.7.1.9 (a))
- CORROSION PROTECTION OF METAL ROOF SHEETING IS REQUIRED TO MEET WITH MINIMAL COATING REQUIREMENTS OF MANUFACTURER
- GUTTERS, DOWPIPES & FLASHING FABRICATED WITH METAL ARE TO MEET AS/NZS2179 REQIREMENTS WHILE UPVC COMPONETNTS ARE TO COMPLY WITH AS1273
- NO LEAD ROOFING PRODUCTS ARE TO BE SPECIFIED TO PREVNET TOXINS FROM ENTERING ANY POTENTIAL POTABLE RAINWATER CATHMENT SUPPLIES (NCC VOL2P3.5.2.2 (d)) EAVE GUTTERS MUST HAVE A A 1:500 MINIMAL FALL (NCC VOL2 P3.5.2.4 (a) (i)) & DESIGNED TO AR120 (NCC VOL2 P3.5.2.3 (b) (ii))
- ROOF SHEETS TO BE LAPPED AWAY FROM PREVAILING WEATHER INGRESS (NCC VOL2 3.5.1.3 (d) (iii) (B)
- INSTALL SARKING OVER BATTENS UNDER ROOF SHEETING FOR IMPROVED MOISTURE DRAINAGE
- 12. BUILDER TO REFER TO TRUSSED ROOF BRACING NOMINATED BY THE TRUSS MANUFACTURER ROOF TRUSSES TO BE REDESIGNED & INSTALLED IN ACCORDANCE WITH AS4440:2004 INSTALLATION OF NAILPLATED TIMBER ROOF TRUSSES

П S 9

# **CONTACT DETAILS**

M. 0437 762 740

E. gabrielle@onpointbuildingdesign.com.au A. 17 Church Street, Mudgee NSW 2850

THIS DRAWING IS AND ALWAYS THALL REMAIN THE OPERTY OF ON POINT BUILDING DELIGN AND MUST NOT BE LENT, GIVEN, BOLD, REPRODUCED OR VARIED IN ANY WAY WITHOUT WEITTEN CORESM.

ALL DIMENSIONS ARE IN MILLIMETERS DO NOT SCALE
DIMENSIONS TO BE CHECKED ON SHE BEFORE
COMMENCEMENT OF WORK

Client

ARLAN FAHEY-LEIGH

PROPOSED EXTENSION AT 144 MORTIMER STREET MUDGEE

> Drawing Title: SITE NOTES

Date Amendment

11/08/21 PRELIMINARY DRAWINGS 12/08/21 PRELIMINARY DRAWINGS

7/11/21 ISSUED FOR APPROVAL

D 11/01/22 ISSUED FOR APPROVAL



**BUILDING DESIGNERS** ASSOCIATION OF AUSTRALIA

Job Number


1259 - A03

Sheet 03 of 09

D

**ISSUED FOR APPROVAL** 



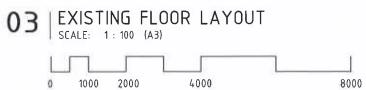



04 | DEMOLITION FLOOR LAYOUT



E. gabrielle@onpointbuildingdesign.com.au

A. 17 Church Street, Mudgee NSW 2850

THIS DEAWING IS AND ALWAYS SHALE REMAIN THE PEOPERTY OF ON POINT SUILDING DESIGN AND MISST NOT SELENT, GIVEN SUID, REPRODUCED OR VARIED IN A WAY WINDOW, PRITTED CONSON.

ALL DIMENSIONS ARE IN MILLIMETERS.
DID NOT SCALE.
DIMENSIONS TO BE CHECKED ON SITE BEFORE
COMMENCEMENT OF WORK.

Client:

ARLAN FAHEY-LEIGH

PROPOSED EXTENSION AT

144 MORTIMER STREET, MUDGEE

Drawing Title:

# **EXISTING & DEMOLITION** FLOOR LAYOUT

Rev Date Amendment A 11/08/21 PRELIMINARY DRAWINGS B 12/08/21 PRELIMINARY DRAWINGS C 7/11/21 ISSUED FOR APPROVAL D 11/01/22 ISSUED FOR APPROVAL




Job Number

D


1259 - A04


Sheet 04 of 09

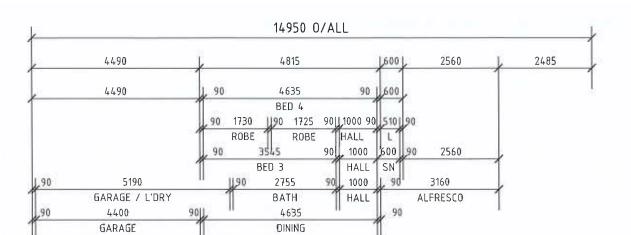





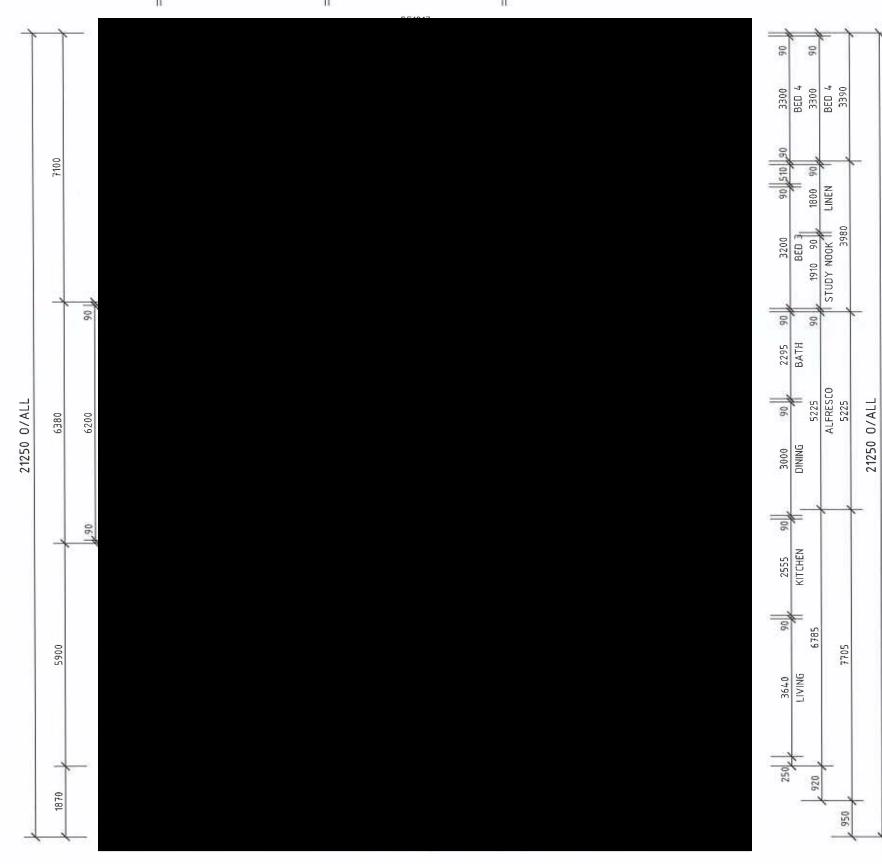

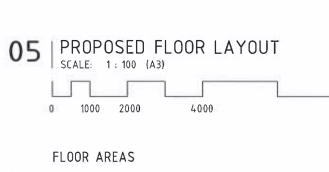

 $76 \text{ m}^2$ EXISTING LIVING  $17 \text{ m}^2$ PROPOSED ALFRESCO PROPOSED GARAGE  $30 \text{ m}^2$ EXISTING PORCH 10 m<sup>2</sup> PROPOSED LIVING 61 m² TOTAL  $194 \text{ m}^2$ 

# ISSUED FOR APPROVAL

8000



# CONTACT DETAILS

Gabrielle Hackett M. 0437 762 740

E. gabrielle@onpointbuildingdesign.com.au

A. 17 Church Street, Mudgee NSW 2850

THIS DNAWING IS AND ALWAYS SHALL REMAIN THE PROPERTY OF ON POINT BUILDING DESIGN AND MUST NOT BE LENT, GIVEN, SOLD, REPRODUCED OF VARIED IN ANY WAY WITHOUT WRITTEN CONSENT.

ALL DIMENSIONS ARE IN MILLIMETERS.

DO NOT TO ALE.

DIMENSIONS TO BE CHECKED ON SITE BEFORE

COMMENCEMENT OF WORK.

Client:

ARLAN FAHEY-LEIGH

PROPOSED EXTENSION AT 144 MORTIMER STREET, MUDGEE

Drawing Title:

# PROPOSED FLOOR LAYOUT

Rev	Date	Amendment
Α	11/08/21	PRELIMINARY DRAWINGS
В	12/08/21	PRELIMINARY DRAWINGS
C	7/11/21	ISSUED FOR APPROVAL
D	11/01/22	ISSUED FOR APPROVAL




ASSOCIATION OF AUSTRALIA


Job Number

D

1259 - A05

Sheet 05 of 09

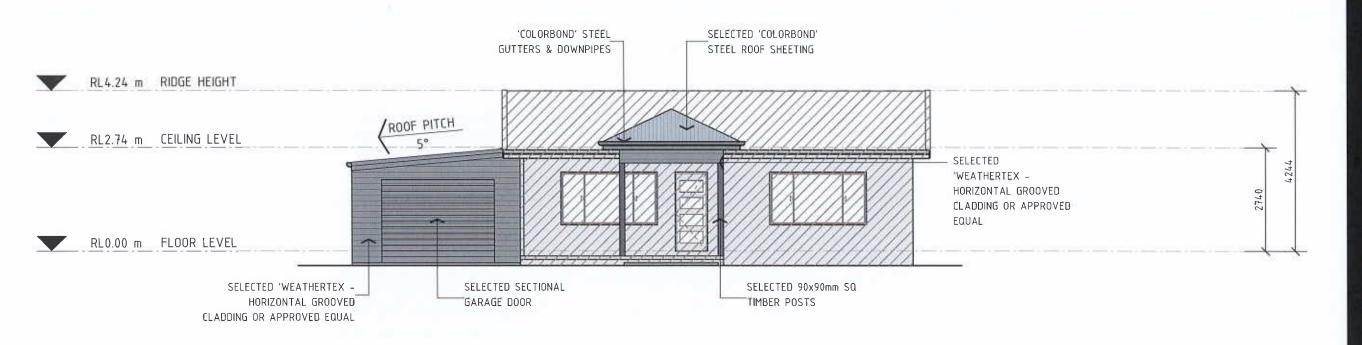

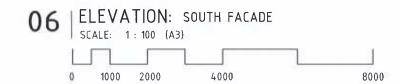



ELEVATION: WEST FACADE SCALE: 1:100 (A3)

# D ES <u>-</u> CONTACT DETAILS

Gabrielle Hackett M. 0437 762 740

E. gabrielle@onpointbuildingdesign.com.au A. 17 Church Street, Mudgee NSW 2850

THIS DRAWING IS AND ALWAYS SHALL REMAIN THE PROFERTY OF ON POINT BUILDING DESIGN AND MUST HOT BE LENT, GIVEN, SOLG, REPRODUCED OR VARIED IN ANY WAT WITHOUT WRITTEN CONSENT.

ALL DIMENSIONS ARE IN MILLIMSTREE.
DO NOT SCALE.
COMMENCEMENT OF WORK.

Client:

ARLAN FAHEY-LEIGH

PROPOSED EXTENSION AT 144 MORTIMER STREET, MUDGEE

Drawing Title:

**ELEVATIONS 1/2** 

A 11/08/21 PRELIMINARY DRAWINGS B 12/08/21 PRELIMINARY DRAWINGS C 7/11/21 ISSUED FOR APPROVAL D 11/01/22 ISSUED FOR APPROVAL


**BUILDING DESIGNERS** ASSOCIATION OF AUSTRALIA

ob Number

1259 - A06

D

Sheet 06 of 09

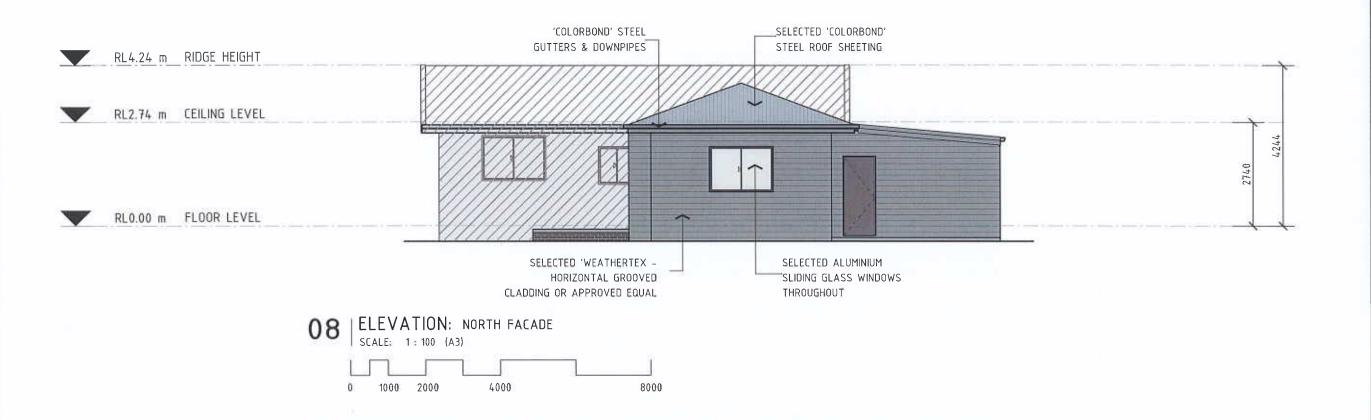



09 | ELEVATION: EAST FACADE SCALE: 1:100 (A3)

# **ISSUED FOR APPROVAL**



# CONTACT DETAILS

Gabrielle Hackett M. 0437 762 740

E. gabrielle@onpointbuildingdesign.com.au

A. 17 Church Street, Mudgee NSW 2850

THE DRAWING IS AND ALWAYS SHALL TEMAIN THE PRUTERTY OF ON POINT SUBDING DESIGN AND MUST NOT BE SENT GIVEN. SOLD, REPODUCED OR VARIED IN ANY WAY WITHOUT WESTER CONFERT.

ALL DIMENSIONS ARE IN MILLIMETERS.

BO NOT SCALE.

DIMENSIONS TO SE CHECKED ON STE SEFORE

COMMUNICAMENT OF WORK.

Client:

ARLAN FAHEY-LEIGH

PROPOSED EXTENSION AT 144 MORTIMER STREET. MUDGEE

Drawing Title:

**ELEVATIONS 2/2** 

A 11/08/21 PRELIMINARY DRAWINGS B 12/08/21 PRELIMINARY DRAWINGS C 7/11/21 ISSUED FOR APPROVAL D 11/01/22 ISSUED FOR APPROVAL




ASSOCIATION OF AUSTRALIA

1259 - A07

Job Number

Sheet 07 of 09

D

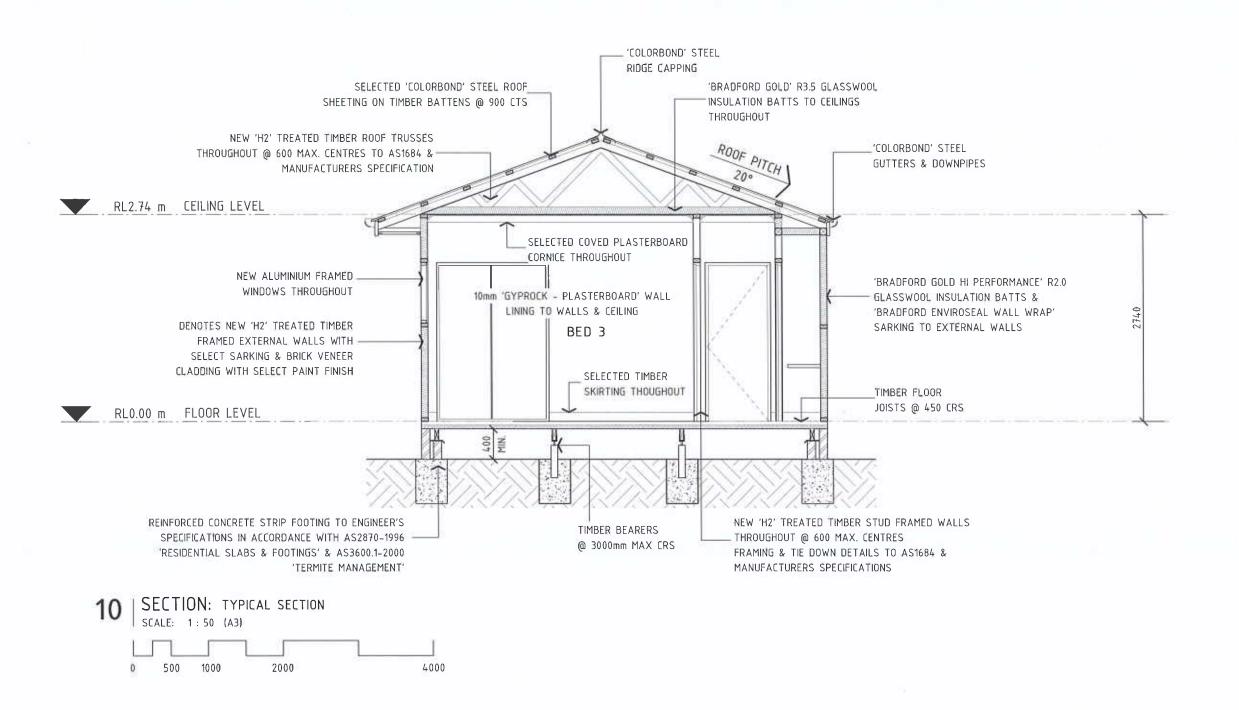

# BASIX CERTIFICATE COMMITMENTS:

# FIXTURES & SYSTEMS THE APPLICANT MUST COMPLY WITH THE COMMITMENTS LISTED BELOW IN CARRYING OUT THE DEVELOPMENT OF THE DWELLING. FIXTURES: THE APPLICANT MUST ENSURE NEW OR ALTERED SHOWERHEADS HAVE A FLOW RATE NO GREATER THAN 9 LITRES PER MINUTE OR A 3 STAR RATING. THE APPLICANT MUST ENSURE NEW OR ALTERED TOILETS HAVE A FLOW RATE NO GREATER THAN 4 LITRES PER AVERAGE FLUSH OR A MINIMUM 3 STAR WATER RATING. THE APPLICANT MUST ENSURE NEW OR ALTERED TAPS HAVE A FLOW RATE NO GREATER THAN 9 LITRES PER MINUTE OR MINIMUM 3 STAR WATER RATING. LIGHTING: THE APPLICANT MUST ENSURE A MINIMUM OF 40% OF NEW OR ALTERED LIGHT FIXTURES ARE FITTED WITH FLUORESCENT, OR LIGHT EMITTING DIODE (LED) LAMPS.

# GLAZING

THE APPLICANT MUST COMPLY WITH THE COMMITMENTS LISTED BELOW IN CARRYING OUT THE DEVELOPMENT OF THE DWELLING.

# WINDOWS & GLAZED DOORS:

THE APPLICANT MUST INSTALL THE WINDOWS, GLAZED DOORS AND SHADING DEVICES IN ACCORDANCE WIHT THE SPECIFICATIONS LISTED WITHIN THE BASIX CERTIFICATE.

# CONSTRUCTION

THE APPLICANT MUST COMPLY WITH THE COMMITMENTS LISTED BELOW IN CARRYING OUT THE DEVELOPMENT OF THE DWELLING.

# FLOOR, WALLS, CEILING/ROOF:

CONSTRUCTION	ADD. INSULATION REQ'D. (R-VALUE)	OTHER SPECIFICATIONS	
SUSPENDED FLOOR -	R1.00 (DOWN)		
ENCLOSED SUB-FLOOR	(OR R1.70 INCLUDING CONSTRUCTION)		
EXTERNAL WALL: WEATHERBOARD CLAD	R1.30 (OR 1.70 INCLUDING CONSTRUCTION)		
INTERNAL WALL SHARED WITH GARAGE: PLASTERBOARD	NIL		
CEILING & ROOF - FLAT	CEILING - R2.25 (UP)		
CEILING/PITCHED ROOF	ROOF - FOIL/SARKING	LIGHT (SOLAR ABSORBANCE < 0.475	



# **CONTACT DETAILS**

Gabrielle Hackett

M. 0437 762 740

E. gabrielle@onpointbuildingdesign.com.au
A. 17 Church Street, Mudgee NSW 2850

THIS DRAWING IS AMB ALWAYS SHALL REMAIN THE PROPERTY OF ON POINT BUILDING DESIGN AND MUST NOT BE LENT, GIVEN, SOLD, REPRODUCED OR VARIED IN ANY WAY WITHOUT WRITTEN CONTENT.

ALL DIMENSIONS ARE IN MILLIMITIES.
DO NOT SCALE.
DIMENSIONS TO BE CHECKED ON SITE BEFORE
COMMENCEMENT OF WORK.

ARLAN FAHEY-LEIGH

Project

PROPOSED EXTENSION AT 144 MORTIMER STREET, MUDGEE

Drawing Title

TYPICAL SECTION & BASIX COMMITMENTS

	Figv	Date	Amendment
	A	11/08/21	PRELIMINARY DRAWINGS
П	В	12/08/21	PRELIMINARY DRAWINGS
	C	7/11/21	ISSUED FOR APPROVAL
	D	11/01/22	ISSUED FOR APPROVAL



ASSOCIATION OF AUSTRALIA

Job Number

1259 - A08

D

Sheet 08 of 09

# SAFE DESIGN OF STRUCTURES NOTES:

FOR THE PURPOSE OF BUILDING, THE FOLLOWING SAFETY GUIDELINES ARE SET OUT HENCEFORTH IN ACCORDANCE WITH THE WORK HEALTH & SAFETY ACT 2011, WORK HEALTH & SAFETY REGULATION 2011 & THE SAFE DESIGN OF STRUCTURES CODE OF PRACTICE 2012.

THE GUIDELINES CONTAIN WORK HEALTH & SAFETY INFORMATION & MAY INCLUDE SOME OF YOUR OBLIGATIONS UNDER THE VARIOUS LEGISLATIONS THAT WORKCOVER NSW ADMINISTERS. TO ENSURE YOU COMPLY WITH YOUR LEGAL OBLIGATIONS YOU MUST REFER TO THE APPROPRIATE LEGISLATION.

# FALLS, SLIPS, TRIPS WORKING AT HEIGHTS

# i. DURING CONSTRUCTION

WHEREVER POSSIBLE, COMPONENTS FOR THIS BUILDING SHOULD BE PREFABRICATED OFF-SITE OR AT GROUND LEVEL TO MINIMISE THE RISK OF WORKERS FALLING MORE THAN TWO METRES, HOWEVER, CONSTRUCTION OF THIS BUILDING WILL REQUIRE WORKERS TO BE WORKING AT HEIGHTS WHERE A FALL IN EXCESS OF TWO METRES IS POSSIBLE & INJURY IS LIKELY TO RESULT FROM SUCH A FALL, TEMPORARY WORK PLATFORMS ARE TO BE ERECTED & MAINTAINED BY THE PRINCIPAL CONTRACTOR AS REQUIRED THROUGHOUT CONSTRUCTION WHEREVER A PERSON IS REQUIRED TO WORK IN A SITUATION WHERE FALLING MORE THAN TWO METRES IS A POSSIBILITY. THE ERECTION OF ALL PLATFORMS HOARDINGS OUTRIGGERS & SCAFFOLDING SHALL BE CONSTRUCTED IN ACCORDANCE WITH THE REQUIREMENTS OF THE RELEVANT AUTHORITIES & THE APPLICABLE AUSTRALIAN STANDARDS.

# II. DURING OPERATION OR MAINTENANCE

FOR HOUSES OR OTHER LOW-RISE BUILDINGS WHERE SCAFFOLDING IS APPROPRIATE:

CLEANING & MAINTENANCE OF WINDOWS, WALLS, ROOF OR OTHER COMPONENTS OF THIS BUILDING WILL REQUIRE PERSONS TO BE SITUATED WHERE A FALL FROM A HEIGHT IN EXCESS OF TWO METRES IS POSSIBLE. WHERE THIS TYPE OF ACTIVITY IS REQUIRED, A FALL ARREST SYSTEM, SCAFFOLDING, LADDERS OR TRESTLES SHOULD BE USED IN ACCORDANCE WITH RELEVANT CODES OF PRACTICE REGULATIONS OR LEGISLATION.

WHERE AN ANCHORAGE & FALL ARREST SYSTEM IS TO BE INSTALLED, THE ANCHORAGE & FALL ARREST SYSTEM & ALL ASSOCIATED HARNESSES & ACCESSORIES MUST BE MAINTAINED THROUGHOUT THE LIFECYCLE OF THE BUILDING & INSPECTED ON A REGULAR BASIS AT LEAST ONCE IN EVERY 6 MONTHS.

# SLIPPERY OR LINEVEN SLIREACES

## ELOOR FINISHES SPECIFIED

INISHES HAVE BEEN SPECIFIED BY DESIGNER, THESE HAVE BEEN SELECTED TO MINIMISE THE RISK OF FLOORS & PAVED AREAS BECOMING SLIPPERY WHEN WET OR WHEN WALKED ON WITH WET SHOES/FEET, ANY CHANGES TO THE SPECIFIED FINISH SHOULD BE MADE IN CONSULTATION WITH THE DESIGNER OR, IF THIS IS NOT PRACTICAL, SURFACES WITH AN EQUIVALENT OR BETTER SLIP RESISTANCE SHOULD BE CHOSEN

IF DESIGNER HAS NOT BEEN INVOLVED IN THE SELECTION OF SURFACE FINISHES. THE OWNER IS RESPONSIBLE FOR THE SELECTION OF SURFACE FINISHES IN THE PEDESTRIAN TRAFFICABLE AREAS OF THIS BUILDING, SURFACES SHOULD BE SELECTED IN ACCORDANCE WITH AS HB 197:1999 AND AS/NZ 4586:2004.

## STEPS LOOSE OBJECTS & UNEVEN SURFACES

DUE TO DESIGN RESTRICTIONS FOR THIS BUILDING, STEPS &/OR RAMPS ARE INCLUDED IN THE BUILDING WHICH MAY BE A HAZARD TO WORKERS CARRYING OBJECTS OR OTHERWISE OCCUPIED, STEPS SHOULD BE CLEARLY MARKED WITH BOTH VISUAL AND TACTILE WARNING DURING CONSTRUCTION, MAINTENANCE, DEMOLITION & AT ALL TIMES WHEN THE BUILDING

- W. BUILDING OWNERS & OCCUPIERS SHOULD MONITOR THE PEDESTRIAN ACCESS WAYS & IN PARTICULAR ACCESS TO AREAS WHERE MAINTENANCE IS ROUTINELY CARRIED OUT TO ENSURE THAT SURFACES HAVE NOT MOVED OR CRACKED SO THAT THEY BECOME UNEVEN & PRESENT A TRIP HAZARD. SPILLS, LOOSE MATERIAL, STRAY OBJECTS OR ANY OTHER MATTER THAT MAY CAUSE A SLIP OR TRIP HAZARD SHOULD BE CLEANED OR REMOVED FROM ACCESS WAYS.
- VI CONTRACTORS SHOULD BE REQUIRED TO MAINTAIN A TIDY WORK SITE DURING CONSTRUCTION, MAINTENANCE OR DEMOLITION TO REDUCE THE RISK OF TRIPS & FALLS IN THE WORKPLACE. MATERIALS FOR CONSTRUCTION OR MAINTENANCE SHOULD BE STORED IN DESIGNATED AREAS AWAY FROM ACCESS WAYS & WORK AREAS.
- ALTHOUGH DURING SPECIFICATION CARE HAS BEEN TAKEN TO ENSURE THE USE OF MATERIALS THAT ARE CHARACTERISTICALLY DEEMED AS 'NON-SLIP'. THE DESIGNER IS UNABLE TO CONFIRM NOR CERTIFY THE SLIP RESISTANCE OF EXISTING MATERIALS USED THROUGHOUT THE EXISTING BUILDING, IT IS RECOMMENDED THAT SLIP RESISTANCE TESTING BE UNDERTAKEN ON THE EXISTING MATERIALS IN ACCORDANCE WITH AUSTRALIAN STANDARDS TO ENSURE COMPLIANCE WITH BUILDING CODE OF AUSTRALIA.
- ALTHOUGH THE ROOF HAS BEEN DESIGNED IN ACCORDANCE WITH THE BUILDING CODE OF AUSTRALIA & ALL RELEVANT STANDARDS, THE CLIENT IS TO BE AWARE THAT THE ROOF MATERIALS HAS POTENTIAL FRAGILITY & SLIP RESISTANCE ISSUES THAT MAY ARISE THROUGHOUT CONSTRUCTION & THE LIFECYCLE OF THE BUILDING WHEN WORK IS UNDERTAKEN ON THE ROOF, ESPECIALLY DURING INCLEMENT WEATHER

# FALLING OBJECTS

# LOOSE MATERIALS OR SMALL OBJECTS

CONSTRUCTION, MAINTENANCE OR DEMOLITION WORK ON OR AROUND THIS BUILDING IS LIKELY TO INVOLVE PERSONS WORKING ABOVE GROUND LEVEL OR ABOVE FLOOR LEVELS. WHERE THIS OCCURS ONE OF THE FOLLOWING MEASURES SHOULD BE TAKEN TO AVOID OBJECTS FALLING FROM THE AREA WHERE THE WORK IS BEING CARRIED OUT ONTO PERSONS BELOW. PREVENT OR RESTRICT ACCESS TO AREAS BELOW WHERE THE WORK IS BEING CARRIED OUT.

- PROVIDE TOEBOARDS TO SCAFFOLDING OR WORK PLATFORMS.
- III PROVIDE PROTECTIVE STRUCTURE BELOW THE WORK AREA.
- iv. ENSURE THAT ALL PERSONS BELOW THE WORK AREA HAVE PERSONAL PROTECTIVE EQUIPMENT (PPE).

RURING CONSTRUCTION REPOYATION OF DEMOLITION OF THIS BUILDING PARTS OF THE STRUCTURE INCLUDING FABRICATED STEELWORK HEAVY PARELS & MANY OTHER COMPONENTS WILL REMAIN STANDING PRIOR TO OR AFTER SUPPORTING PARTS ARE IN PLACE. CONTRACTORS SHOULD ENSURE THAT TEMPORARY BRACING OR OTHER REQUIRED SUPPORT IS IN PLACE AT ALL TIMES WHEN COLLAPSE WHICH MAY INJURE PERSONS IN THE AREA IS A POSSIBILITY.

MECHANICAL LIFTING OF MATERIALS & COMPONENTS DURING CONSTRUCTION, MAINTENANCE OR DEMOLITION PRESENTS A RISK OF FALLING OBJECTS. CONTRACTORS SHOULD ENSURE THAT APPROPRIATE LIFTING DEVICES ARE USED, THAT LOADS ARE PROPERLY SECURED & THAT ACCESS TO AREAS BELOW THE LOAD IS PREVENTED OR RESTRICTED.

IT IS THE RESPONSIBILITY OF THE CLIENT TO ENSURE ALL PERSONNEL & VISITING CLIENTELE ARE AWARE OF ALL FIRE SAFETY PROCEDURES, WITH EMERGENCY ROUTES & EXITS DISPLAYED THROUGHOUT THE BUILDING & MAINTAINED THROUGHOUT THE LIFECYCLE OF THE BUILDING. NO COMBUSTIBLE MATERIAL & RUBBISH WILL BE LEFT ON SITE AS TO CAUSE A FIRE HAZARD.

# TRAFFIC MANAGEMENT

FOR BUILDING ON A MAJOR ROAD, NARROW ROAD OR STEEPLY SLOPING ROAD:

PARKING OF VEHICLES OR LOADING/UNLOADING OF VEHICLES ON THIS ROADWAY MAY CAUSE A TRAFFIC HAZARD DURING CONSTRUCTION NO COMBUSTIBLE MATERIAL & RUBBISH WILL BE LEFT ON SITE AS TO CAUSE A FIRE HAZARD, MANAGEMENT PERSONNEL SHOULD BE RESPONSIBLE FOR THE SUPERVISION OF THESE AREAS FOR BUILDING WHERE ON-SITE LOADING/UNLOADING IS RESTRICTED:

CONSTRUCTION OF THIS BUILDING WILL REQUIRE LOADING & UNLOADING OF MATERIALS ON THE ROADWAY, DELIVERIES SHOULD BE WELL PLANNED TO AVOID CONGESTION OF LOADING AREAS & TRAINED TRAFFIC MANAGEMENT PERSONNEL SHOULD BE USED TO SUPERVISE LOADING/UNLOADING AREAS.

# FOR ALL BUILDINGS:

BUSY CONSTRUCTION & DEMOLITION SITES PRESENT A RISK OF COLLISION WHERE DELIVERIES & OTHER TRAFFIC ARE MOVING WITHIN THE SITE, A TRAFFIC MANAGEMENT PLAN SUPERVISED BY TRAINED TRAFFIC MANAGEMENT PERSONNEL SHOULD BE ADOPTED FOR THE WORK SITE.

RUPTURE OF SERVICES DURING EXCAVATION OR OTHER ACTIVITY CREATES A VARIETY OF RISKS INCLUDING RELEASE OF HAZARDOUS MATERIAL. EXISTING SERVICES ARE LOCATED ON OR AROUND THIS SITE, WHERE KNOWN, THESE ARE IDENTIFIED ON THE PLANS BUT THE EXACT LOCATION & EXTENT OF SERVICES MAY VARY FROM THAT INDICATED. SERVICES SHOULD BE LOCATED USING AN APPROPRIATE SERVICE (SUCH AS DIAL BEFORE YOU DIG), APPROPRIATE EXCAVATION PRACTICE SHOULD BE USED &, WHERE NECESSARY, SPECIALIST CONTRACTORS SHOULD BE USED.

UNDERGROUND POWER LINES MAY BE LOCATED IN OR AROUND THIS SITE, ALL UNDERGROUND POWER LINES MUST BE DISCONNECTED OR CAREFULLY LOCATED & ADEQUATE WARNING SIGNS USED PRIOR TO ANY CONSTRUCTION, MAINTENANCE OR DEMOLITION COMMENCING.

# LOCATIONS WITH OVERHEAD POWERLINES:

OVERHEAD POWERLINES MAY BE NEAR OR ON THIS SITE. THESE POSE A RISK OF ELECTROCUTION IF STRUCK OR APPROACHED BY LIFTING DEVICES OR OTHER PLANT & PERSONS WORKING ABOVE GROUND LEVEL. WHERE THERE IS A DANGER OF THIS OCCURRING, POWERLINES SHOULD BE, WHERE PRACTICAL, DISCONNECTED OR RELOCATED. WHERE THIS IS NOT PRACTICAL ADEQUATE WARNING IN THE FORM OF BRIGHT COLOURED TAPE OR SIGNAGE SHOULD BE USED OR A PROTECTIVE BARRIER PROVIDED

# **EARTHWORKS**

IT IS THE RESPONSIBILITY OF THE PRINCIPAL CONTRACTOR TO ESTABLISH THE LOCATION & THE LEVEL OF ALL EXISTING SERVICES PRIOR TO THE COMMENCEMENT OF ANY WORK ANY DISCREPANCIES SHALL BE REPORTED TO THE SUPERINTENDENT, CLEARANCES SHALL BE OBTAINED FROM THE RELEVANT SERVICE AUTHORITY.

TO ENABLE THE PLACEMENT OF NEW STORMWATER SERVICES, TRENCH EXCAVATIONS WILL OCCUR ON SITE. IT IS TO BE THE RESPONSIBILITY OF THE PRINCIPAL CONTRACTOR TO ENSURE THAT ALL SAFETY RISKS ASSOCIATED WITH TRENCH EXCAVATION ARE IDENTIFIED, ADDRESSED & ADHERED TO THROUGHOUT CONSTRUCTION.

# MANUAL TASKS

COMPONENTS WITHIN THIS DESIGN WITH A MASS IN EXCESS OF 25KG SHOULD BE LIFTED BY TWO OR MORE WORKERS OR BY MECHANICAL LIFTING DEVICE. WHERE THIS IS NOT PRACTICAL SUPPLIERS OR FABRICATORS SHOULD BE REQUIRED TO LIMIT THE COMPONENT MASS.

ALL MATERIAL PACKAGING, BUILDING & MAINTENANCE COMPONENTS SHOULD CLEARLY SHOW THE TOTAL MASS OF PACKAGES & WHERE PRACTICAL ALL ITEMS SHOULD BE STORED ON SITE IN A WAY WHICH MINIMISES BENDING BEFORE LIFTING, ADVICE SHOULD BE PROVIDED ON SAFE LIFTING METHODS IN ALL AREAS WHERE LIFTING MAY OCCUR, CONSTRUCTION, MAINTENANCE & DEMOLITION OF THIS BUILDING WILL REQUIRE THE USE OF PORTABLE TOOLS & EQUIPMENT. THESE SHOULD BE SPECIFICATIONS & NOT USED WHERE FAULTY OR (IN THE CASE OF ELECTRICAL EQUIPMENT) NOT CARRYING A CURRENT ELECTRICAL SAFETY TAG. ALL SAFETY GUARDS OR DEVICES SHOULD BE REGULARLY CHECKED & PERSONAL PROTECTIVE EQUIPMENT SHOULD BE USED IN ACCORDANCE WITH MANUFACTURER'S SPECIFICATION.

# STRUCTURAL SAFETY

ALL PROTECTION WORKS TO ANY ADJOINING BUILDING (AS REQUIRED) WILL BE IN PLACE BEFORE DEMOLITION WORKS.

DEMOLITION & REMOVAL OF THE BUILDING SHALL BE UNDERTAKEN IN A CAREFUL & PROPER MANNER & WITH A MINIMUM DISTURBANCE TO THE ADJOINING BUILDINGS & TO THE PUBLIC & THE OCCUPANTS.

ALL PRACTICABLE PRECAUTIONS SHALL BE TAKEN TO AVOID DANGER FROM COLLAPSE OF A BUILDING WHEN ANY PART OF A FRAMED MEMBER IS REMOVED.

NO NEW OR EXISTING WALL OR OTHER STRUCTURE SHALL BE LEFT FREE STANDING & UNATTENDED WITHOUT TEMPORARY BRACING OR SUPPORTS IN SUCH A CONDITION THAT IT MAY COLLAPSE DUE TO WIND OR VIBRATION.

# CONFINED SPACES

# **EXCAVATION**

CONSTRUCTION OF THIS BUILDING & SOME MAINTENANCE ON THE BUILDING WILL REQUIRE EXCAVATION & INSTALLATION SHOULD BE CARRIED OUT USING METHODS WHICH DO NOT REQUIRE WORKERS TO ENTER THE EXCAVATION, WHERE THIS IS NOT PRACTICAL ADEQUATE SUPPORT FOR THE EXCAVATED AREA SHOULD BE PROVIDED TO PREVENT COLLAPSE, WARNING SIGNS & BARRIERS TO PREVENT ACCIDENTAL OR UNAUTHORISED ACCESS TO ALL EXCAVATIONS SHOULD BE PROVIDED.

# ENCLOSED SPACES

FOR BUILDINGS WITH ENCLOSED SPACES WHERE MAINTENANCE OR OTHER ACCESS MAY BE REQUIRED, ENCLOSED SPACES WITHIN THIS BUILDING MAY PRESENT A RISK TO PERSONS ENTERING FOR CONSTRUCTION, MAINTENANCE, OR ANY OTHER PURPOSE. THE DESIGN DOCUMENTATION CALLS FOR WARNING SIGNS & BARRIERS TO UNAUTHORISED ACCESS. THESE SHOULD BE MAINTAINED THROUGHOUT THE LIFE OF THE BUILDING. WHERE WORKERS ARE REQUIRED TO ENTER ENCLOSED SPACES, AIR TESTING EQUIPMENT & PERSONAL PROTECTIVE EQUIPMENT SHOULD BE PROVIDED.

# SMALL SPACES

FOR BUILDINGS WITH SMALL SPACES WHERE MAINTENANCE OR OTHER ACCESS MAY BE REQUIRED.

SOME SMALL SPACES WITHIN THIS BUILDING WILL REQUIRE ACCESS BY CONSTRUCTION OR MAINTENANCE WORKERS. THE DESIGN DOCUMENTATION CALLS FOR WARNING SIGNS & BARRIERS TO UNAUTHORISED ACCESS. THESE SHOULD BE MAINTAINED THROUGHOUT THE LIFE OF THE BUILDING. WHERE WORKERS ARE REQUIRED TO ENTER SMALL SPACES THEY SHOULD BE SCHEDULED SO THAT ACCESS IS FOR SHORT PERIODS, MANUAL LIFTING & OTHER MANUAL ACTIVITY SHOULD BE RESTRICTED IN SMALL SPACES.

# HAZARDOUS SUBSTANCES

ALTHOUGH DURING SPECIFICATION CARE HAS BEEN TAKEN TO ENSURE THE USE OF NON HAZARDOUS MATERIALS THE POSSIBILITIES OF EXPOSURE STILL EXIST & AS SUCH ALL PRECAUTIONS SHOULD BE MADE DURING USE IN ACCORDANCE WITH MANUFACTURERS SPECIFICATIONS.

# ASBESTOS

FOR ALTERATIONS TO A BUILDING CONSTRUCTED PRIOR TO 1990:

IF THIS EXISTING BUILDING WAS CONSTRUCTED PRIOR TO: 1990- IT THEREFORE IS LIKELY TO CONTAIN ASBESTOS

1986- IT THEREFORE MAY CONTAIN ASBESTOS EITHER IN CLADDING MATERIAL OR IN FIRE RETARDANT INSULATION MATERIAL, IN EITHER CASE, THE BUILDER SHOULD CHECK & IF NECESSARY, TAKE APPROPRIATE ACTION BEFORE DEMOLISHING, CUTTING, SANDING, DRILLING OR OTHERWISE DISTURBING THE EXISTING STRUCTURE.

MANY MATERIALS USED IN THE CONSTRUCTION OF THIS BUILDING CAN CAUSE HARM IF INHALED IN POWDERED FORM. PERSONS WORKING ON OR IN THE BUILDING DURING CONSTRUCTION, OPERATIONAL MAINTENANCE OR DEMOLITION SHOULD ENSURE GOOD VENTILATION & WEAR PERSONAL PROTECTIVE EQUIPMENT INCLUDING PROTECTION AGAINST INHALATION WHILE USING POWDERED MATERIAL OR WHEN SANDING, DRILLING, CUTTING OR OTHERWISE DISTURBING OR CREATING POWDERED MATERIAL.

# TREATED TIMBER

THE DESIGN OF THIS BUILDING MAY INCLUDE PROVISION FOR THE INCLUSION OF TREATED TIMBER WITHIN THE STRUCTURE, DUST OR FUMES FROM THIS MATERIAL CAN BE HARMFUL. PERSONS WORKING ON OR IN THE BUILDING DURING CONSTRUCTION, OPERATIONAL MAINTENANCE OR DEMOLITION SHOULD ENSURE GOOD VENTILATION & WEAR PERSONAL PROTECTIVE EQUIPMENT INCLUDING PROTECTION AGAINST INHALATION OF HARMFUL MATERIAL WHEN SANDING, DRILLING, CUTTING OR USING TREATED TIMBER IN ANY WAY THAT MAY CAUSE HARMFUL MATERIAL TO BE RELEASED DO NOT BURN TREATED TIMBER.

# VOLATILE ORGANIC COMPOLINOS

MANY TYPES OF GLUE, SOLVENTS, SPRAY PACKS, PAINTS, VARNISHES & SOME CLEANING MATERIALS & DISINFECTANTS HAVE DANGEROUS EMISSIONS. AREAS WHERE THESE ARE USED SHOULD BE KEPT WELL VENTILATED WHILE THE MATERIAL IS BEING USED & FOR A PERIOD AFTER INSTALLATION, PERSONAL PROTECTIVE EQUIPMENT MAY ALSO BE REQUIRED. THE MANUFACTURER'S RECOMMENDATIONS FOR USE MUST BE CAREFULLY CONSIDERED AT ALL TIMES.

# SYNTHETIC MINERAL FIRRE

FIRREGLASS, ROCKWOOL, CERAMIC AND OTHER MATERIAL USED FOR THERMAL OR SOUND INSULATION MAY CONTAIN SYNTHETIC MINERAL FIRRE WHICH MAY BE HARMEUL IF INHALED OR IF IT COMES IN CONTACT WITH THE SKIN, EYES OR OTHER SENSITIVE PARTS OF THE BODY, PERSONAL PROTECTIVE EQUIPMENT INCLUDING PROTECTION AGAINST INHALATION OF HARMFUL MATERIAL SHOULD BE USED WHEN INSTALLING, REMOVING OR WORKING NEAR BULK INSULATION MATERIAL.

# TIMBER FLOORS

THIS BUILDING MAY CONTAIN TIMBER FLOORS WHICH HAVE AN APPLIED FINISH. AREAS WHERE FINISHES ARE APPLIED SHOULD BE KEPT WELL VENTILATED DURING SANDING & APPLICATION & FOR A PERIOD AFTER INSTALLATION, PROTECTIVE EQUIPMENT MAY ALSO BE REQUIRED. THE MANUFACTURER'S RECOMMENDATIONS FOR USE MUST BE CAREFULLY CONSIDERED AT ALL

THROUGHOUT THE CONSTRUCTION PERIOD STORAGE & USE OF HAZARDOUS MATERIALS FOR THE ASSOCIATED BUILD IS TO BE THE RESPONSIBILITY OF THE PRINCIPAL CONTRACTOR.

# PUBLIC ACCESS

PUBLIC ACCESS TO CONSTRUCTION & DEMOLITION SITES & TO AREAS UNDER MAINTENANCE CAUSES RISK TO WORKERS & PUBLIC, WARNING SIGNS & SECURE BARRIERS TO UNAUTHORISED ACCESS SHOULD BE PROVIDED. WHERE ELECTRICAL INSTALLATIONS, EXCAVATIONS, PAINT OR LOOSE MATERIALS ARE PRESENT THEY SHOULD BE SECURED WHEN NOT FULLY SUPERVISED.

ACCESS TO EXISTING AMENITIES ARE TO BE RESTRICTED TO CLIENT'S PERSONNEL & VISITING CLIENTELE ONLY IT IS THE RESPONSIBILITY OF THE PRINCIPAL CONTRACTOR TO PROVIDE & MAINTAIN AMENITIES & FACILITIES AS REQUIRED. INCLUDING STORAGE FIST AID RESTROOMS MEAL AREAS & DRINKING WATER

# MOVEMENT OF PEOPLE & MATERIALS

THROUGHOUT CONSTRUCTION & THE LIFECYCLE OF THE RUILDING SAFE ACCESS & FERESS, INCLUDING FOR THOSE WITH A DISABILITY IS TO BE MAINTAINED THROUGHOUT THE RUILDING & SITE. THE EXISTING FRONT ENTRANCE TO THE BUILDING IS DEEMED TO BE THE ACCESSIBLE ROUTE IN & OUT OF THE BUILDING, & AS SUCH SHOULD BE MAINTAINED CLEAR & FREE OF CONSTRUCTION MATERIALS DURING THE CONSTRUCTION PHASE.

TRAFFIC MANAGEMENT DURING THE CONSTRUCTION & LIFECYCLE OF THE BUILDING IS TO BE THE RESPONSIBILITY OF THE CLIENT.

EXCLUSION ZONES ARE TO BE SET IN PLACE BY ESSENTIAL ENERGY DURING CONSTRUCTION, & AS SUCH MOVEMENT WITHIN THESE AREAS ARE TO BE PROHIBITED EXCEPT BY WRITTEN PERMISSION OF THE CLIENT

SITE SECURITY DURING CONSTRUCTION IS TO BE SHARED BY THE PRINCIPAL CONTRACTOR & CLIENT, SECURITY FENCING SHALL BE PROVIDED AROUND THE PERIMETER OF THE CONSTRUCTION SITE & ANY ADDITIONAL PRECAUTIONARY MEASURES TAKEN, AS MAY BE NECESSARY TO PREVENT UNAUTHORISED ENTRY TO THE SITE AT ALL TIMES DURING THE CONSTRUCTION PERIOD.

# OTHER HIGH RISK ACTIVITY

ALL ELECTRICAL WORK SHOULD BE CARRIED OUT IN ACCORDANCE WITH CODE OF PRACTICE: MANAGING ELECTRICAL RISKS AT THE WORKPLACE, AS/NZ 3012 & ALL LICENSING REQUIREMENTS.

ALL WORK USING PLANT SHOULD BE CARRIED OUT IN ACCORDANCE WITH CODE OF PRACTICE: MANAGING RISKS OF PLANT AT THE WORKPLACE, ALL WORK SHOULD BE CARRIED OUT IN ACCORDANCE WITH CODE OF PRACTICE: MANAGING NOISE & PREVENTING HEARING LOSS AT WORK, DUE TO THE HISTORY OF SERIOUS INCIDENTS IT IS RECOMMENDED THAT PARTICULAR CARE BE EXERCISED WHEN UNDERTAKING WORK INVOLVING STEEL CONSTRUCTION & CONCRETE PLACEMENT, ALL THE ABOVE APPLIES

THESE NOTES DO NOT REPRESENT A COMPREHENSIVE STATEMENT OF THE LAW AS IT APPLIES TO PARTICULAR PROBLEMS OR TO INDIVIDUALS OR AS A SUBSTITUTE FOR LEGAL ADVICE, YOU SHOULD SEEK INDEPENDENT LEGAL ADVICE IF YOU NEED ASSISTANCE ON THE APPLICATION OF THE LAW TO YOUR SITUATION. INFORMATION ON THE LATEST LAWS CAN BE CHECKED BY VISITING THE NSW LEGISLATION WEBSITE ISSUED FOR APPROVAL (WWW.LEGISLATION.NSW.GOV.AU).



# CONTACT DETAILS

Gabrielle Hackett M. 8437 762 740

E. gabrielle@onpointbuildingdesign.com.au A. 17 Church Street, Mudgee NSW 2850

THIS DEAWING IS AND ALWAYS SHALL REMAIN THE ROPERTY OF ON POINT EUILDING DESIGN AND MUST NOT BE LENT, GIVEN, SOLD, REPRODUCED OR VARIED IN ANY WAX WITHOUT WAITEN CONSENT.

ALL DIMENSIONS ARE IN MILLIMOTE DO NOT SCALE
DIMENSIONS TO BE CHECKED ON SITE BEFORE
COMMENCEMENT OF WORK

Client

Project

MUDGEE

ARLAN FAHEY-LEIGH

PROPOSED EXTENSION AT 144 MORTIMER STREET

Drawing Title

SAFE DESIGN OF STRUCTURES NOTES

11/08/21 PRELIMINARY DRAWINGS

12/08/21 PRELIMINARY DRAWINGS 7/11/21 ISSUED FOR APPROVAL 11/01/22 ISSUED FOR APPROVA

**BUILDING DESIGNERS** ASSOCIATION OF AUSTRALIA

Job Number

1259 - A09

Sheet 09 of 09

D