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90<sub>500</sub>90<sub>1000</sub>250<sub>2</sub>90<sub>5</sub>10<sub>1</sub>

1910

4090

4570

4090

5870

10260

3500

4180

4180

1460

GARAGE

LIVING

151.48

39.69

SIDE PATIO PATIO

20.88 7.23


TOTAL

219.28 sq.m.

(23.60 sq.)

1550 90 19140

1410

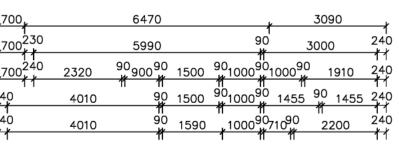

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NOTES — STAIR TREADS TO COMPLY WITH BCA 3.9.1

SMOKE ALARM

⊗

EXHAUST FAN

ALL EXTERNAL LIGHT FITTINGS ARE TO BE SHIELDED.
I.E. DOES NOT PERMIT LIGHT TO SHINE ABOVE THE HORIZONTAL PLANE. \* NOTE: EXTERNAL LIGHTING

\* ALL DIMENSIONS ARE TO BE CONFIRMED BY THE BUILDER PRIOR TO CONSTRUCTION. DO NOT SCALE FROM DRAWNGS.
BUILDING SET OUT & SITE BOUNDARY DETAILS TO BE CONFIRMED BY A REGISTERED SURVEYOR.
ALL WORK TO BE CARRIED OUT TO RELEVANT STANDARDS AND BUILDING CODES.

PROPERTIES

SHEET: 1 / 8

21364 JOB No: DATE:

23.11.22

1:100 (A3) SCALE:

## **"BELLVUE 24"** MODIFIED

DRAWN:	DRAWING:
WP	FLOOR PLAN - DWELLING A
	LOT 91 DUNNACHIE ST, MUDGEE (NO.
ISSUE:	MAAS GROUP PROPERTIES

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EXHAUST SYSTEMS INSTALLED (INCLUDING TASTIC & LIGHT VENT COMBO) TO HAVE MINIMUM FLOW RATE IN ACCORDANCE WITH PART 3.8.7 NCC 2019

1510

1510

240


EXHAUST SYSTEMS (INCLUDING TASTIC & LIGHT VENT COMBO) TO DISCHARGE TO OUTSIDE AIR OR VENTILATED ROOF SPACE AS PER PART 3.8.7 NCC 2019.
METHOD CHOSEN IS TO MATCH COMPLIANCE WITH THE RELEVANT BASIX CERTIFICATE. ጵ

PLIABLE BUILDING MEMBRANE INSTALLED IN EXTERNAL WALLS TO BE A VAPOR PERMEABLE TYPE, COMPLY WITH AS/NZS 4200.1 AND BE INSTALLED AS PER AS4200.2


EXTERNAL DOORS AND OPENABLE WINDOWS IN CONDITIONED SPACES TO BE SEALED TO RESTRICT AIR INFILTRATION AS PER PART 3.12.3 NCC 2019





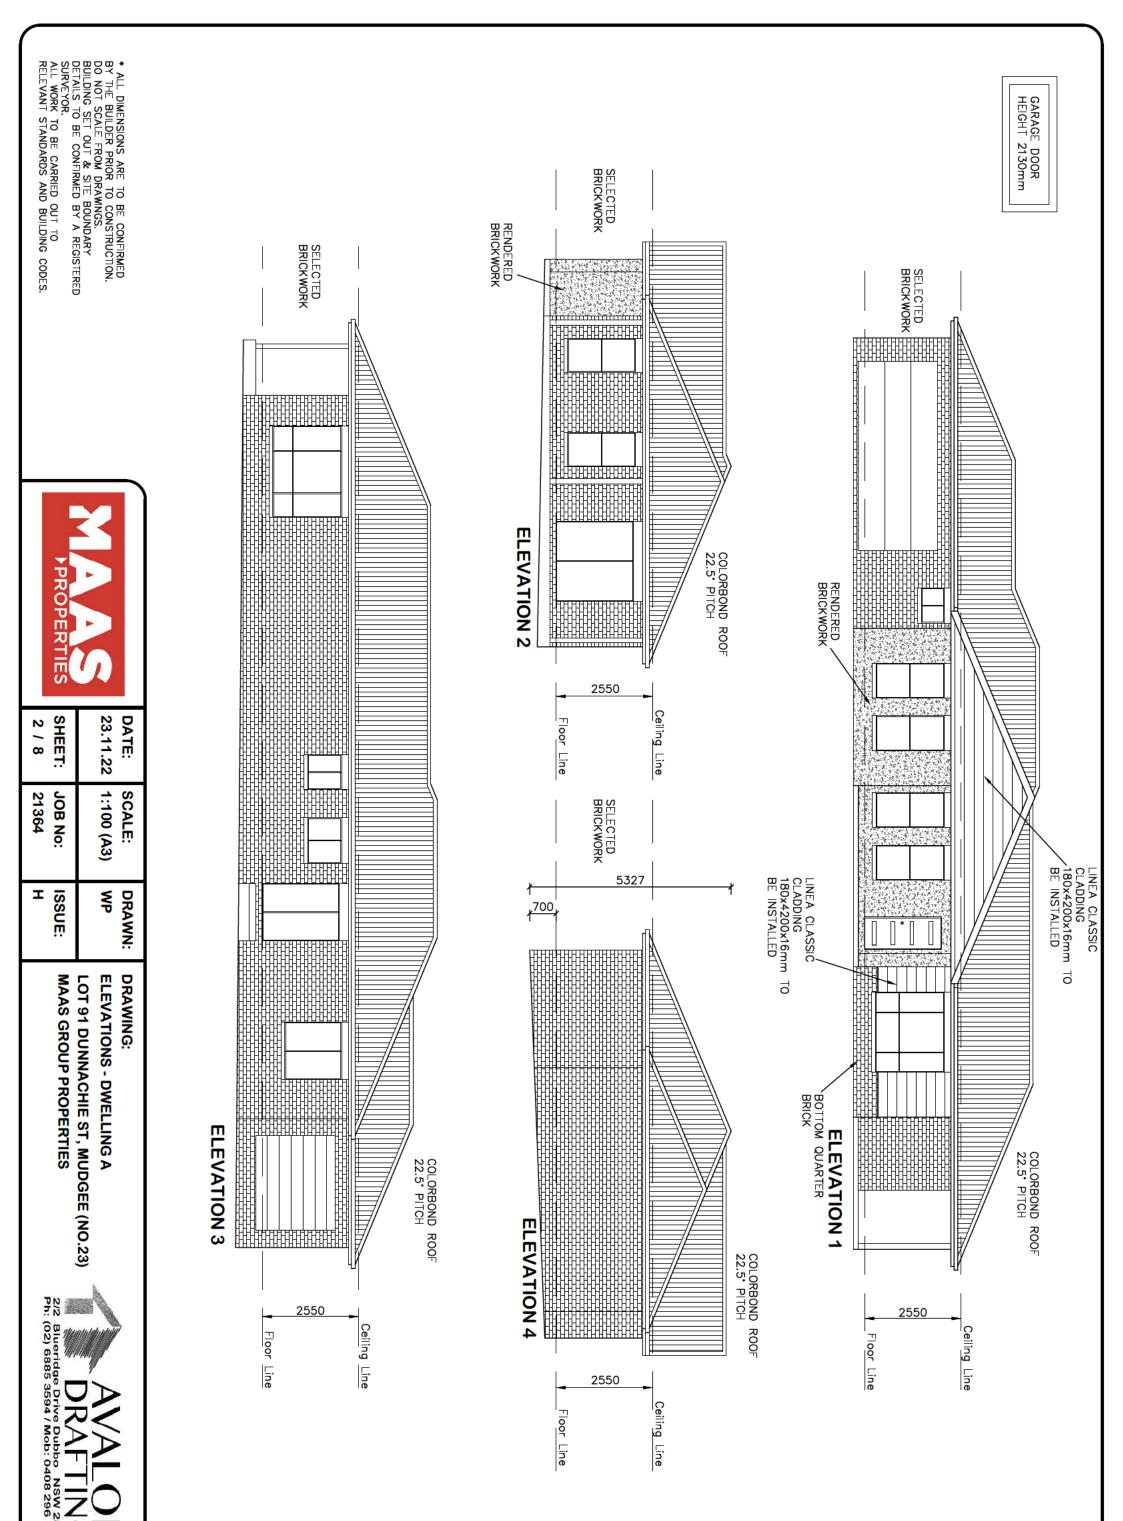




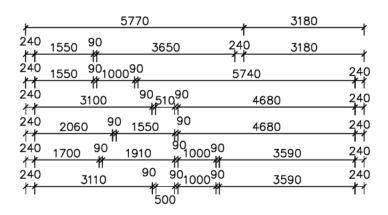

LIVING 131.68
GARAGE 25.42
PATIO 2.99
REAR PATIO 9.76

TOTAL 169.85 sq.m.
(18.28 sq.)

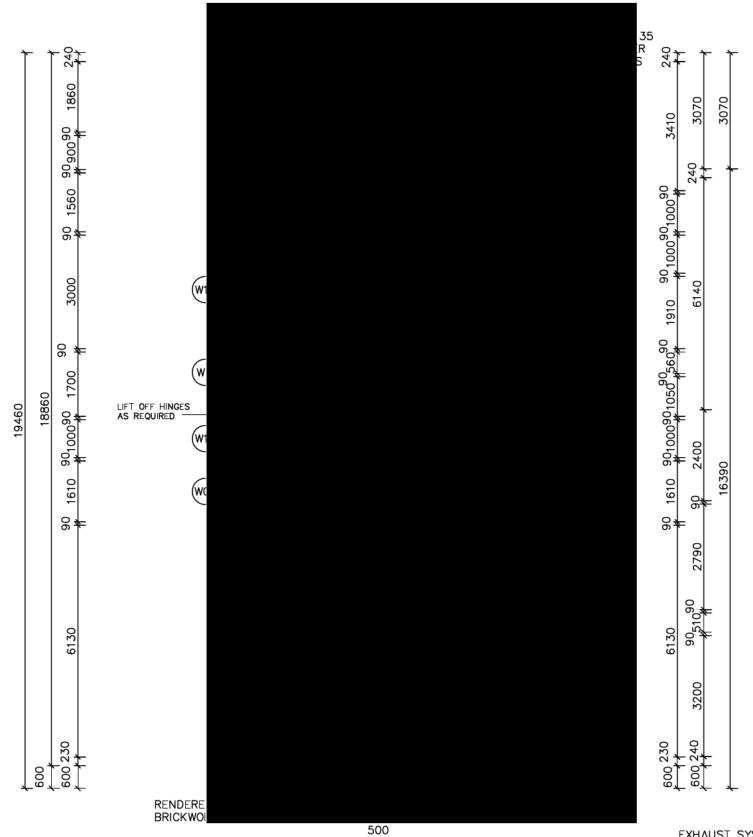

NOTES - STAIR TREADS TO COMPLY WITH BCA 3.9.1

●SA SMOKE ALARM

EXHAUST FAN

\* NOTE: EXTERNAL LIGHTING

ALL EXTERNAL LIGHT FITTINGS ARE TO BE SHIELDED.
I.E. DOES NOT PERMIT LIGHT TO SHINE ABOVE THE HORIZONTAL PLANE.

\* ALL DIMENSIONS ARE TO BE CONFIRMED BY THE BUILDER PRIOR TO CONSTRUCTION. DO NOT SCALE FROM DRAWINGS. BUILDING SET OUT & SITE BOUNDARY DETAILS TO BE CONFIRMED BY A REGISTERED SURVEYOR.
ALL WORK TO BE CARRIED OUT TO RELEVANT STANDARDS AND BUILDING CODES.

## "ELIZABETH SG"

EXHAUST SYSTEMS INSTALLED (INCLUDING TASTIC & LIGHT VENT COMBO) TO HAVE MINIMUM FLOW RATE IN ACCORDANCE WITH PART 3.8.7 NCC 2019

EXHAUST SYSTEMS (INCLUDING TASTIC & LIGHT VENT COMBO) TO DISCHARGE TO OUTSIDE AIR OR VENTILATED ROOF SPACE AS PER PART 3.8.7 NCC 2019. METHOD CHOSEN IS TO MATCH COMPLIANCE WITH THE RELEVANT BASIX CERTIFICATE.

PLIABLE BUILDING MEMBRANE INSTALLED IN EXTFRNAL WALLS TO BF A VAPOR PERMEABLE TYPE, COMPLY WITH AS/NZS 4200.1 AND BE INSTALLED AS PER AS4200.2

EXTERNAL DOORS AND OPENABLE WINDOWS IN CONDITIONED SPACES TO BE SEALED TO RESTRICT AIR INFILTRATION AS PER PART 3.12.3 NCC 2019



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SHEET:	JOB No:	ISSUE:

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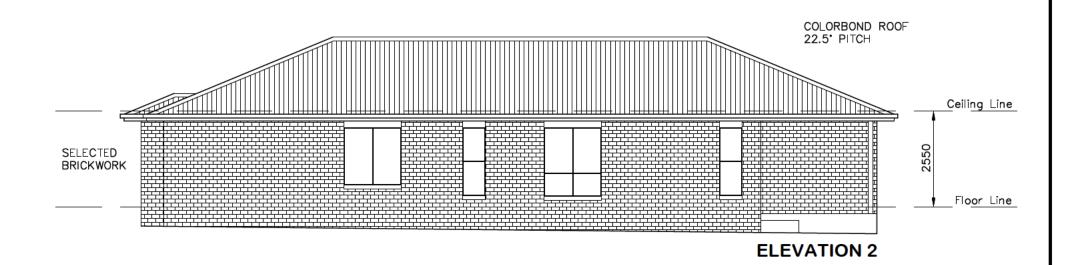
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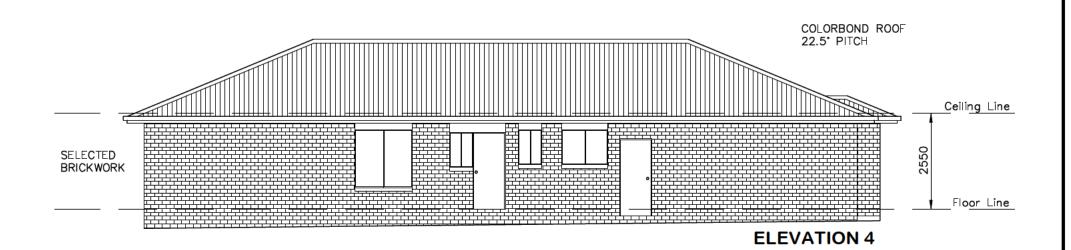
DRAWING: FLOOR PLAN - DWELLING B LOT 91 DUNNACHIE ST, MUDGEE (NO.23) MAAS GROUP PROPERTIES











\* ALL DIMENSIONS ARE TO BE CONFIRMED BY THE BUILDER PRIOR TO CONSTRUCTION. DO NOT SCALE FROM DRAWINGS. BUILDING SET OUT & SITE BOUNDARY DETAILS TO BE CONFIRMED BY A REGISTERED SURVEYOR. ALL WORK TO BE CARRIED OUT TO RELEVANT STANDARDS AND BUILDING CODES.

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	SCALE: 1:100 (A3)	DRAWN: WP
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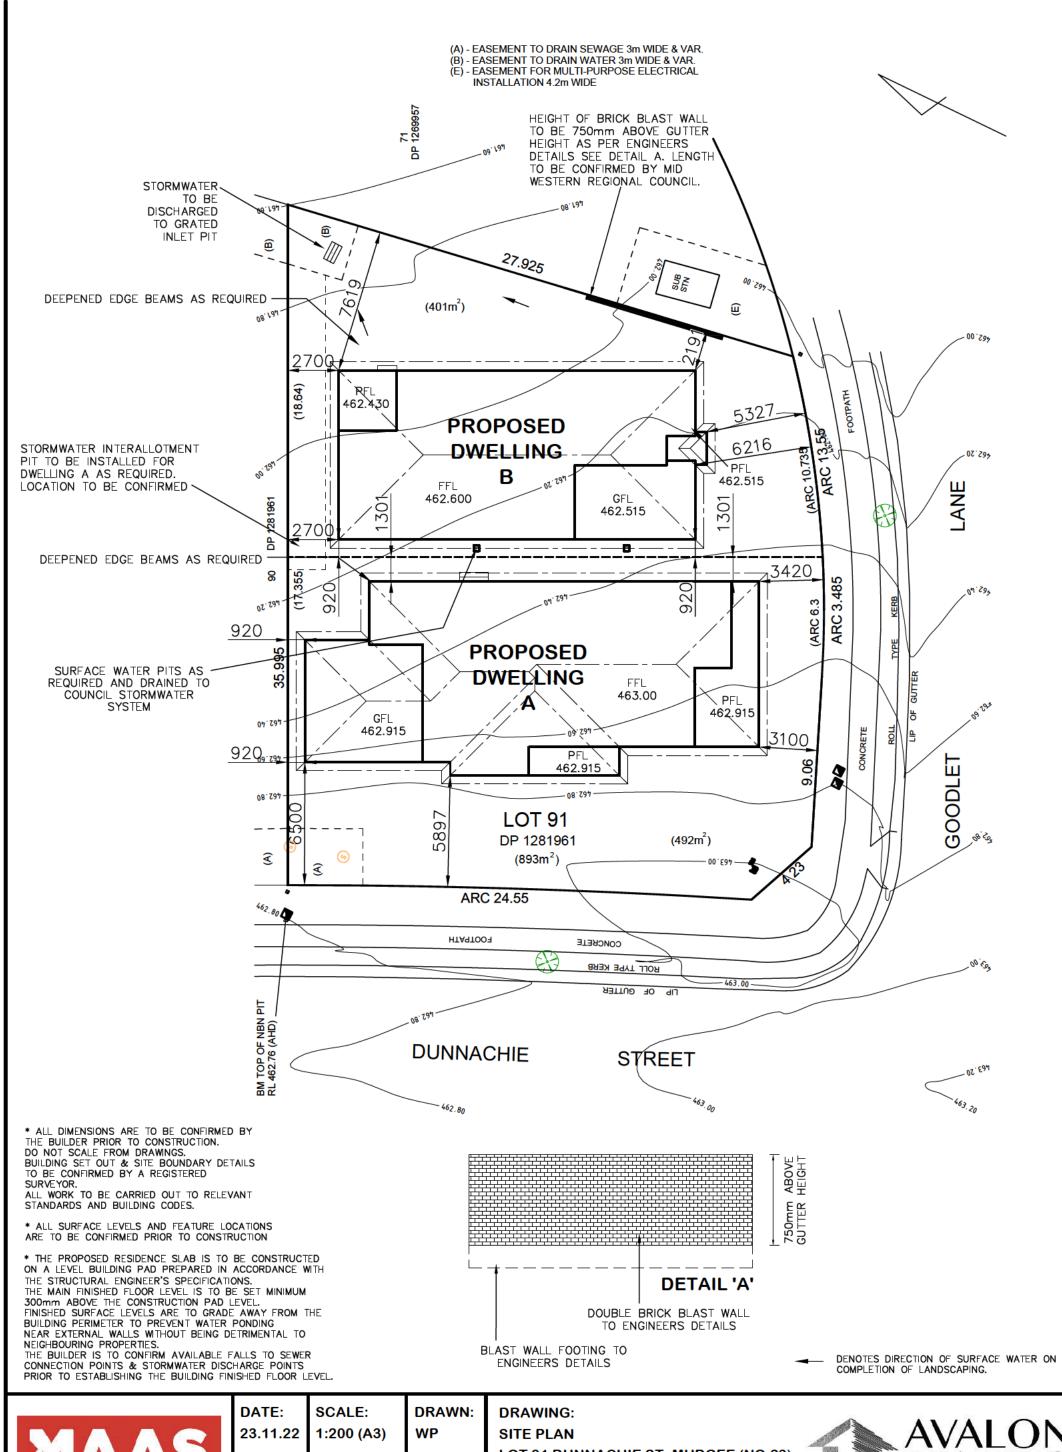
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**DRAWING: ELEVATIONS - DWELLING B LOT 91 DUNNACHIE ST, MUDGEE (NO.23) MAAS GROUP PROPERTIES** 








DATE: SCALE: DRAWN: 23.11.22 1:200 (A3) WP

SHEET: JOB No: ISSUE: 5 / 8 21364 H

SITE PLAN LOT 91 DUNNACHIE ST, MUDGEE (NO.23) MAAS GROUP PROPERTIES



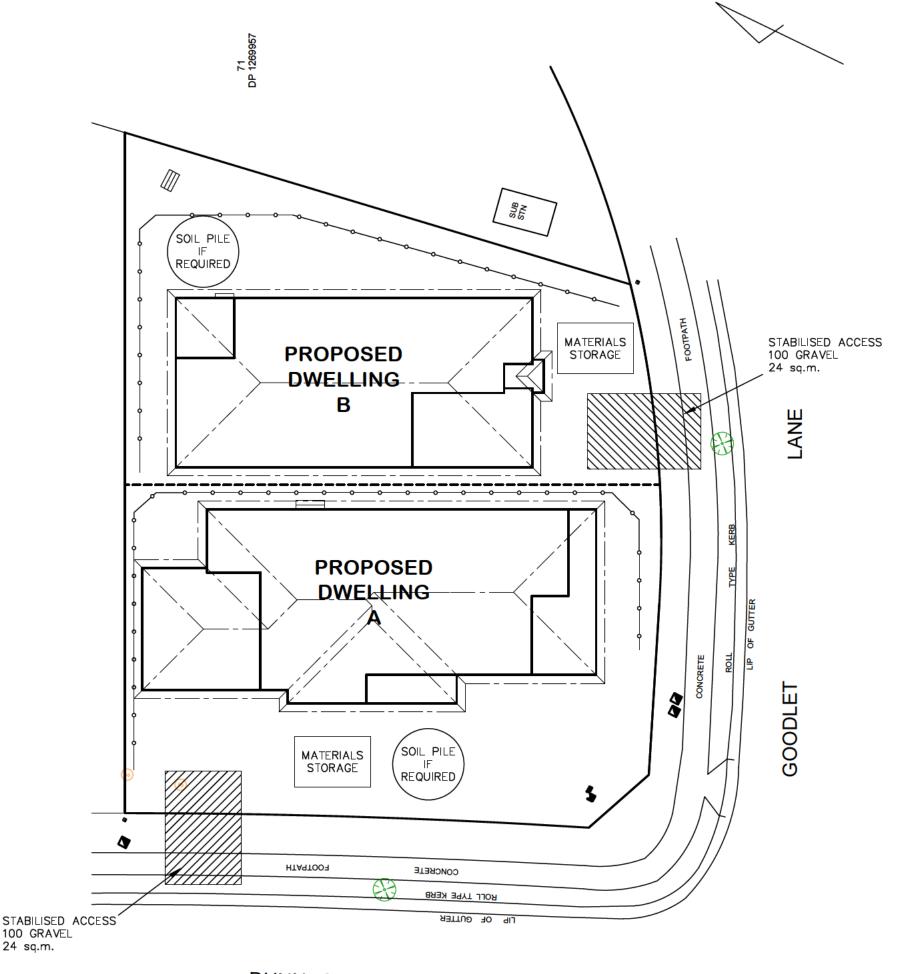

**DUNNACHIE** 

STREET

\* ALL DIMENSIONS ARE TO BE CONFIRMED BY THE BUILDER PRIOR TO CONSTRUCTION. DO NOT SCALE FROM DRAWINGS.
BUILDING SET OUT & SITE BOUNDARY DETAILS TO BE CONFIRMED BY A REGISTERED SURVEYOR.
ALL WORK TO BE CARRIED OUT TO RELEVANT STANDARDS AND BUILDING CODES.

\* ALL SURFACE LEVELS AND FEATURE LOCATIONS ARE TO BE CONFIRMED PRIOR TO CONSTRUCTION

\* THE PROPOSED RESIDENCE SLAB IS TO BE CONSTRUCTED ON A LEVEL BUILDING PAD PREPARED IN ACCORDANCE WITH THE STRUCTURAL ENGINEER'S SPECIFICATIONS.
THE MAIN FINISHED FLOOR LEVEL IS TO BE SET MINIMUM
300mm ABOVE THE CONSTRUCTION PAD LEVEL.
FINISHED SURFACE LEVELS ARE TO GRADE AWAY FROM THE
BUILDING PERIMETER TO PREVENT WATER PONDING
NEAR EXTERNAL WALLS WITHOUT BEING DETRIMENTAL TO NEIGHBOURING PROPERTIES.
THE BUILDER IS TO CONFIRM AVAILABLE FALLS TO SEWER
CONNECTION POINTS & STORMWATER DISCHARGE POINTS

PRIOR TO ESTABLISHING THE BUILDING FINISHED FLOOR LEVEL.

100 GRAVEL 24 sq.m.

NOTES:

- 1. ALL RUNOFF & SEDIMENT CONTROL STRUCTURES TO BE MAINTAINED IN A FUNCTIONAL CONDITION.
- 2. ALL VEGETATION OUTSIDE THE DWELLING SITE WILL BE RETAINED.

→ SEDIMENT FENCE



DATE:	SCALE:	DRAWN:
23.11.22	1:200 (A3)	WP
SHEET:	JOB No:	ISSUE:


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**DRAWING: EROSION & SEDIMENT CONTROL PLAN LOT 91 DUNNACHIE ST, MUDGEE (NO.23) MAAS GROUP PROPERTIES** 





DUNNACHIE

**STREET** 

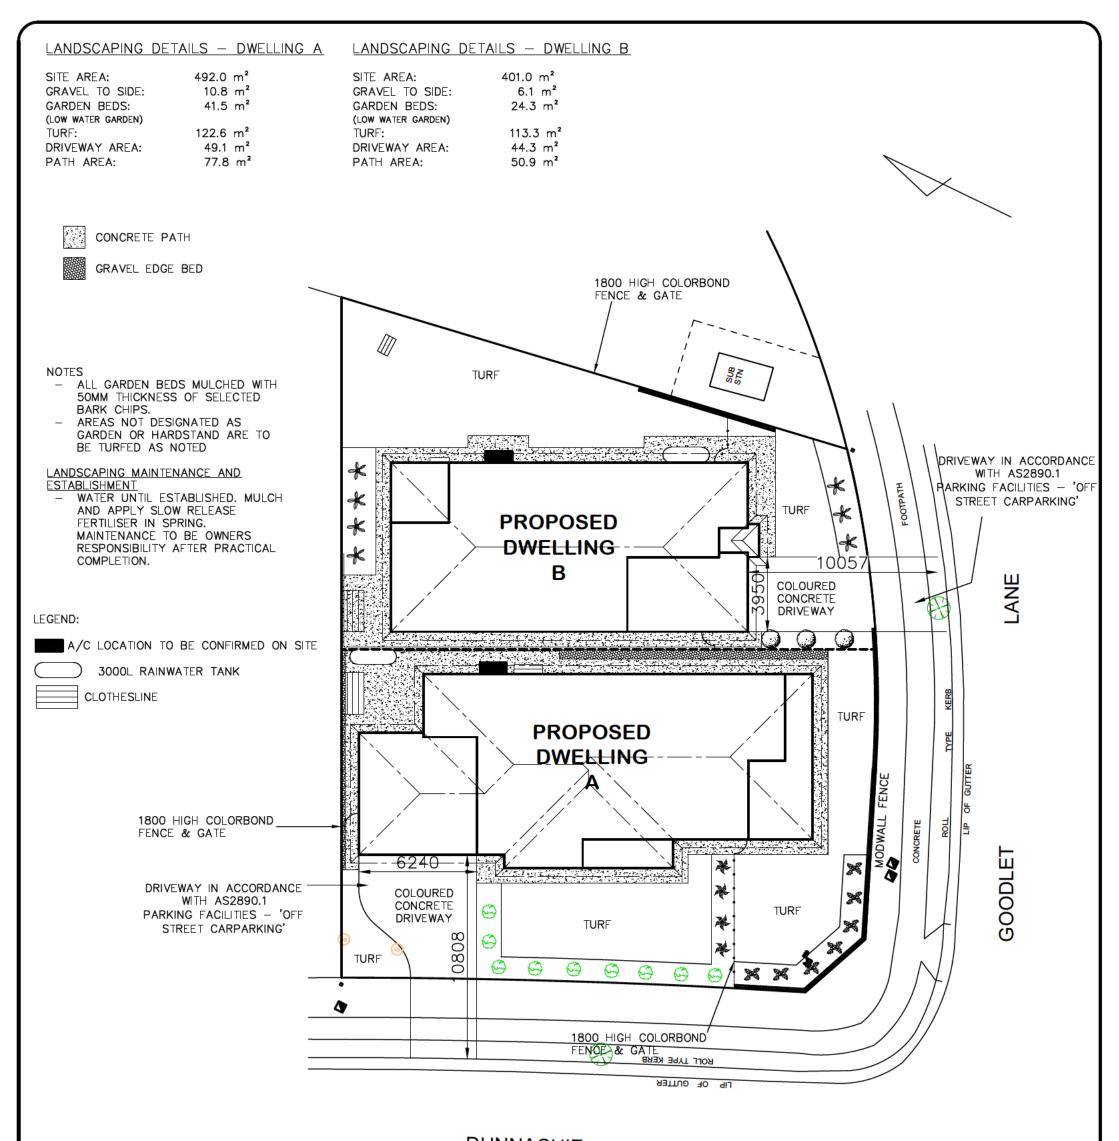\* ALL DIMENSIONS ARE TO BE CONFIRMED BY THE BUILDER PRIOR TO CONSTRUCTION.
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THE MAIN FINISHED FLOOR LEVEL IS TO BE SET MINIMUM 300mm ABOVE THE CONSTRUCTION PAD LEVEL.
FINISHED SURFACE LEVELS ARE TO GRADE AWAY FROM THE BUILDING PERIMETER TO PREVENT WATER PONDING NEAR EXTERNAL WALLS WITHOUT BEING DETRIMENTAL TO NEIGHBOURING PROPERTIES.

THE BUILDER IS TO CONFIRM AVAILABLE FALLS TO SEWER CONNECTION POINTS & STORMWATER DISCHARGE POINTS PRIOR TO ESTABLISHING THE BUILDING FINISHED FLOOR LEVEL.

7 / 8

	Plant Schedule table	ht	spread
	Westringia zena	2m	2m
	Oriental pearl	<b>1</b> m	0.4m
	Photinia robusta	3m	2m
*	Nandina obsession	0.6m	0.6m
×	Lomandra tanika	0.6m	0.6m
K	Viburnum tinus	1.5m	1m
0~			



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DRAWING:
BASIX COMMITMENTS PLAN
LOT 91 DUNNACHIE ST, MUDGEE (NO.23)
MAAS GROUP PROPERTIES



BASIX COMMITMENTS - DWELLING A WATER COMMITMENTS <u>landscape</u> Area low water use species of vegetation 41.5 SQ.M. EIXTURES SHOWER HEAD RATING TOILET FLUSHING SYSTEM RATING MIN RATING 4 STAR 4 STAR 5 STAR 5 STAR KITCHEN TAPS BASIN TAPS ALTERNATIVE WATER RAINWATER TANK RAINWATER TANK CAPACITY 3000 LITRE ROOF COLLECTION AREA FOR R/W R/W TANK CONNECTED TO MIN 1 No. OUTDOOR TAP ALL TOILETS IN DWELLING
THE COLD WATER TAP THAT SUPPLIES THE CLOTHES WASHER THERMAL COMFORT COMMITMENTS CIASS 1 DWELLING WITH NOT MORE THAN 2 STOREYS
CONDITIONED FLOOR AREA NOT EXCEEDING 300 SQUARE METRES
MUST NOT HAVE OPEN MEZZANINE OF MORE THAN 25 SQUARE METRES
NOT CONTAIN THIRD LEVEL HABITABLE ATTIC ROOM CONCRETE SLAB ON GROUND BRICK VENEER - R2.60 INC CONSTRUCTION GROUND FLOOR CONSTRUCTION external wall INTERNAL WALL SHARED WITH GARAGE FLAT CEILING/PITCHED ROOF — CEILING R4, ROOF — SARKING — UNVENTILATED — DARK (SOLAR ABSORPTANCE > 0.7) THERMAL COMFORT COMMITMENTS - WINDOWS & GLAZED DOORS WINDOW ORIENTATION MAXIMUM MAXIMUM SHADING OVERSHADOWING HEIGHT (mm) WIDTH (mm) W01 ALUMINIUM, SINGLE, CLEAR EAVE 600mm, 180mm ABOVE HEAD OF WINDOW OR GLAZED DOOR NOT Overshadowed W02 ALUMINIUM, SINGLE, CLEAR EAVE 600mm, 240mm ABOVE HEAD OF WINDOW OR GLAZED DOOR Ε 2100 1500 NOT Overshadowed EAVE 600mm, 180mm ABOVE HEAD OF WINDOW OR GLAZED DOOR ALUMINIUM, SINGLE, CLEAR W03 Ε 900 1200 not Overshadowed EAVE 600mm, 180mm ABOVE HEAD OF WINDOW OR GLAZED DOOR ALUMINIUM, SINGLE, CLEAR W04 Ε 900 900 NOT Overshadowed EAVE 600mm, 180mm ABOVE HEAD **W**05 1800 ALUMINIUM, SINGLE, CLEAR Ε 2400 NOT Overshadowed OF WINDOW OR GLAZED DOOR EAVE 2060mm, 240mm ABOVE HEAD OF WINDOW OR GLAZED DOOR W06 S 2100 2100 ALUMINIUM, SINGLE, CLEAR OVERSHADOWED W07 S 1800 900 ALUMINIUM, SINGLE, CLEAR NOT Overshadowed EAVE 4000mm, 180mm ABOVE HEAD OF WINDOW OR GLAZED DOOR **W08** S 1800 900 ALUMINIUM, SINGLE, CLEAR NOT OVERSHADOWED EAVE 600mm, 180mm ABOVE HEAD OF WINDOW OR GLAZED DOOR W09 w 1800 2100 ALUMINIUM, SINGLE, CLEAR not Overshadowed ALUMINIUM, SINGLE, CLEAR EAVE 2110mm, 180mm ABOVE HEAD OF WINDOW OR GLAZED DOOR 1800 900 W10 not Overshadowed ALUMINIUM, SINGLE, CLEAR EAVE 2110mm, 180mm ABOVE HEAD NOT W11 1800 900

		. "	1000	300	neominion, shore, servi	OF WINDOW OR GLAZED DOOR	OVERSHADOWED
	W12	w	1800	900	ALUMINIUM, SINGLE, CLEAR	EAVE 600mm, 1500mm ABOVE HEAD OF WINDOW OR GLAZED DOOR	NOT OVERSHADOWED
	W13	w	1800	900	ALUMINIUM, SINGLE, CLEAR	EAVE 600mm, 920mm ABOVE HEAD OF WINDOW OR GLAZED DOOR	NOT OVERSHADOWED
	W14	w	600	900	ALUMINIUM, SINGLE, CLEAR	EAVE 600mm, 180mm ABOVE HEAD OF WINDOW OR GLAZED DOOR	NOT OVERSHADOWED
ENERGY COMMITMENTS HOT WATER SYSTEM COOLING SYSTEM HEATING SYSTEM VENTILATION BATHROOM EXTRACT FAN DUCTED TO ROOF OR FACADE — MANUAL ON/OFF ILJUNDRY  EXTRACT FAN DUCTED TO ROOF OR FACADE — MANUAL ON/OFF NATURAL VENTILATION ONLY							
B L H	ITCHEN		PRIMARY TY PRIMARY TY PRIMARY TY PRIMARY TY	pe of artificia Pe of artificia Pe of artificia Pe of artificia	L LIGHTING IS FLUORESCENT OR LIGHT L LIGHTING IS FLUORESCENT OR LIGHT	EMITTING DIODE (LED) (DEDICATED) EMITTING DIODE (LED) (DEDICATED) EMITTING DIODE (LED) (DEDICATED) EMITTING DIODE (LED) X 2 (DEDICATED)	
K	atural L Itchen Athroom	<u>ighting</u> S/toilets	WINDOW x 3	3			
	PPLIANCE ITCHEN	S					

These are the specifications upon which the Basix assessment is based. These specifications take precedence over the drawings or other specifications.

WELL VENTILATED AS BASIX DEFINITION OUTDOOR CLOTHES DRYING LINE

<u>landscape</u> Area low water use species of vegetation 24.3 SQ.M. FIXTURES MIN RATING SHOWER HEAD RATING TOILET FLUSHING SYSTEM RATING 4 STAR 4 STAR 5 STAR KITCHEN TAPS BASIN TAPS ALTERNATIVE WATER RAINWATER TANK RAINWATER TANK CAPACITY 3000 LITRE ROOF COLLECTION AREA FOR R/W 100 SQ.M. R/W TANK CONNECTED TO MIN 1 No. OUTDOOR TAP ALL TOILETS IN DWELLING
THE COLD WATER TAP THAT SUPPLIES THE CLOTHES WASHER THERMAL COMFORT COMMITMENTS CLASS 1 DWELLING WITH NOT MORE THAN 2 STOREYS CONDITIONED FLOOR AREA NOT EXCEEDING 300 SQUARE METRES MUST NOT HAVE OPEN MEZZANINE OF MORE THAN 25 SQUARE METRES NOT CONTAIN THIRD LEVEL HABITABLE ATTIC ROOM GROUND FLOOR CONSTRUCTION CONCRETE SLAB ON GROUND BRICK VENEER - R2.60 INC CONSTRUCTION EXTERNAL WALL INTERNAL WALL SHARED WITH GARAGE CEILING AND ROOF flat ceiling/pitched roof – ceiling r4, roof – sarking – unventilated – dark (solar absorptance > 0.7) THERMAL COMFORT COMMITMENTS — WINDOWS & GLAZED DOORS WINDOW ORIENTATION MAXIMUM MAXIMUM SHADING OVERSHADOWING HEIGHT (mm) WIDTH (mm) EAVE 600mm, 180mm ABOVE HEAD OF WINDOW OR GLAZED DOOR W01 ALUMINIUM, SINGLE, CLEAR NOT Overshadowed W02 ALUMINIUM, SINGLE, CLEAR EAVE 600mm, 180mm ABOVE HEAD OF WINDOW OR GLAZED DOOR N 1800 2400 NOT Overshadowed EAVE 3670mm, 240mm ABOVE HEAD OF WINDOW OR GLAZED DOOR ALUMINIUM, SINGLE, CLEAR ₩03 N 2100 2100 not Overshadowed EAVE 600mm, 180mm ABOVE HEAD OF WINDOW OR GLAZED DOOR NOT Overshadowed W04 ALUMINIUM, SINGLE, CLEAR Ε 1800 600 ₩05 Ε ALUMINIUM, SINGLE, CLEAR EAVE 600mm, 180mm ABOVE HEAD 1800 1500 not Overshadowed OF WINDOW OR GLAZED DOOR EAVE 600mm, 180mm ABOVE HEAD OF WINDOW OR GLAZED DOOR NOT Overshadowed ₩06 Ε 1800 600 ALUMINIUM, SINGLE, CLEAR W07 1500 1500 ALUMINIUM, SINGLE, CLEAR NOT Overshadowed Ε **W**08 S 1800 1500 ALUMINIUM, SINGLE, CLEAR EAVE 1050mm, 180mm ABOVE HEAD OF WINDOW OR GLAZED DOOR NOT Overshadowed EAVE 600mm, 180mm ABOVE HEAD OF WINDOW OR GLAZED DOOR W09 W 900 1200 ALUMINIUM, SINGLE, CLEAR not Overshadowed ALUMINIUM, SINGLE, CLEAR EAVE 600mm, 180mm ABOVE HEAD OF WINDOW OR GLAZED DOOR 900 600 W10 W not Overshadowed EAVE 600mm, 240mm ABOVE HEAD OF WINDOW OR GLAZED DOOR NOT Overshadowed W11 900 600 ALUMINIUM, SINGLE, CLEAR 1500 1500 ALUMINIUM, SINGLE, CLEAR EAVE 600mm, 180mm ABOVE HEAD W12 NOT Overshadowed OF WINDOW OR GLAZED DOOR ENERGY COMMITMENTS HOT WATER SYSTEM GAS INSTANTANEOUS - 5 STAR COOLING SYSTEM HEATING SYSTEM REVERSE CYCLE: EER 3.0-3.5 WITH DAY/NIGHT ZONING BETWEEN LIMING/BED AREAS REVERSE CYCLE: EER 3.0-3.5 WITH DAY/NIGHT ZONING BETWEEN LIMING/BED AREAS VENTILATION Extract fan ducted to roof or facade — Manual on/off extract fan ducted to roof or facade — Manual on/off natural ventilation only BATHROOM KITCHEN ARTIFICIAL LIGHTING KITCHEN BATHROOMS/TOILETS

BASIX COMMITMENTS - DWELLING B

WATER COMMITMENTS

LAUNDRY
HALLWAYS
LIVING AREAS
BEDROOMS
NATURAL LIGHTING


BATHROOMS/TOILETS

APPLIANCES
KITCHEN
REFRIGERATOR SPACE

CLOTHES DRYING

These are the specifications upon which the Basix assessment is based. These specifications take precedence over the drawings or other specifications.

PRIMARY TYPE OF ARTIFICIAL LIGHTING IS FLUORESCENT OR LIGHT EMITTING DIODE (LED)
PRIMARY TYPE OF ARTIFICIAL LIGHTING IS FLUORESCENT OR LIGHT EMITTING DIODE (LED)
PRIMARY TYPE OF ARTIFICIAL LIGHTING IS FLUORESCENT OR LIGHT EMITTING DIODE (LED)
PRIMARY TYPE OF ARTIFICIAL LIGHTING IS FLUORESCENT OR LIGHT EMITTING DIODE (LED)
PRIMARY TYPE OF ARTIFICIAL LIGHTING IS FLUORESCENT OR LIGHT EMITTING DIODE (LED) X 2
PRIMARY TYPE OF ARTIFICIAL LIGHTING IS FLUORESCENT OR LIGHT EMITTING DIODE (LED) X 2

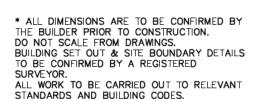


REFRIGERATOR SPACE

CLOTHES DRYING

- \* ALL SURFACE LEVELS AND FEATURE LOCATIONS ARE TO BE CONFIRMED PRIOR TO CONSTRUCTION
- \* THE PROPOSED RESIDENCE SLAB IS TO BE CONSTRUCTED ON A LEVEL BUILDING PAD PREPARED IN ACCORDANCE WITH THE STRUCTURAL ENGINEER'S SPECIFICATIONS.
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  THE BUILDER IS TO CONFIRM AVAILABLE FALLS TO SEWER

CONNECTION POINTS & STORMWATER DISCHARGE POINTS PRIOR TO ESTABLISHING THE BUILDING FINISHED FLOOR LEVEL.

8 / 8

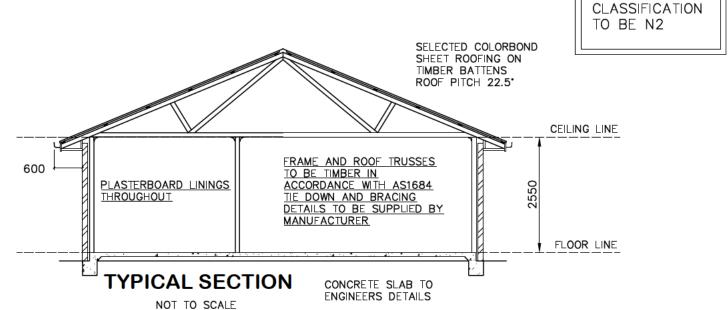

WINDOW x 3

WELL VENTILATED AS BASIX DEFINITION

OUTDOOR CLOTHES DRYING LINE

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	PROPERTIE	S

DATE:	SCALE:	DRAWN:
23.11.22	N / A	WP
SHEET:	JOB No:	ISSUE:

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DRAWING: BASIX COMMITMENTS & TYP SECTION LOT 91 DUNNACHIE ST, MUDGEE (NO.23) MAAS GROUP PROPERTIES



\* NOTE - WIND