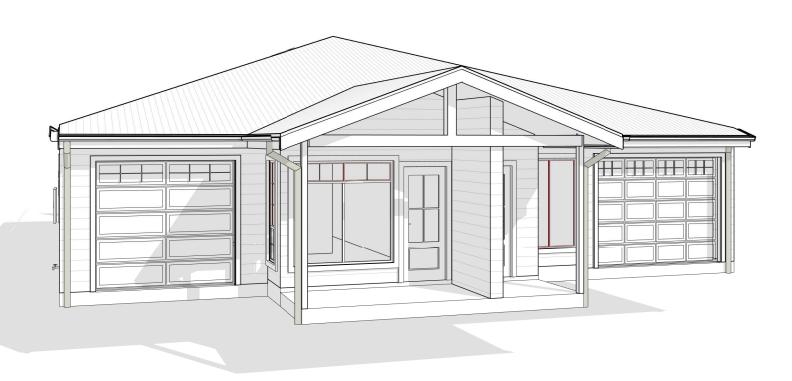


SHEET	DESCRIPTION
A001	COVER SHEET
A002	SITE PLAN
A003	SUB-DIVISION PLAN
A004	DRIVEWAY DETAILS - UNIT A
A005	DRIVEWAY DETAILS - UNIT B
A006	CONCEPT STORMWATER PLAN
A007	SITE MANAGEMENT PLAN
A008	GROUND FLOOR PLAN
A009	ELEVATIONS
A010	ELEVATIONS
A011	SECTION WINDOW & DOOR SCHEDULES
A012	FLOOR COVERING PLAN
A013	ROOF PLAN
A014	SITE ANALYSIS
A015	NOTIFICATION PLAN
A016	LANDSCAPE PLAN
A017	GROSS FLOOR AREA PLAN
A018	PARTY WALL DETAILS
A019	BASIX NOTES
A020	BASIX NOTES
A021	NATHERS NOTES - DWELLING A
A022	NATHERS NOTES - DWELLING B



AMENDED PLANS AS PER COUNCIL'S EDD LETTER 11 BASIX AND NATHERS NOTES ADDED EDD 20.06.22 SKYLIGHTS RELOCATED, GARAGE 27.05.22 EDD AWNING AND ROUND WINDOW AMENDED 26.05.22 PORCH WINDOW, WALL & FEATURE EDD ROOF PITCH, FFL & PORCH BATTEN AMENDED EDD 25.05.22 7 AMENDED PLANS EDD 23.04.22 6 IMPORT FILL EDD 31.03.22 5 AMENDED FACADE EDD 4 PRELIMINARY FACADE / ELEVATIONS EDD 29.03.22 25.03.22 MOVED KITCHEN TO REAR OF THE EDD DWELLING AMENDED TO DOUBLE GARAGE ILO SINGLE GARAGE EDD 25.03.22 ME DA PLAN DATE REV DESCRIPTION BY

ARTISTIC IMPRESSION IS FOR ILLUSTRATION PURPOSES ONLY. COLOURS AND MATERIAL FINISHES WILL BE SUBJECT TO FINAL SELECTIONS.

CLIENT'S NAME: TORI PETER GROUP

SITE ADDRESS:

LOT 8, DP:1267151 (No.51) SALEYARDS LANE MUDGEE, NSW 2850 PROPOSED TORRENS TITLE
SUBDIVISION & DUAL OCCUPANCY
SHEET NAME:
COVER SHEET

toripete

P.O.Box 3421 Bangor, NSW 2234 35A/61-65 GLENCOE STREET SUTHERLAND, NSW 2232 Tori Peter Group P/L ABN 37 156 178 979

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SCRAPE SITE TORL 449.440

LANE

SALEYARDS

(A) - EASEMENT TO DRAIN SEWAGE 3 WIDE (DP 1267151)

(B) - EASEMENT TO DRAIN SEWAGE 3 WIDE & VARIABLE (DP 1267151)

(D) - EASEMENT TO DRAIN WATER 3 WIDE (DP 1267151)

(Z) - EASEMENT TO DRAIN SEWAGE 3 WIDE (DP 1233109)

NOTE: PROVIDE INDOOR AND OUTDOOR CLOTHESLINE TO COMPLY WITH BASIX 5500 CERTIFICATE. 3 GARAGE SETBACK DP 1099282 PROPOSED CONCRETE DRIVEWAY BM: D. H. & WING LOCATION OF METER 3012 LOCATION OF HWS-PROPOSED -CONCRETE CROSSOVER NGL 449.36 FILL -80 FGL 449.440 WALL HUNG 3000 CROSSOVER CLOTHESLINE FFL 449.675 PROPOSED UNIT 2 > FFL 449.750 NGL 449.37 FILL -70 FGL 449.440 2000 LITRE SLIMLINE RAINWATER TANK 1600m(L) x 700m(W) x1860m(H) FGL 449.440 PROPOSED LINE OF SUB-DIVISION 3000 NGL 449.37 FILL -70 FGL 449.440 DP 1267151 PORCH SETBACK 2000 LITRE SLIMLINE RAINWATER TANK **PROPOSED** UNIT 1 1600m(L) x 700m(W) x1860m(H) FFL 449.750 LOCATION OF A/C_ UNIT 7 GARAGE FFL 449.675 WGL 449.38 FGL 449.440 WALL HUNG CLOTHESLINE LOCATION OF HWS-4500 226° 5370 LOCATION OF METER_ BOX FRONT SETBACK REAR SETBACK 5500 DP 1267151 GARAGE SETBACK

WIND CLASSIFICATION: SLAB CLASSIFICATION

TOTAL SITE AREA:

PROPERTY DESCRIPTION

LOT: D.P: 126715

L.G.A: **MID-WESTERN REGIONAL**

DA COUNCIL APPROVAL

COUNCIL DEVELOPMENT APPROVAL PROCESS REQUIRED. REFER TO COUNCIL REGULATIONS FOR FURTHER DETAILS.

	UNIT 1	UNIT 2			
SITE AREA:	329.57	331.53			
SITE COVERAGE AREA					
GROUND FLOOR AREA:	114.17	114.72			
GARAGE AREA:	27.32	23.38			
PROPOSED SITE COVERAGE:	42.93%	41.66%			
MAX SITE COVERAGE:	50%	50%			
LANDSCAPI	E				
TOTAL HARDSTAND AREA:	159.61	155.91			
DRIVEWAY AREA:	19.22	24.43			
LESS THAN 1m:	0.00	0.00			
PORCH/VERANDAH AREA:	2.42	2.42			
ALFRESCO AREA:	15.70	15.39			
REMAINING SOFT LANDSCAPE AREA:	150.74	151.19			
PROPOSED LANDSCAPE AREA:	45.74%	45.60%			
MIN. REQUIRED BY COUNCIL:	N/A	N / A			
PRIVATE OPEN SPACE					
PRINCIPLE PRIVATE OPEN SPACE:	80.00	80.00			
PRIVATE OPEN SPACE:	80.00	80.03			
MIN. ALLOWABLE BY COUNCIL:	80.00	80.00			
MIN. ALLOWABLE BY COUNCIL:	N / A	N / A			

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PRIVATE OPEN SPACE

PRINCIPAL PRIVATE OPEN SPACE



DRIVEWAY AREA				
DRIVEWAY A	19.22 m²			
DRIVEWAY B	24.43 m²			
Grand total	43 65 m ²			

CROSSOVER AREA				
	17.38 m²			
CROSSOVER B	17.30 m ²			
Grand total	34.68 m ²			

OLILITY O'TO MILE.	PROJECT NAME:	ESTATE:	REV. NO:	JOB NO:
	PROPOSED TORRENS TITLE		12	21001
SITE ADDRESS:	SUBDIVISION & DUAL OCCUPANCY	STAGE:	12	SHEET NO:
LOT 8, DP:1267151	SHEET NAME:	DA	DRAWN:	A002
(No.51) SALEYARDS LANE	SITE PLAN	SCALE @ A3:		DATE:
MUDGÉE, NSW 2850		1:200	EDD	04.09.22



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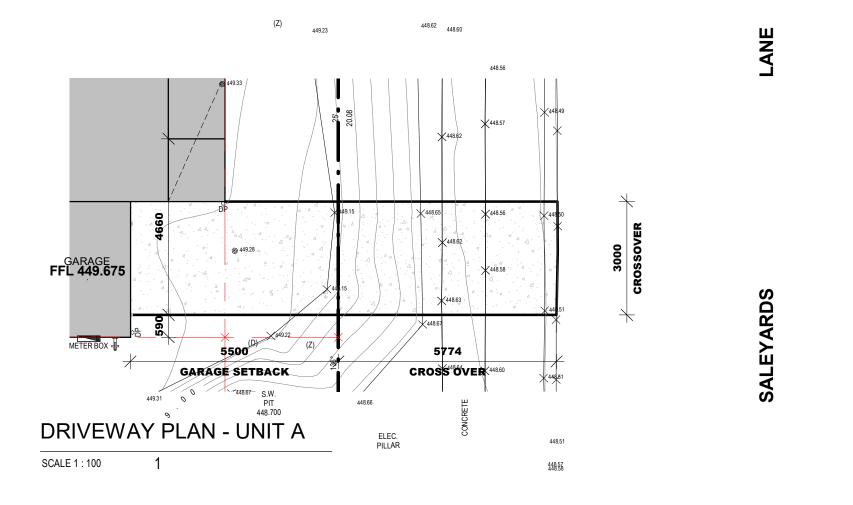


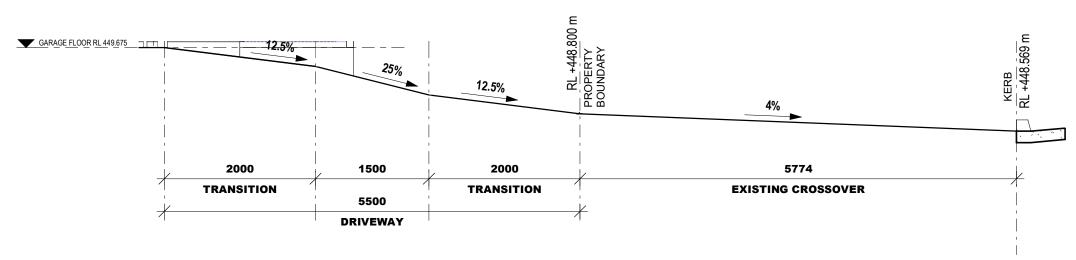
CLIENT'S NAME: TORI PETER GROUP	PROJECT NAME:	ESTATE:	REV. NO:	JOB NO:
TORI PETER GROUP	PROPOSED TORRENS TITLE		12	21001
SITE ADDRESS:	SUBDIVISION & DUAL OCCUPANCY	STAGE: DA	. –	SHEET NO:
LOT 8, DP:1267151	SHEET NAME:		DRAWN:	A003
(No.51) SALEYARDS LANE MUDGEE, NSW 2850	SUB-DIVISION PLAN	1: 200	EDD	04.09.2
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DRIVEWAY GRADIENT UNIT A

2 SCALE 1:50

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NOTES: FIGURED DIMENSIONS MUST TAKE **PREFERENCE** TO SCALING.

CLIENT'S NAME:	PROJECT NAME:	ESTATE:	REV. NO:	JOB NO:
	PROPOSED TORRENS TITLE		12	21001
SITE ADDRESS:	SUBDIVISION & DUAL OCCUPANCY	STAGE:	' -	SHEET NO:
LOT 8, DP:1267151	SHEET NAME:	DA	DRAWN:	A004
(No.51) SALEYARDS LANE	DRIVEWAY DETAILS - UNIT A	SCALE @ A3:		DATE:
MUDGEE, NSW 2850		As indicated	EDD	04.09.22

COUNCIL'S STANDARD. © COPYRIGHT OF

NOTE:

NOTES

PROFILE.

SAG GRADE REFERS TO THE GRADE MADE BY AN **OBTUSE** ANGLE WITHIN A PROFILE.

SUMMIT GRADE REFERS TO THE GRADE MADE BY A

PROFILES ARE TO BE TAKEN

THROUGH THE SHORTEST LENGTH OF DRIVEWAY AND/OR THE CRITICAL SIDE OF

REFLEX ANGLE WITHIN A

DRIVEWAY GRADIENT

THE DRIVEWAY (I.E. THE WORST CASE

FOR A **HIGH** LEVEL

DRIVEWAY, THE PROFILE SHOULD BE DRAWN USING

THE **LOWEST** LEVEL ON THE

FOR A **LOW** LEVEL DRIVEWAY, THE PROFILE SHOULD BE

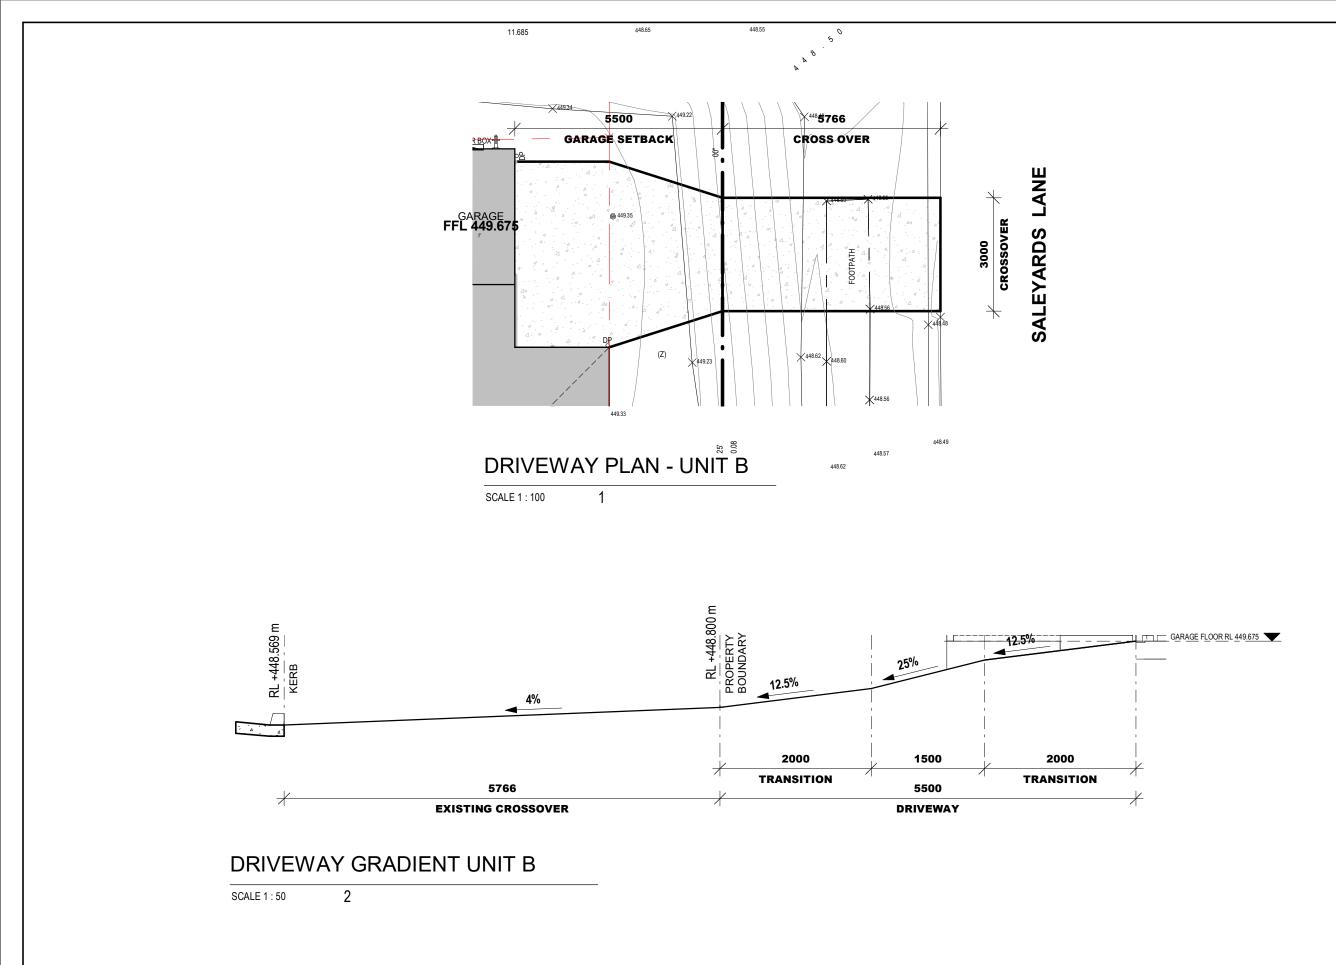
DRAWN USING THE **HIGHEST** LEVEL ON THE KERB.

RETAIN THE EXISTING CROSSOVER LEVELS WHERE PRACTICABLE UNLESS ALTERNATE LEVELS ARE SPECIFIED BY COUNCIL. CHECK WITH COUNCIL IF THE AUSTRALIAN STANDARD TAKES PRECEDENCE OVER

SCENARIO).

DRIVEWAY TO COMPLY WITH AS2890.1:2004.

SITE ADDRESS:				
LOT 8, DP:1267151				
(No.51) SALEYARDS LANE				
MUDCEE NIGWY 2050				



NOTE:

DRIVEWAY TO COMPLY WITH AS2890.1:2004.

NOTES

SAG GRADE REFERS TO THE GRADE MADE BY AN **OBTUSE** ANGLE WITHIN A PROFILE.

SUMMIT GRADE REFERS TO THE GRADE MADE BY A **REFLEX** ANGLE WITHIN A PROFILE.

DRIVEWAY GRADIENT PROFILES ARE TO BE TAKEN THROUGH THE **SHORTEST** LENGTH OF DRIVEWAY AND/OR THE CRITICAL SIDE OF THE DRIVEWAY (I.E. THE WORST CASE SCENARIO).

FOR A **HIGH** LEVEL DRIVEWAY, THE PROFILE SHOULD BE DRAWN USING THE **LOWEST** LEVEL ON THE

FOR A **LOW** LEVEL DRIVEWAY, THE PROFILE SHOULD BE DRAWN USING THE **HIGHEST** LEVEL ON THE KERB.

RETAIN THE EXISTING CROSSOVER LEVELS WHERE PRACTICABLE UNLESS ALTERNATE LEVELS ARE SPECIFIED BY COUNCIL.

CHECK WITH COUNCIL IF THE AUSTRALIAN STANDARD TAKES PRECEDENCE OVER COUNCIL'S STANDARD.

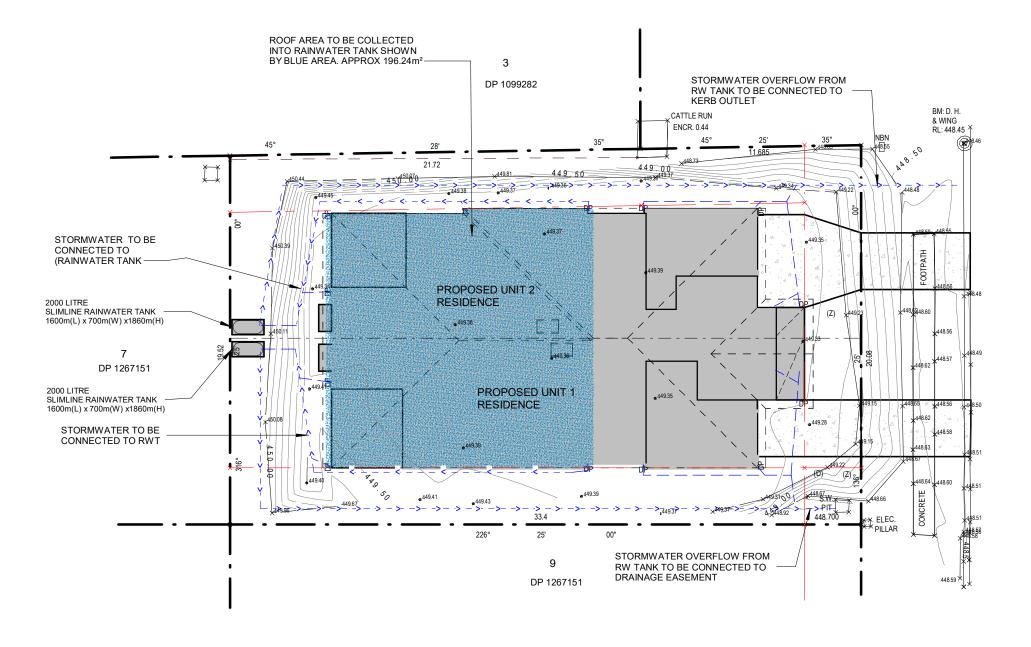
REV. NO: TORI PETER GROUP PROPOSED TORRENS TITLE 21001 12 SUBDIVISION & DUAL OCCUPANCY STAGE: SHEET NO: SITE ADDRESS: DA A005 LOT 8, DP:1267151 DRAWN: DRIVEWAY DETAILS - UNIT B SCALE @ A3: (No.51) SALEYARDS LANE **EDD** 04.09.22 MUDGEE, NSW 2850 As indicated

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SC

DOWNPIPE COUNT

AREA NO. OF DOWNPIPES 354.05 m² 12

CLIENT'S NAME: REV. NO: TORI PETER GROUP PROPOSED TORRENS TITLE 21001 12 SUBDIVISION & DUAL OCCUPANCY STAGE: SHEET NO: SITE ADDRESS: DA A006 LOT 8, DP:1267151 CONCEPT STORMWATER PLAN SCALE @ A3: (No.51) SALEYARDS LANE **EDD** 04.09.22 1:200 MUDGEE, NSW 2850

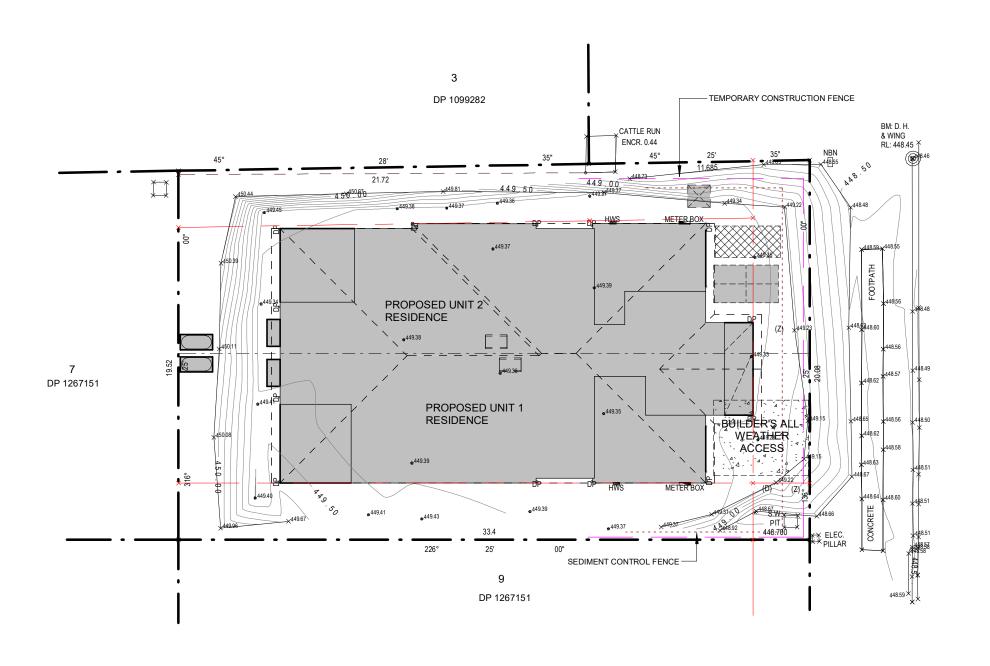
tori pete

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NOISE AND VIBRATION CONTROL:

-BOREHOLE REPORT SHOWS NO ROCK WITHIN SITE. MINIMAL VIBRATION AND NOISE DURING PIER HOLE DRILLING.

- SITE PLAN INDICATES MINIMAL CUT AND FILL PLANT USE WILL BE LOW IMPACT AND FOR MINIMAL TIMBERFRAMES.

SEDIMENT CONTROL NOTES

1. ALL EROSION AND SEDIMENTATION CONTROL MEASURES, INCLUDING REVEGETATION AND STORAGE OF SOIL AND TOPSOIL, SHALL BE IMPLEMENTED TO THE STANDARDS OF THE SOIL CONSERVATION OF NSW AND INSPECTED DAILY BY THE SITE MANAGER.

LANE

SALEYARDS

2. ALL DRAINAGE WORKS SHALL BE CONSTRUCTED AND STABILIZED AS EARLY AS POSSIBLE DURING DEVELOPMENT.

3. SEDIMENT TRAPS SHALL BE CONSTRUCTED AROUND ALL INLET PITS, CONSISTING OF 300mm WIDE x 300mm DEEP TRENCH.

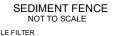
4. ALL SEDIMENT BASINS AND TRAPS SHALL BE CLEANED WHEN THE STRUCTURES ARE A MAXIMUM OF 60% FULL OF SOIL MATERIALS, INCLUDING THE MAINTENANCE PERIOD.

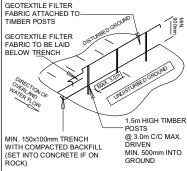
5. ALL DISTURBED AREAS SHALL BE REVEGITATED AS SOON AS THE RELEVANT WORKS ARE COMPLETED.

6. SOIL AND TOPSOIL STOCKPILES SHALL BE LOCATED AWAY FROM DRAINAGE LINES AND AREA WHERE WATER MAY CONCENTRATE. ALL ROADS AND FOOTPATHS TO BE SWEPT DAILY.

7. FILTER SHALL BE CONSTRUCTED BY STRETCHING A FILTER FABRIC (PROPEX OR APPROVED EQUIVALENT BETWEEN POST AT 3.0m CENTRES. FABRIC SHALL BE BURIED 150mm ALONG ITS LOWER

8. DUST PREVENTION MEASURES TO BE MAINTAINED AT ALL TIMES.





LEGEND

	_	CONSTRUCTION FENCE
		SEDIMENT CONTROL FENCE
	\otimes	WASTE STOCKPILE
-		BUILDERS WASTE
À .	`.	ALL WEATHER ACCESS

ONSITE PORTABLE TOILET

TORI PETER GROUP SITE ADDRESS:

CLIENT'S NAME:

LOT 8, DP:1267151 (No.51) SALEYARDS LANE MUDGEE, NSW 2850

PROPOSED TORRENS TITLE SUBDIVISION & DUAL OCCUPANCY SITE MANAGEMENT PLAN

REV. NO: 12 STAGE: DA SCALE @ A3: **EDD**

As indicated

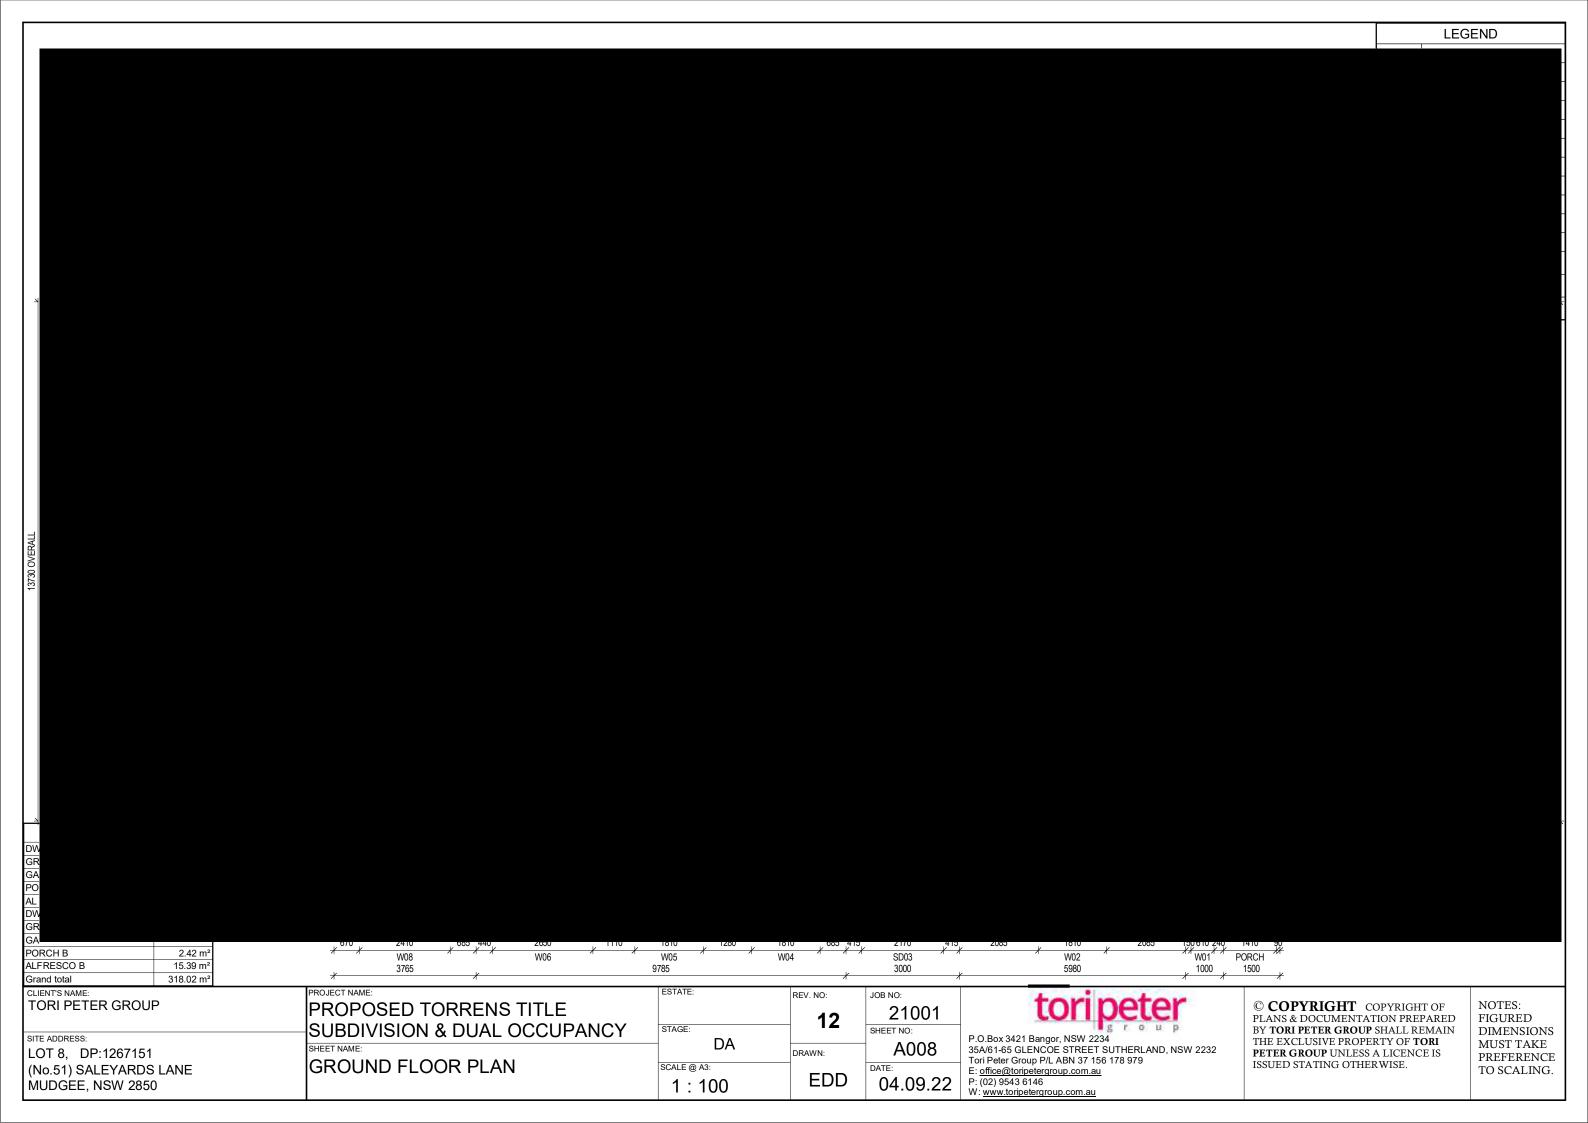
21001 SHEET NO:

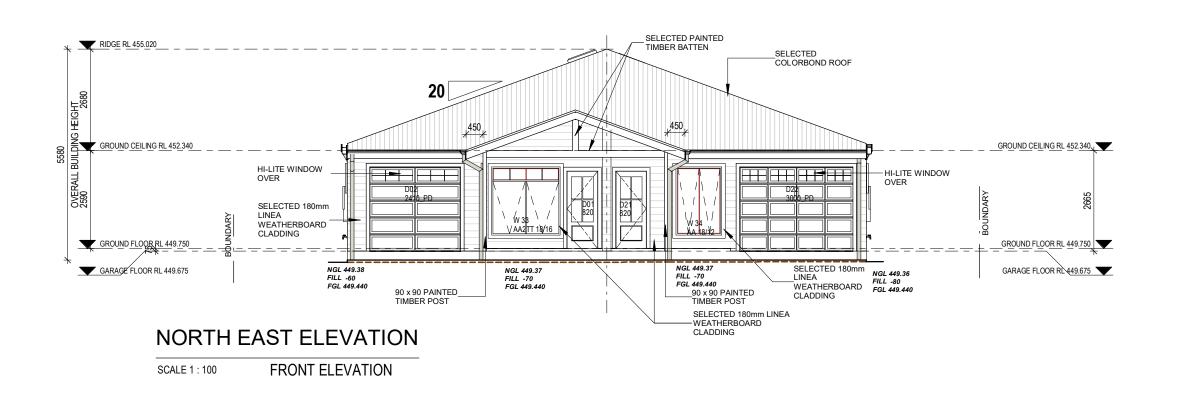
04.09.22

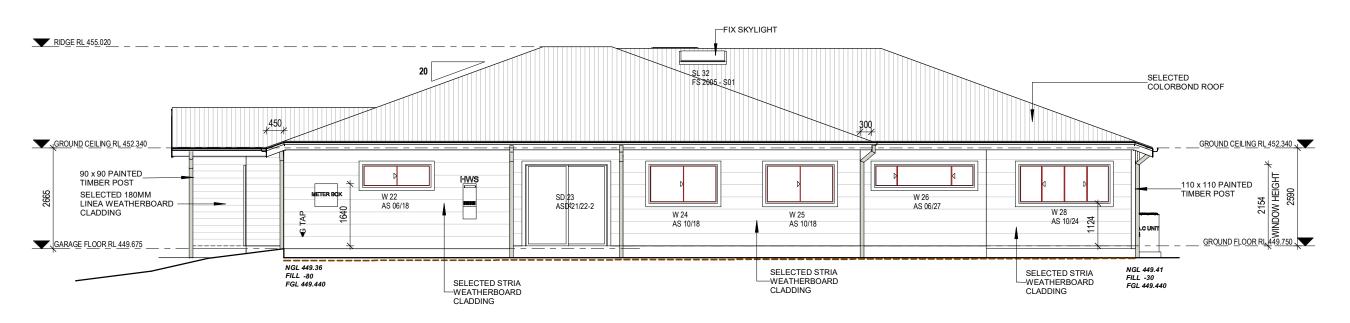
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NORTH WEST ELEVATION

SCALE 1:100 SIDE ELEVATION

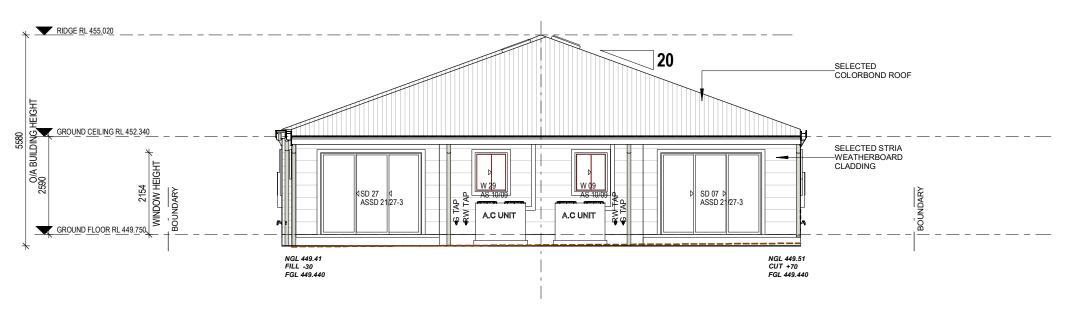
CLIENT'S NAME: TORI PETER GROUP	PROJECT NAME:	ESTATE:	REV. NO:	JOB NO:
SITE ADDRESS:	PROPOSED TORRENS TITLE SUBDIVISION & DUAL OCCUPANCY	STAGE:	12	21001 SHEET NO:
LOT 8, DP:1267151 (No.51) SALEYARDS LANE	SHEET NAME: ELEVATIONS	SCALE @ A3:	DRAWN:	A009
MUDGEE, NSW 2850		1:100	EDD	04.09.22

tori peter

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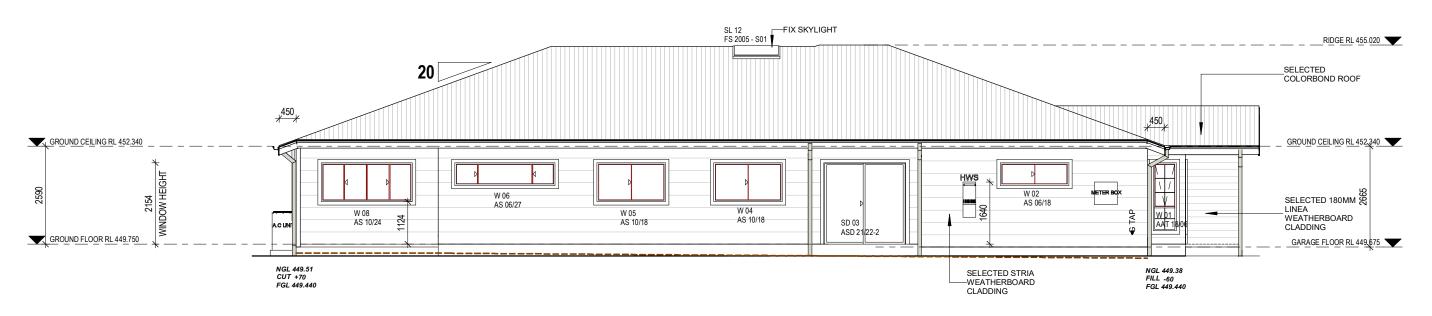
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SOUTH WEST ELEVATION

REAR ELEVATION SCALE 1:100



21001

A010

04.09.22

SOUTH EAST ELEVATION

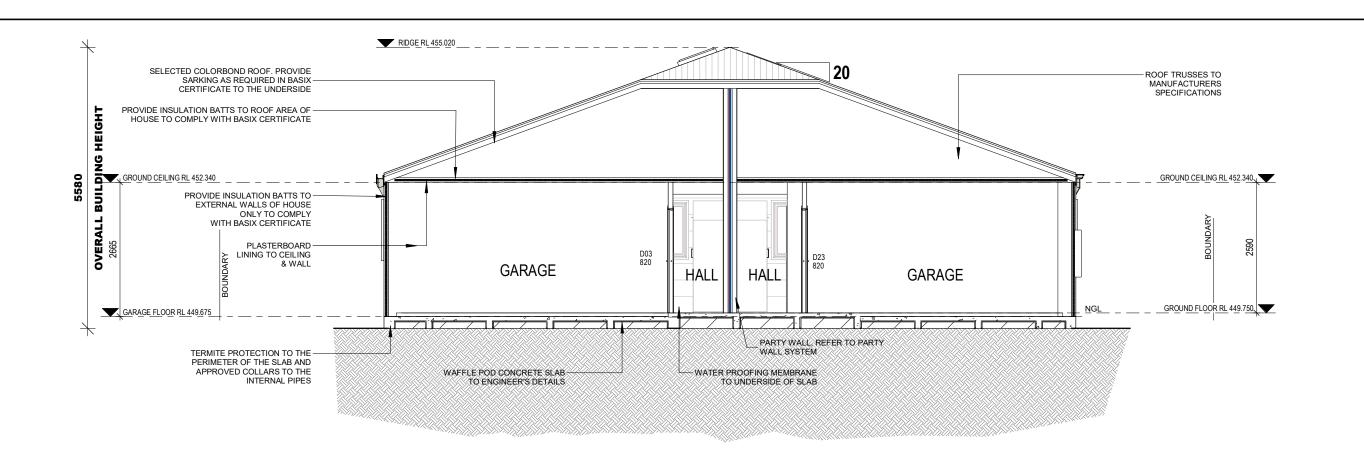
SIDE ELEVATION SCALE 1:100

CLIENT'S NAME:	PROJECT NAME:	ESTATE:	REV. NO:	JOB NO:
TORI PETER GROUP	PROPOSED TORRENS TITLE		12	210
SITE ADDRESS:	SUBDIVISION & DUAL OCCUPANCY	STAGE:	14	SHEET NO:
LOT 8, DP:1267151	SHEET NAME:	DA	DRAWN:	A01
(No.51) SALEYARDS LANE	ELEVATIONS	SCALE @ A3:	-	DATE:
MUDGEE, NSW 2850		1:100	EDD	04.09

P.O.Box 3421 Bangor, NSW 2234 35A/61-65 GLENCOE STREET SUTHERLAND, NSW 2232 Tori Peter Group P/L ABN 37 156 178 979 E: office@toripetergroup.com.au P: (02) 9543 6146

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		V	VIINDOVV &	OLIDIN	O DOON O	CHEDOLL	
TYPE	MARK	CODE	HEIGHT	WIDTH	STYLE	FRAME TYPE	GLAZING
W	01	AAT 18/06	1800	610	AWNING	STANDARD ALUMINIUM	SINGLE CLEAR
W	02	AS 06/18	600	1810	SLIDING	STANDARD ALUMINIUM	SINGLE CLEAR
SD	03	ASD 21/22-2	2154	2170	SLIDING	STANDARD ALUMINIUM	SINGLE CLEAR
W	04	AS 10/18	1030	1810	SLIDING	STANDARD ALUMINIUM	SINGLE CLEAR
W	05	AS 10/18	1030	1810	SLIDING	STANDARD ALUMINIUM	SINGLE CLEAR
W	06	AS 06/27	600	2650	SLIDING	STANDARD ALUMINIUM	SINGLE CLEAR
SD	07	ASSD 21/27-3	2154	2676	STACKING	STANDARD ALUMINIUM	SINGLE LOW E
W	08	AS 10/24	1030	2410	SERVERY WINDOW	STANDARD ALUMINIUM	SINGLE LOW E
W	09	AS 10/09	1030	850	SLIDING	STANDARD ALUMINIUM	SINGLE CLEAR
SL	12	FS 2005 - S01	700	1140	FIXED SKYLIGHT	STANDARD ALUMINIUM	DOUBLE GLAZING
W	22	AS 06/18	600	1810	SLIDING	STANDARD ALUMINIUM	SINGLE CLEAR
SD	23	ASD 21/22-2	2154	2170	SLIDING	STANDARD ALUMINIUM	SINGLE CLEAR
W	24	AS 10/18	1030	1810	SLIDING	STANDARD ALUMINIUM	SINGLE CLEAR
W	25	AS 10/18	1030	1810	SLIDING	STANDARD ALUMINIUM	SINGLE CLEAR
W	26	AS 06/27	600	2650	SLIDING	STANDARD ALUMINIUM	SINGLE CLEAR
SD	27	ASSD 21/27-3	2154	2676	STACKING	STANDARD ALUMINIUM	SINGLE LOW E
W	28	AS 10/24	1030	2410	SERVERY WINDOW	STANDARD ALUMINIUM	SINGLE LOW E
W	29	AS 10/09	1030	850	SLIDING	STANDARD ALUMINIUM	SINGLE CLEAR
SL	32	FS 2005 - S01	700	1140	FIXED SKYLIGHT	STANDARD ALUMINIUM	DOUBLE GLAZING
W	33	AA2TT 18/16	1800	1810	AWNING	STANDARD ALUMINIUM	SINGLE CLEAR
W	34	AA 18/12	1800	1210	AWNING	STANDARD ALUMINIUM	SINGLE CLEAR

	DOOR SC	HEDULE		
MARK	TYPE	HEIGHT	WIDTH	TO ROOM
01	Entry Door: 820	2040	820	ENTRY
02	Garage_Door: 2410_PD	2229	2410	GARAGE
03	Internal_Door: 820	2040	820	WORKSHOP
05	Internal_Door: 820	2040	820	BED 1
07	Cavity_Sliding_Door: 720 CSD	2040	720	ENS
08	Cavity_Sliding_Door: 720 CSD	2040	720	BED 1
09	Internal_Double_Door: 2 x 620	2040	1240	HALL
10	Cavity_Sliding_Door: 720 CSD	2040	720	BATH
11	Internal_Door: 820	2040	820	BED 2
12	Internal_Door: 720	2040	720	BED 2
13	Internal_Door: 820	2040	820	BED 3
14	Internal_Door: 720	2040	720	BED 3
21	Entry Door: 820	2040	820	ENTRY
22	Garage_Door: 3000_PD	2229	3000	GARAGE
23	Internal_Door: 820	2040	820	GARAGE
25	Internal_Door: 820	2040	820	BED 1
26	Cavity_Sliding_Door: 720 CSD	2040	720	ENS.
27	Cavity_Sliding_Door: 720 CSD	2040	720	BED 1
28	Internal_Double_Door: 2 x 620	2040	1240	HALL
29	Cavity_Sliding_Door: 720 CSD	2040	720	BATH
30	Internal_Door: 820	2040	820	BED 2
31	Internal_Door: 720	2040	720	BED 2
32	Internal_Door: 820	2040	820	BED 3
33	Internal Door: 720	2040	720	BED 3

CLIENT'S NAME:	PROJECT NAME:	ESTATE:	REV. NO:	JOB NO:
TORI PETER GROUP	PROPOSED TORRENS TITLE	07405	12	21001
SITE ADDRESS:	SUBDIVISION & DUAL OCCUPANCY	STAGE:		SHEET NO:
LOT 8, DP:1267151	SHEET NAME:	- DA	DRAWN:	A011
(No.51) SALEYARDS LANE	SECTION WINDOW & DOOR	SCALE @ A3:		DATE:
MUDGÉE, NSW 2850	SCHEDULES	1:75	EDD	04.09.22

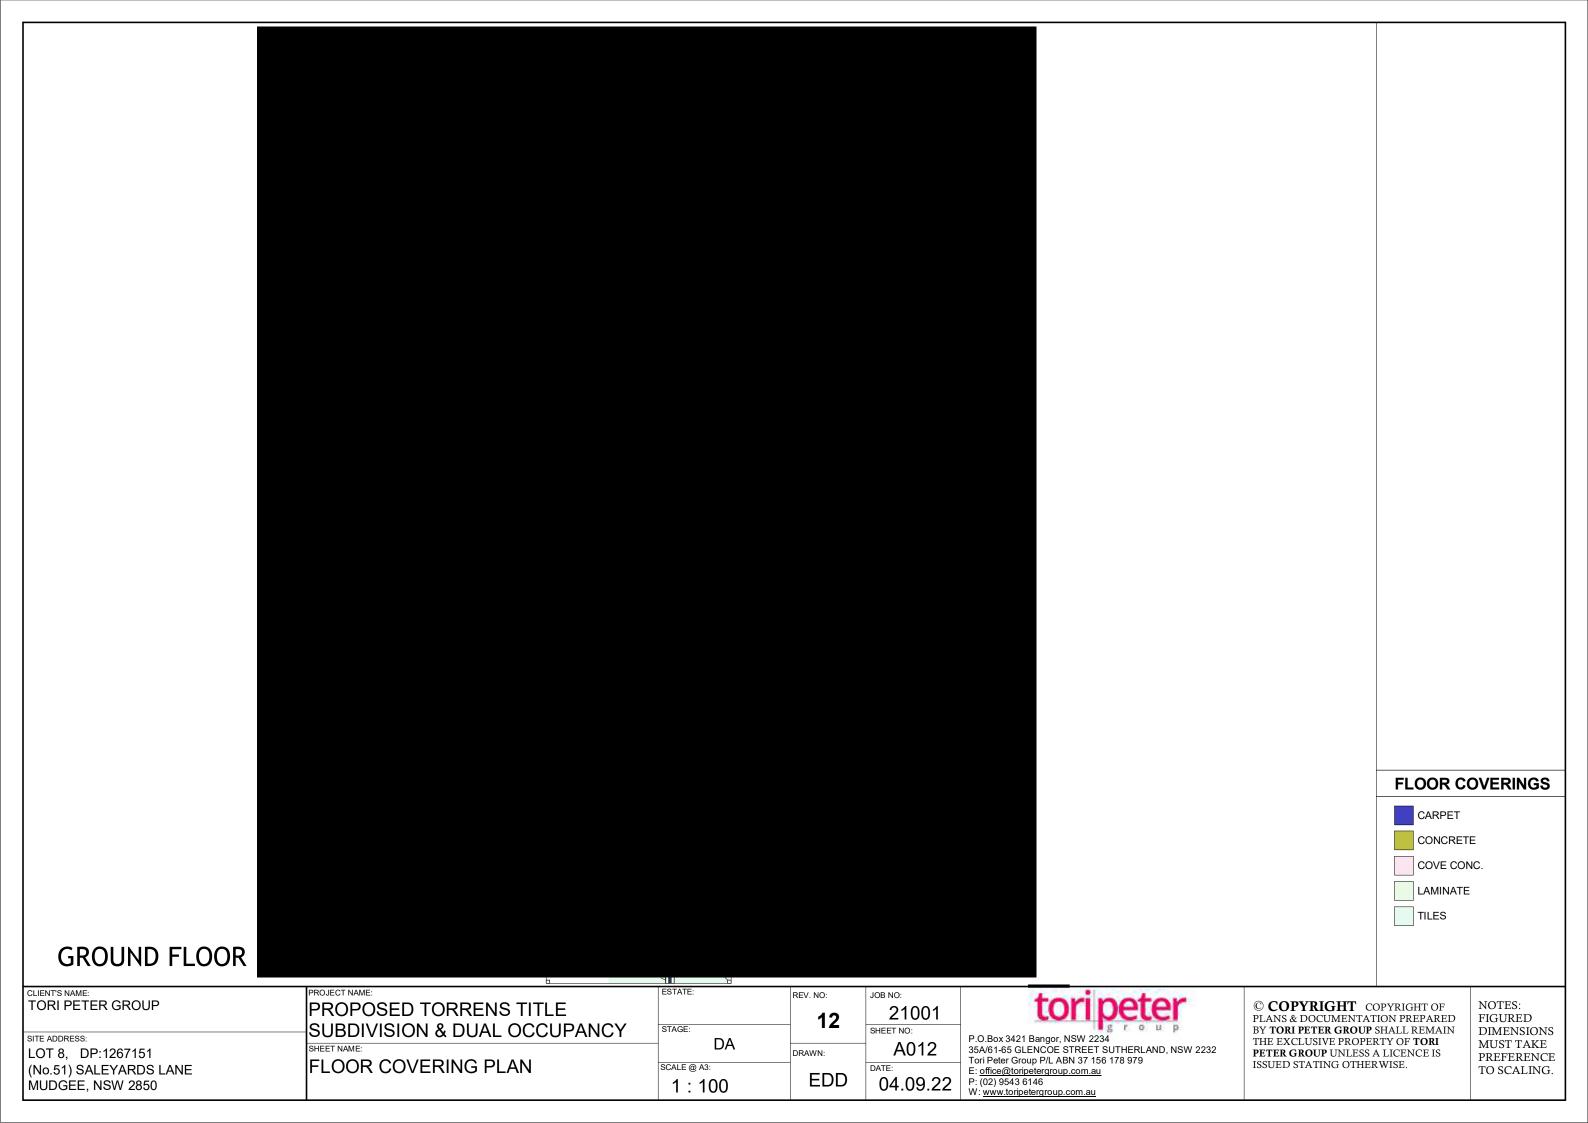
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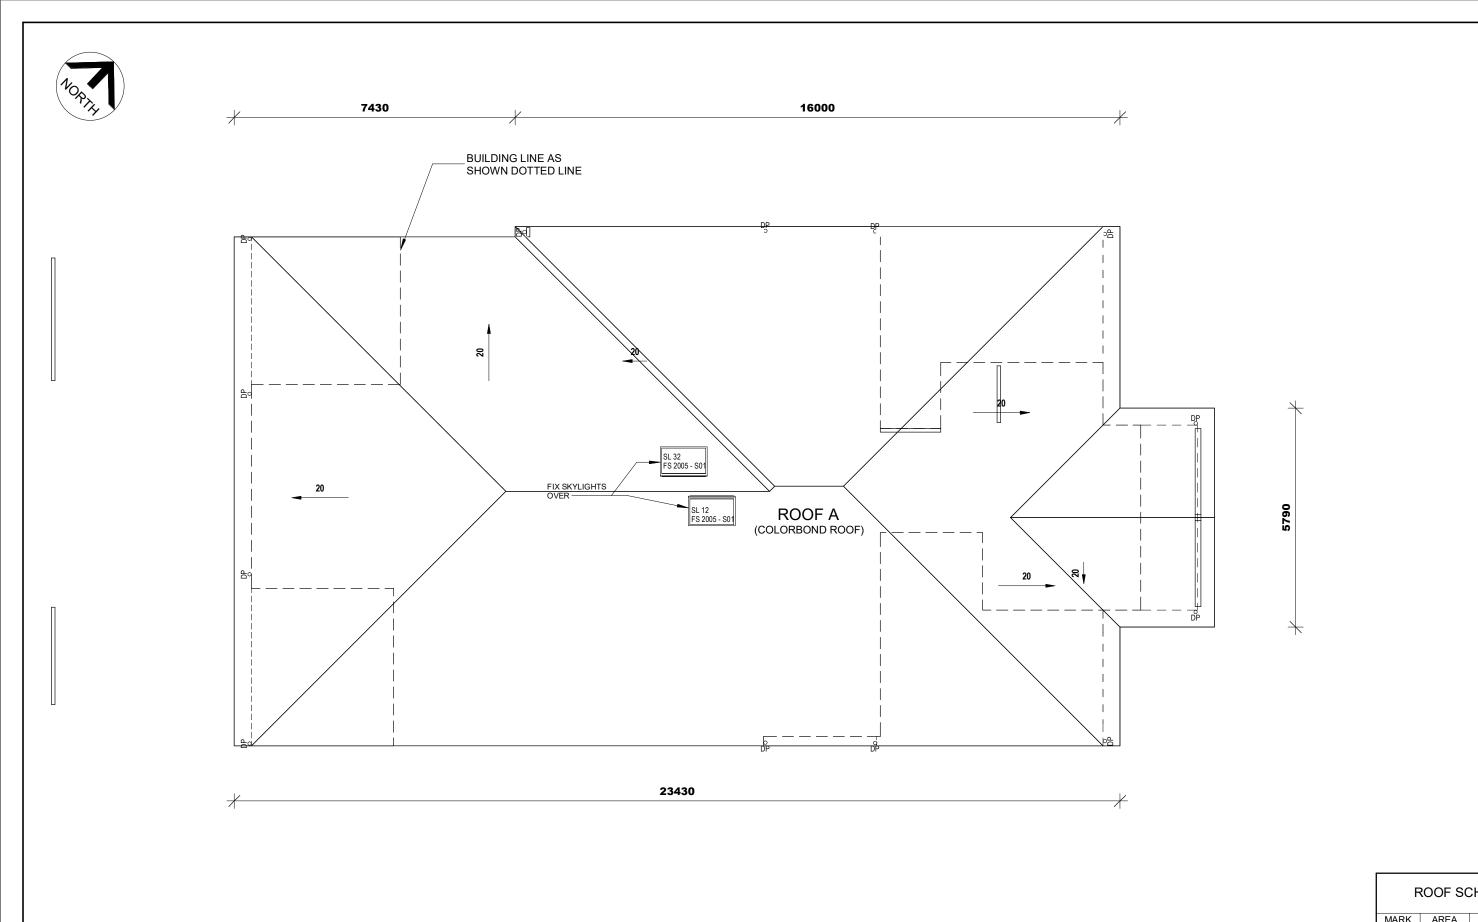
P.O.Box 3421 Bangor, NSW 2234 35A/61-65 GLENCOE STREET SUTHERLAND, NSW 2232 Tori Peter Group P/L ABN 37 156 178 979

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R()()F	SCHEDULE
11001	OULLDULL

MARK	AREA	TYPE
ROOF A	354.05 m ²	COLORBOND ROOF
TOTAL	354.05 m ²	

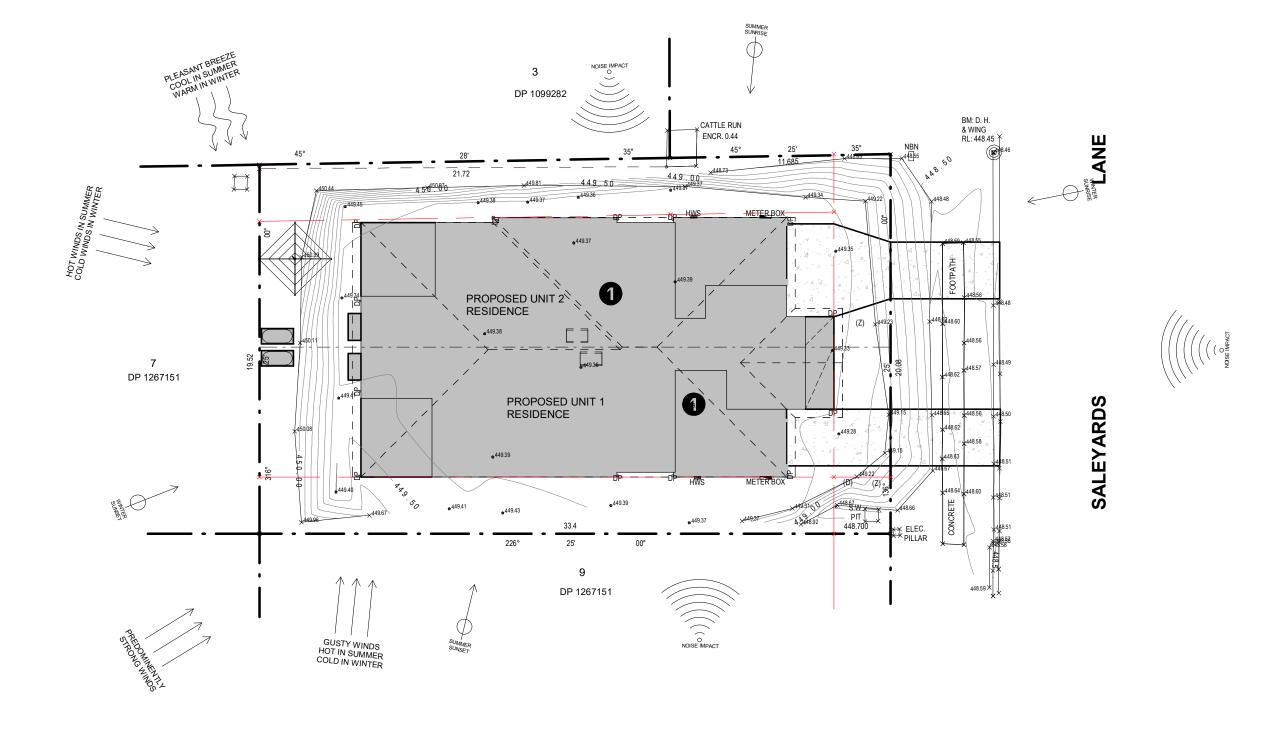
CLIENT'S NAME:	PROJECT NAME:	ESTATE:	REV. NO:
TORI PETER GROUP	PROPOSED TORRENS TITLE SUBDIVISION & DUAL OCCUPANCY	STAGE:	12
SITE ADDRESS:		DA	
LOT 8, DP:1267151	SHEET NAME:	B/X	DRAWN:
(No.51) SALEYARDS LANE	ROOF PLAN	SCALE @ A3:	
MUDGÉE, NSW 2850		1:100	EDD

STATE:	REV. NO:	JOB NO:
	12	21001
ſAGE:	14	SHEET NO:
DA	DRAWN:	A013
TALE @ A3: 1:100	EDD	04.09.22

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CLIENT'S NAME: TORI PETER GROUP
SITE ADDRESS:
LOT 8, DP:1267151
LOT 8, DP:1267151 (No.51) SALEYARDS LANE MUDGEE, NSW 2850

PROPOSED TORRENS TITLE SUBDIVISION & DUAL OCCUPANCY SHEET NAME: SITE ANALYSIS

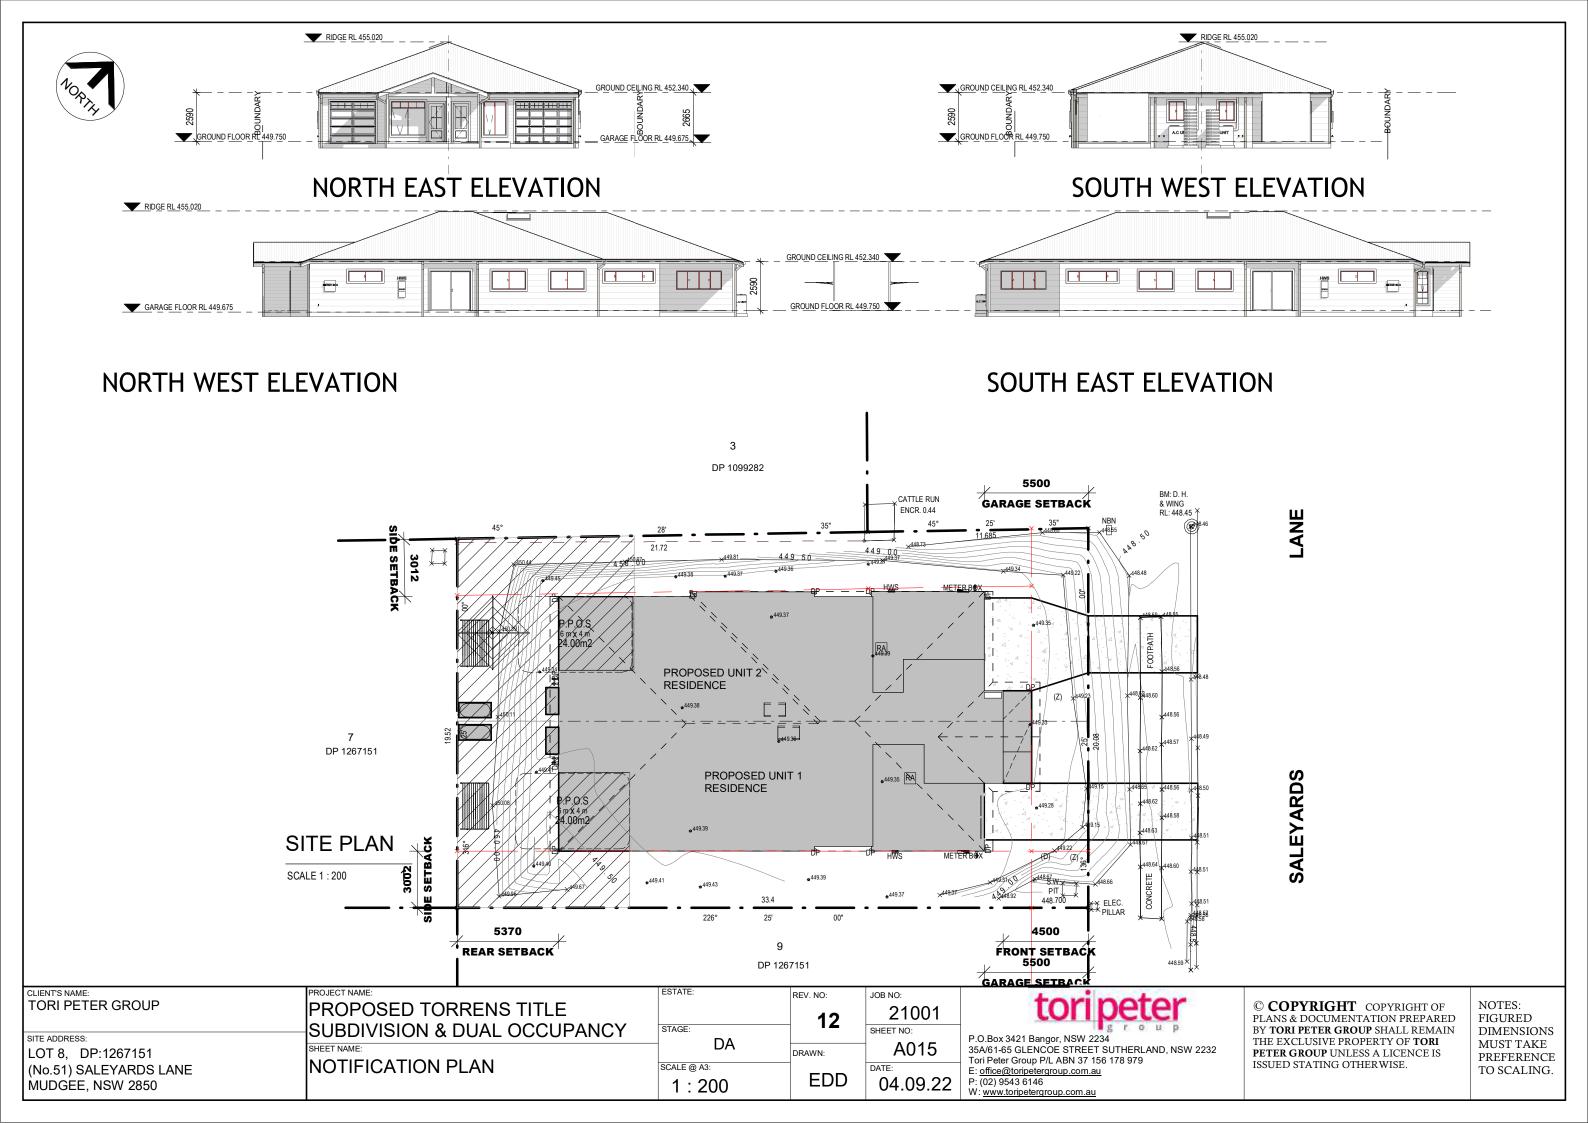
ESTATE:	REV. NO:
	12
STAGE:	' -
DA	
	DRAWN:
SCALE @ A3:	1 [
1 · 200	EDD
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JOB NO: 21001 SHEET NO: A014

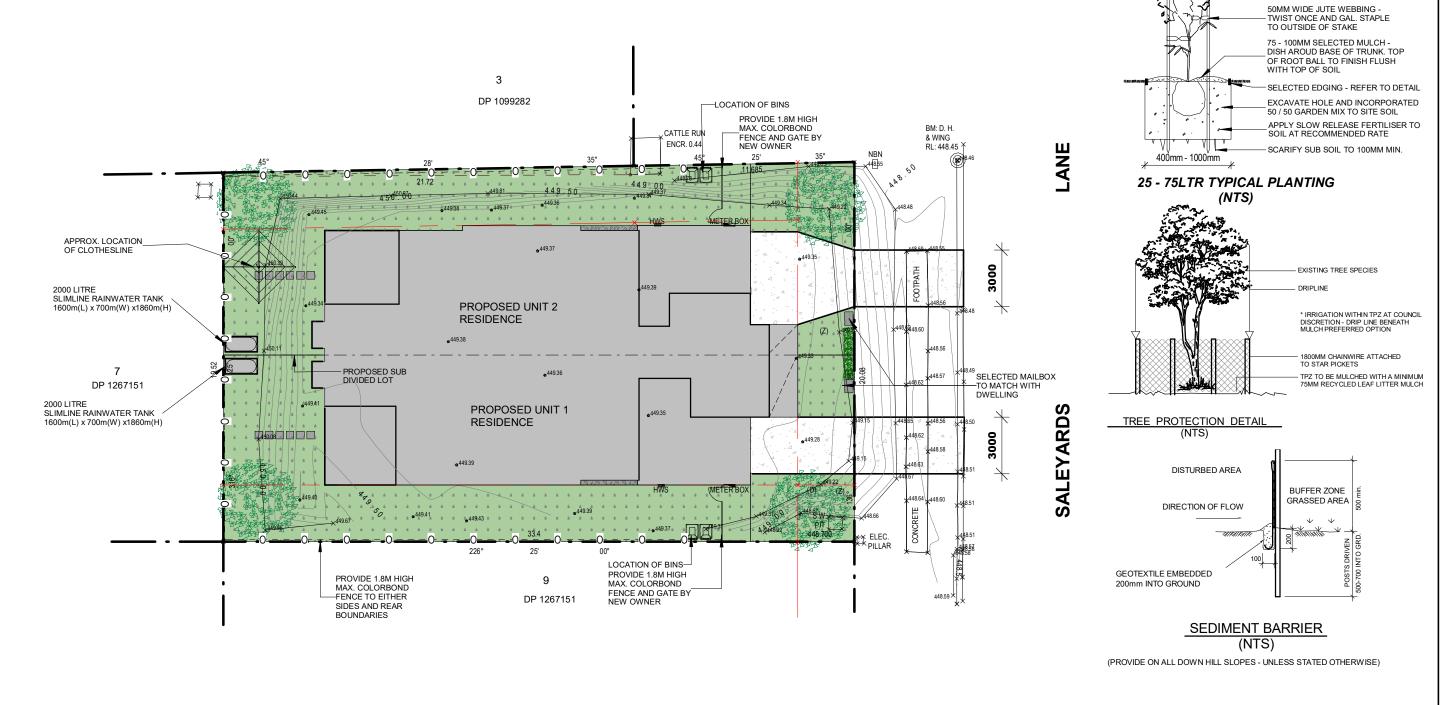
04.09.22

P.O.Box 3421 Bangor, NSW 2234 35A/61-65 GLENCOE STREET SUTHERLAND, NSW 2232 Tori Peter Group P/L ABN 37 156 178 979 E: office@toripetergroup.com.au P: (02) 9543 6146

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							20 20 20 20	HEDGE
							oo_	BOUNDARY FENCE
							(TREES
	PLANT SCHEDULES							BINS
SYMBOL	COMMON NAME	BOTANIC NAME	SPACING	POT SIZE	MATURE HEIGHT	COUNT		
ASAM	Dwarf Lillypilli	Acmena Smithii 'Allyn Magic'	1m	300mm	0.9m hedged	1		MAILBOX
SAP	Chinese Tallow Tree	Sapium Sebiferum	-	45lt	9m	4		PAVERS
							7	GATE

CLIENT'S NAME: TORI PETER GROUP PROPOSED TORRENS TITLE SUBDIVISION & DUAL OCCUPANCY SITE ADDRESS: LOT 8, DP:1267151 LANDSCAPE PLAN (No.51) SALEYARDS LANE MUDGEE, NSW 2850

ESTATE: REV. NO: JOB NO: 21001 12 STAGE: SHEET NO: DA DRAWN: SCALE @ A3: **EDD** 04.09.22 1:200

P.O.Box 3421 Bangor, NSW 2234 35A/61-65 GLENCOE STREET SUTHERLAND, NSW 2232 Tori Peter Group P/L ABN 37 156 178 979

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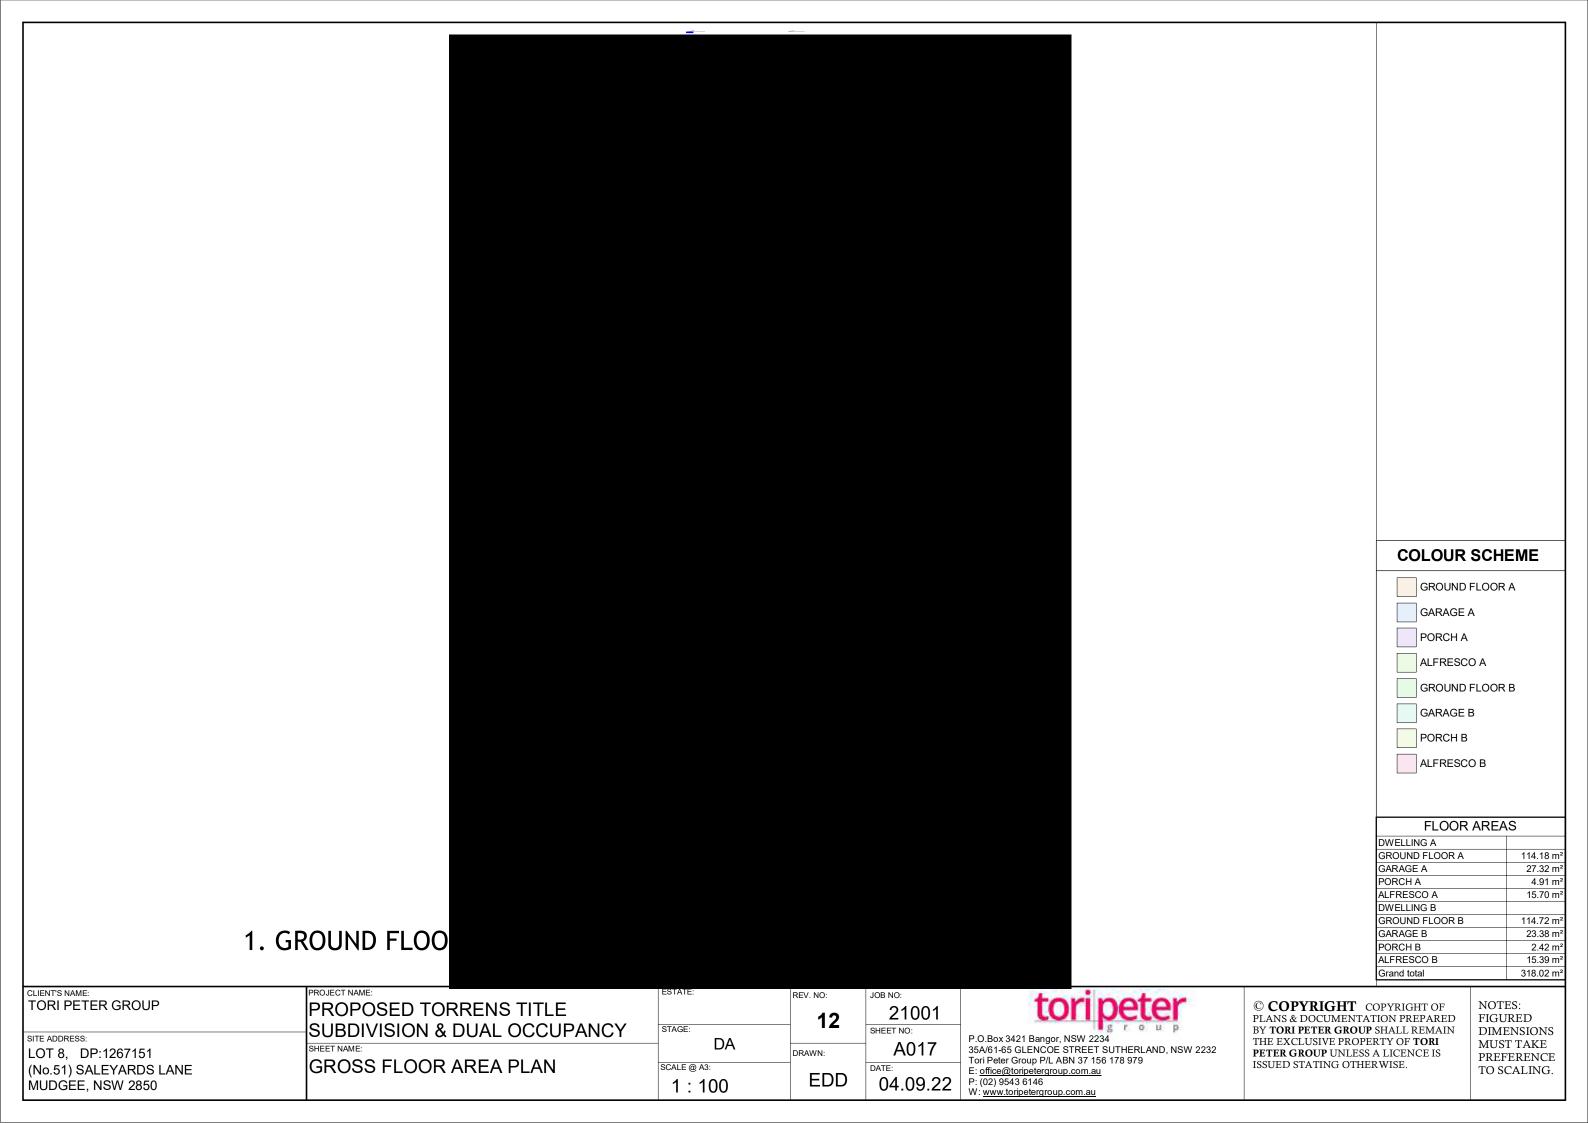
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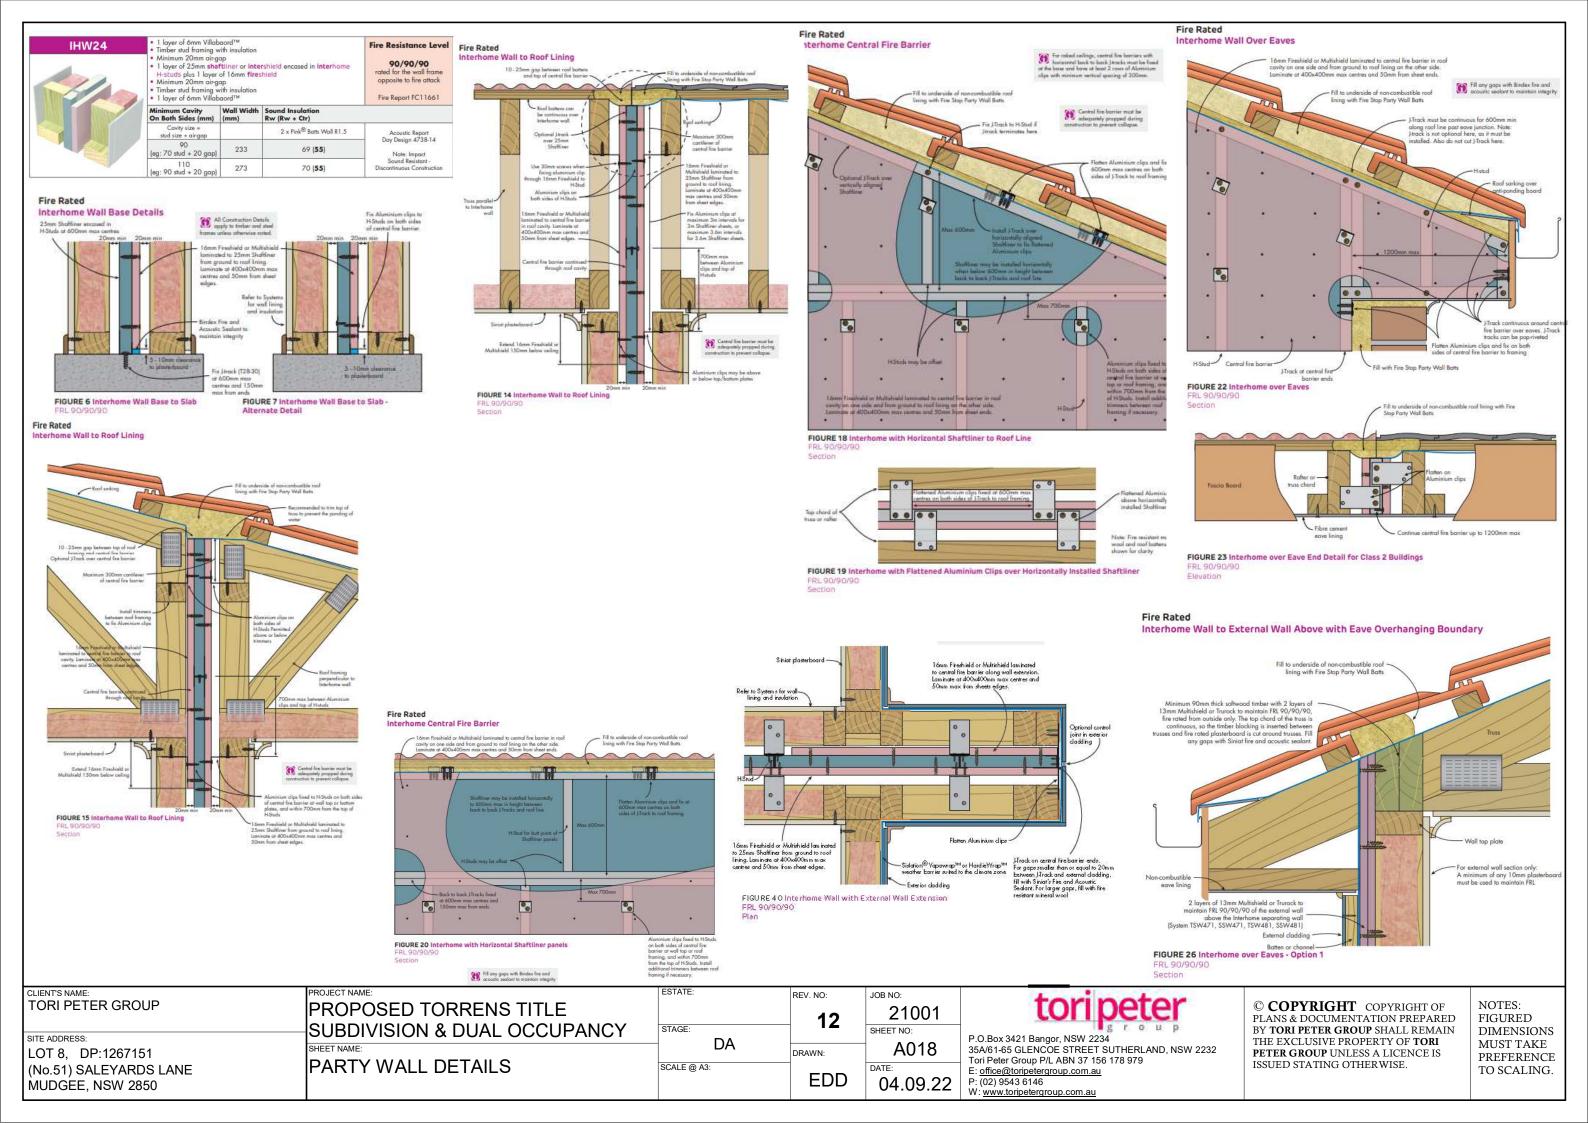
NOTES: FIGURED **DIMENSIONS** MUST TAKE PREFERENCE TO SCALING.

LEGEND

GRASS GRAVEL

2 x 40MM HARDWOOD -STAKES AS REQUIRED. DO NOT PEIRCE ROOT BALL







Building Sustainability Index www.basix.nsw.gov.au

Multi Dwelling

Certificate number: 1313916M

Schedule of BASIX commitments

The commitments set out below regulate how the proposed development is to be carried out. It is a condition of any development consent granted, or complying development certificate issued, for the proposed development, that BASIX commitments be complied with.

1. Commitments for multi-dwelling houses

(a) Dwellings

(i) Water	Show on DA plans	Show on CC/CDC plans & specs	Certifier check
(a) The applicant must comply with the commitments listed below in carrying out the development of a dwelling listed in a table below.			
(b) The applicant must plant indigenous or low water use species of vegetation throughout the area of land specified for the dwelling in the "Indigenous species" column of the table below, as private landscaping for that dwelling. (This area of indigenous vegetation is to be contained within the "Area of garden and lawn" for the dwelling specified in the "Description of Project" table).	~	~	
(c) If a rating is specified in the table below for a fixture or appliance to be installed in the dwelling, the applicant must ensure that each such fixture and appliance meets the rating specified for it.		~	~
(d) The applicant must install an on demand hot water recirculation system which regulates all hot water use throughout the dwelling, where indicated for a dwelling in the "HW recirculation or diversion" column of the table below.		~	~
(e) The applicant must install:			
(aa) a hot water diversion system to all showers, kitchen sinks and all basins in the dwelling, where indicated for a dwelling in the "HW recirculation or diversion" column of the table below; and		_	•
(bb) a separate diversion tank (or tanks) connected to the hot water diversion systems of at least 100 litres. The applicant must connect the hot water diversion tank to all toilets in the dwelling.		-	•
(e) The applicant must not install a private swimming pool or spa for the dwelling, with a volume exceeding that specified for it in the table below.	V	V	
(f) If specified in the table, that pool or spa (or both) must have a pool cover or shading (or both).		V	
(g) The pool or spa must be located as specified in the table.	V	V	
(h) The applicant must install, for the dwelling, each alternative water supply system, with the specified size, listed for that dwelling in the table below. Each system must be configured to collect run-off from the areas specified (excluding any area which supplies any other alternative water supply system), and to divert overflow as specified. Each system must be connected as specified.	~	•	•

			Fixtur	es		Appli	ances		Indi	vidual pool		in	dividual	spa
Dwelling no.	All shower- heads	All toilet flushing systems	kitchen	All bathroom taps	HW recirculation or diversion	All clothes washers	All dish- washers	Volume (max volume)	Pool cover	Pool location	Pool shaded	Volume (max volume)	Spa cover	Spa shaded
All dwellings	4 star (> 4.5 but <= 6 L/min)	4 star	4 star	4 star	no	-	-	-	-	-	-	-	-	-

		Alternative water source									
Dwelling no.	Alternative water supply systems	Size	Configuration	Landscape connection	Toilet connection (s)		Pool top-up	Spa top-up			
All dwellings	individual water tank (no. 1)	Tank size (min) 1500.0 litres	To collect run-off from at least: 157.0 square metres of roof area;	yes	yes	yes	no	no			
None	-	-	-	-	-	-	-	-			

(ii) Energy	Show on DA plans	Show on CC/CDC plans & specs	Certifier check
(a) The applicant must comply with the commitments listed below in carrying out the development of a dwelling listed in a table below.			
(b) The applicant must install each hot water system specified for the dwelling in the table below, so that the dwelling's hot water is supplied by that system. If the table specifies a central hot water system for the dwelling, then the applicant must connect that central system to the dwelling, so that the dwelling's hot water is supplied by that central system.	~	~	~
(c) The applicant must install, in each bathroom, kitchen and laundry of the dwelling, the ventilation system specified for that room in the table below. Each such ventilation system must have the operation control specified for it in the table.		~	V
(d) The applicant must install the cooling and heating system/s specified for the dwelling under the "Living areas" and "Bedroom areas" headings of the "Cooling" and "Heating" columns in the table below, in/for at least 1 living/bedroom area of the dwelling. If no cooling or heating system is specified in the table for "Living areas" or "Bedroom areas", then no systems may be installed in any such areas. If the term "zoned" is specified beside an air conditioning system, then the system must provide for day/night zoning between living areas and bedrooms.		~	~

(ii) Energy	Show on DA plans	Show on CC/CDC plans & specs	Certifier check
(e) This commitment applies to each room or area of the dwelling which is referred to in a heading to the "Artificial lighting" column of the table below (but only to the extent specified for that room or area). The applicant must ensure that the "primary type of artificial lighting" for each such room in the dwelling is fluorescent lighting or light emitting diode (LED) lighting. If the term "dedicated" is specified for a particular room or area, then the light fittings in that room or area must only be capable of being used for fluorescent lighting or light emitting diode (LED) lighting.		~	*
(f) This commitment applies to each room or area of the dwelling which is referred to in a heading to the "Natural lighting" column of the table below (but only to the extent specified for that room or area). The applicant must ensure that each such room or area is fitted with a window and/or skylight.	~	~	~
(g) This commitment applies if the applicant installs a water heating system for the dwelling's pool or spa. The applicant must			
(aa) install the system specified for the pool in the "Individual Pool" column of the table below (or alternatively must not install any system for the pool). If specified, the applicant must install a timer, to control the pool's pump; and		V	
(bb) install the system specified for the spa in the "Individual Spa" column of the table below (or alternatively must not install any system for the spa). If specified, the applicant must install a timer to control the spa's pump.			
(h) The applicant must install in the dwelling:			
(aa) the kitchen cook-top and oven specified for that dwelling in the "Appliances & other efficiency measures" column of the table below;		V	
(bb) each appliance for which a rating is specified for that dwelling in the "Appliances & other efficiency measures" column of the table, and ensure that the appliance has that minimum rating; and		-	~
(cc) any clothes drying line specified for the dwelling in the "Appliances & other efficiency measures" column of the table.		•	
(i) If specified in the table, the applicant must carry out the development so that each refrigerator space in the dwelling is "well ventilated".		V	
(j) The applicant must install the photovoltaic system specified for the dwelling under the "Photovoltaic system" heading of the "Alternative energy" column of the table below, and connect the system to that dwelling's electrical system.	V	~	< -

	Hot water	Bathroom ven	tilation system	Kitchen venti	lation system	Laundry ventilation system		
Dwelling no.	Hot water system	Each bathroom	Operation control	Each kitchen	Operation control	Each laundry	Operation control	
All dwellings	gas instantaneous 6 star	individual fan, ducted to façade or roof	manual switch on/off	individual fan, ducted to façade or roof	manual switch on/off	individual fan, ducted to façade or roof	manual switch on/off	

	Cooling		Heating		Artificial lighting						Natural lighting	
Dwelling no.	living areas	bedroom areas	living areas	bedroom areas	No. of bedrooms &/or study	No. of living &/or dining rooms	Each kitchen	All bathrooms/ toilets	Each laundry	All hallways	No. of bathrooms &/or toilets	Main kitcher
All dwellings	1-phase airconditioning EER 3.0 - 3.5 (zoned)	3 (dedicated)	2 (dedicated)	yes (dedicated)	yes (dedicated)	yes (dedicated)	yes (dedicated)	0	yes			

		Individual pool		Individual spa		Appliances & other efficiency measures							
Dwell no.	lling	Pool heating system	Timer	Spa heating system	Timer	Kitchen cooktop/oven	Refrigerator	Well ventilated fridge space	Dishwasher		Clothes dryer	Indoor or sheltered clothes drying line	Private outdoor or unsheltered clothes drying line
All dwelli	ings	-	-	-	-	gas cooktop & electric oven	-	yes	-	-	-	yes	yes

	Alternative energy
Dwelling no.	Photovoltaic system (min rated electrical output in peak kW)
All dwellings	-

(iii) Thermal Comfort	Show on DA plans	Show on CC/CDC plans & specs	Certifier check
(a) The applicant must attach the certificate referred to under "Assessor details" on the front page of this BASIX certificate (the "Assessor Certificate") to the development application and construction certificate application for the proposed development (or, if the applicant is applying for a complying development certificate for the proposed development, to that application.) The applicant must also attach the Assessor Certificate to the application for a final occupation certificate for the proposed development.			
(b) The Assessor Certificate must have been issued by an Accredited Assessor in accordance with the Thermal Comfort Protocol.			
(c) The details of the proposed development on the Assessor Certificate must be consistent with the details shown in this BASIX Certificate, including the details shown in the "Thermal Loads" table below.			

CLIENT'S NAME:	PROJECT NAME:
TORI PETER GROUP	PROPOSED TORRENS TITLE
	———SUBDIVISION & DUAL OCCUPANCY
SITE ADDRESS:	SHEET NAME:
LOT 8, DP:1267151	- · · - · · · · · · · · · · · · · · ·
(No.51) SALEYARDS LANE MUDGEE, NSW 2850	BASIX NOTES
INIODGLE, NOVY 2000	

ESTATE:	REV. NO:	JOB NO:	A- will
	12	21001	torit
STAGE:	1 4	SHEET NO:	P.O.Box 3421 Bangor, NSW 2234
DA	DRAWN:	A019	35A/61-65 GLENCOE STREET S Tori Peter Group P/L ABN 37 156
SCALE @ A3:	EDD	04.09.22	E: office@toripetergroup.com.au P: (02) 9543 6146 W: www.toripetergroup.com.au



Tori Peter Group P/L ABN 37 156 178 979

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Multi Dwelling

Certificate number: 1313916M

Show on DA plans	Show on CC/CDC plans & specs	Certifier check
~		
	~	
	~	V
v	V	•
v	v	V

	Thermal loads					
Dwelling no.	Area adjusted heating load (in mJ/m²/yr)	Area adjusted cooling load (in mJ/m²/yr)				
Α	261.9	5.7				
All other dwellings	256.7	11.7				

	Construction of floors and walls									
Dwelling no.	Concrete slab on ground(m²)	Suspended floor with open subfloor (m²)	Suspended floor with endclosed subfloor (m²)		Primarily rammed earth or mudbrick walls					
All dwellings	90	-	-	-	No					

3. Commitments for common areas and central systems/facilities for the development (non-building specific)

(b) Common areas and central systems/facilities

(i) Water	Show on DA plans	Show on CC/CDC plans & specs	Certifier check
(a) If, in carrying out the development, the applicant installs a showerhead, toilet, tap or clothes washer into a common area, then that item must meet the specifications listed for it in the table.		~	-
(b) The applicant must install (or ensure that the development is serviced by) the alternative water supply system(s) specified in the "Central systems" column of the table below. In each case, the system must be sized, be configured, and be connected, as specified in the table.	~	~	~
(c) A swimming pool or spa listed in the table must not have a volume (in kLs) greater than that specified for the pool or spa in the table.	V	~	
(d) A pool or spa listed in the table must have a cover or shading if specified for the pool or spa in the table.		~	
(e) The applicant must install each fire sprinkler system listed in the table so that the system is configured as specified in the table.		~	¥
(f) The applicant must ensure that the central cooling system for a cooling tower is configured as specified in the table.		~	¥

Common area	Showerheads rating	Toilets rating	Taps rating	Clothes washers rating
All common areas	no common facility	no common facility	no common facility	no common laundry facility

(ii) Energy	Show on DA plans	Show on CC/CDC plans & specs	Certifier check
(a) If, in carrying out the development, the applicant installs a ventilation system to service a common area specified in the table below, then that ventilation system must be of the type specified for that common area, and must meet the efficiency measure specified.		~	~
(b) In carrying out the development, the applicant must install, as the "primary type of artificial lighting" for each common area specified in the table below, the lighting specified for that common area. This lighting must meet the efficiency measure specified. The applicant must also install a centralised lighting control system or Building Management System (BMS) for the common area, where specified.		~	~
(c) The applicant must install the systems and fixtures specified in the "Central energy systems" column of the table below. In each case, the system or fixture must be of the type, and meet the specifications, listed for it in the table.	V	V	v

	PROJECT NAME:	ESTATE:	REV. NO:	JOB NO:
TORI PETER GROUP	PROPOSED TORRENS TITLE		12	21001
CUTE ADDRESS.	SUBDIVISION & DUAL OCCUPANCY	STAGE:	12	SHEET NO:
SITE ADDRESS: LOT 8, DP:1267151	SHEET NAME:	DA	DRAWN:	A020
(No.51) SALEYARDS LANE	BASIX NOTES	SCALE @ A3:		DATE:
MUDGÉE, NSW 2850			EDD	04.09.2



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Nationwide House Energy Rating Scheme NatHERS Certificate No. TJ43VJZBMG

Generated on 17 Jun 2022 using FirstRate5: 5.3.2a (3.21)

Property

Address DW-A, 51 Saleyards Lane, Mudgee, NSW, 2850

Lot/DP 8/-/DP1267151 NCC Class* Class 1a

Type New Home

Plans Main plan 21001

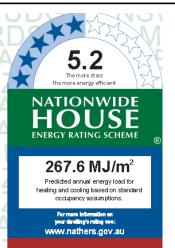
Prepared by

Construction and environment

Assessed floor area (m2)* Exposure type Conditioned*

Total 127.1 Garage

suburban 90.2 NatHERS climate zone Unconditioned* 36.9 65 Orange AP 32.8



Thermal performance

Heating Cooling 261.9 5.7

MJ/m² MJ/m²

Additional Notes

- 1. Roof colour to be as per certificate
- 2. All insulation type may be replaced with similar R-value OR BETTER
- 3. All window type may be replaced with similar u-value and SHGC OR BETTER

Window and glazed door type and performance

Default* windows

Derault Williaows				Substitution to	lerance ranges
Window ID	Window description	Maximum U-value*	SHGC*	SHGC lower limit	SHGC upper limit
ALM-002-01 A	Aluminium B SG Clear	6.7	0.7	0.66	0.74
ALM-002-03 A	Aluminium B SG High Solar Gain Low-E	5.4	0.58	0.55	0.61

Custom* windows

No Data Available

Window ID	Window description	Maximum U-value*	SHGC*	SHGC lower limit	SHGC upper limit

Window and glazed door Schedule

								Window
			Height	Width				shading
Location	Window ID	Window no.	(mm)	(mm)	Window type	Opening %	Orientation	device*
Bedroom 1	ALM-002-01 A	SD23	2154	2170	sliding	30.0	SE	No

TJ43VJZBMG NatHERS Certificate			5.2 Star Railing as of 17 Jun 2022					HOUSE
Bedroom2	ALM-002-01 A	24	1030	1810	sliding	45.0	SE	No
Bedroom3	ALM-002-01 A	25	1030	1810	sliding	45.0	SE	No
Kitchen/Living8	ALM-002-01 A	29	1030	850	sliding	45.0	SW	No
Kitchen/Living8	ALM-002-03 A	28	1030	2410	sliding	45.0	SE	No .
Kitchen/Living8	ALM-002-03 A	SD27	2154	2676	sliding	30.0	SW	No
Kitchen/Living8	ALM-002-01 A	26	600	2650	sliding	45.0	SE	No
HALLWAY	ALM-002-01 A	21	1800	610	awning	60.0	SE	No .

Roof window type and performance value

Windowdescription

Default* rolof windows

WindowID

No Data Available

		Maximum		CHCC lavor limit	CHCC up per limit
WindowID	Windowdescription	U-value*	SHGC*	SHOC IMMEL IIIIII	SHGC upper limit
No Data Available	!				
Custom* roof wind	lows				
				Substitution to	lerance ranges

U-value*

Roof window schedule

				Агеа		Outdoor	hdoor
Location	WindowID	Windowno.	Opening %	(m^2)	Orientation	shade	shade
No Data Available							

Skylight type and performance

arylight type and pendimance		
Skylight ID	Skylight description	
No Data Available		

Skylight schedule

No Data Available	Onyman is	1101	19 19 11 (11111)	()	2,,222	
Location	Skylight ID	Skylight No.	Skylightshart length (mm)			reflectance

External door schedule

 Location	Height (mm)	Width (mm)	Opening %	Orientation	
Garage 1	2229	4810	100.0	NE	
HALLWAY	2100	820	100.0	NE	

External wall type

		Solar	Wall shade	≘	Reflective
all ID	Walltype	absorptance	e (colour)	Bulkinsulation (R-value)	well wrap*
1	FR5 - Fibro Clad Framed	0.5	Medium	Rockwool batt: R2.0 (R2.0)	No
2	WALL-01 - Db-party	0.5	Medium		No

External wall schedule

					nonzanta shading	vertica
	Wall	Height	Width		feature* maximum	shading feature
Location	ID	(mm)	(mm)	Orientation	projection (mm)	(yes/no)
Garage 1	1	2665	5791	SE	0	Yes
Garage 1	1	2665	5242	NE	0	Yes
Garage 1	1	2665	260	sw	0	Yes
Bedroom 1	1	2665	3006	SE	0	Yes
Bedroom2	1	2665	3004	SE	0	Yes
Bedroom2	1	2665	243	NE	0	Yes
Bedroom3	1	2665	3005	SE	0	Yes
Bedroom3	1	2665	236	SW	0	Yes
Kitchen/Living 8	2	2665	7182	NW	0	No
Kitchen/Living 8	1	2665	2459	SW	0	No
Kitchen/Living 8	1	2665	3937	SE	3896	Yes
Kitchen/Living 8	1	2665	3917	sw	4263	Yes
Kitchen/Living 8	1	2665	3251	SE	0	Yes
HALLWAY	1	2665	1385	NE	1797	No
HALLWAY	2	2665	16091	NW	0	No
HALLWAY	1	2665	922	SE	0	Yes

Horizontal shading - Vertical

Internal wall type

waitio	wartype	Area(IIF) bulkinsulation
1	FR5 - Internal Plasterboard Stud Wall	128.6 Rockwool batt: R2.0 (R2.0)

Floor type

Substitution tolerance ranges

SHGC lower limit SHGC upper limit

		Area	Sub-floor	Added insulation	
Location	Construction	(m^2)	ventilation	(R-value)	Covering
Garage 1	FR5 - 225mm waffle pod, 85mm concrete (R0.60)	32.8	Enclosed	RO.D	none
Bedroom 1	FR5 - 225mm waffle pod, 85mm concrete (R0.60)	13.5	Enclosed	R0.0	Carpet
WIR	FR5 - 225mm waffle pod, 85mm concrete (R0.60)	1.5	Enclosed	R0.0	Carpet
Bedroom2	FR5 - 225mm waffle pod, 85mm concrete (R0.60)	9.6	Enclosed	R0.0	Carpet
ENS	FR5 - 225mm waffle pod, 85mm concrete (R0.60)	4.3	Enclosed	R0.0	Tiles
Bedroom3	FR5 - 225mm waffle pod, 85mm concrete (R0.60)	9.6	Enclosed	R0.0	Carpet
Bath	FR5 - 225mm waffle pod, 85mm concrete (R0.60)	4	Enclosed	R0.0	Tiles
Kitchen/Living 8	FR5 - 225mm waffle pod, 85mm concrete (R0.60)	30.4	Enclosed	R0.0	Vinyl
HALLWAY	FR5 - 225mm waffle pod, 85mm concrete (R0.60)	21.4	Enclosed	R0.0	Vinyl

Ceiling type

		Bulkinsulation R-value (may	Reflective
Location	Construction material/type	include edge batt values)	wrap*
Garage 1	Plasterboard	R4.5	Yes
Bedroom 1	Plasterboard	R4.5	Yes
WIR	Plasterboard	R4.5	Yes
Bedroom2	Plasterboard	R4.5	Yes
ENS	Plasterboard	R4.5	Yes
Bedroom3	Plasterboard	R4.5	Yes
Bath	Plasterboard	R4.5	Yes
Kitchen/Living8	Plasterboard	R4.5	Yes
HALLWAY	Plasterboard	R4.5	Yes

Ceiling penetrations*

L	ocation	Quantity	Туре	Diameter (mm)	Sealed/unsealed
E	ENS	1	Exhaust Fans	250	Sealed
E	9 ath	1	Exhaust Fars	250	Sealed
-	Kitchen/Living 8	1	Exhaust Fans	250	Sealed

Ceiling fans

Location	Quantity	Diameter (mm)
No Data Available		

Roof type

0t- 0#F - 0 F	4.0		D - 4.	
Construction	Added insulation (R-value)	Solar absorptance	Roof shade	

CLIENT'S NAME TORI PETER GROUP

SITE ADDRESS: LOT 8, DP:1267151 (No.51) SALEYARDS LANE MUDGEE, NSW 2850

PROPOSED TORRENS TITLE SUBDIVISION & DUAL OCCUPANCY

Substitution tolerance ranges

NATHERS NOTES - DWELLING A

ESTATE:	REV. NO:	JOB NO:
	12	21001
STAGE:	14	SHEET NO:
DA	DRAWN:	A021
SCALE @ A3:	EDD	04.09.2



P.O.Box 3421 Bangor, NSW 2234 35A/61-65 GLENCOE STREET SUTHERLAND, NSW 2232 Tori Peter Group P/L ABN 37 156 178 979

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Nationwide House Energy Rating Scheme NatHERS Certificate No. 19C9SHOBQM

Generated on 17 Jun 2022 using First Rate5: 5.3.2a (3.21)

Property

Address DW-B,51 Saleyards Lane, Mudgee, NSW, 2850 Lot/DP

NCC Class* Class 1a Туре New Home

Plans

Total

Main plan 21001 Prepared by

Construction and environment

Assessed floor area (m²)* Exposuretype

Conditioned* 90.2 Unconditioned*

36.9

NatHERS dimate zone 65 Orange AP 127.1

Additional Notes

- 1. Roof colour to be as per certificate
- 2. All insulation type may be replaced with similar R-value OR BETTER
- 3. All window type may be replaced with similar u-value and SHGC OR BETTER

suburban

Window and glazed door type and performance

Default* windows

				Substitution to	lerance ranges
WindowID	Windowdescription	Maximum U-value*	SHGC*	SHGC lower limit	SHGC upper limi
ALM-002-01 A	Aluminium B SG Clear	6.7	0.7	0.66	0.74
ALM-002-03 A	Aluminium B SG High Solar Gain Low-E	5.4	0.58	0.55	0.61

Custom* window	WS			
			Substitution to	olerance ranges
		Maximum	CUC C 1 5-3	CUCC
WindowID	Windowdescription	U-value* SH	HGC*	SHGC upper limit
No Data Availat	ble			

Window and glazed door Schedule

			Height	Width				shading
Location	WindowID	Windowno.	(mm)	(mm)	Windowtype	Opening %	Orientation	device*
Bedroom 1	ALM-002-01 A	SD23	2154	2170	sliding	30.0	NW	No

edroom2	ALM-002-01 A	24	1030	1810	sliding	45.0	NW	No
edroom3	ALM-002-01 A	25	1030	1810	sliding	45.0	NW	No
(itchen/Living8	ALM-002-01 A	26	600	2650	sliding	45.0	NW	No
(itchen/Living8	ALM-002-03 A	SD27	2154	2676	sliding	30.0	SW	No
(itchen/Living8	ALM-002-03 A	28	1030	2410	sliding	45.0	NW	No
(itchen/Living8	ALM-002-01 A	29	1030	850	sliding	45.0	SW	No
IALLWAY	ALM-002-01 A	21	1800	610	awning	60.0	NW	No

Roof window type and performance value

Default* rolof windows

NATIONWIDE

HOUSE

268.4 MJ/m²

Pie dbie diann vallenergy load for he ating an diccolling base dion standard occupancy assumptions.

Cooling

11.7

MJ/m²

for more information on your deading's using sea: www.nathere.gov.au

Thermal performance

Heating

256.7

MJ/m²

				Substitution tolerance ranges		
		Maximum		SHGC lawer limit	SHGC upper limit	
WindowID	Windowdescription	U-value*	U-value* SHGC*		orroo apper minit	
No Data Available						

Custom* roof windows

2					Substitution to	lerance ranges
	WindowID	Windowdescription	Maximum U-value*	SHGC*	SHGC lower limit	SHGC upper limit
	No Data Available	windowdesarption	0-value"	SHOC"		
	No Data Awallable					

Roof window schedule

				Агеа		Outdoor	Indoor
Location	WindowID	Windowno.	Opening %	(m^2)	Orientation	shade	shade
No Data Available							

Skylight type and performance

Skylight ID	Skylight description
No Data Available	

Skylight schedule

		Skylight	Skylightshaft	Area Orient-	Outdoor		Skylight shaft	
Location	Skylight ID	No.	length (mm)	(m²) ation	shade	Diffuser	reflectance	
No Data Available								_

External door schedule

Location	Height (mm)	Width (mm)	Opening %	Orientation	
Garage 1	2229	4810	100.0	NE	
HALLWAY	2100	820	100.0	NE	

External wall type

		301 a r	wall shade	:	re leal ve
Wall ID	Walltype	absorptance	(colour)	Bulkinsulation (R-value)	well wrap*
1	FR5 - Fibro Clad Framed	0.5	Medium	Rockwool batt: R2.0 (R2.0)	No
2	WALL-01 - Db-party	0.5	Medium		No

External wall schedule

					Horizontal shading	Vertical
	Wall	Height	Width		feature* maximum	shading feature
Location	ID	(mm)	(mm)	Orientation	projection (mm)	(yes/no)
Garage 1	1	2665	260	SW	0	Yes
Garage 1	1	2665	5242	NE	0	Yes
Garage 1	1	2665	5791	NW	0	Yes
Bedroom 1	1	2665	3006	NW	0	Yes
Bedroom2	1	2665	243	NE	0	Yes
Bedroom2	1	2665	3004	NW	0	Yes
Bedroom3	1	2665	236	sw	0	Yes
Bedroom3	1	2665	3005	NW	0	Yes
Kitchen/Living 8	1	2665	3251	NW	0	Yes
Kitchen/Living 8	1	2665	3917	SW	4263	Yes
Kitchen/Living 8	1	2665	3937	NW	3896	Yes
Kitchen/Living 8	1	2665	2459	sw	0	No
Kitchen/Living 8	2	2665	7182	SE	0	No
HALLWAY	1	2665	922	NW	0	Yes
HALLWAY	2	2665	16091	SE	0	No
HALLWAY	1	2665	1385	NE	1797	Yes

Internal wall type

FR5 - Internal Plasterboard Stud Wall

Floor type

		Area	Sub-floor	Added insulation	
Location	Construction	(m^2)	ventilation	(R-value)	Covering
Garage 1	FR5 - 225mm waffle pod, 85mm concrete (R0.60)	32.8	Enclosed	R0.0	none
Bedroom 1	FR5 - 225mm waffle pod, 85mm concrete (R0.60)	13.5	Enclosed	R0.0	Carpet
WIR	FR5 - 225mm waffle pod, 85mm concrete (R0.60)	1.5	Enclosed	R0.0	Carpet
Bedroom2	FR5 - 225mm waffle pod, 85mm concrete (R0.60)	9.6	Enclosed	R0.0	Carpet
ENS	FR5 - 225mm waffle pod, 85mm concrete (R0.60)	4.3	Enclosed	R0.0	Tiles
Bedroom3	FR5 - 225mm waffle pod, 85mm concrete (R0.60)	9.6	Enclosed	R0.0	Carpet
Bath	FR5 - 225mm waffle pod, 85mm concrete (R0.60)	4	Enclosed	R0.0	Tiles
Kitchen/Living 8	FR5 - 225mm waffle pod, 85mm concrete (R0.60)	30.4	Enclosed	R0.0	Vinyl
HALLWAY	FR5 - 225mm waffle pod, 85mm concrete (R0.60)	21.4	Enclosed	R0.0	Vinyl

Ceiling type

			Bulk insulation R-value (may	Reflective	
Location C		Construction material/type	include edge batt values)	wrap*	
Garage :	1	Plasterboard	R4.5	Yes	
Bedroom 1		Plasterboard	R4.5	Yes	
	WIR	Plasterboard	R4.5	Yes	
	Bedroom2	Plasterboard	R4.5	Yes	
	ENS	Plasterboard	R4.5	Yes	
	Bedroom3	Plasterboard	R4.5	Yes	
	B <i>a</i> th	Plasterboard	R4.5	Yes	
	Kitch en/Living	g8 Plasterboard	R4.5	Yes	
	HALLWAY	Plasterboard	R4.5	Yes	

Ceiling penetrations*

Location	Quantity	Туре	Diameter (mm)	Sealed/unsealed	
ENS	1	Exhaust Fans	250	Sealed	
Bath	1	Exhaust Fans	250	Sealed	
Mitch and in in a O	4	Eubauet Case	260	Contod	Т

Ceiling fans

Location	Quantity	Diameter (mm)
No Data Available		

Post time

				_
Construction	Added insulation (R-value)	Solar absorptance	Roof shade	
Rout type				

Cont:Attic-Continuou

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NOTES: FIGURED **DIMENSIONS** MUST TAKE **PREFERENCE** TO SCALING.

CLIENT'S NAME REV. NO: TORI PETER GROUP PROPOSED TORRENS TITLE 21001 STAGE:

NATHERS NOTES - DWELLING B

12 SHEET NO: DA A022 DRAWN: SCALE @ A3: **EDD** 04.09.22

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