

4780 2400 ر 1240 ر **GARAGE** 21.60 PATIO 2.72 **EAR PATIO** 8.64 TOTAL 149.65 sq.m. (16.11 sq.) UST SYSTEMS INSTALLED (INCLUDING 240 1580 11 MINIMUM FLOW RATE IN ACCORDANCE 3200 3160

NOTES - STAIR TREADS TO COMPLY WITH BCA 3.9.1

> SMOKE ALARM **O**SA

8 EXHAUST FAN

* NOTE: EXTERNAL LIGHTING ALL EXTERNAL LIGHT FITTINGS ARE TO BE SHIELDED.
I.E. DOES NOT PERMIT LIGHT TO SHINE ABOVE THE HORIZONTAL PLANE.

* ALL DIMENSIONS ARE TO BE CONFIRMED BY THE BUILDER PRIOR TO CONSTRUCTION. DO NOT SCALE FROM DRAWINGS. BUILDING SET OUT & SITE BOUNDARY DETAILS TO BE CONFIRMED BY A REGISTERED SURVEYOR.
ALL WORK TO BE CARRIED OUT TO
RELEVANT STANDARDS AND BUILDING CODES.

"MACQUARIE SG"

350 <u>1580</u>

3330

TASTIC & LIGHT VENT COMBO) TO HAVE WITH PART 3.8.7 NCC 2019

LIVING

116.69

EXHAUST SYSTEMS (INCLUDING TASTIC & LIGHT VENT COMBO) TO DISCHARGE TO OUTSIDE AIR OR VENTILATED ROOF SPACE AS PER PART 3.8.7 NCC 2019. METHOD CHOSEN IS TO MATCH COMPLIANCE WITH THE RELEVANT BASIX CERTIFICATE.

PLIABLE BUILDING MEMBRANE INSTALLED IN EXTERNAL WALLS TO BE A VAPOR PERMEABLE TYPE, COMPLY WITH AS/NZS 4200.1 AND BE INSTALLED AS PER AS4200.2

EXTERNAL DOORS AND OPENABLE WINDOWS IN CONDITIONED SPACES TO BE SEALED TO RESTRICT AIR INFILTRATION AS PER PART 3.12.3 NCC 2019



DATE:	SCALE:	DRAWN:
15.11.22	1:100 (A3)	WP
SHEET:	JOB No:	ISSUE:

D


21379


1 / 8


DRAWING: FLOOR PLAN - DWELLING A **LOT 106 DUNNACHIE ST, MUDGEE (NO.8) MAAS GROUP PROPERTIES**


3160



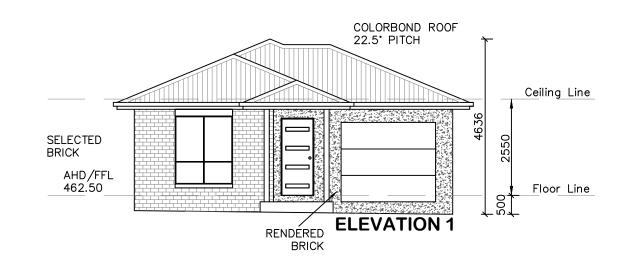

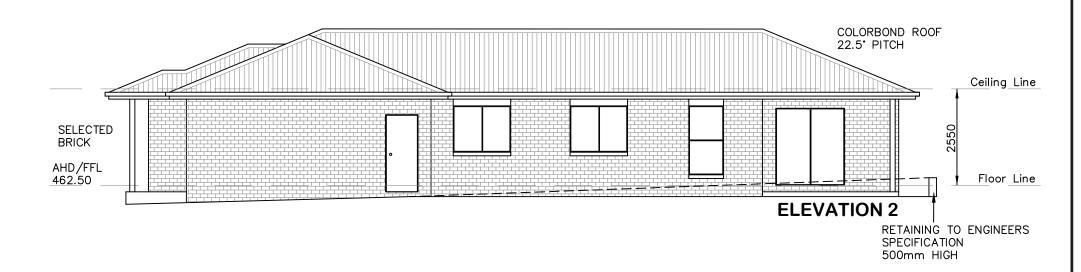

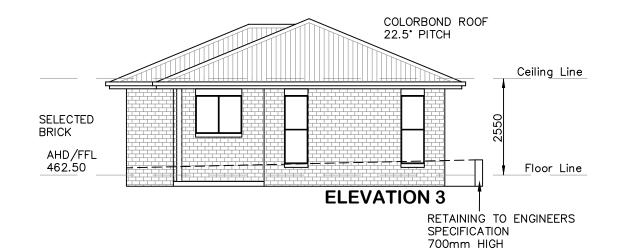

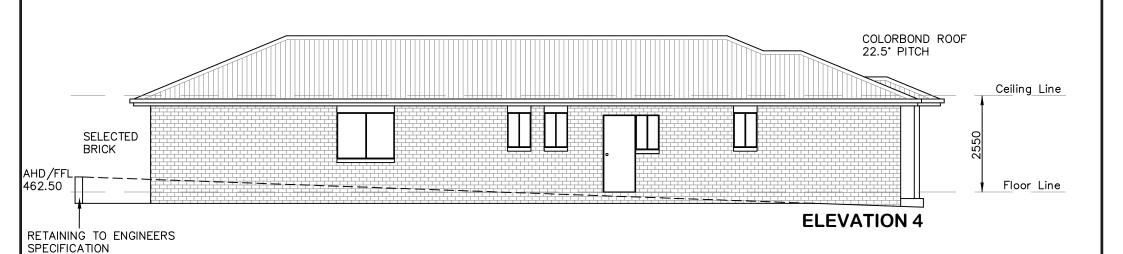

* ALL DIMENSIONS ARE TO BE CONFIRMED BY THE BUILDER PRIOR TO CONSTRUCTION. DO NOT SCALE FROM DRAWNGS. BUILDING SET OUT & SITE BOUNDARY DETAILS TO BE CONFIRMED BY A REGISTERED SURVEYOR. ALL WORK TO BE CARRIED OUT TO RELEVANT STANDARDS AND BUILDING CODES.

700mm HIGH

y - v	7	
		S
DDC	DED	TIES
	PRO	PROPER

	SCALE: 1:100 (A3)	DRAWN: WP
SHEET:	JOB No:	ISSUE:

D


21379

2 / 8

DRAWING: ELEVATIONS - DWELLING A LOT 106 DUNNACHIE ST, MUDGEE (NO.8) MAAS GROUP PROPERTIES





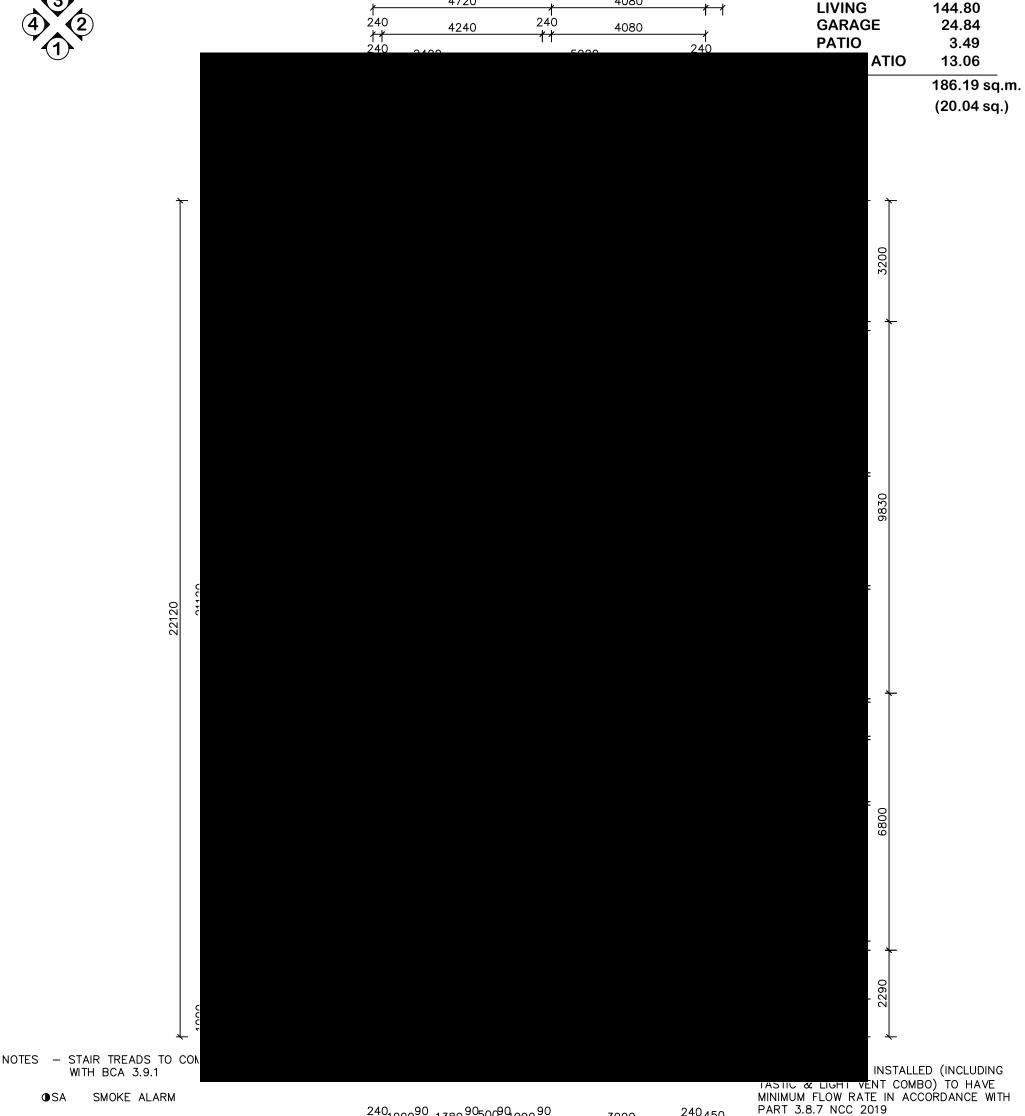

4080

4720

SMOKE ALARM SA

WITH BCA 3.9.1

8 EXHAUST FAN

* NOTE: EXTERNAL LIGHTING ALL EXTERNAL LIGHT FITTINGS ARE TO BE SHIELDED.
I.E. DOES NOT PERMIT LIGHT TO SHINE ABOVE THE HORIZONTAL PLANE.

* ALL DIMENSIONS ARE TO BE CONFIRMED BY THE BUILDER PRIOR TO CONSTRUCTION. DO NOT SCALE FROM DRAWINGS. BUILDING SET OUT & SITE BOUNDARY DETAILS TO BE CONFIRMED BY A REGISTERED SURVEYOR.
ALL WORK TO BE CARRIED OUT TO
RELEVANT STANDARDS AND BUILDING CODES.

240 ₁₀₀	0 ⁹⁰ 1380 ⁹⁰ 50	0090 1090 90	3990	240 ₄₅₀
240	3500	90 1200 90	1800 90	2000 240
240	3500	90 1200 90	3890	240
11	3630	71 11 350 1370	390	0 ,
1		1 1 1 9250		1
1				1

"SHERATON SG"

EXHAUST SYSTEMS (INCLUDING TASTIC & LIGHT VENT COMBO) TO DISCHARGE TO OUTSIDE AIR OR VENTILATED ROOF SPACE AS PER PART 3.8.7 NCC 2019. METHOD CHOSEN IS TO MATCH COMPLIANCE WITH THE RELEVANT BASIX CERTIFICATE.

PLIABLE BUILDING MEMBRANE INSTALLED IN EXTERNAL WALLS TO BE A VAPOR PERMEABLE TYPE, COMPLY WITH AS/NZS 4200.1 AND BE INSTALLED AS PER AS4200.2

EXTERNAL DOORS AND OPENABLE WINDOWS IN CONDITIONED SPACES TO BE SEALED TO RESTRICT AIR INFILTRATION AS PER PART 3.12.3 NCC 2019



DATE:	SCALE:	DRAWN:
15.11.22	1:100 (A3)	WP
SHEET:	JOB No:	ISSUE:


D


21379

3 / 8

DRAWING: FLOOR PLAN - DWELLING B **LOT 106 DUNNACHIE ST, MUDGEE (NO.8) MAAS GROUP PROPERTIES**



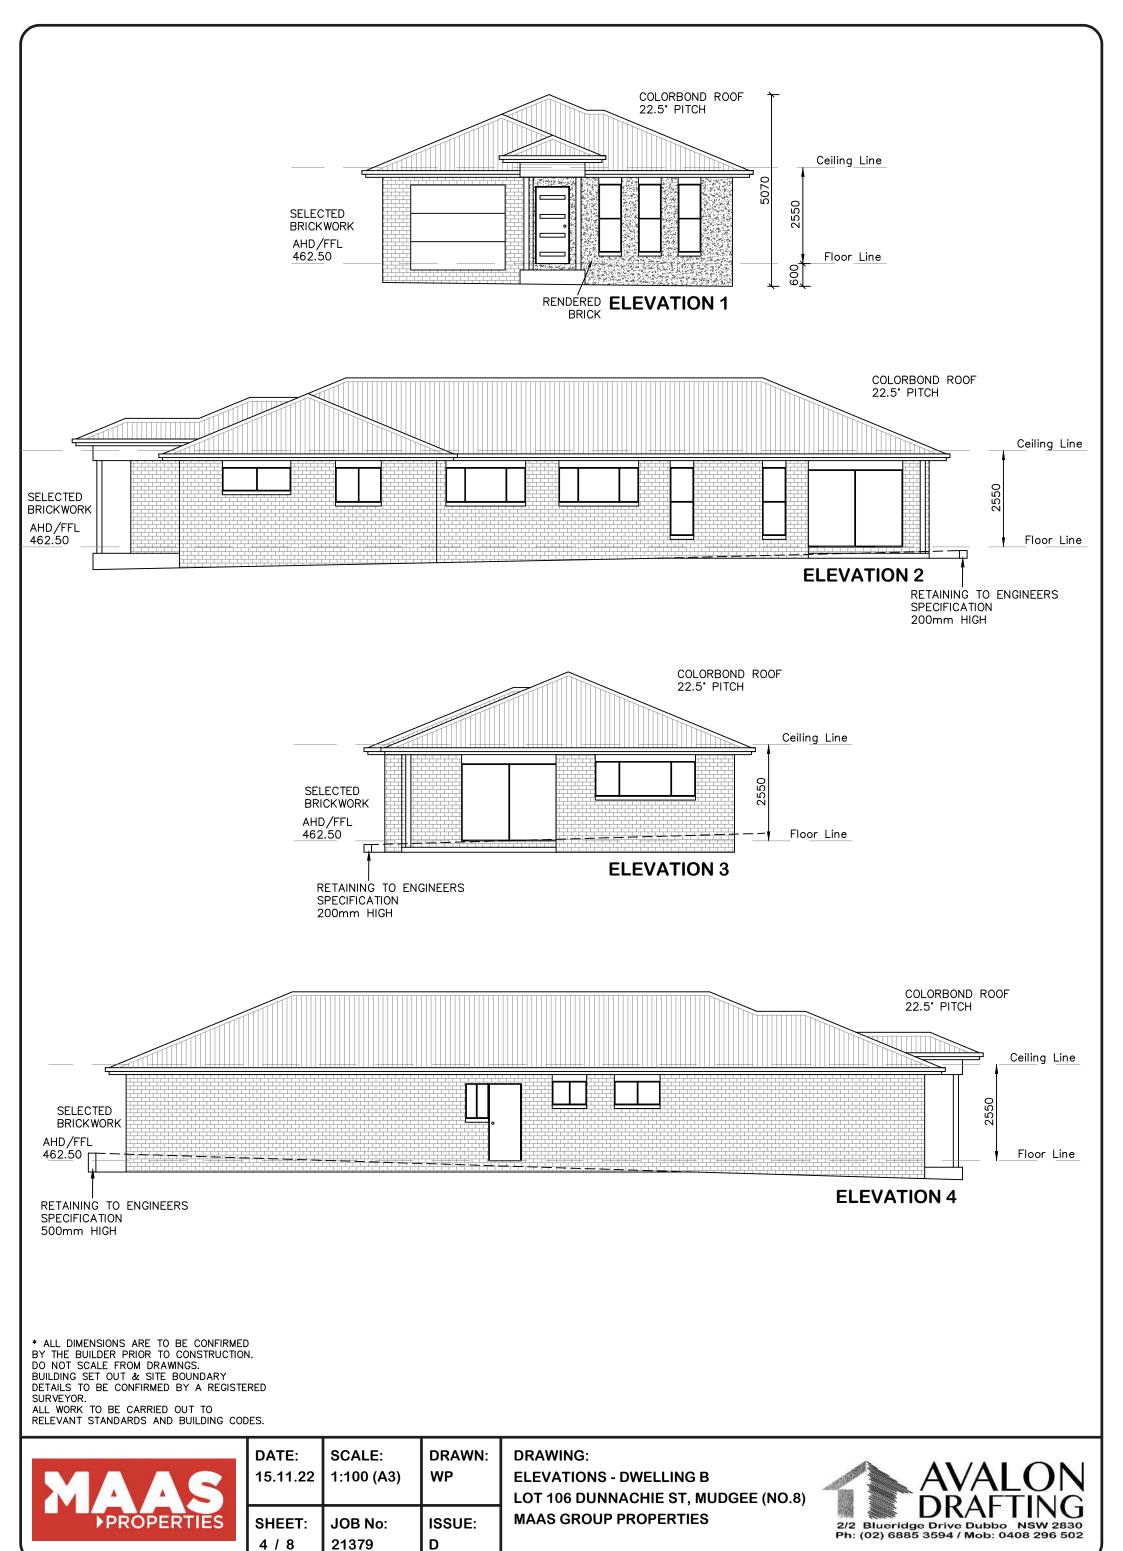

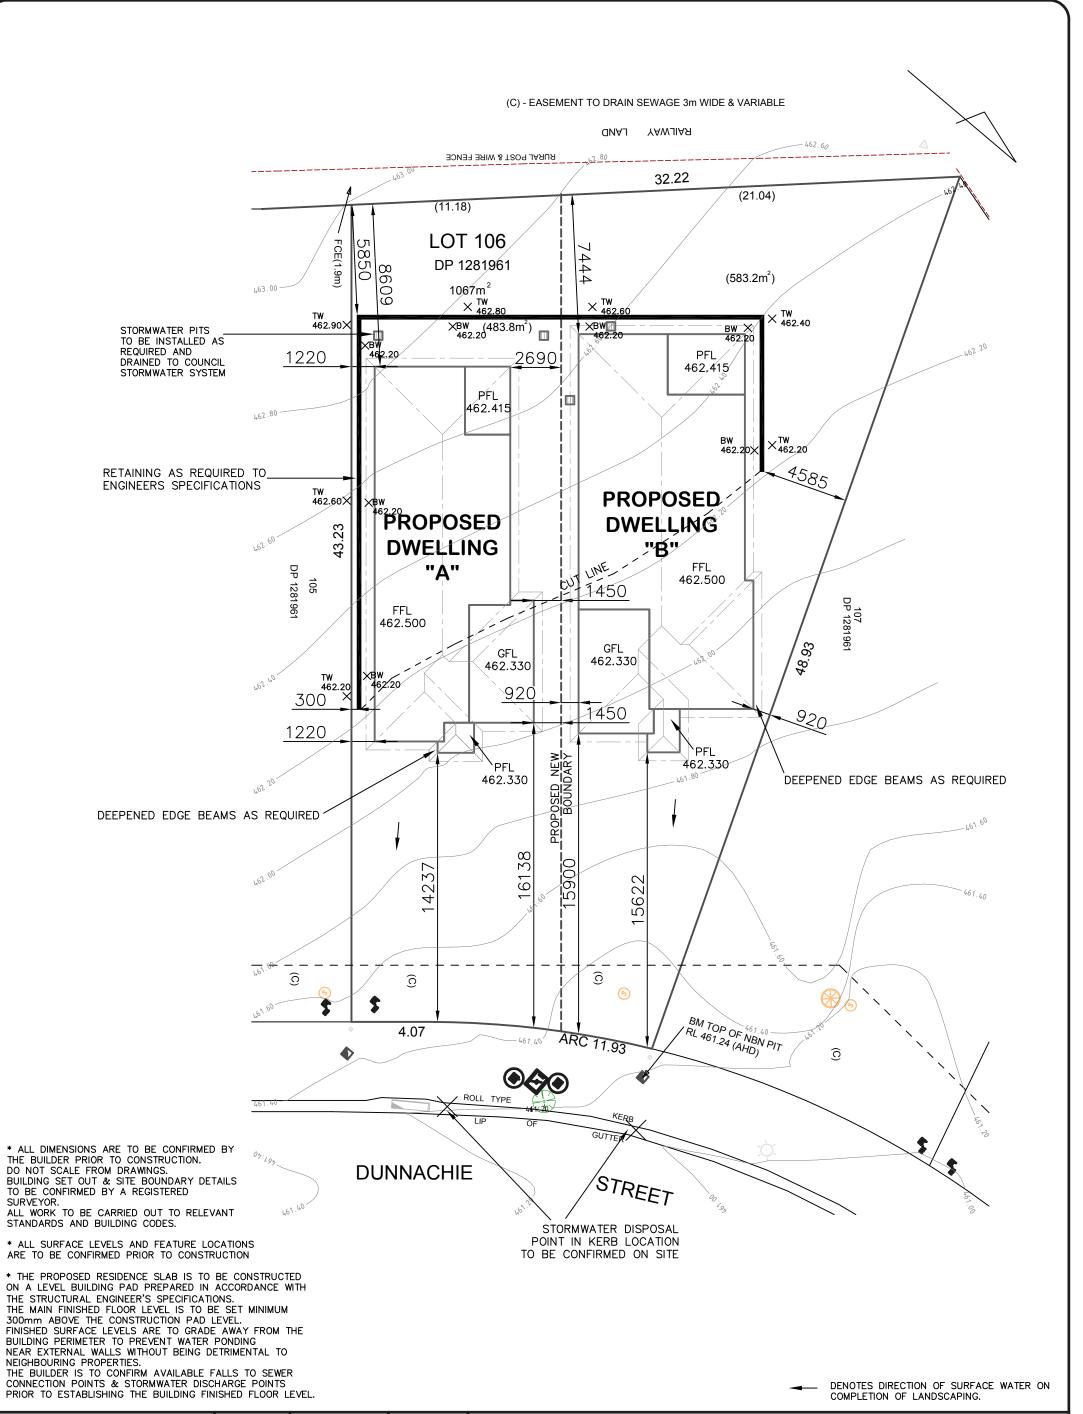


	y—v		
M		A	G
	PR	OPER	TIES

DATE: SCALE: DRAWN: 15.11.22 1:200 (A3) WP

SHEET: JOB No: ISSUE: 5 / 8 21379 D

DRAWING: SITE PLAN LOT 106 DUNNACHIE ST, MUDGEE (NO.8) MAAS GROUP PROPERTIES



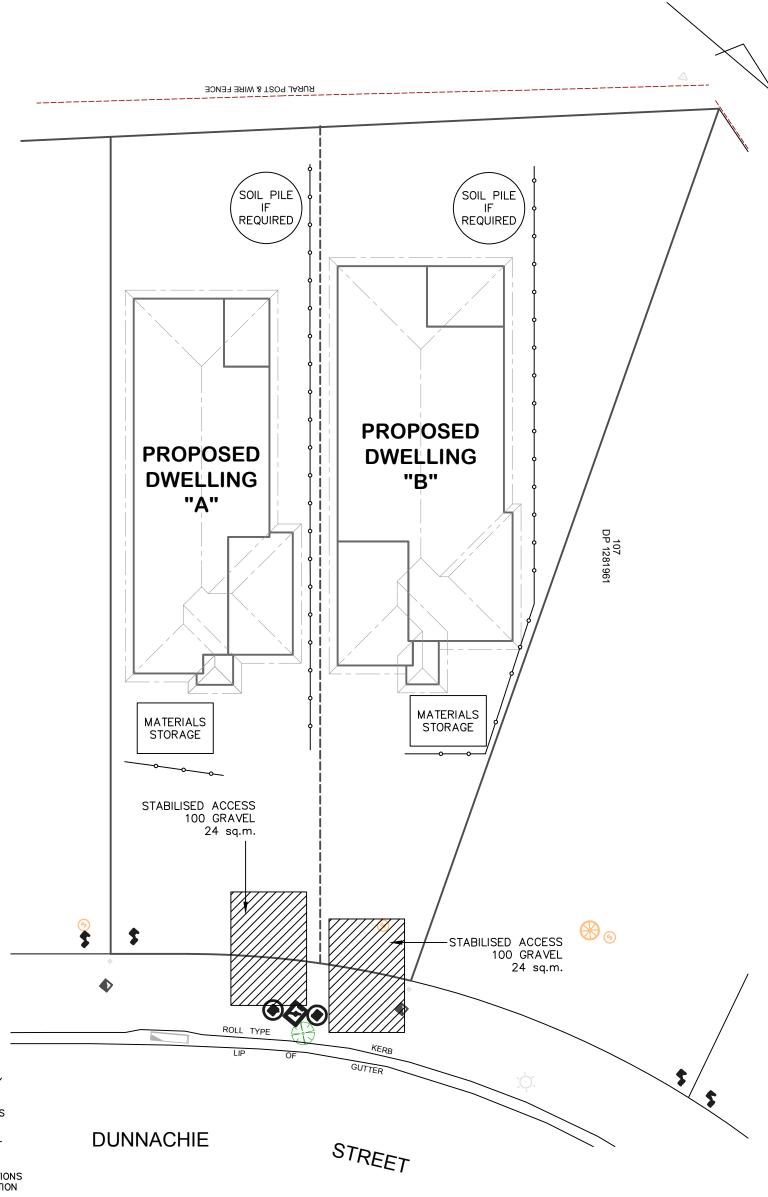

* ALL DIMENSIONS ARE TO BE CONFIRMED BY THE BUILDER PRIOR TO CONSTRUCTION.
DO NOT SCALE FROM DRAWINGS.
BUILDING SET OUT & SITE BOUNDARY DETAILS TO BE CONFIRMED BY A REGISTERED SURVEYOR.
ALL WORK TO BE CARRIED OUT TO RELEVANT STANDARDS AND BUILDING CODES.

* ALL SURFACE LEVELS AND FEATURE LOCATIONS ARE TO BE CONFIRMED PRIOR TO CONSTRUCTION

* THE PROPOSED RESIDENCE SLAB IS TO BE CONSTRUCTED ON A LEVEL BUILDING PAD PREPARED IN ACCORDANCE WITH ON A LEVEL BUILDING PAD PREPARED IN ACCORDANCE WITH THE STRUCTURAL ENGINEER'S SPECIFICATIONS.

THE MAIN FINISHED FLOOR LEVEL IS TO BE SET MINIMUM 300mm ABOVE THE CONSTRUCTION PAD LEVEL.

FINISHED SURFACE LEVELS ARE TO GRADE AWAY FROM THE BUILDING PERIMETER TO PREVENT WATER PONDING NEAR EXTERNAL WALLS WITHOUT BEING DETRIMENTAL TO NEIGHBOURING PROPERTIES.

THE BUILDER IS TO CONFIRM AVAILABLE FALLS TO SEWER CONNECTION POINTS & STORMWATER DISCHARGE POINTS PRIOR TO ESTABLISHING THE BUILDING FINISHED FLOOR LEVEL.

NOTES:

- 1. ALL RUNOFF & SEDIMENT CONTROL STRUCTURES TO BE MAINTAINED IN A FUNCTIONAL CONDITION.
- 2. ALL VEGETATION OUTSIDE THE DWELLING SITE WILL BE RETAINED.


→ SEDIMENT FENCE



DATE: 15.11.22	SCALE: 1:200 (A3)	DRAWN: WP
SHEET:	JOB No:	ISSUE:
6 / 8	21379	D

DRAWING: EROSION & SEDIMENT CONTROL PLAN LOT 106 DUNNACHIE ST, MUDGEE (NO.8) MAAS GROUP PROPERTIES



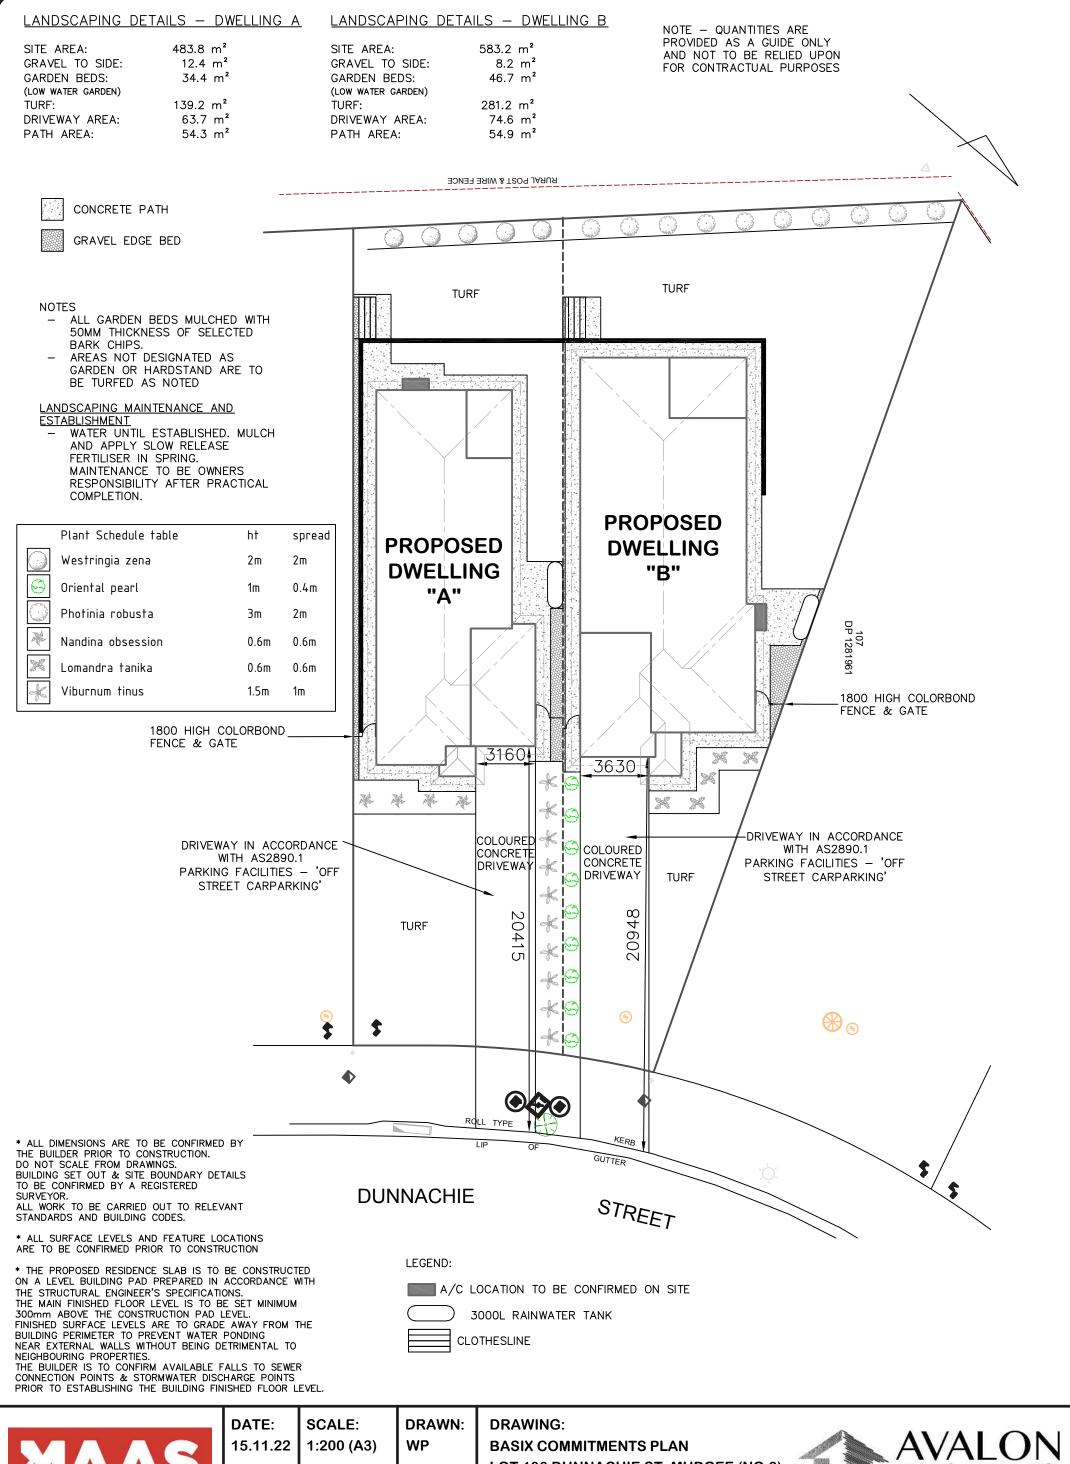



	SCALE: 1:200 (A3)	DRAWN: WP
SHEET:	JOB No:	ISSUE:

D

21379

7 / 8

LOT 106 DUNNACHIE ST, MUDGEE (NO.8) MAAS GROUP PROPERTIES



BASIX COMMITMENTS - DWELLING A WATER COMMITMENTS AREA LOW WATER USE SPECIES OF VEGETATION 34.4 SQ.M. MIN RATING FIXTURES SHOWER HEAD RATING 4 STAR 4 STAR 5 STAR TOILET FLUSHING SYSTEM RATING KITCHEN TAPS 5 STAR BASIN TAPS ALTERNATIVE WATER RAINWATER TANK RAINWATER TANK CAPACITY 3000 LITRE ROOF COLLECTION AREA FOR R/W 100 SQ.M. R/W TANK CONNECTED TO MIN 1 No. OUTDOOR TAP ALL TOILETS IN DWELLING THE COLD WATER TAP THAT SUPPLIES THE CLOTHES WASHER THERMAL COMFORT COMMITMENTS CLASS 1 DWELLING WITH NOT MORE THAN 2 STOREYS
CONDITIONED FLOOR AREA NOT EXCEEDING 300 SQUARE METRES
MUST NOT HAVE OPEN MEZZANINE OF MORE THAN 25 SQUARE METRES
NOT CONTAIN THIRD LEVEL HABITABLE ATTIC ROOM GENERAL REQUIREMENTS -CONCRETE SLAB ON GROUND BRICK VENEER - R2.60 INC CONSTRUCTION GROUND FLOOR CONSTRUCTION INTERNAL WALL SHARED WITH GARAGE FLAT CEILING/PITCHED ROOF - CEILING R4, ROOF - SARKING - UNVENTILATED - DARK (SOLAR ABSORPTANCE > 0.7) THERMAL COMFORT COMMITMENTS - WINDOWS & GLAZED DOORS WINDOW ORIENTATION MAXIMUM TYPE SHADING OVERSHADOWING HEIGHT (mm) WIDTH (mm) W01 NE 1800 1500 ALUMINIUM, SINGLE, CLEAR EAVE 600mm, 180mm ABOVE HEAD OF WINDOW OR GLAZED DOOR NOT Overshadowed FAVE 600mm, 180mm ABOVE HEAD ALUMINIUM, SINGLE, CLEAR W02 SE 600 NOT Overshadowed 900 OF WINDOW OR GLAZED DOOR ALUMINIUM, SINGLE, CLEAR W03 SE 900 600 NOT OVERSHADOWED EAVE 600mm, 180mm ABOVE HEAD OF WINDOW OR GLAZED DOOR W04 ALUMINIUM, SINGLE, CLEAR SE 900 600 NOT OVERSHADOWED EAVE 600mm, 180mm ABOVE HEAD OF WINDOW OR GLAZED DOOR W05 SE 900 600 ALUMINIUM, SINGLE, CLEAR OVERSHADOWED EAVE 600mm, 180mm ABOVE HEAD OF WINDOW OR GLAZED DOOR W06 ALUMINIUM, SINGLE, CLEAR SE 1200 1500 NOT Overshadowed EAVE 600mm, 180mm ABOVE HEAD OF WINDOW OR GLAZED DOOR W07 SW 1800 600 ALUMINIUM, SINGLE, CLEAR NOT Overshadowed W08 SW 1800 600 ALUMINIUM, SINGLE, CLEAR EAVE 600mm, 180mm ABOVE HEAD OF WINDOW OR GLAZED DOOR NOT OVERSHADOWED EAVE 4200mm, 180mm ABOVE HEAD OF WINDOW OR GLAZED DOOR W09 SW 1000 1200 ALUMINIUM, SINGLE, CLEAR not Overshadowed EAVE 3000mm, 240mm ABOVE HEAD OF WINDOW OR GLAZED DOOR 2100 1800 ALUMINIUM, SINGLE, CLEAR NOT OVERSHADOWED W10 NW EAVE 600mm, 180mm ABOVE HEAD OF WINDOW OR GLAZED DOOR W11 ALUMINIUM, SINGLE, CLEAR NW 1800 900 NOT Overshadowed EAVE 600mm, 180mm ABOVE HEAD W12 NW 1200 1500 ALUMINIUM, SINGLE, CLEAR NOT Overshadowed OF WINDOW OR GLAZED DOOR EAVE 600mm, 180mm ABOVE HEAD OF WINDOW OR GLAZED DOOR ALUMINIUM, SINGLE, CLEAR NOT Overshadowed W13 NW 1200 1500 ENERGY COMMITMENTS HOT WATER SYSTEM GAS INSTANTANEOUS - 5 STAR COOLING SYSTEM
HEATING SYSTEM REVERSE CYCLE: EER 3.0-3.5 WITH DAY/NIGHT ZONING BETWEEN LIVING/BED AREAS REVERSE CYCLE: EER 3.0-3.5 WITH DAY/NIGHT ZONING BETWEEN LIVING/BED AREAS VENTILATION extract fan ducted to roof or facade — manual on/off extract fan ducted to roof or facade — manual on/off natural ventilation only KITCHEN LAUNDRY ARTIFICIAL LIGHTING PRIMARY TYPE OF ARTIFICIAL LIGHTING IS FLUORESCENT OR LIGHT EMITTING DIODE (LED) PRIMARY TYPE OF ARTIFICIAL LIGHTING IS FLUORESCENT OR LIGHT EMITTING DIODE (LED) PRIMARY TYPE OF ARTIFICIAL LIGHTING IS FLUORESCENT OR LIGHT EMITTING DIODE (LED) PRIMARY TYPE OF ARTIFICIAL LIGHTING IS FLUORESCENT OR LIGHT EMITTING DIODE (LED) PRIMARY TYPE OF ARTIFICIAL LIGHTING IS FLUORESCENT OR LIGHT EMITTING DIODE (LED) PRIMARY TYPE OF ARTIFICIAL LIGHTING IS FLUORESCENT OR LIGHT EMITTING DIODE (LED) KITCHEN BATHROOMS/TOILETS LAUNDRY LIVING AREAS

These are the specifications upon which the Basix assessment is based. These specifications take precedence over the drawings or other specifications

PRIMARY TYPE OF ARTIFICIAL LIGHTING IS FLUORESCENT OR LIGHT EMITTING DIODE (LED) X 3


WATER COMMITMENTS LANDSCAPE AREA LOW WATER USE SPECIES OF VEGETATION 46.7 SQ.M. MIN RATING FIXTURES SHOWER HEAD RATING 4 STAR 4 STAR TOILET FLUSHING SYSTEM RATING KITCHEN TAPS 5 STAR BASIN TAPS 5 STAR ALTERNATIVE WATER
RAINWATER TANK
RAINWATER TANK CAPACITY 3000 LITRE ROOF COLLECTION AREA FOR R/W 100 SQ.M. R/W TANK CONNECTED TO MIN 1 No. OUTDOOR TAP ALL TOILETS IN DWELLING THE COLD WATER TAP THAT SUPPLIES THE CLOTHES WASHER THERMAL COMFORT COMMITMENTS CLASS 1 DWELLING WITH NOT MORE THAN 2 STOREYS
CONDITIONED FLOOR AREA NOT EXCEEDING 300 SQUARE METRES
MUST NOT HAVE OPEN MEZZANINE OF MORE THAN 25 SQUARE METRES
NOT CONTAIN THIRD LEVEL HABITABLE ATTIC ROOM GENERAL REQUIREMENTS -CONCRETE SLAB ON GROUND BRICK VENEER - R2.60 INC CONSTRUCTION GROUND FLOOR CONSTRUCTION EXTERNAL WALL
INTERNAL WALL SHARED WITH GARAGE CEILING AND ROOF FLAT CEILING/PITCHED ROOF - CEILING R4, ROOF - SARKING - UNVENTILATED - DARK (SOLAR ABSORPTANCE > 0.7) THERMAL COMFORT COMMITMENTS - WINDOWS & GLAZED DOORS WINDOW ORIENTATION MAXIMUM SHADING OVERSHADOWING TYPE HEIGHT (mm) WIDTH (mm) W01 NE 1800 ALUMINIUM, SINGLE, CLEAR EAVE 600mm, 180mm ABOVE HEAD OF WINDOW OR GLAZED DOOR NOT OVERSHADOWED ALUMINIUM, SINGLE, CLEAR EAVE 600mm, 180mm ABOVE HEAD OF WINDOW OR GLAZED DOOR W02 NE 1800 600 NOT OVERSHADOWED ALUMINIUM, SINGLE, CLEAR W03 NE 1800 600 NOT OVERSHADOWED EAVE 600mm, 180mm ABOVE HEAD OF WINDOW OR GLAZED DOOR ALUMINIUM, SINGLE, CLEAR NOT OVERSHADOWED W04 SE 600 1200 EAVE 600mm, 180mm ABOVE HEAD OF WINDOW OR GLAZED DOOR W05 SE 600 ALUMINIUM, SINGLE, CLEAR 900 NOT Overshadowed EAVE 600mm, 240mm ABOVE HEAD OF WINDOW OR GLAZED DOOR W06 NOT OVERSHADOWED SE 900 600 ALUMINIUM, SINGLE, CLEAR EAVE 600mm, 180mm ABOVE HEAD OF WINDOW OR GLAZED DOOR W07 SW 900 2700 ALUMINIUM, SINGLE, CLEAR NOT OVERSHADOWED W08 SW 2100 2600 ALUMINIUM, SINGLE, CLEAR EAVE 3800mm, 240mm ABOVE HEAD OF WINDOW OR GLAZED DOOR NOT OVERSHADOWED EAVE 4680mm, 240mm ABOVE HEAD OF WINDOW OR GLAZED DOOR W09 NW 2100 2600 ALUMINIUM, SINGLE, CLEAR NOT OVERSHADOWED EAVE 600mm, 180mm ABOVE HEAD OF WINDOW OR GLAZED DOOR 1800 600 ALUMINIUM, SINGLE, CLEAR NOT OVERSHADOWED W10 NW EAVE 600mm, 180mm ABOVE HEAD OF WINDOW OR GLAZED DOOR W11 ALUMINIUM, SINGLE, CLEAR NOT OVERSHADOWED 1800 600 EAVE 600mm, 180mm ABOVE HEAD OF WINDOW OR GLAZED DOOR W12 NW 900 2100 ALUMINIUM, SINGLE, CLEAR NOT OVERSHADOWED EAVE 600mm, 180mm ABOVE HEAD OF WINDOW OR GLAZED DOOR W13 NW 900 2100 ALUMINIUM, SINGLE, CLEAR OVERSHADOWED EAVE 600mm, 180mm ABOVE HEAD OF WINDOW OR GLAZED DOOR W14 NW 900 1200 ALUMINIUM, SINGLE, CLEAR NOT OVERSHADOWED W15 NW 600 1800 ALUMINIUM, SINGLE, CLEAR EAVE 600mm, 180mm ABOVE HEAD OF WINDOW OR GLAZED DOOR NOT OVERSHADOWED **ENERGY COMMITMENTS** HOT WATER SYSTEM COOLING SYSTEM HEATING SYSTEM GAS INSTANTANEOUS - 5 STAR REVERSE CYCLE: EER 3.5—4.0 WITH DAY/NIGHT ZONING BETWEEN LIVING/BED AREAS REVERSE CYCLE: EER 3.5—4.0 WITH DAY/NIGHT ZONING BETWEEN LIVING/BED AREAS VENTILATION BATHROOM KITCHEN EXTRACT FAN DUCTED TO ROOF OR FACADE — MANUAL ON/OFF EXTRACT FAN DUCTED TO ROOF OR FACADE — MANUAL ON/OFF NATURAL VENTILATION ONLY LAUNDRY ARTIFICIAL LIGHTING KITCHEN PRIMARY TYPE OF ARTIFICIAL LIGHTING IS FLUORESCENT OR LIGHT EMITTING DIODE (LED) PRIMARY TYPE OF ARTIFICIAL LIGHTING IS FLUORESCENT OR LIGHT EMITTING DIODE (LED) BATHROOMS/TOILETS LAUNDRY HALLWAYS LIVING AREAS PRIMARY TYPE OF ARTIFICIAL LIGHTING IS FLUORESCENT OR LIGHT EMITTING DIODE (LED)
PRIMARY TYPE OF ARTIFICIAL LIGHTING IS FLUORESCENT OR LIGHT EMITTING DIODE (LED)
PRIMARY TYPE OF ARTIFICIAL LIGHTING IS FLUORESCENT OR LIGHT EMITTING DIODE (LED) X 2
PRIMARY TYPE OF ARTIFICIAL LIGHTING IS FLUORESCENT OR LIGHT EMITTING DIODE (LED) X 3 BEDROOMS NATURAL LIGHTING KITCHEN BATHROOMS/TOILETS WINDOW x 3 <u>APPLIANCES</u> KITCHEN

BASIX COMMITMENTS - DWELLING B

These are the specifications upon which the Basix assessment is based. These specifications take precedence over the drawings or other specifications.

WELL VENTILATED AS BASIX DEFINITION

OUTDOOR CLOTHES DRYING LINE

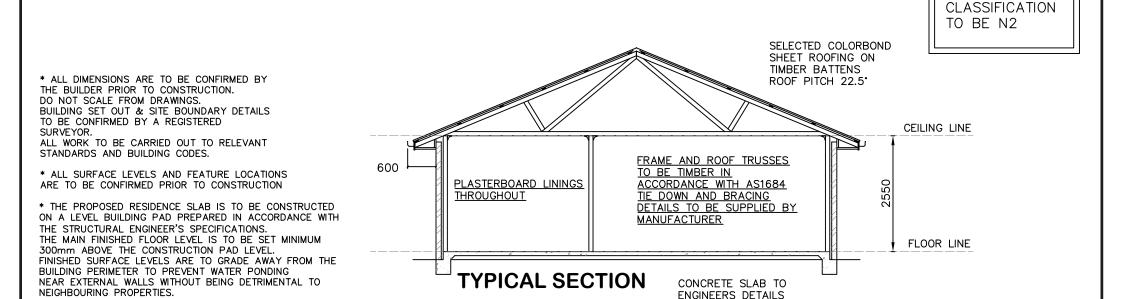

NOT TO SCALE

RFFRIGFRATOR SPACE

CLOTHES DRYING

M	A	A	3
	PRO	PER	TIES

THE BUILDER IS TO CONFIRM AVAILABLE FALLS TO SEWER

CONNECTION POINTS & STORMWATER DISCHARGE POINTS PRIOR TO ESTABLISHING THE BUILDING FINISHED FLOOR LEVEL.

BEDROOMS

<u>APPLIANCES</u>

NATURAL LIGHTING

BATHROOMS/TOILETS

KITCHEN REFRIGERATOR SPACE

WINDOW WINDOW x 3

WELL VENTILATED AS BASIX DEFINITION

DATE:	SCALE:	DRAWN:
15.11.22	N / A	WP
SHEET:	JOB No:	ISSUE:

D

21379

8 / 8

DRAWING: BASIX COMMITMENTS & TYP SECTION LOT 106 DUNNACHIE ST, MUDGEE (NO.8) MAAS GROUP PROPERTIES

ENGINEERS DETAILS



* NOTE - WIND