

LIVING GARAGE PATIO

TIO

116.70 21.60 2.72

8.64

149.66 sq.m. (16.11 sq.)

NOTES - STAIR TREADS WITH BCA 3.9.1..

SMOKE ALA

8 EXHAUST F

* NOTE: EXTERNAL LIGHTING ALL EXTERNAL LIGHT FITTINGS ARE TO BE SHIELDED.
I.E. DOES NOT PERMIT LIGHT TO SHINE
ABOVE THE HORIZONTAL PLANE.

* ALL DIMENSIONS ARE TO BE CONFIRMED BY THE BUILDER PRIOR TO CONSTRUCTION. DO NOT SCALE FROM DRAWINGS.
BUILDING SET OUT & SITE BOUNDARY DETAILS TO BE CONFIRMED BY A REGISTERED SURVEYOR.
ALL WORK TO BE CARRIED OUT TO RELEVANT STANDARDS AND BUILDING CODES.

1 / 8

"MACQUARIE"

DRAWING: FLOOR PLAN - DWELLING A **LOT 90 THE LOGAN, MUDGEE MAAS GROUP PROPERTIES**



ALLED (INCLUDING OMBO) TO HAVE ACCORDANCE

UDING TASTIC &

DISCHARGE TO TED ROOF

B.7 NCC 2019.

019

MATCH WITH THE RELEVANT BASIX

PLIABLE BUILDING MEMBRANE INSTALLED

EXTERNAL DOORS AND OPENABLE WINDOWS IN CONDITIONED SPACES TO BE SEALED TO RESTRICT AIR INFILTRATION

AS PER PART 3.12.3 NCC 2019

IN EXTERNAL WALLS TO BE A VAPOR PERMEABLE TYPE, COMPLY WITH AS/NZS 4200.1 AND BE INSTALLED AS PER

CERTIFICATE.

AS4200.2

DRAWN: DATE: SCALE: 13.07.22 1:100 (A3) NT

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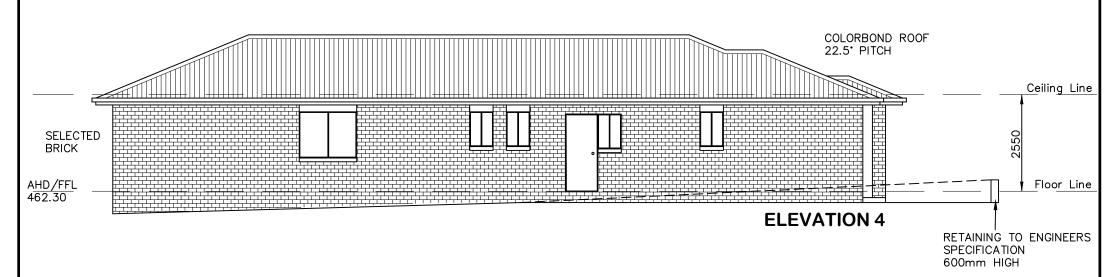
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* ALL DIMENSIONS ARE TO BE CONFIRMED BY THE BUILDER PRIOR TO CONSTRUCTION. DO NOT SCALE FROM DRAWINGS.
BUILDING SET OUT & SITE BOUNDARY DETAILS TO BE CONFIRMED BY A REGISTERED SURVEYOR.
ALL WORK TO BE CARRIED OUT TO RELEVANT STANDARDS AND BUILDING CODES.

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DRAWING: ELEVATIONS - DWELLING A LOT 90 THE LOGAN, MUDGEE MAAS GROUP PROPERTIES



LIVING GARAGE 3500 4170 PATIO **EAR PATIO**

20.81 1.94 11.55

140.78

175.08 sq.m. (18.85 sq.)

NOTES - STAIR TREADS T WITH BCA 3.9.1.3

●SA SMOKE ALAF

8 EXHAUST FAN

* NOTE: EXTERNAL LIGHTING ALL EXTERNAL LIGHT FITTINGS ARE TO BE SHIELDED. I.E. DOES NOT PERMIT LIGHT TO SHINE ABOVE THE HORIZONTAL PLANE.

* ALL DIMENSIONS ARE TO BE CONFIRMED BY THE BUILDER PRIOR TO CONSTRUCTION.
DO NOT SCALE FROM DRAWINGS.
BUILDING SET OUT & SITE BOUNDARY DETAILS TO BE CONFIRMED BY A REGISTERED SURVEYOR.
ALL WORK TO BE CARRIED OUT TO RELEVANT STANDARDS AND BUILDING CODES. STANDARDS AND BUILDING CODES.

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k			7670		
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"TALBRAGAR"

DATE: SCALE: **DRAWN: DRAWING:** 13.07.22 1:100 (A3) NT FLOOR PLAN - DWELLING B **LOT 90 THE LOGAN, MUDGEE**



HAUST SYSTEMS INSTALLED (INCLUDING STIC & LIGHT VENT COMBO) TO HAVE NIMUM FLOW RATE IN ACCORDANCE

CHAUST SYSTEMS (INCLUDING TASTIC &

LIGHT VENT COMBO) TO DISCHARGE TO OUTSIDE AIR OR VENTILATED ROOF SPACE AS PER PART 3.8.7 NCC 2019.

COMPLIANCE WITH THE RELEVANT BASIX

PLIABLE BUILDING MEMBRANE INSTALLED

PERMEABLE TYPE, COMPLY WITH AS/NZS

WINDOWS IN CONDITIONED SPACES TO BE SEALED TO RESTRICT AIR INFILTRATION

IN EXTERNAL WALLS TO BE A VAPOR

4200.1 AND BE INSTALLED AS PER

EXTERNAL DOORS AND OPENABLE

AS PER PART 3.12.3 NCC 2019


TH PART 3.8.7 NCC 2019

METHOD CHOSEN IS TO MATCH

CERTIFICATE.

AS4200.2

MAAS GROUP PROPERTIES 2/2 Blueridge Drive Dubbo NSW 2830 Ph: (02) 6885 3594 / Mob: 0408 296 502 SHEET: JOB No: ISSUE: 3 / 8 21363 C

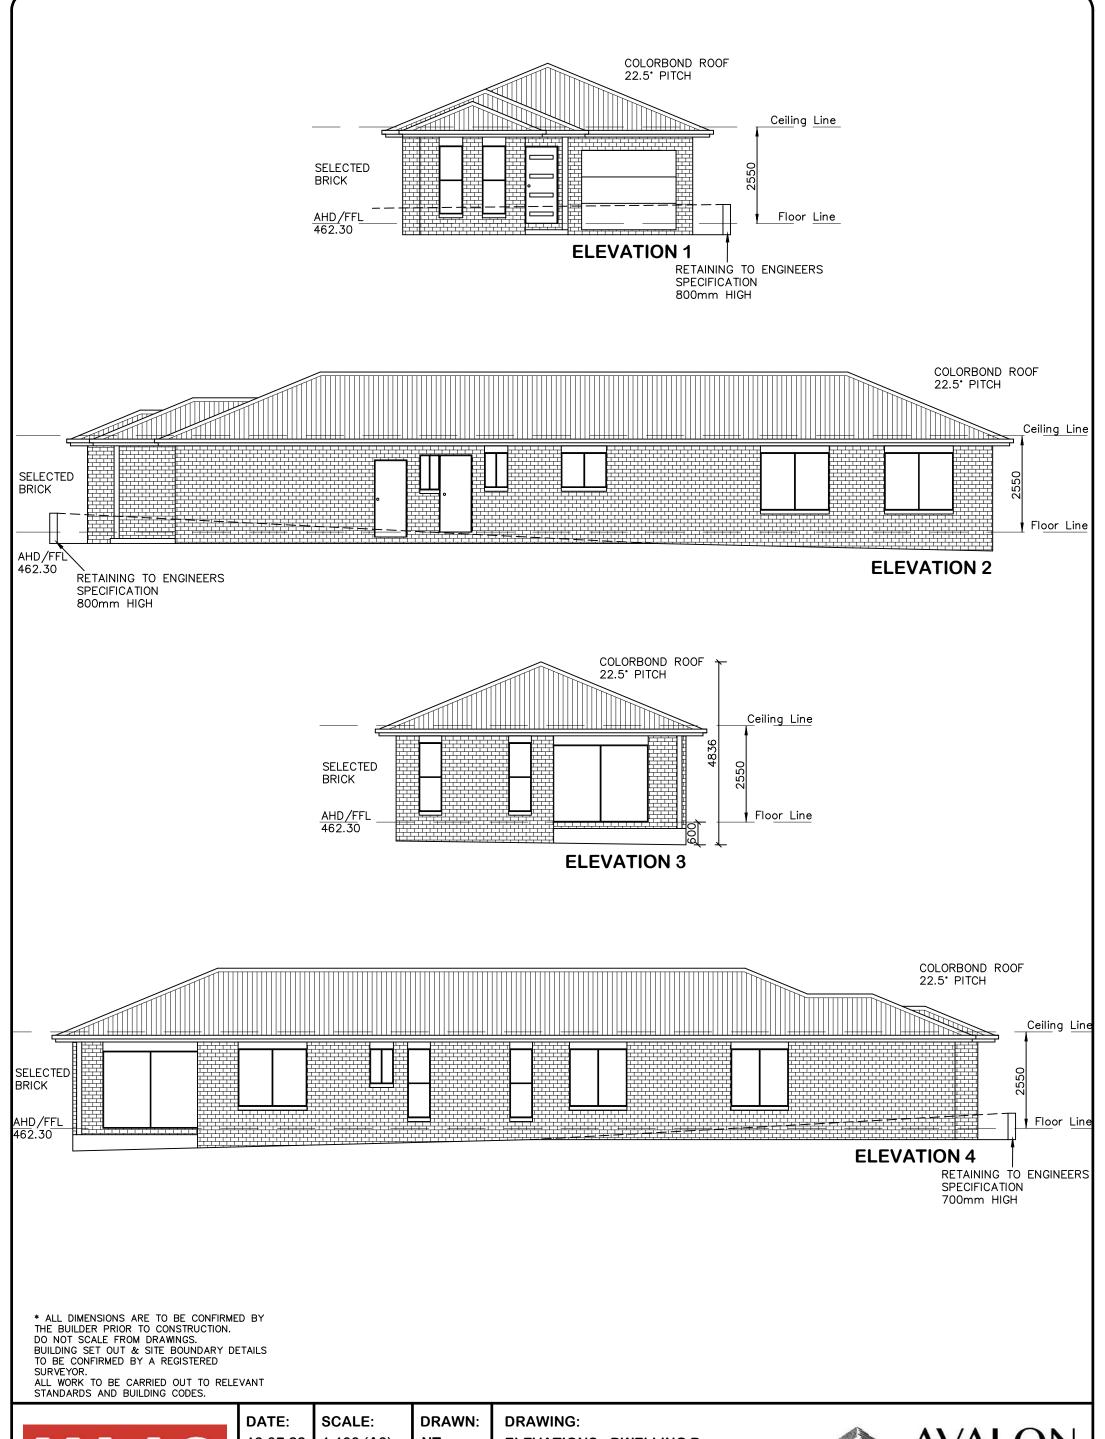

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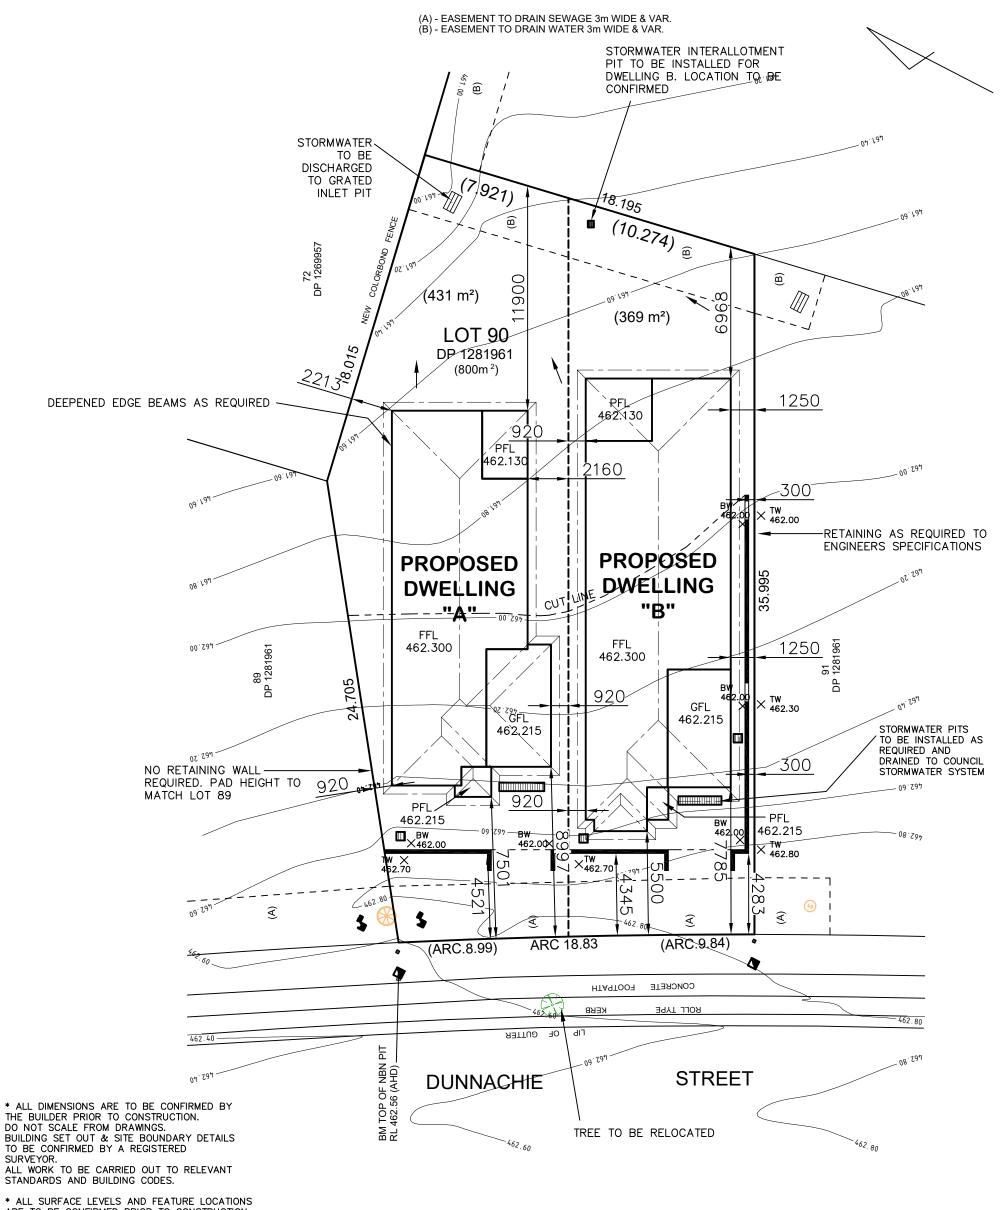
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ELEVATIONS - DWELLING B LOT 90 THE LOGAN, MUDGEE MAAS GROUP PROPERTIES





ARE TO BE CONFIRMED PRIOR TO CONSTRUCTION

* THE PROPOSED RESIDENCE SLAB IS TO BE CONSTRUCTED ON A LEVEL BUILDING PAD PREPARED IN ACCORDANCE WITH THE STRUCTURAL ENGINEER'S SPECIFICATIONS.
THE MAIN FINISHED FLOOR LEVEL IS TO BE SET MINIMUM 300mm ABOVE THE CONSTRUCTION PAD LEVEL. JOOMM ABOVE THE CONSTRUCTION PAD LEVEL.
FINISHED SURFACE LEVELS ARE TO GRADE AWAY FROM THE
BUILDING PERIMETER TO PREVENT WATER PONDING
NEAR EXTERNAL WALLS WITHOUT BEING DETRIMENTAL TO
NEIGHBOURING PROPERTIES.
THE BUILDER IS TO CONFIRM AVAILABLE FALLS TO SEWER
CONNECTION POINTS & STORMWATER DISCHARGE POINTS
PRIOR TO ESTABLISHING THE BUILDING FINISHED FLOOR LEVEL.


DENOTES DIRECTION OF SURFACE WATER ON COMPLETION OF LANDSCAPING.



DATE: 13.07.22	SCALE: 1:200 (A3)	DRAWN: NT
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DRAWING: SITE PLAN **LOT 90 THE LOGAN, MUDGEE MAAS GROUP PROPERTIES**



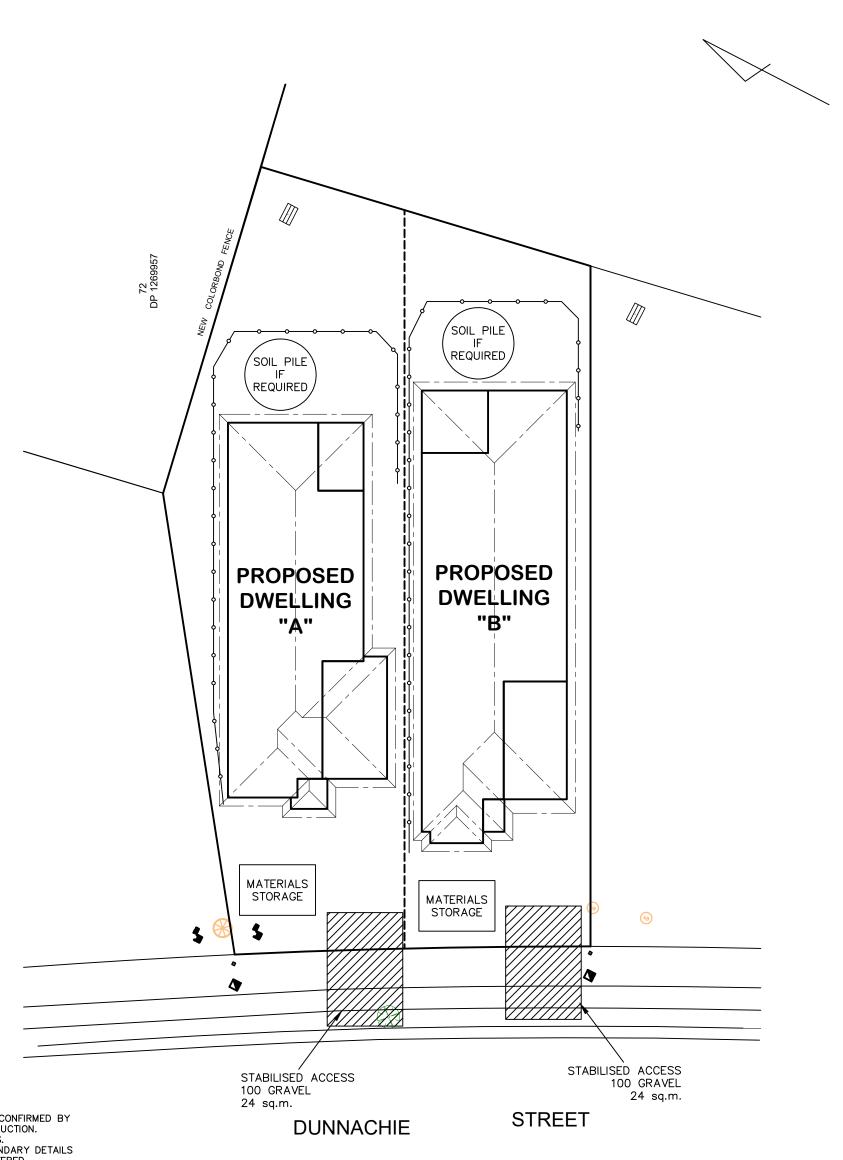

* ALL DIMENSIONS ARE TO BE CONFIRMED BY THE BUILDER PRIOR TO CONSTRUCTION.
DO NOT SCALE FROM DRAWINGS.
BUILDING SET OUT & SITE BOUNDARY DETAILS TO BE CONFIRMED BY A REGISTERED SURVEYOR. ALL WORK TO BE CARRIED OUT TO RELEVANT

STANDARDS AND BUILDING CODES.

* ALL SURFACE LEVELS AND FEATURE LOCATIONS ARE TO BE CONFIRMED PRIOR TO CONSTRUCTION

* THE PROPOSED RESIDENCE SLAB IS TO BE CONSTRUCTED ON A LEVEL BUILDING PAD PREPARED IN ACCORDANCE WITH ON A LEVEL BUILDING PAD PREPARED IN ACCORDANCE WITH THE STRUCTURAL ENGINEER'S SPECIFICATIONS.

THE MAIN FINISHED FLOOR LEVEL IS TO BE SET MINIMUM 300mm ABOVE THE CONSTRUCTION PAD LEVEL.

FINISHED SURFACE LEVELS ARE TO GRADE AWAY FROM THE BUILDING PERIMETER TO PREVENT WATER PONDING NEAR EXTERNAL WALLS WITHOUT BEING DETRIMENTAL TO NEIGHBOURING PROPERTIES.

THE BUILDER IS TO CONFIRM AVAILABLE FALLS TO SEWER CONNECTION POINTS & STORMWATER DISCHARGE POINTS PRIOR TO ESTABLISHING THE BUILDING FINISHED FLOOR LEVEL.

NOTES:

- 1. ALL RUNOFF & SEDIMENT CONTROL STRUCTURES TO BE MAINTAINED IN A FUNCTIONAL CONDITION.
- 2. ALL VEGETATION OUTSIDE THE DWELLING SITE WILL BE RETAINED.


→ SEDIMENT FENCE

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DRAWING: EROSION & SEDIMENT CONTROL PLAN LOT 90 THE LOGAN, MUDGEE MAAS GROUP PROPERTIES





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DRAWING:
BASIX COMMITMENTS PLAN
LOT 90 THE LOGAN, MUDGEE
MAAS GROUP PROPERTIES

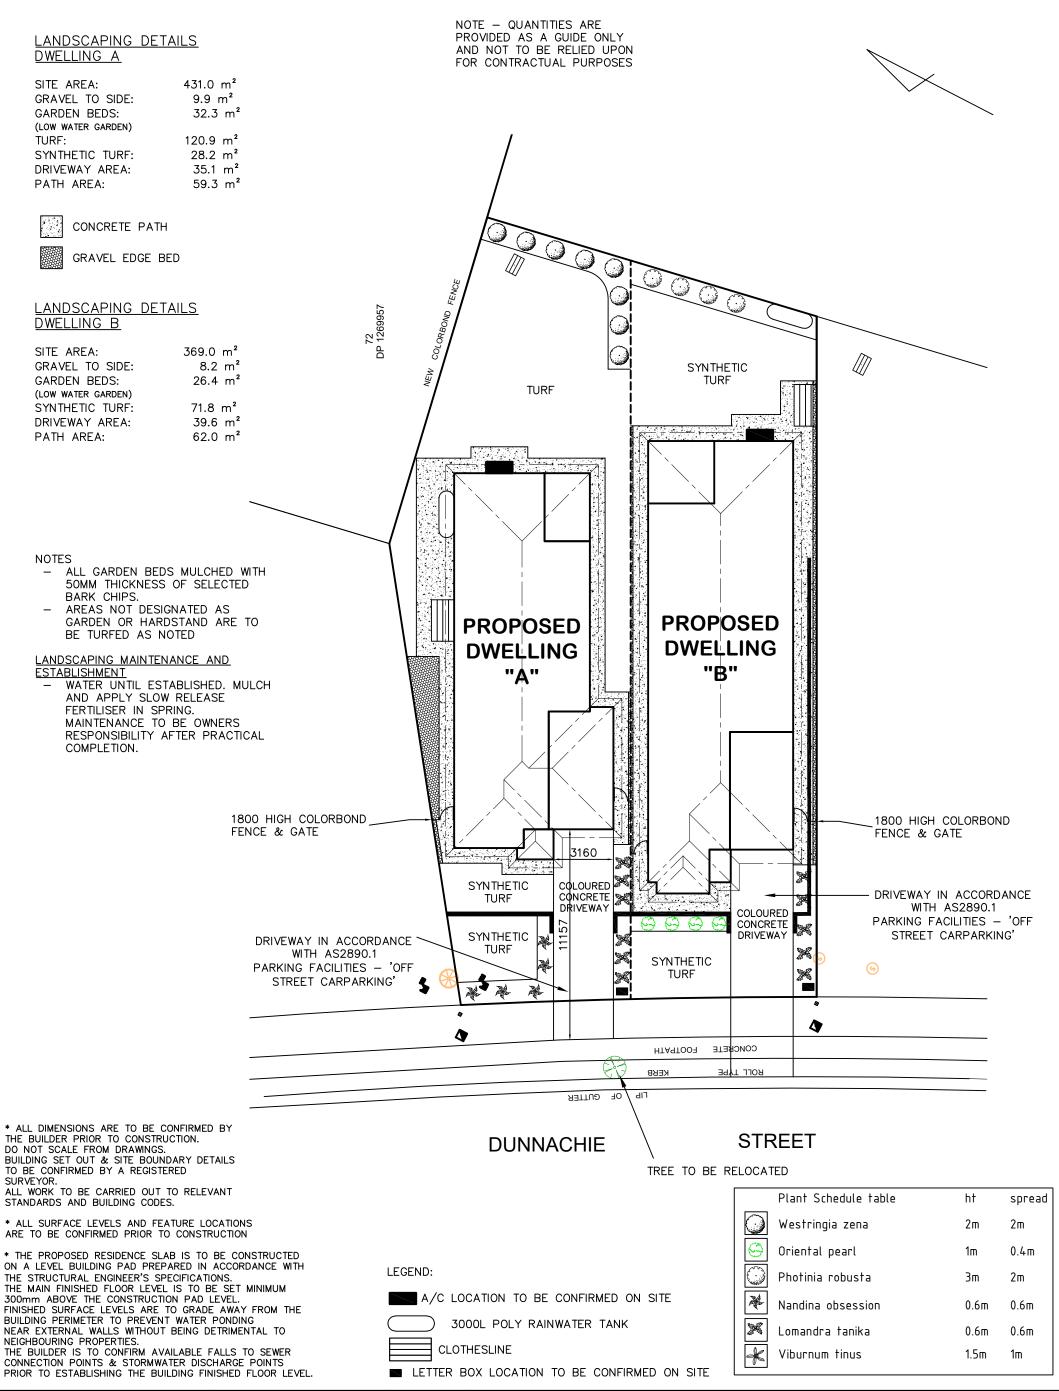

BASIX COMMITMENTS - DWELLING A WATER COMMITMENTS <u>Landscape</u> Area low water use species of vegetation 32.3 SQ.M. MIN RATING FIXTURES SHOWER HEAD RATING 4 STAR 4 STAR 5 STAR TOILET FLUSHING SYSTEM RATING KITCHEN TAPS 5 STAR BASIN TAPS ALTERNATIVE WATER RAINWATER TANK
RAINWATER TANK CAPACITY
ROOF COLLECTION AREA FOR R/W 3000 LITRE 100 SQ.M. R/W TANK CONNECTED TO MIN 1 No. OUTDOOR TAP ALL TOILETS IN DWELLING THE COLD WATER TAP THAT SUPPLIES THE CLOTHES WASHER THERMAL COMFORT COMMITMENTS CLASS 1 DWELLING WITH NOT MORE THAN 2 STOREYS
CONDITIONED FLOOR AREA NOT EXCEEDING 300 SQUARE METRES
MUST NOT HAVE OPEN MEZZANINE OF MORE THAN 25 SQUARE METRES
NOT CONTAIN THIRD LEVEL HABITABLE ATTIC ROOM GENERAL REQUIREMENTS -CONCRETE SLAB ON GROUND BRICK VENEER - R2.60 INC CONSTRUCTION GROUND FLOOR CONSTRUCTION INTERNAL WALL SHARED WITH GARAGE CEILING AND ROOF FLAT CEILING/PITCHED ROOF - CEILING R4, ROOF - SARKING - UNVENTILATED - DARK (SOLAR ABSORPTANCE > 0.7) THERMAL COMFORT COMMITMENTS - WINDOWS & GLAZED DOORS WINDOW ORIENTATION MAXIMUM TYPE SHADING OVERSHADOWING HEIGHT (mm) WIDTH (mm) EAVE 600mm, 180mm ABOVE HEAD OF WINDOW OR GLAZED DOOR ALUMINIUM, SINGLE, CLEAR W01 900 600 NOT Overshadowed ALUMINIUM, SINGLE, CLEAR EAVE 600mm, 240mm ABOVE HEAD W02 900 600 N NOT OVERSHADOWED OF WINDOW OR GLAZED DOOR ALUMINIUM, SINGLE, CLEAR W03 900 600 NOT OVERSHADOWED N EAVE 600mm, 180mm ABOVE HEAD OF WINDOW OR GLAZED DOOR W04 ALUMINIUM, SINGLE, CLEAR 900 600 NOT OVERSHADOWED W05 1200 1500 ALUMINIUM, SINGLE, CLEAR EAVE 600mm, 180mm ABOVE HEAD OF WINDOW OR GLAZED DOOR N OVERSHADOWED EAVE 600mm, 180mm ABOVE HEAD OF WINDOW OR GLAZED DOOR W06 ALUMINIUM, SINGLE, CLEAR Ε 1800 600 NOT Overshadowed EAVE 600mm, 180mm ABOVE HEAD OF WINDOW OR GLAZED DOOR W07 Ε 1800 600 ALUMINIUM, SINGLE, CLEAR NOT Overshadowed ALUMINIUM, SINGLE, CLEAR EAVE 4200mm, 180mm ABOVE HEAD OF WINDOW OR GLAZED DOOR W08 Ε 1000 1200 NOT OVERSHADOWED EAVE 3000mm, 240mm ABOVE HEAD OF WINDOW OR GLAZED DOOR W09 S 2100 1800 ALUMINIUM, SINGLE, CLEAR not Overshadowed ALUMINIUM, SINGLE, CLEAR EAVE 600mm, 180mm ABOVE HEAD OF WINDOW OR GLAZED DOOR 1800 900 NOT OVERSHADOWED W10 S EAVE 600mm, 180mm ABOVE HEAD OF WINDOW OR GLAZED DOOR W11 ALUMINIUM, SINGLE, CLEAR 1200 1500 NOT OVERSHADOWED EAVE 600mm, 180mm ABOVE HEAD W12 S 1200 1500 ALUMINIUM, SINGLE, CLEAR NOT OVERSHADOWED OF WINDOW OR GLAZED DOOR EAVE 600mm, 180mm ABOVE HEAD OF WINDOW OR GLAZED DOOR ALUMINIUM, SINGLE, CLEAR NOT Overshadowed W13 1800 1500 ENERGY COMMITMENTS HOT WATER SYSTEM GAS INSTANTANEOUS - 5 STAR COOLING SYSTEM
HEATING SYSTEM REVERSE CYCLE: EER 3.0-3.5 WITH DAY/NIGHT ZONING BETWEEN LIVING/BED AREAS REVERSE CYCLE: EER 3.0-3.5 WITH DAY/NIGHT ZONING BETWEEN LIVING/BED AREAS VENTILATION extract fan ducted to roof or facade — manual on/off extract fan ducted to roof or facade — manual on/off natural ventilation only KITCHEN LAUNDRY ARTIFICIAL LIGHTING PRIMARY TYPE OF ARTIFICIAL LIGHTING IS FLUORESCENT OR LIGHT EMITTING DIODE (LED) PRIMARY TYPE OF ARTIFICIAL LIGHTING IS FLUORESCENT OR LIGHT EMITTING DIODE (LED) PRIMARY TYPE OF ARTIFICIAL LIGHTING IS FLUORESCENT OR LIGHT EMITTING DIODE (LED) PRIMARY TYPE OF ARTIFICIAL LIGHTING IS FLUORESCENT OR LIGHT EMITTING DIODE (LED) PRIMARY TYPE OF ARTIFICIAL LIGHTING IS FLUORESCENT OR LIGHT EMITTING DIODE (LED) PRIMARY TYPE OF ARTIFICIAL LIGHTING IS FLUORESCENT OR LIGHT EMITTING DIODE (LED) KITCHEN
BATHROOMS/TOILETS LAUNDRY LIVING AREAS BEDROOMS PRIMARY TYPE OF ARTIFICIAL LIGHTING IS FLUORESCENT OR LIGHT EMITTING DIODE (LED) X 3 NATURAL LIGHTING WINDOW x 3 BATHROOMS/TOILETS <u>APPLIANCES</u>

These are the specifications upon which the Basix assessment is based. These specifications take precedence over the drawings or other specifications.

WELL VENTILATED AS BASIX DEFINITION

	S	ATING	4 S 4 S 5 S	MIN RATING 4 STAR 4 STAR 5 STAR 5 STAR			
	<u>r tank</u> R tank capacity Lection area foi	R R/W	3000 LITRE 100 SQ.M.				
R/W TANK	K CONNECTED TO		MIN 1 No. OUTDOOR TAP ALL TOILETS IN DWELLING THE COLD WATER TAP THAT SUPPLIES THE CLOTHES WASHER				
	COMFORT COMMITM REQUIREMENTS —	<u>IENTS</u>	CLASS 1 DWELLING WITH NOT MORE THAN 2 STOREYS CONDITIONED FLOOR AREA NOT EXCEEDING 300 SQUARE METRES MUST NOT HAVE OPEN MEZZANINE OF MORE THAN 25 SQUARE METRES NOT CONTAIN THIRD LEVEL HABITABLE ATTIC ROOM				
external Internal	WALL SHARED W						
CEILING AF	OMFORT COMMITMEN			CHED ROOF - CEILING R4, ROOF - SA	AKKING - UNVENTILATED - DAKK (SULAK A	ABSURPIANCE > 0.7)	
WINDOW	ORIENTATION	MAXIMUM HEIGHT (mm)	MAXIMUM WIDTH (mm)	TYPE	SHADING	OVERSHADOWING	
W01	N	1500	1500	ALUMINIUM, SINGLE, CLEAR	EAVE 600mm, 180mm ABOVE HEAD OF WINDOW OR GLAZED DOOR	NOT OVERSHADOWED	
W02	N	1500	1500	ALUMINIUM, SINGLE, CLEAR	EAVE 600mm, 180mm ABOVE HEAD OF WINDOW OR GLAZED DOOR	NOT OVERSHADOWED	
W03	N	1800	600	ALUMINIUM, SINGLE, CLEAR	EAVE 600mm, 180mm ABOVE HEAD OF WINDOW OR GLAZED DOOR	NOT OVERSHADOWED	
W04	N	1800	600	ALUMINIUM, SINGLE, CLEAR	EAVE 600mm, 180mm ABOVE HEAD OF WINDOW OR GLAZED DOOR	NOT OVERSHADOWED	
W05	N	900	600	ALUMINIUM, SINGLE, CLEAR	EAVE 600mm, 180mm ABOVE HEAD OF WINDOW OR GLAZED DOOR	NOT OVERSHADOWED	
W 06	N	1500	1800	ALUMINIUM, SINGLE, CLEAR	EAVE 600mm, 180mm ABOVE HEAD OF WINDOW OR GLAZED DOOR	NOT OVERSHADOWED	
W07	N	2100	2600	ALUMINIUM, SINGLE, CLEAR	EAVE 4100mm, 240mm ABOVE HEAD OF WINDOW OR GLAZED DOOR	NOT OVERSHADOWED	
W08	E	2100	2600	ALUMINIUM, SINGLE, CLEAR	EAVE 3900mm, 240mm ABOVE HEAD OF WINDOW OR GLAZED DOOR	NOT OVERSHADOWED	
W09	E	1800	600	600 ALUMINIUM, SINGLE, CLEAR EAVE 600mm, 180mm ABOVE HEAD OF WINDOW OR GLAZED DOOR		NOT OVERSHADOWED	
W 10	E	1800	600	600 ALUMINIUM, SINGLE, CLEAR EAVE 600mm, 180mm ABOWE HEAD OF WINDOW OR GLAZED DOOR		NOT OVERSHADOWED	
W11	S	1500	1800			NOT OVERSHADOWED	
W12	s	1500	1800	1800 ALUMINIUM, SINGLE, CLEAR EAVE 600mm, 180mm ABOVE HEAD NOT OF WINDOW OR GLAZED DOOR OVE		NOT OVERSHADOWED	
W13	s	900	1200	ALUMINIUM, SINGLE, CLEAR EAVE 600mm, 180mm ABOVE HEAD NOT OF WINDOW OR GLAZED DOOR OVERSI		NOT OVERSHADOWED	
W14	s	900	600	ALUMINIUM, SINGLE, CLEAR	EAVE 600mm, 180mm ABOVE HEAD OF WINDOW OR GLAZED DOOR	NOT OVERSHADOWED	
W 15	s	900	500	ALUMINIUM, SINGLE, CLEAR	EAVE 600mm, 240mm ABOVE HEAD OF WINDOW OR GLAZED DOOR	NOT OVERSHADOWED	
W16	w	1800	600	ALUMINIUM, SINGLE, CLEAR	EAVE 600mm, 180mm ABOVE HEAD OF WINDOW OR GLAZED DOOR	NOT OVERSHADOWED	
W17	W	1800	600	ALUMINIUM, SINGLE, CLEAR	EAVE 600mm, 180mm ABOVE HEAD OF WINDOW OR GLAZED DOOR	NOT OVERSHADOWED	
ENERGY C HOT WATER COOLING S HEATING S VENTILATIO BATHROOM KITCHEN LAUNDRY	System System <u>Sy</u>	GAS INSTANTANEOUS — 5 STAR REVERSE CYCLE: EER 3.0—3.5 WITH DAY/NIGHT ZONING BETWEEN LIVING/BED AREAS REVERSE CYCLE: EER 3.0—3.5 WITH DAY/NIGHT ZONING BETWEEN LIVING/BED AREAS EXTRACT FAN DUCTED TO ROOF OR FACADE — MANUAL ON/OFF EXTRACT FAN DUCTED TO ROOF OR FACADE — MANUAL ON/OFF NATURAL VENTILATION ONLY					
ARTIFICIAL KITCHEN BATHROOM LAUNDRY HALLWAYS LIVING ARE BEDROOMS	is/toilets Eas	PRIMARY 1 PRIMARY 1 PRIMARY 1 PRIMARY 1	PRIMARY TYPE OF ARTIFICIAL LIGHTING IS FLUORESCENT OR LIGHT EMITTING DIODE (LED) PRIMARY TYPE OF ARTIFICIAL LIGHTING IS FLUORESCENT OR LIGHT EMITTING DIODE (LED) PRIMARY TYPE OF ARTIFICIAL LIGHTING IS FLUORESCENT OR LIGHT EMITTING DIODE (LED) PRIMARY TYPE OF ARTIFICIAL LIGHTING IS FLUORESCENT OR LIGHT EMITTING DIODE (LED) PRIMARY TYPE OF ARTIFICIAL LIGHTING IS FLUORESCENT OR LIGHT EMITTING DIODE (LED) X 3 PRIMARY TYPE OF ARTIFICIAL LIGHTING IS FLUORESCENT OR LIGHT EMITTING DIODE (LED) X 4				
NATURAL I KITCHEN BATHROOM	lighting Is/toilets	WINDOW x	3				
APPLIANCE KITCHEN REFRIGERA CLOTHES	TOR SPACE	WELL VENTILATED AS BASIX DEFINITION OUTDOOR CLOTHES DRYING LINE					


BASIX COMMITMENTS - DWELLING B

<u>Landscape</u> Area low water use species of vegetation

WATER COMMITMENTS

FIXTURES

These are the specifications upon which the Basix assessment is based. These specifications take precedence over the drawings or other specifications.

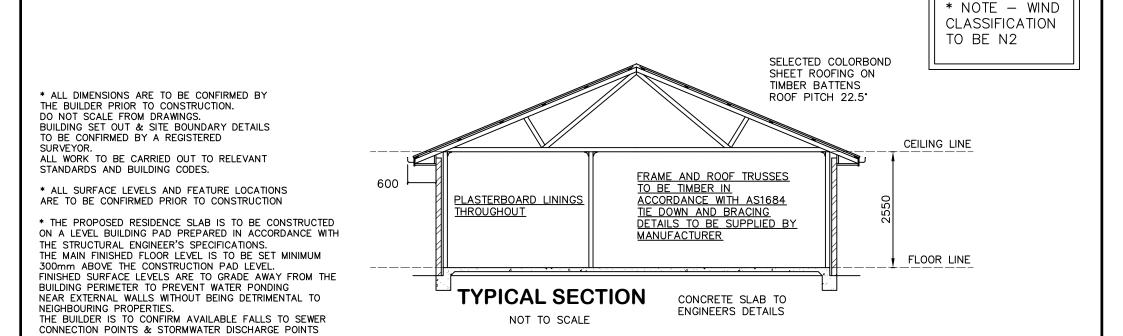

PROPE	ERTIES

PRIOR TO ESTABLISHING THE BUILDING FINISHED FLOOR LEVEL.

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KITCHEN REFRIGERATOR SPACE

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DRAWING:
BASIX COMMITMENTS & TYP SECTION
LOT 90 THE LOGAN, MUDGEE
MAAS GROUP PROPERTIES

