

Proposed Detached Dual Occupancy Lot 408, 3 Suttor Avenue Caerleon NSW 2850

DRAWING	SCHEDULE - FILE NO: 0469-A01
0469-A01	TITLE SHEET
0469-A02	BASIX COMMITMENTS
0469-A03	LOCATION, SITE, SUBDIVISION & LANDSCAPE PLAN
0469-A04	FLOOR PLAN - DWELLING ONE
0469-A05	FLOOR PLAN - DWELLING TWO
0469-A06	ELEVATIONS - DWELLING ONE
0469-A07	ELEVATIONS - DWELLING TWO
0469-A08	SECTION & GENERAL NOTES
0469-A09	ELECTRICAL & MECHANICAL PLANS - DWELLING ONE
0469-A10	ELECTRICAL \$ MECHANICAL PLANS - DWELLING TWO



LOCATION PLAN SCALE: NTS

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DESCRIPTION 25/02/2022 CONCEPT PLANS FOR REVIEW 14/03/2022 PRELIMINARY DA PLANS 29/07/2022 DA ISSUE FOR PCA SUBMISSION

ALL DRAWINGS TO BE READ IN CONJUNCTION WITH -WTH - ALL SHEETS TO THIS SET OF PLANS
- SEPERATE SPECIFICATION DOCUMENTS
- STRUCTURAL ENGINEERS DOCUMENTATION
- PCA DOCUMENTS (WHERE APPLICABLE)
- BASIX CERTIFICATE
- ALL RELEVANT CODES, STANDARDS & APPROVALS

BUILDING DESIGNERS ASSOCIATION OF AUSTRALIA

LYNCH BUILDING GROUP PROPOSED DETACHED DUAL OCCUPANCY LOT 408, 3 SUTTOR AVENUE CAERLEON NSW 2850



POSTAL: PO BOX | 298 Mudgee NSW 2850

CONTACT U5: P. 02 63726 054 E. projects@lynchbuildinggroup.com.au DRAFTED: J.LYNCH WWW.LYNCHBUILDINGGROUP.COM.AU

TITLE \$ LOCATION PLAN

DRAWING TITLE: DESIGN: LBG

FILE NO: 0469-A01

01 OF 10 C

CHECKED: A.LYNCH PAPER SIZE: A3 DRAWING NO:

BASIX COMMITMENTS - Dwelling One

THERMAL COMFORT

- > See Typical Section, Floor Plan and Basix Certificate for further Thermal Comfort Commitments.
- > The proposed construction must have the following applied to the floors, walls and ceiling / roof of the dwelling.

CONSTRUCTION	ADDITIONAL INSULATION REQUIRED	OTHER
Floor - concrete slab on ground	Nil	
External wall - brick veneer, framed (weatherboard)	R2.06/R2.2 (or R2.60 including construction)	
Internal wall shared with Garage - plasterboard	Nil	
Ceiling and roof - flat ceiling / pitched roof	Ceiling: R4.0 (up), Roof: foil / sarking	Unventilated; Dark (solar absorptance >0.70)

FNFRGY

HOT WATER

> A Gas Instantaneous Hot Water System must be installed with 5 star rating

COOLING & HEATING SYSTEM:

- > Living Area I -phase air conditioning, 3.5 Star (cold zone)
- > Bedroom I-phase air conditioning, 3.5 Star (cold zone) VENTILATION EXHAUST SYSTEMS:

- > At least | Bathroom individual fan not ducted with manual on/off switch
- > Kitchen individual fan, not ducted with manual on/off switch
- > Laundry natural ventilation only.

NATURAL LIGHTING:

- > A window and / or skylight must be installed in 2 bathrooms / toilet of the development
- > A window and / or skylight must be installed in the kitchen of the development

ARTIFICIAL LIGHTING:

- > The primary type of lighting in the following rooms must be fluorescent or LED:
 - At least 3 of the bedrooms / study (dedicated)
 - At least 2 of the living / dining rooms (dedicated)
 - The kitchen (dedicated)
 - The laundry (dedicated)
 - All hallways (dedicated)

- > Each refrigerator space must be constructed so that it is well ventilated
- > A fixed outdoor clothes drying line must be installed

GLAZING REQUIREMENTS

WINDOWS & GLAZED DOORS

> The applicant must install all proposed windows, glazed doors and shading devices as listed below.

WINDOW/DOOR NO.	ORIENTATION		OVER- SHADOWING	SHADING (mm)	TYPE
Living	N	2.0x0.7	0	E-0.60, A/H-0.0	Aluminium, single, clear
Living	N	2.0x0.7	0	E-2.45, A/H-0.0	Aluminium, single, clear
Living, Dining, Master Suite, ENS	E	2.0x0.9, .8x .8 (x3), 0.9x .5	0	E-0.60, A/H-0.0	Aluminium, single, clear
Kıtchen	E	2.0x2.7	0	E-4.02, A/H-0.15	Aluminium, single, clear
Dining	S	2.0x2.7	0	E-3.89, A/H-0.0	Aluminium, single, clear
Bath, Bed 3	S	0.9x1.5, 1.8x1.8	0	E-0.60, A/H-0.0	Aluminium, single, clear
Bed I, Bed2, Media, L'dry, Drop Zone	W	1.8x1.8 (x2), 2.0x1.5, 0.6x1.5	0	E-0.60, A/H-0.0	Aluminium, single, clear

> Note: E = Eave | A/H = Above Head | S/O = Solid Overhang | A/B = Above Base

WATER

FIXTURES

- > Showerheads 4 Star (>4.5 <=6L/min)
- > Toilet Flushing System 4 Star Rating
- > Kitchen Taps 4 Star Ratina
- > Bathroom Basin Taps 4 Star Rating

- > A rainwater tank of at least 2,000L capacity must be installed
- > The rainwater tank must collect rainwater from at least 268.45m2 of the roof area
- > The rainwater tank must be connected to:
 - The cold water tap that supplies each clothes washer
 - At least one outdoor tap in the development

> A minimum of 3 square metres of low water use planst must be included within the landscaping on site.

BASIX NOTES:

THE APPLICANT MUST COMPLY WITH THE BASIX COMMITMENTS WITHIN BASIX CERTIFICATE PROVIDED DURING THE CONSTRUCTION OF THIS PROPOSED DEVELOPMENT

BASIX COMMITMENTS - Dwelling Two

THERMAL COMFORT

- > See Typical Section, Floor Plan and Basix Certificate for further Thermal Comfort Commitments.
- > The proposed construction must have the following applied to the floors, walls and ceiling / roof of the dwelling.

CONSTRUCTION	ADDITIONAL INSULATION REQUIRED	OTHER
Floor - concrete slab on ground	Nil	
External wall - brick veneer, framed (weatherboard)	R2.06/R2.2 (or R2.60 including construction)	
Internal wall shared with Garage - plasterboard	Nil	
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Living	N	2.0x2.7	0	E-2.45, A/H-0.0	Aluminium, single, clear
Living, Dining, Master Suite, ENS	E	2.0x0.9, I.8xI.8 (x3), 0.9xI.5	0	V-3.3, A/H-2.14	Aluminium, single, clear
Kıtchen	E	2.0x2.7	0	E-4.02, A/H-0.15	Aluminium, single, clear
Dining	S	2.0x2.7	0	E-3.89, A/H-0.0	Aluminium, single, clear
Bath, Bed 3	S	0.9x1.5, 1.8 x 1.8	0	E-0.60, A/H-0.0	Aluminium, single, clear
Bed I , Bed2, L'dry, Drop Zone	W	1.8x1.8 , 2.0x1.5, 0.6x1.5	0	E-0.60, A/H-0.0	Aluminium, single, clear

 \rightarrow Note: E = Eave | A/H = Above Head | S/O = Solid Overhang | A/B = Above Base

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- > Kitchen Taps 4 Star Ratina
- > Bathroom Basin Taps 4 Star Rating

- > A rainwater tank of at least 2,000L capacity must be installed
- > The rainwater tank must collect rainwater from at least 239m2 of the roof area
- > The rainwater tank must be connected to:
 - The cold water tap that supplies each clothes washer
 - At least one outdoor tap in the development

> A minimum of 3 square metres of low water use planst must be included within the landscaping on site.

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CONTACT US:

02 63726 054 projects@lynchbuildinggroup.com.au WWW.LYNCHBUILDINGGROUP.COM.AU BASIX COMMITMENTS

DRAWING TITLE: DESIGN:

DRAFTED:


FILE NO: 0469-A02 LBG J.LYNCH

02 OF 10 A.LYNCH PAPER SIZE: A3

SEDIMENT CONTROL STAR PICKETS AT MAXIMUM 2.5 M SPACINGS

D. THE BOTTOM OF THE RADIO TO BE CONTROLLED TO THE PROPERTY OF THE PROPERTY OF THE PROPERTY OF THE PROPERTY OF THE TRENCH. ENSURE ANY STAR PICKETS ARE SAFETY CAPS, SUPPORTING GEOTEXTILE TO THE UPSLOPE SIDE THE SENSURING IT GOES TO THE BASE OF THE X THE GEOTEXTILE WITH WIRE TIES OR AS DED BY THE MANUFACTURER. ONLY USE SPECIFICALLY PRODUCED FOR SEDIMENT HE USE OF SHADE CLOTH FOR THIS PURPOSE SPACTORY.

OF FABRIC AT A SUPPORT POST WITH A . BACKFILL THE TRENCH OVER THE BASE OF THE FABRIC ND COMPACT IT THOROUGHLY OVER THE GEOTEXTILE.

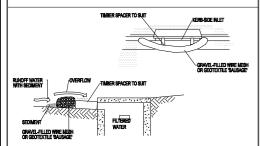

INSTALL FILTERS TO KERB INLETS ONLY AT SAG POINTS 2. FABRICATE A SLEEVE MADE FROM GEOTEXTILE OR WIRE MESH LONGER THAN THE LENGTH OF THE INLET PIT AND FILL IT WITH 25 MM TO 50 MM GRAVEL. 3. FORM AN ELLIPTICAL CROSS-SECTION ABOUT 150 MM

HIGH X 400 MM WIDE. 4. PLACE THE FILTER AT THE OPENING LEAVING AT LEAST A

100-MM SPACE BETWEEN IT AND THE KERB INLET.
MAINTAIN THE OPENING WITH SPACER BLOCKS. 5. FORM A SEAL WITH THE KERB TO PREVENT SEDIMENT BYPASSING THE FILTER.

. SANDBAGS FILLED WITH GRAVEL CAN SUBSTITUTE FOR THE MESH OR GEOTEXTILE PROVIDING THEY ARE PLACED SO THAT THEY FIRMLY ABUT EACH OTHER AND SEDIMENT-LADEN WATERS CANNOT PASS BETWEEN.

SITE NOTES

- CONFIRM ALL DIMENSIONS ON SITE TO EXISTING
- RESIDENCE PRIOR TO COMMENCEMENT OF ANY WORK THIS PLAN DOES NOT PROVIDE SPECIFIC LANDSCAPE PLANTING LOCATIONS.
- THE EXACT LOCATION OF UNDERGROUND AND ABOVEGROUND SERVICES SHALL BE PROVEN ON SITE. NO GUARANTEE IS GIVEN THAT ALL EXISTING SERVICES
- THIS DRAWING SET TO BE READ IN CONJUNCTION WITH THE SPECIFICATION PROVIDED.
 BEWARE OF EXISTING SERVICES. CONFIRM LOCATIONS
- PRIOR TO EXCAVATION. TAKE EXTREME CARE.

EGEND

TEMPORARY SITE MATERIAL DISPOSAL ARE DURING CONSTRUCTION. TO BE PROTECTED BY A SEDIMENT FENCE OR STRAW BALE FILTER.

SITE ACCESS DURING CONSTRUCTION.

COMPLYING DEVELOPMENT BOUNDARY MIN. OFFSET

SITE COVERAGE

LOT 408 SUTTOR AVENUE, CAERLEON

SITE COVERAGE TOTAL GFA INCLUDING PORCH \$ ALFRESCO

LANDSCAPING - INCLUDING GRAVEL AREAS
LESS TOTAL DRIVEWAY & PATHWAYS

 $= 750.32M^2$ $= 107.00M^2$ = 643 32M = 53.36%

DWELLING ONE

= 147.19M² DWELLING TWO $= 178.82M^2$

SUBDIVISION NOTES

LOT 408 SUTTOR AVENUE CAFRLEON

TOTAL LOT 408 AREA PROPOSED LOT I (DWELLING ONE) PROPOSED LOT 2 (DWELLING TWO)

- = 1205.60M 602.80M 602.80M
- CONFIRM ALL DIMENSIONS BACK TO SPECIFIC SURVEY PLANS PRIOR TO COMMENCEMENT OF ANY WORK.

 PROPOSED DIVIDING SUBDIVISION BOUNDARY IS
- APPROXIMATE ONLY AND TO BE CONFIRMED AS ABOVE BE READ IN CONJUNCTION WITH SPECIFIC SURVEY PLANS.

LANDSCAPING DETAILS

SMALL SHRUBS TO LOM HIGH


- BRONZE BABY (PHORIUM)

GOLF BABY (PITOS)PORUM)
 GOLF BABY (PITTOS)PORUM)
 MANCHURIAN PEAR (PYRUS USSURIENSIS)

CONSULT LOCAL NURSERY FOR AVAILABILITY AND SUITABILITY OF THE SPECIES LISTED \$ SUBSTITUTE SIMILAR PLANTING IF

REQUIRED. MULCH BEDS WITH WOODCHIP OR PEBBLES & FILL OUT OR LINE BEDS WITH GROUND COVERS OR SIMILAR SMALL PLANTS. EDGE BEDS WITH INSITU FORMED CONCRETE ROLLED EDGE, SLEEPERS. MASCONARY BLOCK EDGING OR SIMILAR AS

KIKUYU TURF TO ALL AREAS, UNLESS GRAVEL IS STATED AND DISPLAYED OTHERWISE.

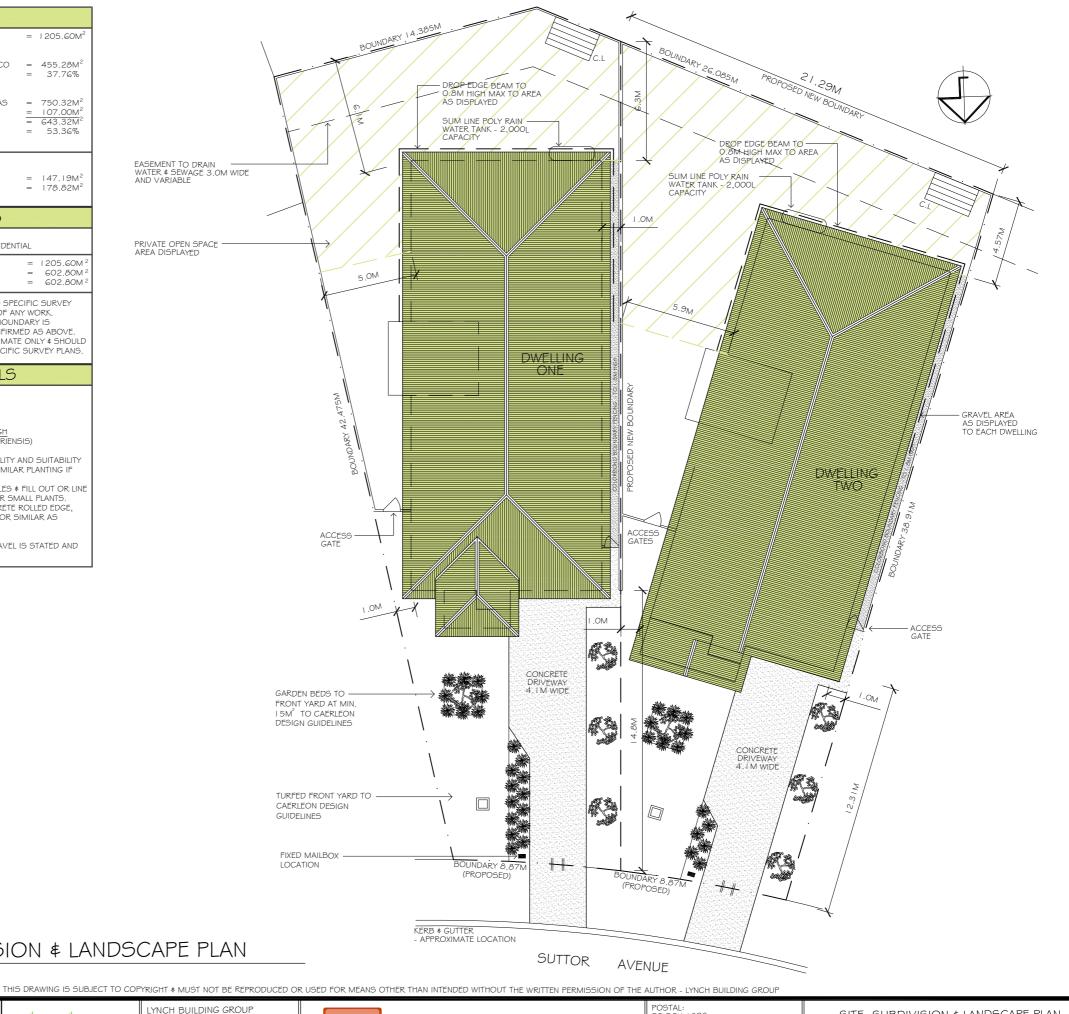

SITE ,SUBDIVISION & LANDSCAPE PLAN

SCALE: 1:200

REV DATE DESCRIPTION

25/02/2022

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Mudgee NSW 2850 CONTACT US:


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SITE ,SUBDIVISION \$ LANDSCAPE PLAN DRAWING TITLE:

DESIGN: DRAFTED: J.LYNCH

FILE NO: 0469-A03 L.B.G

03 OF 10 PAPER SIZE: A3

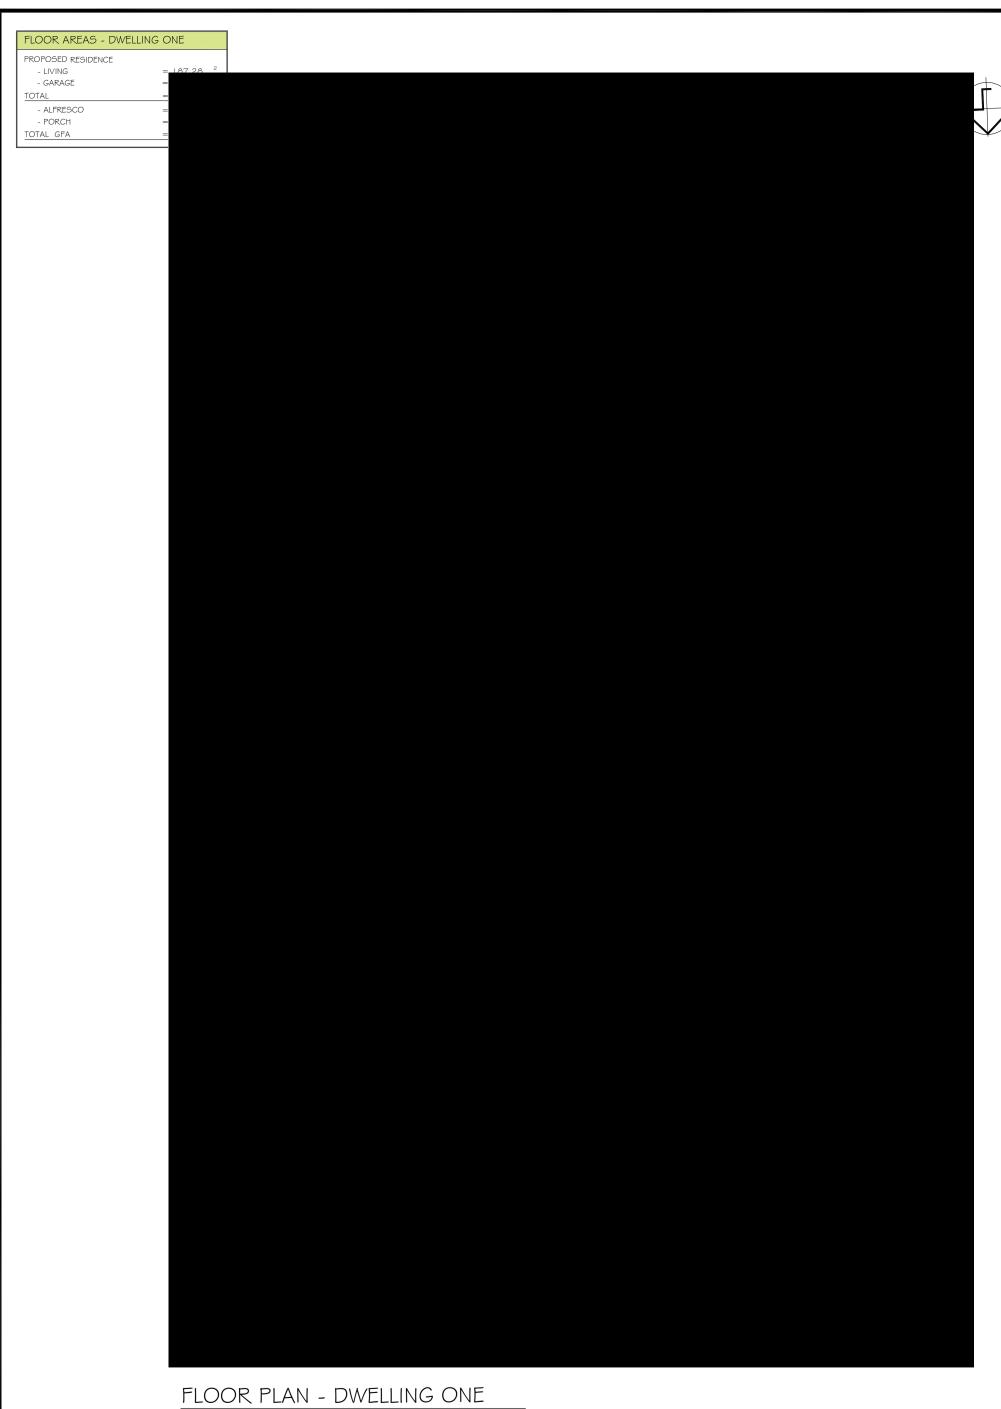

SCALE: 1:100

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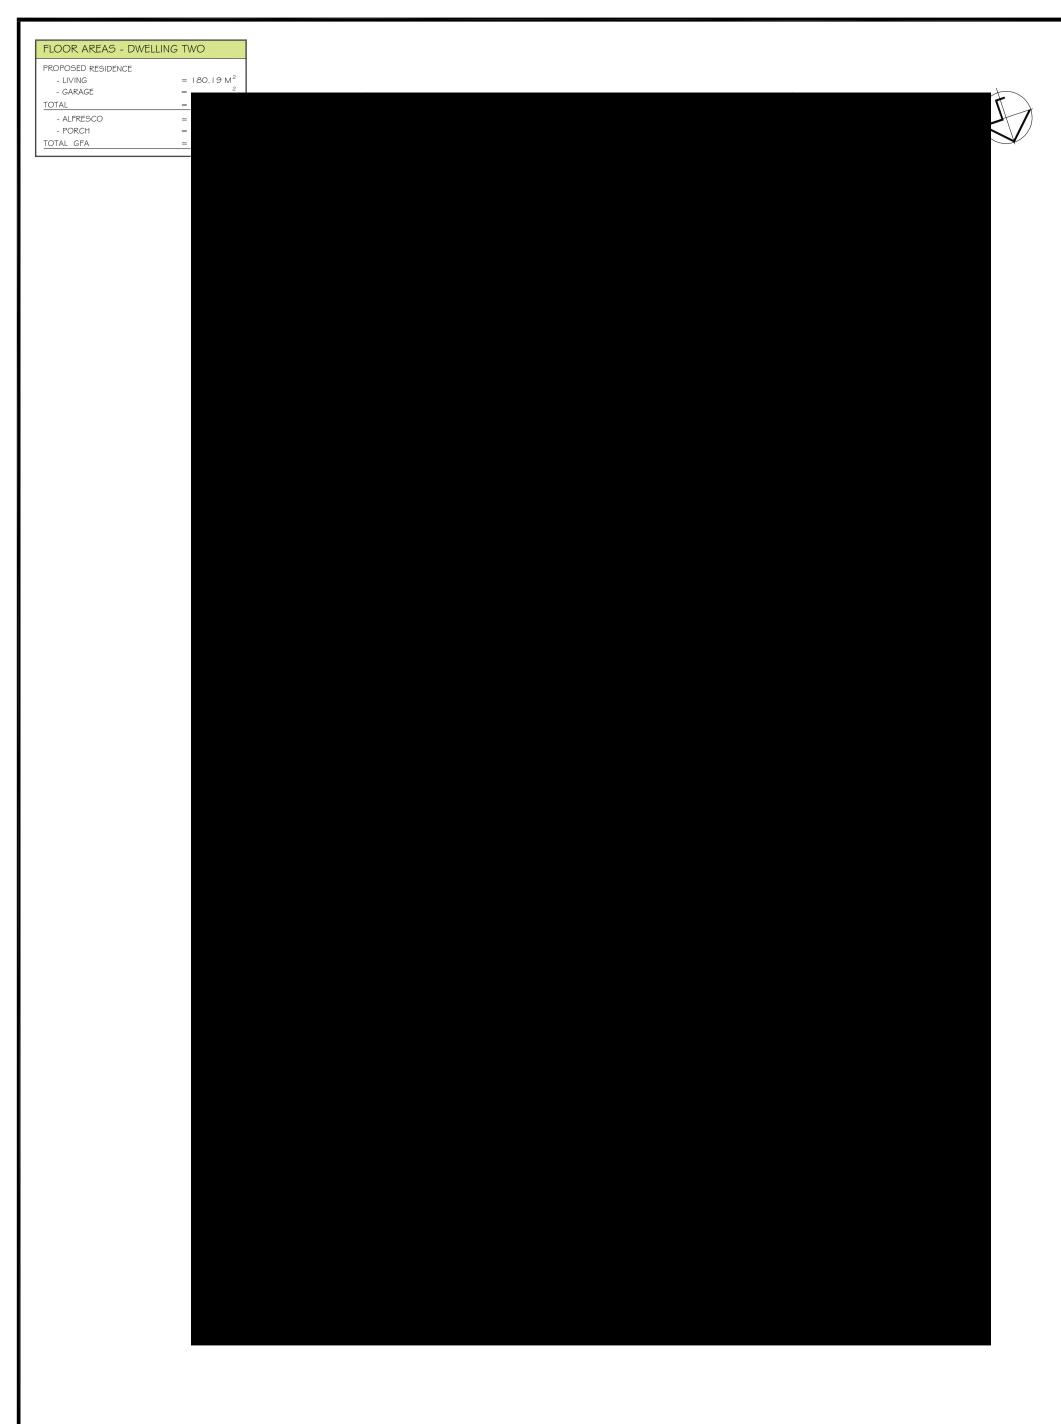
YNCH BUILDING GROUP -CLIENT:
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CAERLEON NSW 2850



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FLOOR PLAN - DWELLING ONE FILE NO: 0469-A04 04 0F 10 C DESIGN: LBG
DRAFTED: J.LYNCH
CHECKED: A.LYNCH

PAPER SIZE: A3 DRAWING NO



FLOOR PLAN - DWELLING TWO

SCALE: 1:100

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 REV
 DATE
 DESCRIPTION

 A
 25/02/2022
 CONCEPT PLANS FOR REVIEW

 B
 14/03/2022
 PRELIMINARY DA PLANS

 C
 29/07/2022
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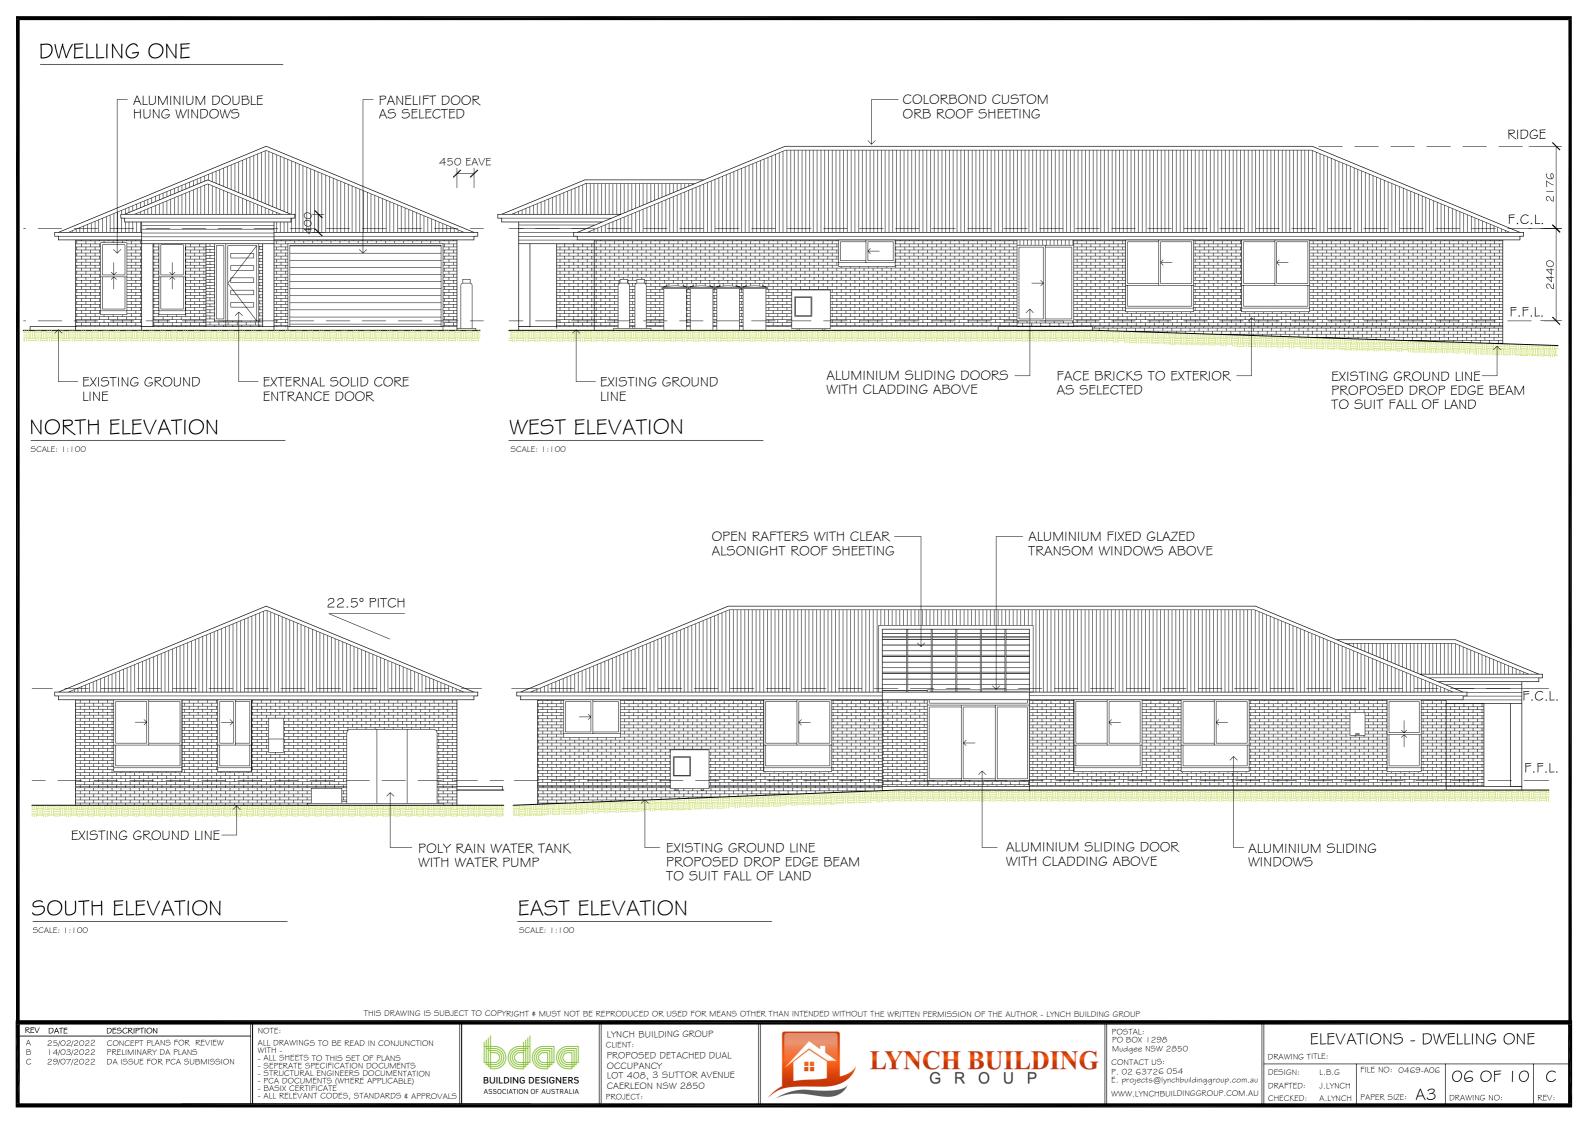
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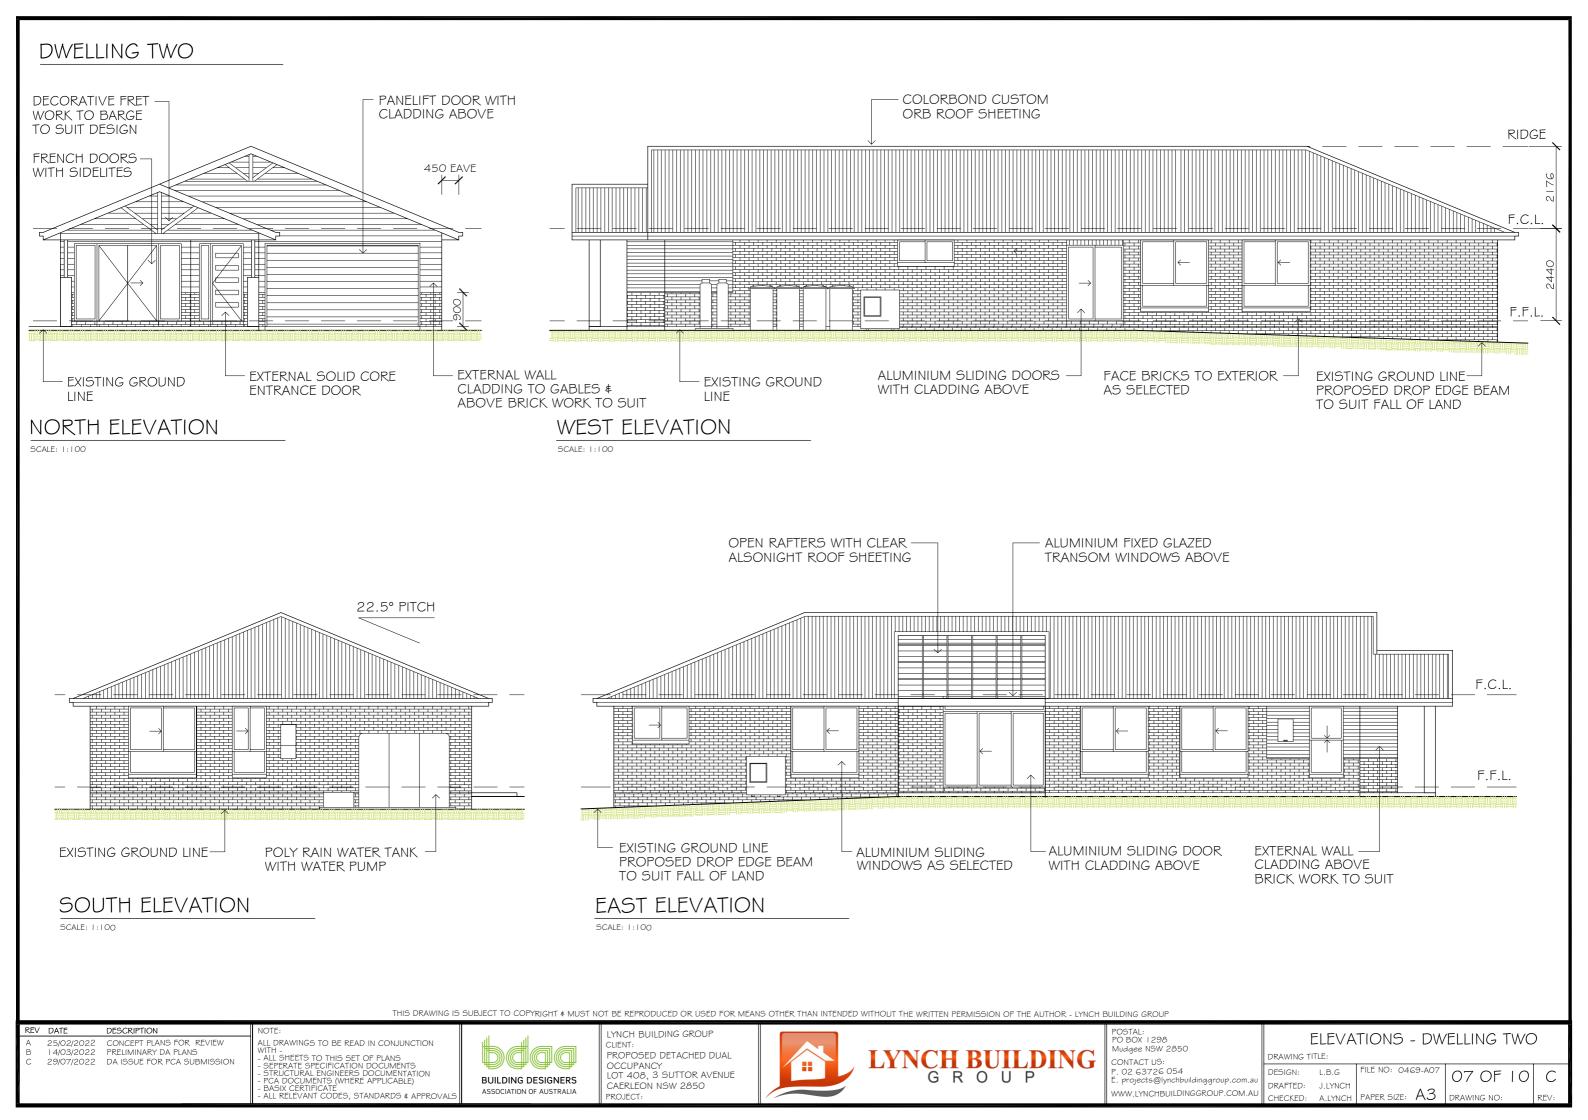



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FLOOR PLAN - DWELLING TWO
DRAWING TITLE:

DESIGN: LBG
DRAFTED: JLYNCH
CHECKED: ALYNCH PAPER SIZE: A3 DRAWING NO: REV:





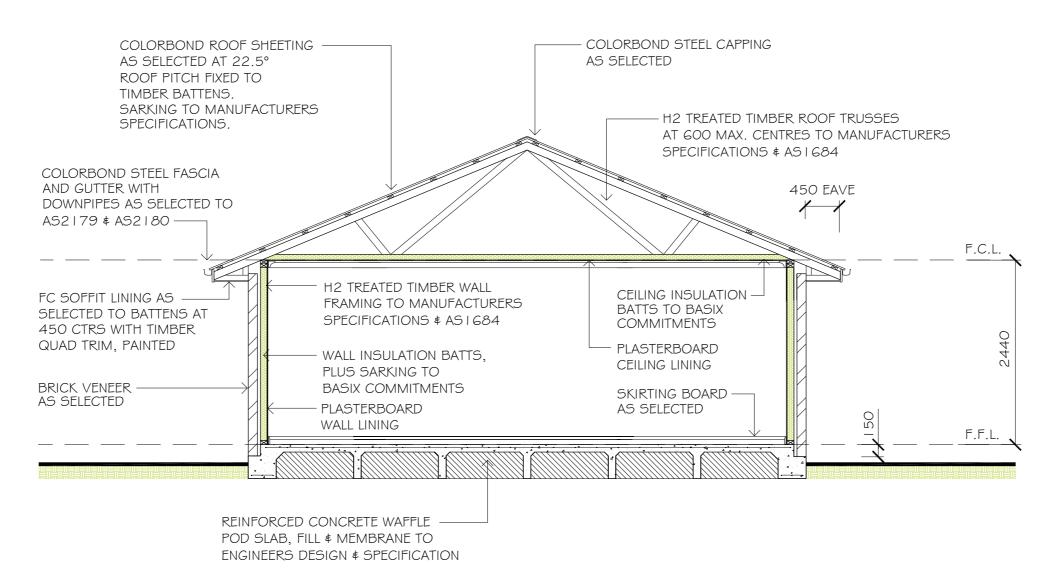

TYPICAL SECTION

SECTION NOTES

- FOR COMPLETE SLAB DETAILS & DESIGN REFER TO ENGINEERS
- TERMITE TREATMENT SHALL BE INCLUDED TO PROTECT AGAINST INFESTATION TO AS3660, I-2000

GENERAL NOTES

- PLANS DOCUMENTED FOR THE EXCLUSIVE USE OF THE NOTED CLIENTS BELOW ONLY & SUBJECT TO COPYRIGHT LAWS.
- 2 | ALL DIMENSIONS & INFORMATION WITHIN THESE SET OF PLANS ARE DOCUMENTED WITH DUE CARE.
- 3 | ALL DRAWINGS WITHIN THIS SET OF PLANS SHALL BE READ IN CONJUNCTION WITH OTHER CONSULTANTS DRAWINGS. DESIGNS \$ SPECIFICATIONS & WITH OTHER WRITTEN INSTRUCTIONS ISSUED DIJRING ESTIMATIONS & CONSTRUCTION WITH SELECTED BUILDER.
- ALL DISCREPANCIES SHALL BE REFERRED TO IN WRITING TO JHL BUILDING DESIGNS FOR A DECISION BEFORE PROCEEDING WITH THE WORK
- ALL DIMENSIONS ARE IN MILLIMETRES UNLESS STATED OTHERWISE. DIMENSIONS ARE TO STRUCTURAL ELEMENTS OF THE DRAWING \$ NOT TO FINISHED SURFACES IE. TILING, PLASTERBOARD ETC.
- ALL RELEVANT DIMENSIONS ARE TO BE CONFIRMED BY THE CONTRACTOR PRIOR TO CONSTRUCTION \$ FABRICATION WITH REGARDS TO ONSITE & OFF SITE REQUIREMENTS & WORK.

- 7 THE RELEVANT SERVICE AUTHORITIES SHALL BE CONSULTED IN REGARDS TO CONFIRMING / CHECKING ALL DIMENSIONS, LEVELS. SERVICES & SITE CONDITIONS PRIOR TO CONSTRUCTION
- 8 THE RELEVANT STATUTORY AUTHORITIES SHALL BE NOTIFIED \$ APPROVAL SORT FROM / OBTAINED PRIOR TO CONSTRUCTION, IF & WHEN NECESSARY.
- STUD WALL & TRUSSED ROOF DESIGN, BRACING & TIE DOWN TO SELECTED FRAME & TRUSS MANUFACTURERS ENGINEERED SPECIFICATIONS \$ TO AS I 684 WHERE APPLICABLE.
- 10 SHALL NO WIND CLASSIFICATION BE NOTED, CLIENT TO BE ADVISED BY PCA OR ENGINEERING CONSULTANT.
- I I | SITE CLASSIFICATION TO BE DETERMINED BY QUALIFIED GEOTECHNICAL ENGINEER & ALL REINFORCED CONCRETE FOOTINGS & SLABS TO BE CONSTRUCTED TO AS2870.
- 12 ALL STORM WATER FROM ROOF TO BE DISPURSED TO REQUIRED DOWNPIPES & TO STREET / RAIN WATER TANK TO AUSTRALIAN STANDARDS & PCA REQUIREMENTS.

- 13 A MINIMUM WATER ALLOWANCE SHALL BE PROVIDED FOR RURAL PROPERTIES FOR FIRE FIGHTING PURPOSES AS SPECIFIED BY PCA
- 14 WHERE A SITE REQUIRES CUT & FILL TO OCCUR OR RETAINING WALLS CONSTRUCTED, ENGINEERS SHALL BE CONSULTED WHERE NECESSARY & BUILDING CONTRACTOR TO ENSURE ALL FINAL LEVELS, GROUND LINES & GRADIENTS DIVERT ALL SURFACE STORM WATER FROM THE PROPOSED RESIDENCE FITHER BY MEANS OF PIPES DETENTION AREAS OR GRADING TO KERB NEIGHBOURING PROPERTIES MUST BE TAKEN INTO CONSIDERATION WITH THE DESIGN OF THE FLOW OF STORM WATER
- 151 SEWER DRAINAGE LINES TO BE CONNECTED TO SEWER MAIN OR IN THE CASE OF A RURAL PROPERTY, CONNECTED TO A SEPTIC SYSTEM. IN ACCORDANCE WITH THE RELEVANT AUSTRALIAN STANDARDS \$ LOCAL PCA.
- 16 A QUALIFIED CONTRACTOR SHALL COMPLETE THE FINAL DRAINAGE LAYOUT TO BE SUBMITTED TO THE LOCAL PCA FOR THEIR RECORDS & APPROVAL.

- 17 THE HOT WATER SYSTEM IS AS SPECIFIED WITHIN THE BASIX CERTIFICATE & LOCATION NOTED OF FLOOR PLAN.
- 18 TERMITE PROTECTION SHALL BE IN ACCORDANCE WITH AS3660.
- 19 WHERE BRICK VENEER CONSTRUCTION IS SPECIFIED. CONTROL JOINTS FOR ARTICULATION MUST BE PROVIDED AT NOMINAL 6.0M MAX. CENTRES OR TO STRUCTURAL ENGINEERS DETAILS.

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CONTACT US: . 02 63726 054 . projects@lynchbuildinggroup.com.au WWW.LYNCHBUILDINGGROUP.COM.AU TYPICAL SECTION

DRAWING TITLE:

CHECKED:

DRAFTED: J.LYNCH

FILE NO: 0469-A08 DESIGN: L.B.G

08 OF 10 C

ALYNCH PAPER SIZE: A3



ELECTRICAL LEGEND SINGLE POWER POINT (DISTANCE ABOVE F.F.L.) (2) (17) DOUBLE POWER POINT (DISTANCE ABOVE F.F.L.) LED LINEAR BATTEN - SINGLE (2) 0 DOWN LIGHT (24) \boxtimes SENSOR LIGHT (1) EXTERNAL WALL LIGHT (4) \otimes STANDARD BATTEN (8) 88 TASTIC LIGHT - 4 LIGHT (1) 8 TASTIC LIGHT - 2 LIGHT (1) TV (2) TELEVISION OUTLET NBN CONNECTION POINT (1) (1) 2-WAY SWITCH (-) PENDANT LIGHT (2) EXTERNAL POWER POINT CEILING FAN - WITH LIGHT CEILING FAN

ELECTRICAL NOTES

- ALL ELECTRICAL WORK SHALL BE CARRIED OUT BY A LICENSED CONTRACTOR. ALL WORK SHALL BE IN ACCORDANCE WITH AS/NZ3012 \$ ALL LINENSING REQUIREMENTS.
- 2 THE SELECTION OF FITTINGS AND THE LAYOUT TO BE CARRIED OUT BY THE BUILDER & DESIGNED TO THE CLIENT'S REQUIREMENTS.
- 3 ALL APPROVED SMOKE ALARMS / DETECTORS TO BE INSTALLED TO AS3786 BY A LICENSED CONTRACTOR.

MECHANICAL LEGEND

OUTDOOR AIR CONDITIONER UNIT

INDOOR SPLIT SYSTEM AIR CONDITIONER UNIT

70NFS

SUPPLY AIR GRILLS - ROUND



RETURN AIR GRILLS



AIR CONDITIONER UNIT IN ROOF SPACE

AIR CONDITIONER CONTROL PANEL / REMOTE

MECHANICAL NOTES

- ALL MECHANICAL WORKS REGARDING AIR CONDITIONING SHALL BE CARRIED OUT BY A LICENSED CONTRACTOR, ALL WORK SHALL BE IN
- 2 THE SELECTION OF FITTINGS AND THE LAYOUT TO BE CONFIRMED BY THE BUILDER & DESIGNED TO THE CLIENT'S REQUIREMENTS.
- GENERAL LAYOUT OF SUPPLY AIR GRILLS ETC IS TO BE VIEWED AS AN EXAMPLE ONLY & CAN CHANGE THROUGHOUT INSTALLATION

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LYNCH BUILDING GROUP PROPOSED DETACHED DUAL OCCUPANCY LOT 408, 3 SUTTOR AVENUE CAERLEON NSW 2850



Mudgee NSW 2850 CONTACT US:

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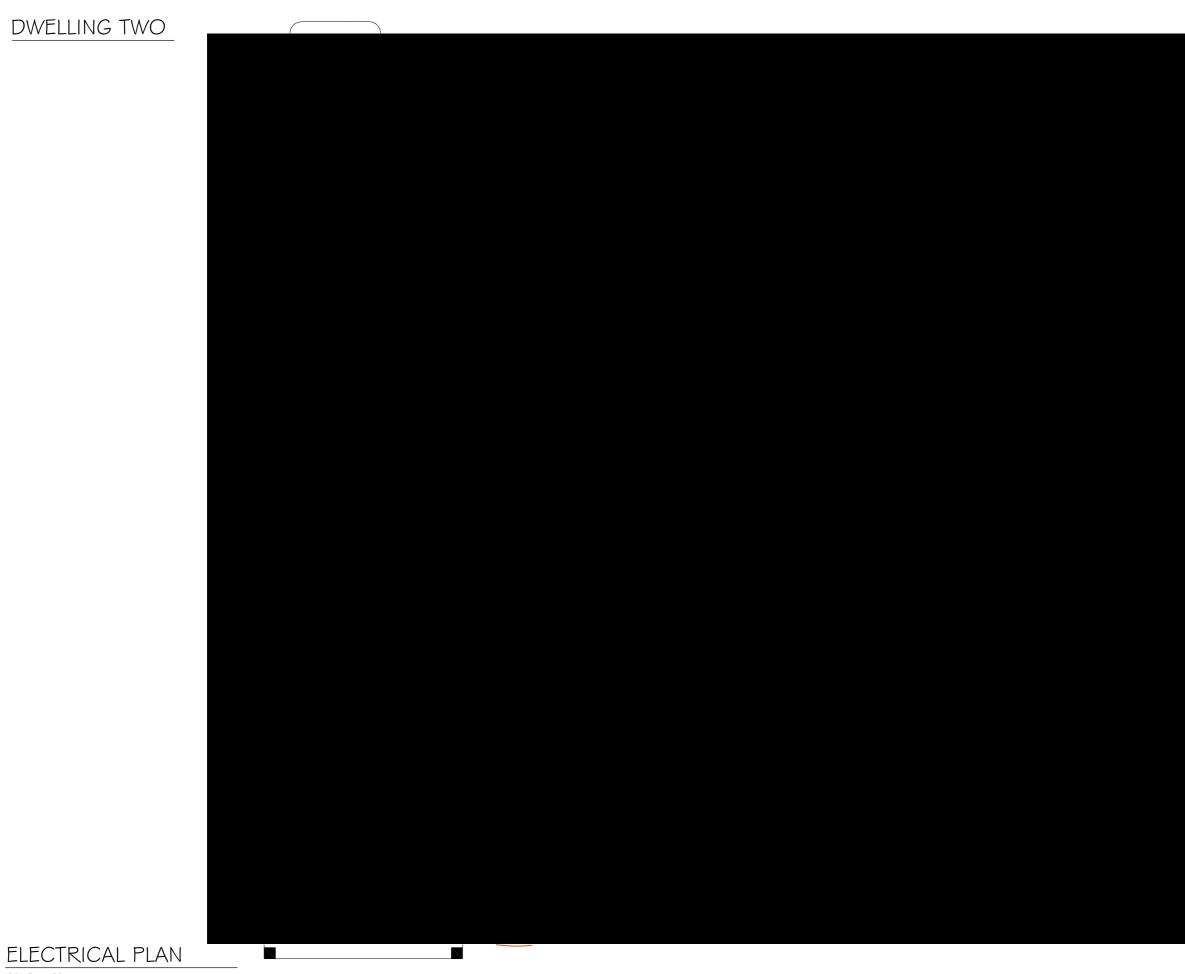
ELECTRICAL & MECHANICAL PLANS

DRAWING TITLE:

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ELECTRICAL LEGEND SINGLE POWER POINT (DISTANCE ABOVE F.F.L.) (2) (16) DOUBLE POWER POINT (DISTANCE ABOVE F.F.L.) LED LINEAR BATTEN - SINGLE (2) 0 DOWN LIGHT (19) \boxtimes SENSOR LIGHT (1) EXTERNAL WALL LIGHT (6) \otimes STANDARD BATTEN (7) 88 TASTIC LIGHT - 4 LIGHT (1) TASTIC LIGHT - 2 LIGHT (1) TV TELEVISION OUTLET (1) (1) NBN CONNECTION POINT (-) 2-WAY SWITCH PENDANT LIGHT OXX (2) EXTERNAL POWER POINT CEILING FAN - WITH LIGHT CEILING FAN

ELECTRICAL NOTES

- ALL ELECTRICAL WORK SHALL BE CARRIED OUT BY A LICENSED CONTRACTOR. ALL WORK SHALL BE IN ACCORDANCE WITH AS/NZ3012 \$ ALL LINENSING REQUIREMENTS.
- 2 THE SELECTION OF FITTINGS AND THE LAYOUT TO BE CARRIED OUT BY THE BUILDER & DESIGNED TO THE CLIENT'S REQUIREMENTS.
- ALL APPROVED SMOKE ALARMS / DETECTORS TO BE INSTALLED TO AS3786 BY A LICENSED CONTRACTOR.

MECHANICAL LEGEND

OUTDOOR AIR CONDITIONER UNIT



INDOOR SPLIT SYSTEM AIR CONDITIONER UNIT





SUPPLY AIR GRILLS - ROUND



RETURN AIR GRILLS



AIR CONDITIONER UNIT IN ROOF SPACE

AIR CONDITIONER CONTROL PANEL / REMOTE

MECHANICAL NOTES

- CARRIED OUT BY A LICENSED CONTRACTOR. ALL WORK SHALL BE IN ACCORDANCE WITH AUS STANDARDS \$ ALL LICENSING REQUIREMENTS
- 2 THE SELECTION OF FITTINGS AND THE LAYOUT TO BE CONFIRMED BY THE BUILDER & DESIGNED TO THE CLIENT'S REQUIREMENTS.
- GENERAL LAYOUT OF SUPPLY AIR GRILLS ETC IS TO BE VIEWED AS AN EXAMPLE ONLY & CAN CHANGE THROUGHOUT INSTALLATION

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REV DATE DESCRIPTION 25/02/2022 CONCEPT PLANS FOR REVIEW PRELIMINARY DA PLANS

29/07/2022 DA ISSUE FOR PCA SUBMISSION

ALL DRAWINGS TO BE READ IN CONJUNCTION

WITH - ALL SHEETS TO THIS SET OF PLANS
- SEPERATE SPECIFICATION DOCUMENTS
- STRUCTURAL ENGINEERS DOCUMENTATION
- PCA DOCUMENTS (WHERE APPLICABLE)
- BASIX CERTIFICATE

ALL RELEVANT CODES, STANDARDS & APPROVALS



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