



LIVING 144.70
GARAGE 36.52
PATIO 3.51
REAR PATIO 13.19
TOTAL 197.92 sq.m.

(21.30 sq.)

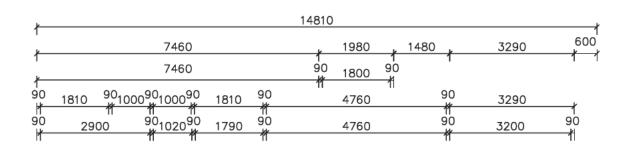

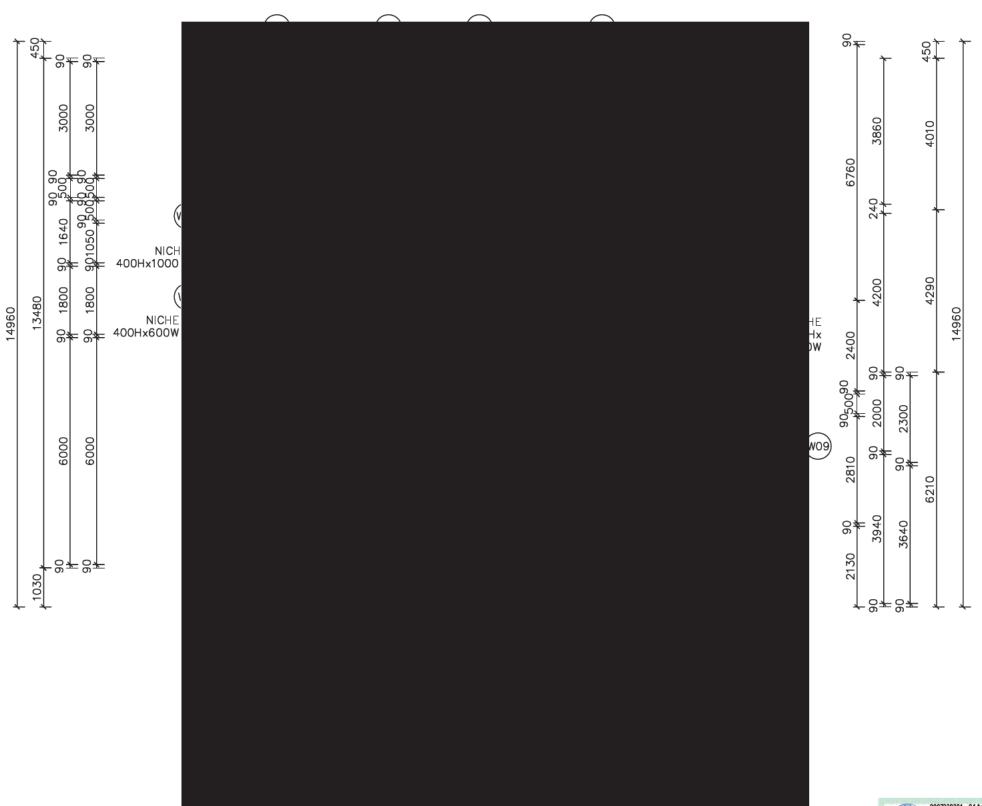

* NOTE: EXTERNAL LIGHTING
ALL EXTERNAL LIGHT FITTINGS ARE TO BE SHIELDED.
I.E. DOES NOT PERMIT LIGHT TO SHINE ABOVE THE HORIZONTAL PLANE.

* ALL DIMENSIONS ARE TO BE CONFIRMED BY THE BUILDER PRIOR TO CONSTRUCTION. DO NOT SCALE FROM DRAWINGS. BUILDING SET OUT & SITE BOUNDARY DETAILS TO BE CONFIRMED BY A REGISTERED SURVEYOR.

ALL WORK TO BE CARRIED OUT TO RELEVANT

NOTES - STAIR TREADS TO COMPLY WITH BCA 3.9.1.3

●SA SMOKE ALARM

8 EXHAUST FAN

E

EXHAUST SYSTEMS INSTALLED (INCLUDING TASTIC & LIGHT VENT COMBO) TO HAVE MINIMUM FLOW RATE IN ACCORDANCE WITH PART 3.8.7 NCC 2019

EXHAUST SYSTEMS (INCLUDING TASTIC & LIGHT VENT COMBO) TO DISCHARGE TO OUTSIDE AIR OR VENTILATED ROOF SPACE AS PER PART 3.8.7 NCC 2019. METHOD CHOSEN IS TO MATCH COMPLIANCE WITH THE RELEVANT BASIX CERTIFICATE.



PLIABLE BUILDING MEMBRANE INSTALLED IN EXTERNAL WALLS TO BE A VAPOR PERMEABLE TYPE, COMPLY WITH AS/NZS 4200.1 AND BE INSTALLED AS PER AS4200.2

EXTERNAL DOORS AND OPENABLE WINDOWS IN CONDITIONED SPACES TO BE SEALED TO RESTRICT AIR INFILTRATION AS PER PART 3.12.3 NCC 2019



STANDARDS AND BUILDING CODES.


DATE:	SCALE:	DRAWN:
02.08.22	1:100 (A3)	WP
SHEET:	JOB No:	ISSUE:


22073


1 / 6

DRAWING: FLOOR PLAN LOT 710 HONE CREEK DRIVE, MUDGEE SHANE KAIDA



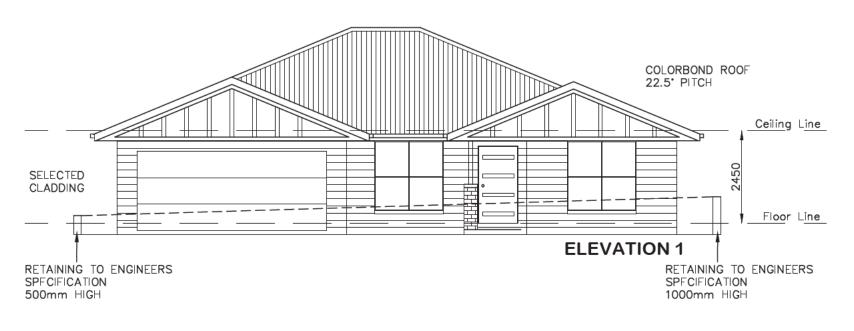

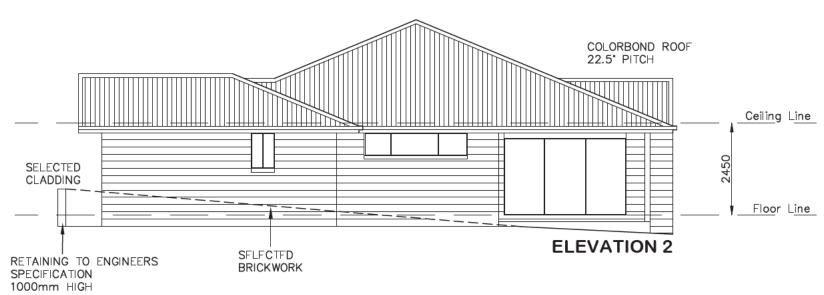

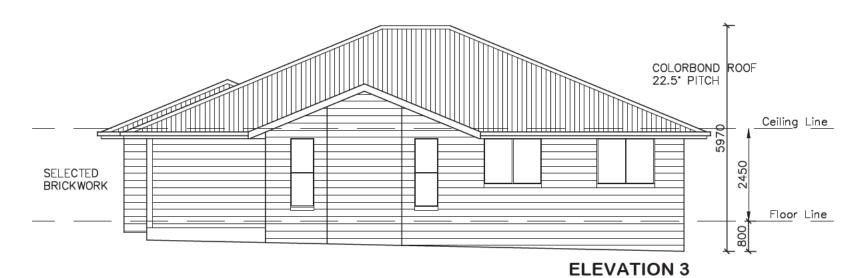



* ALL DIMENSIONS ARE TO BE CONFIRMED BY THE BUILDER PRIOR TO CONSTRUCTION. DO NOT SCALE FROM DRAWINGS.
BUILDING SET OUT & SITE BOUNDARY DETAILS TO BE CONFIRMED BY A REGISTERED SURVEYOR.
ALL WORK TO BE CARRIED OUT TO RELEVANT STANDARDS AND BUILDING CODES.




MITCH	BOWER	7

DATE: 02.08.22	SCALE: 1:100 (A3)	DRAWN: WP
SHEET:	JOB No:	ISSUE:
2/6	22073	l F

DRAWING: **ELEVATIONS** LOT 710 HONE CREEK DRIVE, MUDGEE SHANE KAIDA



. 0

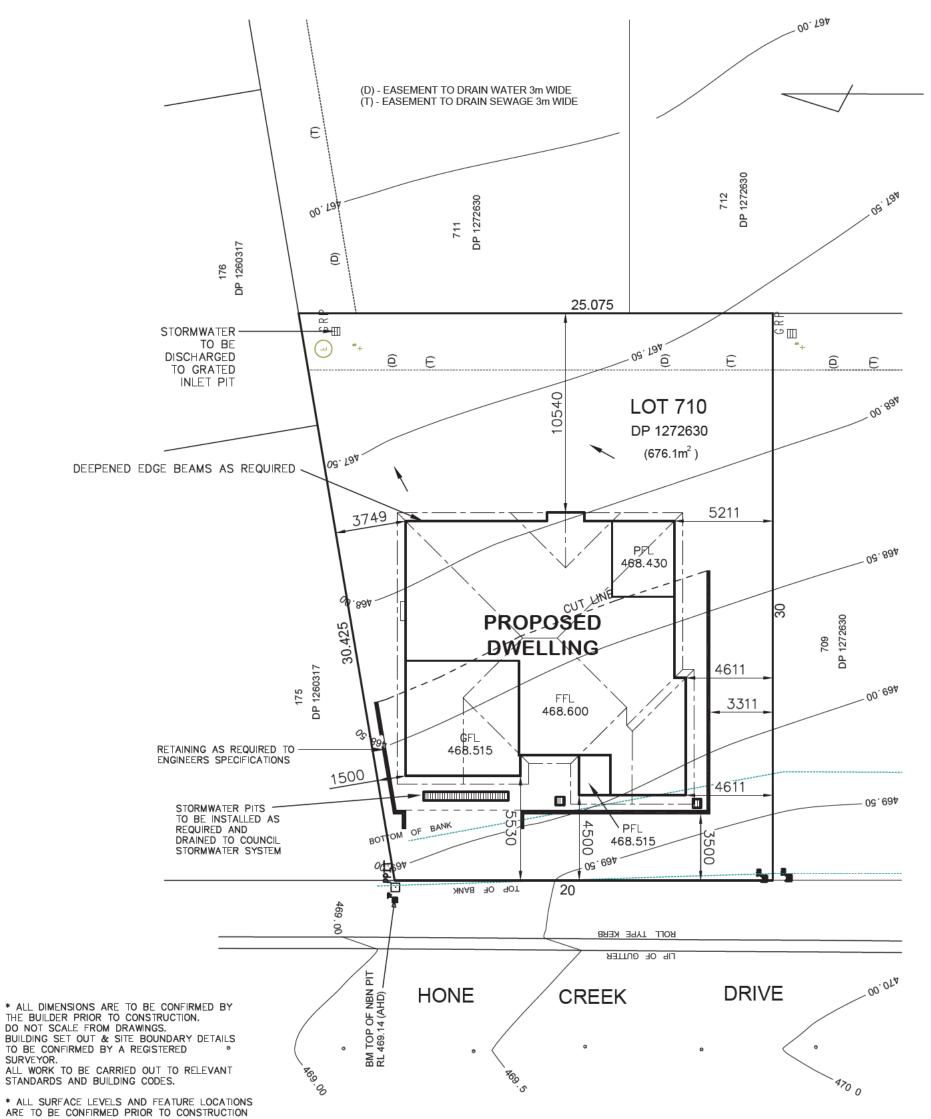

* THE PROPOSED RESIDENCE SLAB IS TO BE CONSTRUCTED ON A LEVEL BUILDING PAD PREPARED IN ACCORDANCE WITH

THE STRUCTURAL ENGINEER'S SPECIFICATIONS.
THE MAIN FINISHED FLOOR LEVEL IS TO BE SET MINIMUM
300mm ABOVE THE CONSTRUCTION PAD LEVEL.
FINISHED SURFACE LEVELS ARE TO GRADE AWAY FROM THE
BUILDING PERIMETER TO PREVENT WATER PONDING
NEAR EXTERNAL WALLS WITHOUT BEING DETRIMENTAL TO
NEIGHBOURING PROPERTIES.
THE BUILDER IS TO CONFIRM AVAILABLE FALLS TO SEWER

THE BUILDER IS TO CONFIRM AVAILABLE FALLS TO SEWER CONNECTION POINTS & STORMWATER DISCHARGE POINTS PRIOR TO ESTABLISHING THE BUILDING FINISHED FLOOR LEVEL.




DENOTES DIRECTION OF SURFACE WATER ON COMPLETION OF LANDSCAPING.



DATE:	SCALE:	DRAWN:
02.08.22	1:200 (A3)	WP
SHEET:	JOB No:	ISSUE:
3 / 6	22073	E

DRAWING: SITE PLAN LOT 710 HONE CREEK DRIVE, MUDGEE SHANE KAIDA



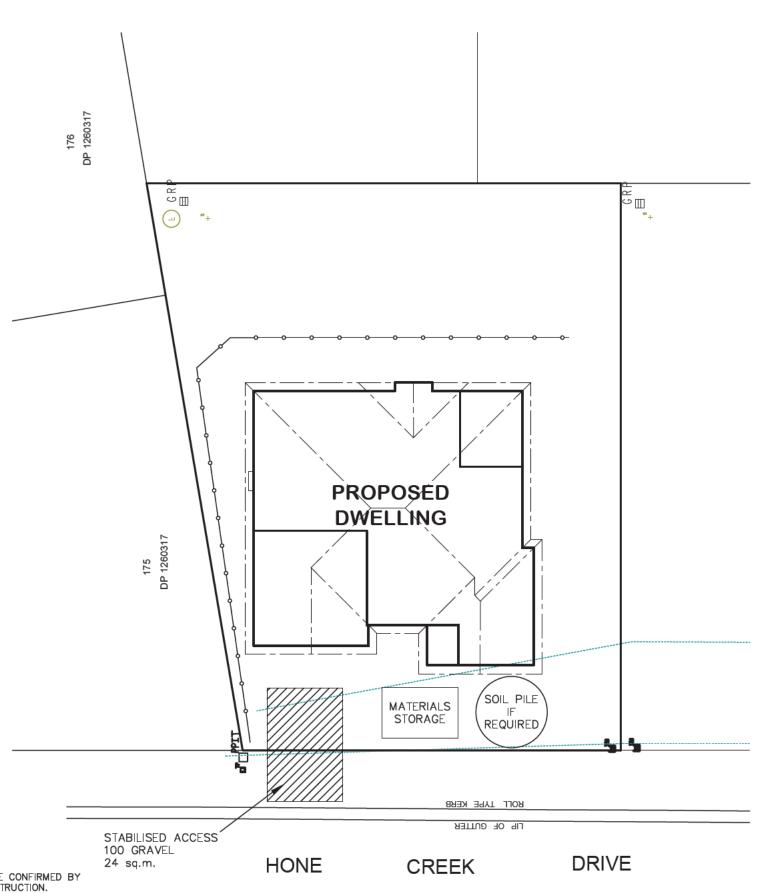

* ALL DIMENSIONS ARE TO BE CONFIRMED BY THE BUILDER PRIOR TO CONSTRUCTION.
DO NOT SCALE FROM DRAWINGS.
BUILDING SET OUT & SITE BOUNDARY DETAILS TO BE CONFIRMED BY A REGISTERED SURVEYOR.
ALL WORK TO BE CARRIED OUT TO RELEVANT

STANDARDS AND BUILDING CODES.

* ALL SURFACE LEVELS AND FEATURE LOCATIONS ARE TO BE CONFIRMED PRIOR TO CONSTRUCTION

* THE PROPOSED RESIDENCE SLAB IS TO BE CONSTRUCTED ON A LEVEL BUILDING PAD PREPARED IN ACCORDANCE WITH THE STRUCTURAL ENGINEER'S SPECIFICATIONS.
THE MAIN FINISHED FLOOR LEVEL IS TO BE SET MINIMUM
300mm ABOVE THE CONSTRUCTION PAD LEVEL.
FINISHED SURFACE LEVELS ARE TO GRADE AWAY FROM THE
BUILDING PERIMETER TO PREVENT WATER PONDING
NEAR EXTERNAL WALLS WITHOUT BEING DETRIMENTAL TO NEIGHBOURING PROPERTIES.
THE BUILDER IS TO CONFIRM AVAILABLE FALLS TO SEWER
CONNECTION POINTS & STORMWATER DISCHARGE POINTS
PRIOR TO ESTABLISHING THE BUILDING FINISHED FLOOR LEVEL. 5.3 0007938384 04 Aug 2022 Assessor Andrew Lorriman Accreditation No. DMN17/1827 Address Hone Greek Drive , Mudgee , NSW , 2850 262.3

NOTES:

- 1. ALL RUNOFF & SEDIMENT CONTROL STRUCTURES TO BE MAINTAINED IN A FUNCTIONAL CONDITION.
- 2. ALL VEGETATION OUTSIDE THE DWELLING SITE WILL BE RETAINED.

→ SEDIMENT FENCE

MITCH	BOWER

DATE:	SCALE:	DRAWN:
02.08.22	1:200 (A3)	WP
SHEET:	JOB No:	ISSUE:


Ε

22073

4 / 6

DRAWING: EROSION & SEDIMENT CONTROL PLAN LOT 710 HONE CREEK DRIVE, MUDGEE SHANE KAIDA



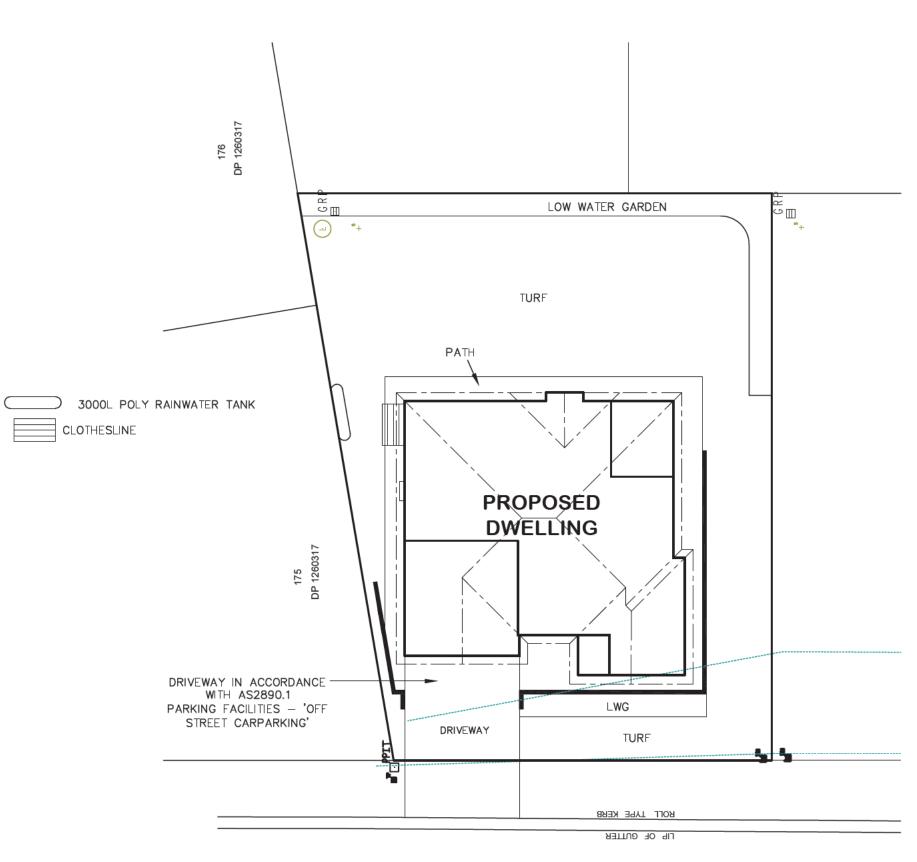

* ALL DIMENSIONS ARE TO BE CONFIRMED BY THE BUILDER PRIOR TO CONSTRUCTION.
DO NOT SCALE FROM DRAWINGS.
BUILDING SET OUT & SITE BOUNDARY DETAILS TO BE CONFIRMED BY A REGISTERED SURVEYOR.
ALL WORK TO BE CARRIED OUT TO RELEVANT STANDARDS AND BUILDING CODES.

* ALL SURFACE LEVELS AND FEATURE LOCATIONS ARE TO BE CONFIRMED PRIOR TO CONSTRUCTION

* THE PROPOSED RESIDENCE SLAB IS TO BE CONSTRUCTED ON A LEVEL BUILDING PAD PREPARED IN ACCORDANCE WITH THE STRUCTURAL ENGINEER'S SPECIFICATIONS.
THE MAIN FINISHED FLOOR LEVEL IS TO BE SET MINIMUM
300mm ABOVE THE CONSTRUCTION PAD LEVEL.
FINISHED SURFACE LEVELS ARE TO GRADE AWAY FROM THE
BUILDING PERIMETER TO PREVENT WATER PONDING
NEAR EXTERNAL WALLS WITHOUT BEING DETRIMENTAL TO NEIGHBOURING PROPERTIES.
THE BUILDER IS TO CONFIRM AVAILABLE FALLS TO SEWER
CONNECTION POINTS & STORMWATER DISCHARGE POINTS
PRIOR TO ESTABLISHING THE BUILDING FINISHED FLOOR LEVEL.

DRIVE HONE CREEK

**	0007938384 04 Aug 2022
5.3 DUSE	Assessor Antrew Lorriman Accreditation No. DMN17/1827 Address Hone Creek Drive , Mudgee ,
62.3	NSW , 2850
others.gov.au	www.hstar.com.a

MITCH	BOWER

DATE:	SCALE:	DRAWN:
02.08.22	1:200 (A3)	WP
SHEET:	JOB No:	ISSUE:

Ε

22073

5 / 6


DRAWING: BASIX COMMITMENTS PLAN LOT 710 HONE CREEK DRIVE, MUDGEE SHANE KAIDA

	AVA	LON
	DRAF	TING
	ge Drive Dubbo	

BASIX COMMITMENTS		
WATER COMMITMENTS LANDSCAPE AREA LOW WATER USE SPECIE FIXTURES SHOWER HEAD RATING TOILET FLUSHING SYSTEM RATI KITCHEN TAPS BASIN TAPS ALTERNATIVE WATER RAINWALER TANK ROOF COLLECTION AREA FOR R/W TANK CONNECTED TO	NG	53.2 SQ.M. MIN RATING 4 STAR 4 STAR 5 STAR 5 STAR 5 STAR 3000 LITRE 100 SQ.M. MIN 1 No. OUTDOOR TAP ALL TOILETS IN DWELLING THE COLD WATER TAP THAT SUPPLIES THE CLOTHES WASHER
ENERCY COMMITMENTS HOT WATER SYSTEM COOLING SYSTEM HEATING SYSTEM YENTLATION BATHROOM KITCHEN LAUNDRY	REVERSE CYCLE: EXTRACT FAN DU	EER 3.0–3.5 WITH DAY/NIGHT ZONING BETWEEN LIVING/BED AREAS EER 3.0–3.5 WITH DAY/NIGHT ZONING BETWEEN LIVING/BED AREAS CTED TO ROOF OR FACADE — MANUAL ON/OFF CTED TO ROOF OR FACADE — MANUAL ON/OFF
ARTIFICAL LIGHTING KITCHEN BATHROOMS/TOILETS LAUNDRY HALLWAYS LIVING AREAS BEDROOMS	PRIMARY TYPE OF ARTIFICIAL LIGHTING IS FLUORESCENT OR LIGHT EMITTING DIODE (LED) PRIMARY TYPE OF ARTIFICIAL LIGHTING IS FLUORESCENT OR LIGHT EMITTING DIODE (LED) PRIMARY TYPE OF ARTIFICIAL LIGHTING IS FLUORESCENT OR LIGHT EMITTING DIODE (LED) PRIMARY TYPE OF ARTIFICIAL LIGHTING IS FLUORESCENT OR LIGHT EMITTING DIODE (LED) PRIMARY TYPE OF ARTIFICIAL LIGHTING IS FLUORESCENT OR LIGHT EMITTING DIODE (LED) X 3 PRIMARY TYPE OF ARTIFICIAL LIGHTING IS FLUORESCENT OR LIGHT EMITTING DIODE (LED) X 4	
NATURAL LIGHTING KITCHEN BATHROOMS/TOILETS	WINDOW x 2	
APPLIANCES KITCHEN REFRIGERATOR SPACE CLOTHES DRYING	WELL VENTILATED OUTDOOR CLOTHE	as basix definition s drying line


These are the specifications upon which the Basix assessment is based. These specifications take precedence over the drawings or other specifications.

* NOTE - WIND CLASSIFICATION TO BE N2

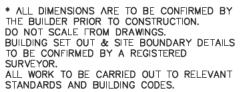

- * ALL SURFACE LEVELS AND FEATURE LOCATIONS ARE TO BE CONFIRMED PRIOR TO CONSTRUCTION
- * THE PROPOSED RESIDENCE SLAB IS TO BE CONSTRUCTED ON A LEVEL BUILDING PAD PREPARED IN ACCORDANCE WITH THE STRUCTURAL ENGINEER'S SPECIFICATIONS. THE MAIN FINISHED FLOOR LEVEL IS TO BE SET MINIMUM 300mm ABOVE THE CONSTRUCTION PAD LEVEL. FINISHED SURFACE LEVELS ARE TO GRADE AWAY FROM THE BUILDING PERIMETER TO PREVENT WATER PONDING NEAR EXTERNAL WALLS WITHOUT BEING DETRIMENTAL TO NEIGHBOURING PROPERTIES.

THE BUILDER IS TO CONFIRM AVAILABLE FALLS TO SEWER CONNECTION POINTS & STORMWATER DISCHARGE POINTS PRIOR TO ESTABLISHING THE BUILDING FINISHED FLOOR LEVEL.

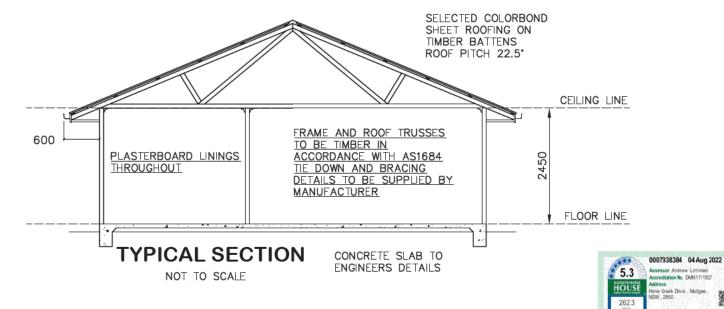



DATE:	SCALE:	DRAWN:
02.08.22	N / A	WP
SHEET:	JOB No:	ISSUE:

Ε

22073

6 / 6

DRAWING: BASIX COMMITMENTS & TYP SECTION LOT 710 HONE CREEK DRIVE, MUDGEE SHANE KAIDA

