




LIVING 132.13
GARAGE 46.60
PATIO 22.52
PORCH 3.57
TOTAL 204.82 sq.m.
22.05 sq.)

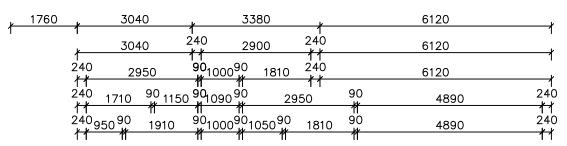

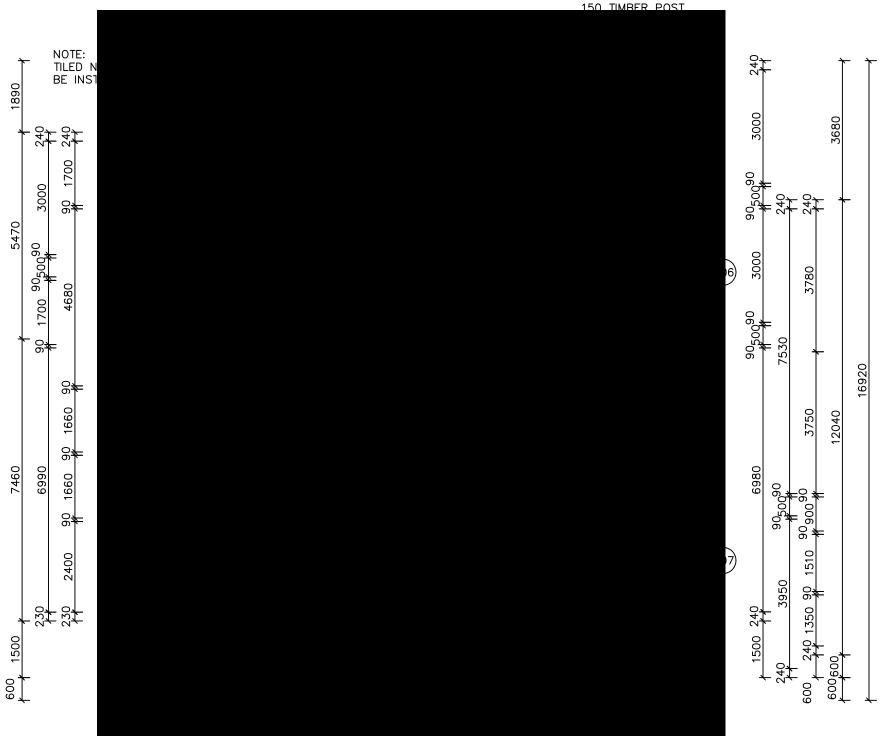

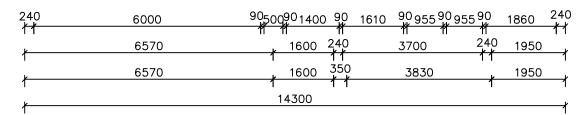

NOTES - STAIR TREADS TO COMPLY WITH BCA 3.9.1.3

●SA SMOKE ALARM

EXHAUST FAN

* NOTE: EXTERNAL LIGHTING

ALL EXTERNAL LIGHT FITTINGS ARE TO BE SHIELDED.
I.E. DOES NOT PERMIT LIGHT TO SHINE ABOVE THE HORIZONTAL PLANE.

* ALL DIMENSIONS ARE TO BE CONFIRMED BY THE BUILDER PRIOR TO CONSTRUCTION. DO NOT SCALE FROM DRAWINGS. BUILDING SET OUT & SITE BOUNDARY DETAILS TO BE CONFIRMED BY A REGISTERED SURVEYOR. ALL WORK TO BE CARRIED OUT TO RELEVANT STANDARDS AND BUILDING CODES.

"DURUM 4 DG"

EXHAUST SYSTEMS INSTALLED (INCLUDING TASTIC & LIGHT VENT COMBO) TO HAVE MINIMUM FLOW RATE IN ACCORDANCE WITH PART 3.8.7 NCC 2019

EXHAUST SYSTEMS (INCLUDING TASTIC & LIGHT VENT COMBO) TO DISCHARGE TO OUTSIDE AIR OR VENTILATED ROOF SPACE AS PER PART 3.8.7 NCC 2019. METHOD CHOSEN IS TO MATCH COMPLIANCE WITH THE RELEVANT BASIX CERTIFICATE.

PLIABLE BUILDING MEMBRANE INSTALLED IN EXTERNAL WALLS TO BE A VAPOR PERMEABLE TYPE, COMPLY WITH AS/NZS 4200.1 AND BE INSTALLED AS PER AS4200.2

EXTERNAL DOORS AND OPENABLE WINDOWS IN CONDITIONED SPACES TO BE SEALED TO RESTRICT AIR INFILTRATION AS PER PART 3.12.3 NCC 2019



| DATE: | SCALE: | DRAWN: |
|----------|------------|--------|
| 17.12.21 | 1:100 (A3) | WP |
| SHEET: | JOB No: | ISSUE: |

Н

21085


1 / 8


DRAWING: FLOOR PLAN - DWELLING A LOT 66 THE LOGAN, MUDGEE MAAS GROUP PROPERTIES



Ph: (02) 6885 3594 / Mob: 0408 296 502



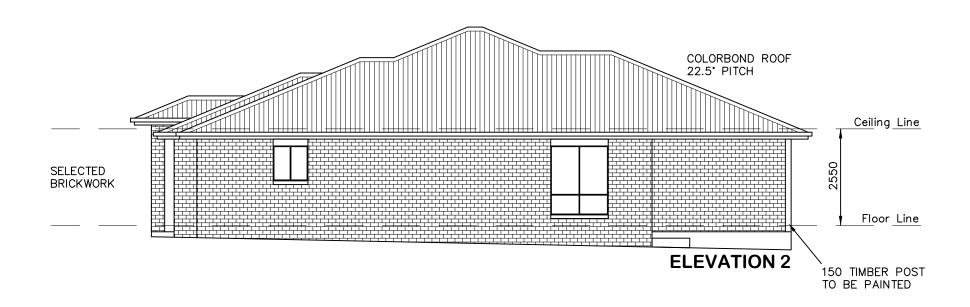

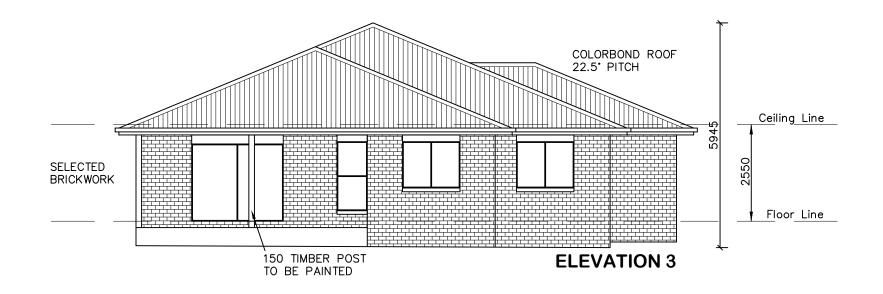



* ALL DIMENSIONS ARE TO BE CONFIRMED BY THE BUILDER PRIOR TO CONSTRUCTION.
DO NOT SCALE FROM DRAWINGS.
BUILDING SET OUT & SITE BOUNDARY DETAILS TO BE CONFIRMED BY A REGISTERED SURVEYOR.
ALL WORK TO BE CARRIED OUT TO RELEVANT STANDARDS AND BUILDING CODES.

"DURUM 4 DG"



| DATE: 17.12.21 | SCALE: 1:100 (A3) | DRAWN: WP |
|-------------------|----------------------|--------------|
| SHEET: | JOB No: | ISSUE: |
| 2/8 | 21085 | Н |


DRAWING: ELEVATIONS - DWELLING A LOT 66 THE LOGAN, MUDGEE MAAS GROUP PROPERTIES







LIVING 102.45
GARAGE 22.50
PATIO 5.32
REAR PATIO 12.57

142.84 sq.m. (15.38 sq.)

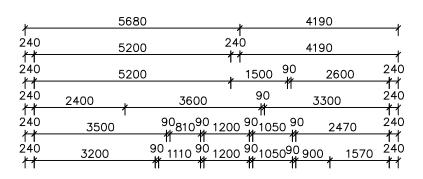

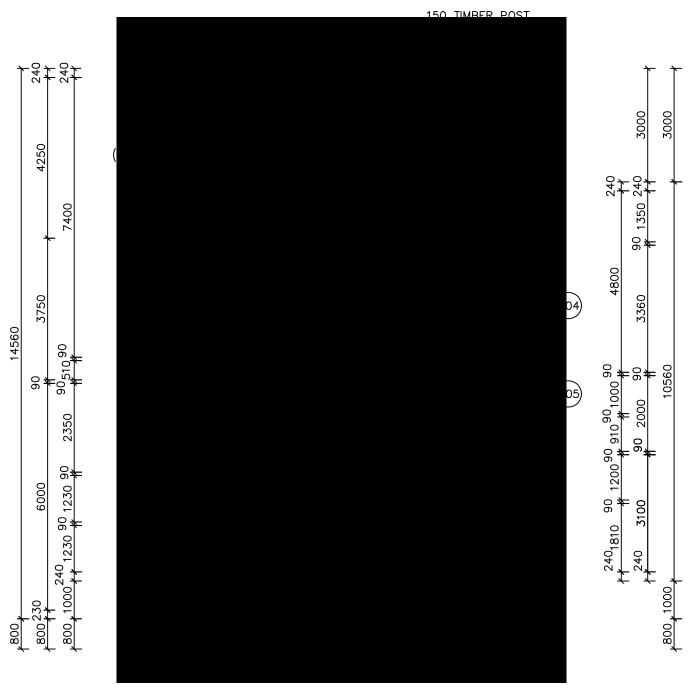

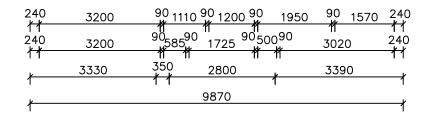

●SA SMOKE ALARM

NOTES - STAIR TREADS TO COMPLY WITH BCA 3.9.1.3

8 EXHAUST FAN

"TAMWORTH SG"

EXHAUST SYSTEMS INSTALLED (INCLUDING TASTIC & LIGHT VENT COMBO) TO HAVE MINIMUM FLOW RATE IN ACCORDANCE WITH PART 3.8.7 NCC 2019

EXHAUST SYSTEMS (INCLUDING TASTIC & LIGHT VENT COMBO) TO DISCHARGE TO OUTSIDE AIR OR VENTILATED ROOF SPACE AS PER PART 3.8.7 NCC 2019. METHOD CHOSEN IS TO MATCH COMPLIANCE WITH THE RELEVANT BASIX CERTIFICATE.

PLIABLE BUILDING MEMBRANE INSTALLED IN EXTERNAL WALLS TO BE A VAPOR PERMEABLE TYPE, COMPLY WITH AS/NZS 4200.1 AND BE INSTALLED AS PER AS4200.2

EXTERNAL DOORS AND OPENABLE WINDOWS IN CONDITIONED SPACES TO BE SEALED TO RESTRICT AIR INFILTRATION AS PER PART 3.12.3 NCC 2019

* NOTE: EXTERNAL LIGHTING

ALL EXTERNAL LIGHT FITTINGS ARE TO BE SHIELDED.

I.E. DOES NOT PERMIT LIGHT TO SHINE ABOVE THE HORIZONTAL PLANE.

* ALL DIMENSIONS ARE TO BE CONFIRMED BY THE BUILDER PRIOR TO CONSTRUCTION. DO NOT SCALE FROM DRAWINGS. BUILDING SET OUT & SITE BOUNDARY DETAILS TO BE CONFIRMED BY A REGISTERED SURVEYOR. ALL WORK TO BE CARRIED OUT TO RELEVANT STANDARDS AND BUILDING CODES.

MAAS PROPERTIES

| SHEET: | JOB No: | ISSUE: |
|----------|------------|--------|
| 17.12.21 | 1:100 (A3) | WP |
| DATE: | SCALE: | DRAWN: |

Н


21085


3 / 8


DRAWING: FLOOR PLAN - DWELLING B LOT 66 THE LOGAN, MUDGEE MAAS GROUP PROPERTIES





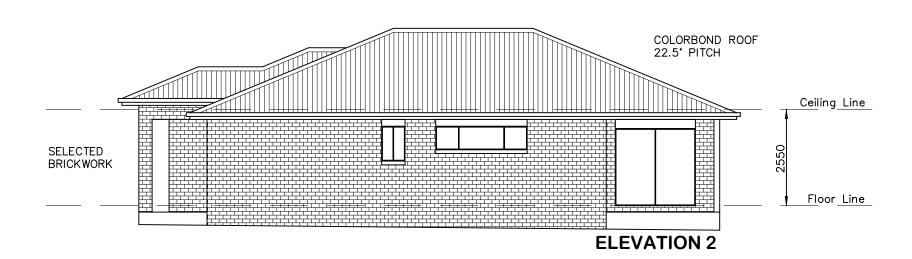

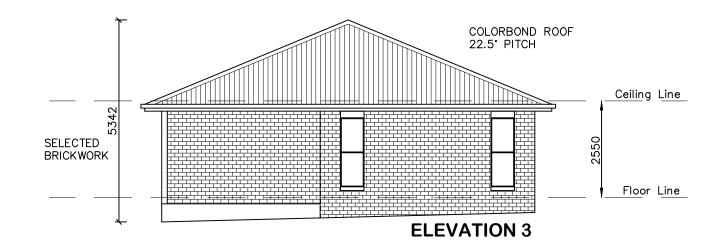

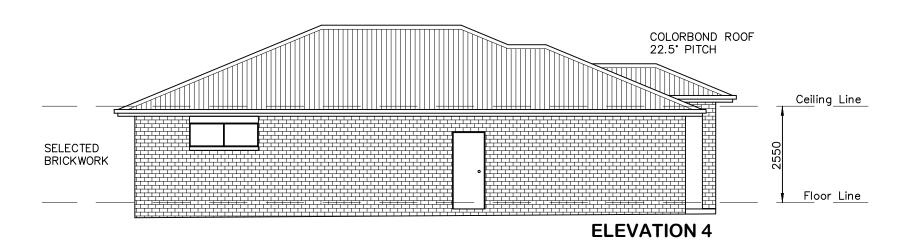

* ALL DIMENSIONS ARE TO BE CONFIRMED BY THE BUILDER PRIOR TO CONSTRUCTION.
DO NOT SCALE FROM DRAWINGS.
BUILDING SET OUT & SITE BOUNDARY DETAILS TO BE CONFIRMED BY A REGISTERED SURVEYOR.
ALL WORK TO BE CARRIED OUT TO RELEVANT STANDARDS AND BUILDING CODES.


"TAMWORTH SG"



| DATE: | SCALE: | DRAWN: |
|----------|------------------|--------|
| 17.12.21 | 1:100 (A3) | WP |
| SHEET: | JOB No: 21085 | ISSUE: |

DRAWING: ELEVATIONS - DWELLING B LOT 66 THE LOGAN, MUDGEE **MAAS GROUP PROPERTIES**



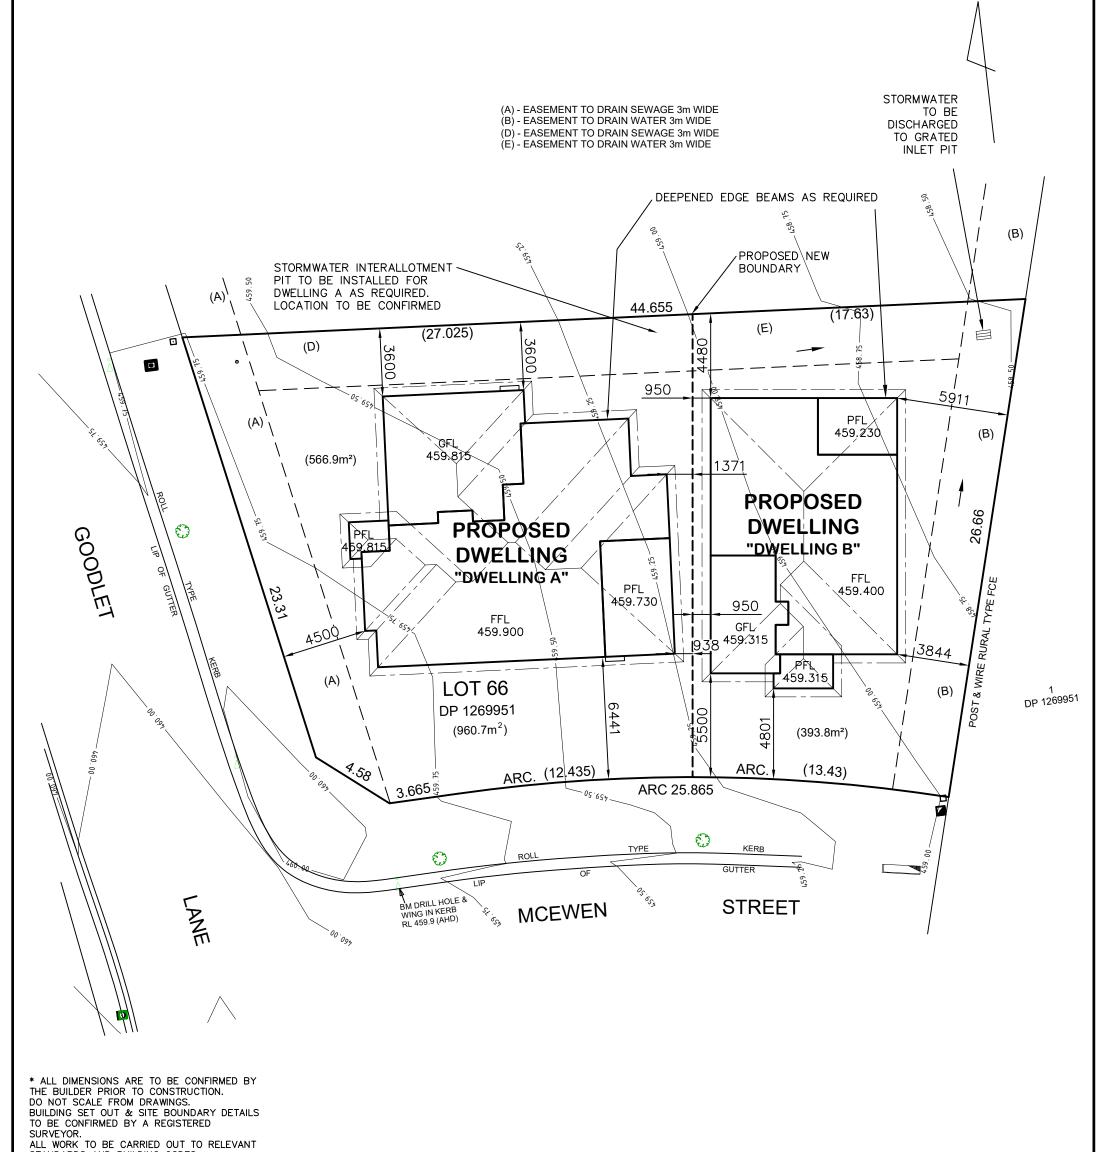

STANDARDS AND BUILDING CODES.

* ALL SURFACE LEVELS AND FEATURE LOCATIONS ARE TO BE CONFIRMED PRIOR TO CONSTRUCTION

THE PROPOSED RESIDENCE SLAB IS TO BE CONSTRUCTED ON A LEVEL BUILDING PAD PREPARED IN ACCORDANCE WITH THE STRUCTURAL ENGINEER'S SPECIFICATIONS. THE MAIN FINISHED FLOOR LEVEL IS TO BE SET MINIMUM 300mm ABOVE THE CONSTRUCTION PAD LEVEL. FINISHED SURFACE LEVELS ARE TO GRADE AWAY FROM THE BUILDING PERIMETER TO PREVENT WATER PONDING NEAR EXTERNAL WALLS WITHOUT BEING DETRIMENTAL TO NEIGHBOURING PROPERTIES NEIGHBOURING PROPERTIES.
THE BUILDER IS TO CONFIRM AVAILABLE FALLS TO SEWER
CONNECTION POINTS & STORMWATER DISCHARGE POINTS
PRIOR TO ESTABLISHING THE BUILDING FINISHED FLOOR LEVEL.


DENOTES DIRECTION OF SURFACE WATER ON COMPLETION OF LANDSCAPING.



| DATE: | SCALE: | DRAWN: |
|----------|------------------|--------|
| 17.12.21 | 1:200 (A3) | WP |
| SHEET: | JOB No: 21085 | ISSUE: |

DRAWING: SITE PLAN **LOT 66 THE LOGAN, MUDGEE MAAS GROUP PROPERTIES**



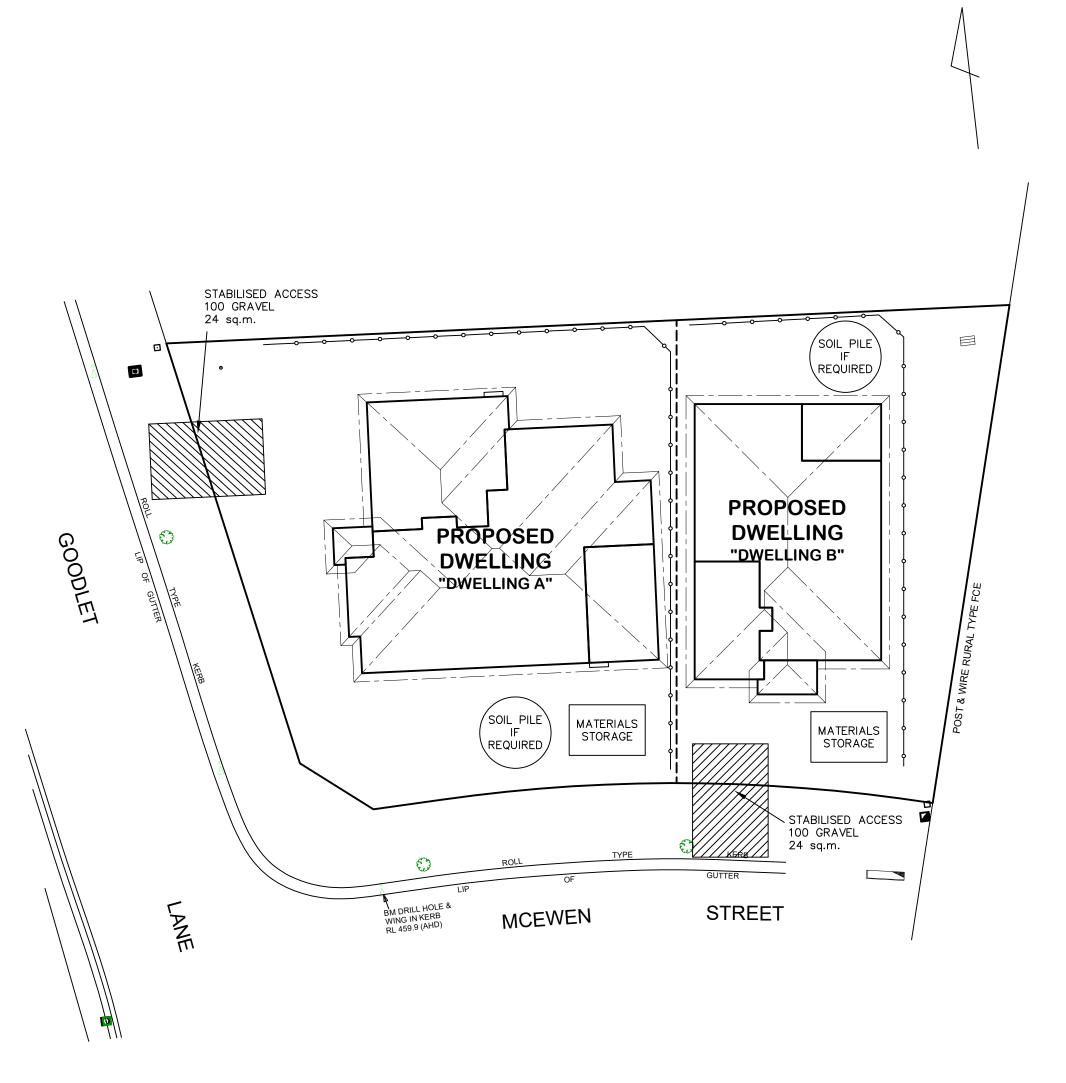

- * ALL DIMENSIONS ARE TO BE CONFIRMED BY THE BUILDER PRIOR TO CONSTRUCTION.

 DO NOT SCALE FROM DRAWINGS.

 DITTORNO SET OUT 18 SITE POUNDARY. & SITE BOUNDARY DETAILS TO BE CONFIRMED BY A REGISTERED SURVEYOR.
 ALL WORK TO BE CARRIED OUT TO RELEVANT STANDARDS AND BUILDING CODES.
- * ALL SURFACE LEVELS AND FEATURE LOCATIONS ARE TO BE CONFIRMED PRIOR TO CONSTRUCTION
- * THE PROPOSED RESIDENCE SLAB IS TO BE CONSTRUCTED ON A LEVEL BUILDING PAD PREPARED IN ACCORDANCE WITH THE STRUCTURAL ENGINEER'S SPECIFICATIONS.
 THE MAIN FINISHED FLOOR LEVEL IS TO BE SET MINIMUM
 300mm ABOVE THE CONSTRUCTION PAD LEVEL.
 FINISHED SURFACE LEVELS ARE TO GRADE AWAY FROM THE
 BUILDING PERIMETER TO PREVENT WATER PONDING
 NEAR EXTERNAL WALLS WITHOUT BEING DETRIMENTAL TO

NEIGHBOURING PROPERTIES.

THE BUILDER IS TO CONFIRM AVAILABLE FALLS TO SEWER
CONNECTION POINTS & STORMWATER DISCHARGE POINTS
PRIOR TO ESTABLISHING THE BUILDING FINISHED FLOOR LEVEL.

NOTES:

- 1. ALL RUNOFF & SEDIMENT CONTROL STRUCTURES TO BE MAINTAINED IN A FUNCTIONAL CONDITION.
- 2. ALL VEGETATION OUTSIDE THE DWELLING SITE WILL BE RETAINED.

→ SEDIMENT FENCE

| AAG |
|------------|
| PROPERTIES |
| PROPERTIES |

| DATE: | SCALE: | DRAWN: |
|----------|------------|--------|
| 17.12.21 | 1:200 (A3) | WP |
| SHEET: | JOB No: | ISSUE: |

Н

21085

6 / 8

DRAWING: EROSION & SEDIMENT CONTROL PLAN LOT 66 THE LOGAN, MUDGEE MAAS GROUP PROPERTIES



DWELLING A LANDSCAPING DETAILS

CONCRETE PATH

GRAVEL EDGE BED

565.7 m² SITE AREA: GRAVEL TO SIDE: 2.8 m² 40.4 m² **GARDEN BEDS:** (LOW WATER GARDEN) TURF: 201.0 m² DRIVEWAY AREA: 82.1 m² 59.6 m² PATH AREA:

NOTE - QUANTITIES ARE PROVIDED AS A GUIDE ONLY AND NOT TO BE RELIED UPON FOR CONTRACTUAL PURPOSES

DWELLING B LANDSCAPING DETAILS

GRAVEL TO SIDE: 3.8 m² 30.4 m² GARDEN BEDS: (LOW WATER GARDEN) TURF: 150.2 m² DRIVEWAY AREA: 33.4 m^2 PATH AREA: 47.2 m²

1800 HIGH COLORBOND FENCE & GATE

TURF

395.1 m²

CONCRETE PATH

GRAVEL EDGE BED

PROPOSED


DWELLING

"DWELLING B"

34

*

SITE AREA:

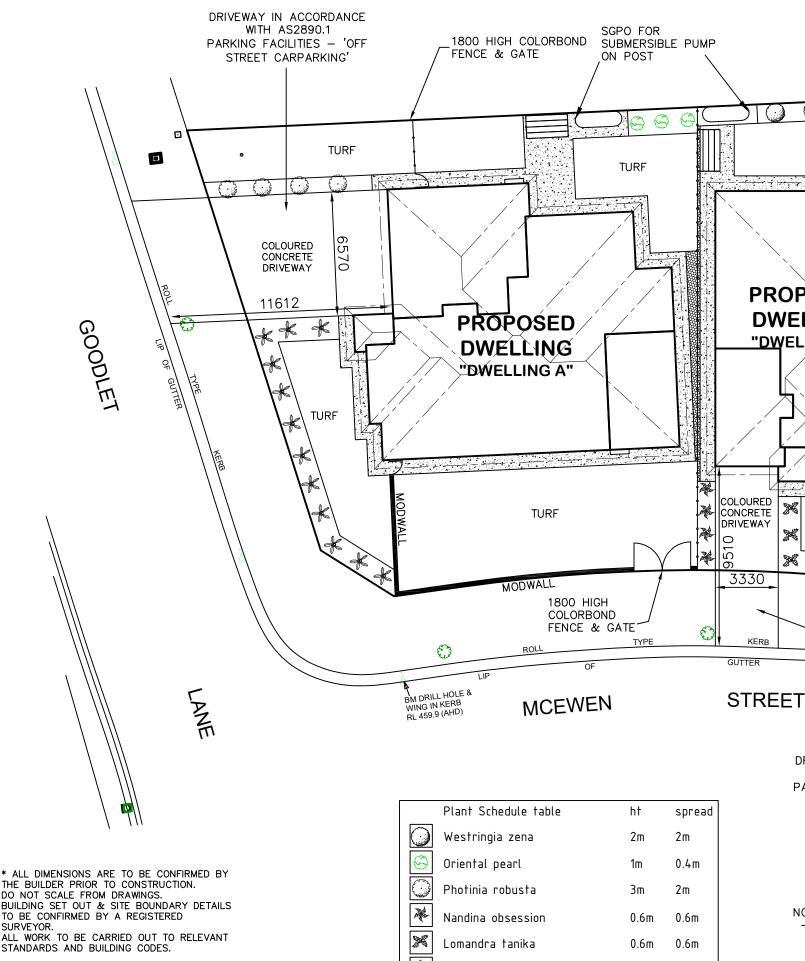

THE BUILDER PRIOR TO CONSTRUCTION. DO NOT SCALE FROM DRAWINGS. TO BE CONFIRMED BY A REGISTERED SURVEYOR. ALL WORK TO BE CARRIED OUT TO RELEVANT

ALL SURFACE LEVELS AND FEATURE LOCATIONS ARE TO BE CONFIRMED PRIOR TO CONSTRUCTION

THE PROPOSED RESIDENCE SLAB IS TO BE CONSTRUCTED. ON A LEVEL BUILDING PAD PREPARED IN ACCORDANCE WITH THE STRUCTURAL ENGINEER'S SPECIFICATIONS. THE MAIN FINISHED FLOOR LEVEL IS TO BE SET MINIMUM 300mm ABOVE THE CONSTRUCTION PAD LEVEL. FINISHED SURFACE LEVELS ARE TO GRADE AWAY FROM THE BUILDING PERIMETER TO PREVENT WATER PONDING NEAR EXTERNAL WALLS WITHOUT BEING DETRIMENTAL TO

THE BUILDER IS TO CONFIRM AVAILABLE FALLS TO SEWER CONNECTION POINTS & STORMWATER DISCHARGE POINTS PRIOR TO ESTABLISHING THE BUILDING FINISHED FLOOR LEVEL.

Viburnum tinus 1.5m 1m

LEGEND:

A/C LOCATION TO BE CONFIRMED ON SITE

3000L POLY RAINWATER TANK

CLOTHESLINE

ALL GARDEN BEDS MULCHED WITH 50MM THICKNESS OF SELECTED BARK CHIPS.

TURF

DRIVEWAY IN ACCORDANCE WITH AS2890.1 PARKING FACILITIES - 'OFF STREET CARPARKING'

AREAS NOT DESIGNATED AS GARDEN OR HARDSTAND ARE TO BE TURFED AS NOTED

LANDSCAPING MAINTENANCE AND

<u>ESTABLISHMENT</u>

- WATER UNTIL ESTABLISHED. MULCH AND APPLY SLOW RELEASE FERTILISER IN SPRING. MAINTENANCE TO BE OWNERS RESPONSIBILITY AFTER PRACTICAL COMPLETION.



| DATE: | SCALE: | DRAWN: |
|----------|------------|--------|
| 17.12.21 | 1:200 (A3) | WP |
| SHEET: | JOB No: | ISSUE: |

Н

21085

7 / 8

DRAWING: BASIX COMMITMENTS PLAN LOT 66 THE LOGAN, MUDGEE MAAS GROUP PROPERTIES




BASIX COMMITMENTS - DWELLING A BASIX COMMITMENTS - DWELLING B WATER COMMITMENTS LANDSCAPE AREA LOW WATER USE SPECIES OF VEGETATION 40.4 SQ.M. MIN RATING FIXTURES
SHOWER HEAD RATING
TOILET FLUSHING SYSTEM RATING
KITCHEN TAPS 4 STAR 4 STAR 5 STAR BASIN TAPS ALTERNATIVE WATER RAINWATER TANK RAINWATER TANK CAPACITY 3000 LITRE ROOF COLLECTION AREA FOR R/W R/W TANK CONNECTED TO MIN 1 No. OUTDOOR TAP ALL TOILETS IN DWELLING
THE COLD WATER TAP THAT SUPPLIES THE CLOTHES WASHER THERMAL COMFORT COMMITMENTS CLASS 1 DWELLING WITH NOT MORE THAN 2 STOREYS
CONDITIONED FLOOR AREA NOT EXCEEDING 300 SQUARE METRES
MUST NOT HAVE OPEN MEZZANINE OF MORE THAN 25 SQUARE METRES
NOT CONTAIN THIRD LEVEL HABITABLE ATTIC ROOM GENERAL REQUIREMENTS -GROUND FLOOR CONSTRUCTION CONCRETE SLAB ON GROUND BRICK VENEER — R2.60 INC CONSTRUCTION EXTERNAL WALL INTERNAL WALL SHARED WITH GARAGE CEILING AND ROOF FLAT CEILING/PITCHED ROOF - CEILING R4, ROOF - SARKING - UNVENTILATED - DARK (SOLAR ABSORPTANCE > 0.7) Thermal comfort commitments — Windows & Glazed Doors WINDOW ORIENTATION MAXIMUM MAXIMUM SHADING OVERSHADOWING HEIGHT (mm) WIDTH (mm) ALUMINIUM, SINGLE, CLEAR W01 400 EAVE 600mm, 180mm ABOVE HEAD OF WINDOW OR GLAZED DOOR NOT OVERSHADOWED ALUMINIUM, SINGLE, CLEAR EAVE 600mm, 180mm ABOVE HEAD W02 Ε 1200 1500 NOT Overshadowed WINDOW OR GLAZED DOOF EAVE 600mm, 180mm ABOVE HEAD OF WINDOW OR GLAZED DOOR W03 Ε 1200 1500 ALUMINIUM. SINGLE, CLEAR NOT Overshadowed EAVE 4280mm, 180mm ABOVE HEAD OF WINDOW OR GLAZED DOOR W04 ALUMINIUM, SINGLE, CLEAR Ε 1800 800 OVERSHADOWED Ε ALUMINIUM, SINGLE, CLEAR EAVE 4280mm, 240mm ABOVE HEAD OF WINDOW OR GLAZED DOOR NOT OVERSHADOWED W05 2400 EAVE 600mm, 180mm ABOVE HEAD OF WINDOW OR GLAZED DOOR W06 S 1800 1500 ALUMINIUM, SINGLE, CLEAR NOT Overshadowed EAVE 600mm, 180mm ABOVE HEAD OF WINDOW OR GLAZED DOOR 900 900 ALUMINIUM, SINGLE, CLEAR W07 S NOT OVERSHADOWED EAVE 600mm, 180mm ABOVE HEAD OF WINDOW OR GLAZED DOOR ALUMINIUM, SINGLE, CLEAR W08 1800 2400 NOT OVERSHADOWED ENERGY COMMITMENTS HOT WATER SYSTEM GAS INSTANTANEOUS - 5 STAR REVERSE CYCLE: EER 3.0–3.5 WITH DAY/NIGHT ZONING BETWEEN LIVING/BED AREAS REVERSE CYCLE: EER 3.0–3.5 WITH DAY/NIGHT ZONING BETWEEN LIVING/BED AREAS COOLING SYSTEM HEATING SYSTEM
VENTILATION
BATHROOM EXTRACT FAN DUCTED TO ROOF OR FACADE — MANUAL ON/OFF EXTRACT FAN DUCTED TO ROOF OR FACADE — MANUAL ON/OFF NATURAL VENTILATION ONLY KITCHEN ARTIFICIAL LIGHTING KITCHEN BATHROOMS/TOILETS PRIMARY TYPE OF ARTIFICIAL LIGHTING IS FLUORESCENT OR LIGHT EMITTING DIODE (LED) PRIMARY TYPE OF ARTIFICIAL LIGHTING IS FLUORESCENT OR LIGHT EMITTING DIODE (LED) PRIMARY TYPE OF ARTIFICIAL LIGHTING IS FLUORESCENT OR LIGHT EMITTING DIODE (LED) LAUNDRY PRIMARY TYPE OF ARTIFICIAL LIGHTING IS FLUORESCENT OR LIGHT EMITTING DIODE (LED)
PRIMARY TYPE OF ARTIFICIAL LIGHTING IS FLUORESCENT OR LIGHT EMITTING DIODE (LED) X 2
PRIMARY TYPE OF ARTIFICIAL LIGHTING IS FLUORESCENT OR LIGHT EMITTING DIODE (LED) X 4 HALLWAYS LIVING AREAS BEDROOMS NATURAL LIGHTING KITCHEN
BATHROOMS/TOILETS WINDOW x 2 **APPLIANCES** KITCHEN REFRIGERATOR SPACE WELL VENTILATED AS BASIX DEFINITION CLOTHES DRYING OUTDOOR CLOTHES DRYING LINE

WATER COMMITMENTS
LANDSCAPE
AREA LOW WATER USE SPECIES OF VEGETATION FIXTURES
SHOWER HEAD RATING
TOILET FLUSHING SYSTEM RATING
KITCHEN TAPS 4 STAR 4 STAR 5 STAR BASIN TAPS
ALTERNATIVE WATER
RAINWATER TANK
RAINWATER TANK CAPACITY 3000 LITRE ROOF COLLECTION AREA FOR R/W R/W TANK CONNECTED TO MIN 1 No. OUTDOOR TAP ALL TOILETS IN DWELLING
THE COLD WATER TAP THAT SUPPLIES THE CLOTHES WASHER THERMAL COMFORT COMMITMENTS CLASS 1 DWELLING WITH NOT MORE THAN 2 STOREYS
CONDITIONED FLOOR AREA NOT EXCEEDING 300 SQUARE METRES
MUST NOT HAVE OPEN MEZZANINE OF MORE THAN 25 SQUARE METRES GENERAL REQUIREMENTS NOT CONTAIN THIRD LEVEL HABITABLE ATTIC ROOM GROUND FLOOR CONSTRUCTION EXTERNAL WALL CONCRETE SLAB ON GROUND BRICK VENEER - R2.60 INC CONSTRUCTION INTERNAL WALL SHARED WITH GARAGE FLAT CEILING/PITCHED ROOF - CEILING R5, ROOF - SARKING - UNVENTILATED - DARK (SOLAR ABSORPTANCE > 0.7) CEILING AND ROOF THERMAL COMFORT COMMITMENTS — WINDOWS & GLAZED DOORS MAXIMI IM WINDOW ORIENTATION MAXIMUM SHADING OVERSHADOWING HEIGHT (mm) WIDTH (mm) W01 1800 ALUMINIUM, SINGLE, CLEAR EAVE 600mm, 180mm ABOVE HEAD OF WINDOW OR GLAZED DOOR NOT OVERSHADOWED EAVE 600mm, 180mm ABOVE HEAD OF WINDOW OR GLAZED DOOR ALUMINIUM, SINGLE, CLEAR W02 1800 600 NOT Overshadowed EAVE 4790mm, 240mm ABOVE HEAD OF WINDOW OR GLAZED DOOR W03 Ε 2100 2100 ALUMINIUM, SINGLE, CLEAR NOT Overshadowed EAVE 600mm, 180mm ABOVE HEAD OF WINDOW OR GLAZED DOOR W04 2400 ALUMINIUM, SINGLE, CLEAR NOT OVERSHADOWED Ε 600 Ε ALUMINIUM, SINGLE, CLEAR EAVE 600mm, 180mm ABOVE HEAD OF WINDOW OR GLAZED DOOR W05 900 NOT Overshadowed EAVE 600mm, 180mm ABOVE HEAD OF WINDOW OR GLAZED DOOR W06 S 1800 900 ALUMINIUM, SINGLE, CLEAR not Overshadowed ALUMINIUM, SINGLE, CLEAR EAVE 600mm, 180mm ABOVE HEAD OF WINDOW OR GLAZED DOOR 1800 900 NOT OVERSHADOWED W07 S EAVE 600mm, 180mm ABOVE HEAD OF WINDOW OR GLAZED DOOR ALUMINIUM, SINGLE, CLEAR NOT OVERSHADOWED W08 600 1800 ENERGY COMMITMENTS HOT WATER SYSTEM GAS INSTANTANEOUS - 5 STAR COOLING SYSTEM
HEATING SYSTEM
VENTILATION
BATHROOM REVERSE CYCLE: EER 3.5—4.0 WITH DAY/NIGHT ZONING BETWEEN LIVING/BED AREAS REVERSE CYCLE: EER 3.5—4.0 WITH DAY/NIGHT ZONING BETWEEN LIVING/BED AREAS Extract fan ducted to roof or facade — Manual on/off extract fan ducted to roof or facade — Manual on/off extract fan ducted to roof or facade — Manual on/off KITCHEN ARTIFICIAL LIGHTING KITCHEN BATHROOMS/TOILETS LAUNDRY PRIMARY TYPE OF ARTIFICIAL LIGHTING IS FLUORESCENT OR LIGHT EMITTING DIODE (LED) (DEDICATED)
PRIMARY TYPE OF ARTIFICIAL LIGHTING IS FLUORESCENT OR LIGHT EMITTING DIODE (LED) (DEDICATED)
PRIMARY TYPE OF ARTIFICIAL LIGHTING IS FLUORESCENT OR LIGHT EMITTING DIODE (LED) (DEDICATED)
PRIMARY TYPE OF ARTIFICIAL LIGHTING IS FLUORESCENT OR LIGHT EMITTING DIODE (LED) X 2 (DEDICATED)
PRIMARY TYPE OF ARTIFICIAL LIGHTING IS FLUORESCENT OR LIGHT EMITTING DIODE (LED) X 2 (DEDICATED)
PRIMARY TYPE OF ARTIFICIAL LIGHTING IS FLUORESCENT OR LIGHT EMITTING DIODE (LED) X 2 (DEDICATED) HALLWAYS LIVING AREAS BEDROOMS NATURAL LIGHTING KITCHEN
BATHROOMS/TOILETS WINDOW x 1 **APPLIANCES** CAS COOKTOP & ELECTRIC OVEN
WELL VENTILATED AS BASIX DEFINITION
OUTDOOR & INDOOR CLOTHES DRYING LINE KITCHEN REFRIGERATOR SPACE CLOTHES DRYING

These are the specifications upon which the Basix assessment is based. These specifications take precedence over the drawings or other specifications.


These are the specifications upon which the Basix assessment is based. These specifications take precedence over the drawings or other specifications.

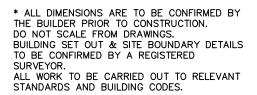

- * ALL SURFACE LEVELS AND FEATURE LOCATIONS ARE TO BE CONFIRMED PRIOR TO CONSTRUCTION
- * THE PROPOSED RESIDENCE SLAB IS TO BE CONSTRUCTED ON A LEVEL BUILDING PAD PREPARED IN ACCORDANCE WITH THE STRUCTURAL ENGINEER'S SPECIFICATIONS. THE MAIN FINISHED FLOOR LEVEL IS TO BE SET MINIMUM 300mm ABOVE THE CONSTRUCTION PAD LEVEL. FINISHED SURFACE LEVELS ARE TO GRADE AWAY FROM THE BUILDING PERIMETER TO PREVENT WATER PONDING NEAR EXTERNAL WALLS WITHOUT BEING DETRIMENTAL TO NEIGHBOURING PROPERTIES.

THE BUILDER IS TO CONFIRM AVAILABLE FALLS TO SEWER CONNECTION POINTS & STORMWATER DISCHARGE POINTS PRIOR TO ESTABLISHING THE BUILDING FINISHED FLOOR LEVEL.

8 / 8

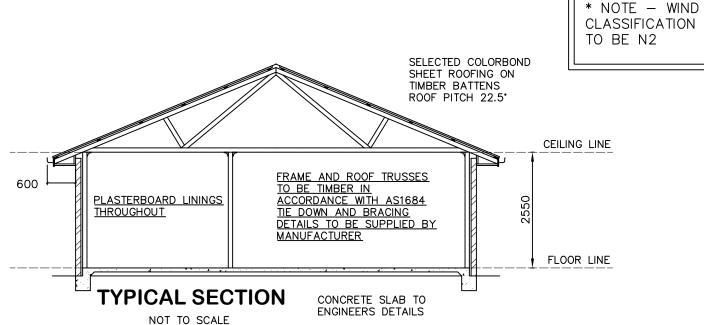



DATE: SCALE: DRAWN: 17.12.21 N / A WP

SHEET: JOB No: ISSUE:

Н

21085

DRAWING:
BASIX COMMITMENTS & TYP SECTION
LOT 66 THE LOGAN, MUDGEE
MAAS GROUP PROPERTIES

