

Proposed Detached Dual Occupancy Lot 407, 4 Suttor Avenue Caerleon NSW 2850

| DRAWING  | SCHEDULE - FILE NO: 0462-A01                  |
|----------|---|
| 0462-A01 | TITLE SHEET                                   |
| 0462-A02 | BASIX COMMITMENTS                             |
| 0462-A03 | LOCATION, SITE, SUBDIVISION \$ LANDSCAPE PLAN |
| 0462-A04 | FLOOR PLAN - DWELLING ONE                     |
| 0462-A05 | FLOOR PLAN - DWELLING TWO                     |
| 0462-A06 | ELEVATIONS - DWELLING ONE                     |
| 0462-A07 | ELEVATIONS - DWELLING TWO                     |
| 0462-A08 | SECTION & GENERAL NOTES                       |
| 0462-A09 | ELECTRICAL \$ MECHANICAL PLANS - DWELLING ONE |
| 0462-A10 | ELECTRICAL ¢ MECHANICAL PLANS - DWELLING TWO  |

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| NLV.    | DAIL   | DEJUNI TION  | NOIL:   |
|---------|--|--|---|
| A B C D | 23/09/2021<br>15/10/2021<br>11/02/2022<br>22/02/2022 | FINAL PLANS FOR REVIEW<br>REVISED PLANS FOR REVIEW<br>FINAL PLANS REVISED AS REQUESTED<br>FINAL PLANS FOR PCA APPROVAL | ALL DRAWINGS TO BE READ IN CONJUNCTION WITH  WITH  STEPS TO THIS SET OF PLANS  SEPERATE SPECIFICATION DOCUMENTS  STELUTURAL ENGINEERS DOCUMENTATION  PAG DOCUMENTS  BASIN CERTIFICATION  ALL PETERATE CAPPLOABLE. |



LYNCH BUILDING GROUP CUENT: PROPOSED DETACHED DUAL OCCUPANCY LOT 407, 4 SUTTOR AVENUE CAERLEON NSW 2850 PROJECT:





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|                                   |

|                | TITLE SHEET |
|----------------|-------------|
| DRAWING TITLE: |             |

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|   | CHECKED:   | A.LYNCH | PAPER SIZE: | A3     | DRAW | NG NO: |    |

# BASIX COMMITMENTS - Dwelling One

### THERMAL COMFORT

- > See Typical Section, Floor Plan and Basix Certificate for further Thermal Comfort Commitments.
- > The proposed construction must have the following applied to the floors, walls and ceiling / roof of the dwelling.

| CONSTRUCTION                                    | ADDITIONAL INSULATION REQUIRED               | OTHER  |
|---|--|--|
| Floor - concrete slab on ground                 | Nil  |  |
| External wall - brick veneer/framed \$ cladded  | R2.06/R2.2 (or R2.60 including construction) |  |
| Internal wall shared with Garage - plasterboard | Nil  |  |
| Ceiling and roof - flat ceiling / pitched roof  | Ceiling: R4.0 (up), Roof: foil / sarking     | Unventilated; Dark (solar absorptance >0.70) |

OTHER:

ARTIFICIAL LIGHTING:

> The primary type of lighting in the following rooms must be fluorescent or LED:

> Each refrigerator space must be constructed so that it is well ventilated

- All hallways (dedicated)

- At least 3 of the bedrooms / study (dedicated)

> A fixed outdoor clothes drying line must be installed

> A rainwater tank of at least 2,000L capacity must be installed

> The rainwater tank must be connected to:

one outdoor tap in the development

> The rainwater tank must collect rainwater from at least 213.25m2 of the roof area

- The cold water tap that supplies each clothes washer, and at least

- The kitchen (dedicated)

- The laundry (dedicated)

- At least 2 of the living / dining rooms (dedicated)

### ENERGY

### HOT WATER

> A Gas Instantaneous Hot Water System must be installed with 4.5 star rating

### COOLING # HEATING SYSTEM: Day/night zoned

- > Living Area 1-phase air conditioning, 3.5 Star (cold zone)
- > Bedroom I-phase air conditioning, 3.5 Star (cold zone) VENTILATION EXHAUST SYSTEMS:
- > At least | Bathroom individual fan not ducted manual on/off
- > Kitchen individual fan, not ducted manual on/off
- > Laundry natural ventilation only.

> A window and / or skylight must be installed in 3 bathrooms / toilet(s) of the development

### NATURAL LIGHTING:

### GLAZING REQUIREMENTS

### WINDOWS # GLAZED DOORS

> The applicant must install all proposed windows, glazed doors and shading devices as listed within the Basix Certificate numbers listed above.

| WINDOW/DOOR NO. | ORIENTATION |                           |   | SHADING<br>(mm)  | TYPE                     |
|-----------------|-------------|---------------------------|---|------------------|--------------------------|
| Bed I, Living   | N           | 1.8x1.8 (x2)              | 0 | E-0.45, A/H-0.0  | Aluminium, single, clear |
| Laundry         | N           | 2.0x0.82                  | 0 | E-2.88, A/H-2.25 | Aluminium, single, clear |
| Living          | E           | 2.0x2.4                   | 0 | E-3.18, A/H-2.25 | Aluminium, single, clear |
| ENS             | E           | 0.9x 0.6                  | 0 | E-0.45, A/H-0.0  | Aluminium, single, clear |
| Entry, Bed 2    | 5           | 1.8x2.1 (x2)              | 0 | E-0.45, A/H-0.0  | Aluminium, single, clear |
| Bath, WC, Bed 3 | W           | 0.6x1.2, 0.6x0.9, 1.8x1.5 | 0 | E-0.45, A/H-0.05 | Aluminium, single, clear |
|                 |             |                           |   |                  |                          |

> Note: E = Eave | A/H = Above Head | S/O = Solid Overhang | A/B = Above Base

### WATER

- > Showerheads 4 Star (>4.5 <=6L/min)
- > Toilet Flushing System 5 Star Rating
- > Kitchen Taps 5 Star Rating
- > Bathroom Basin Taps 5 Star Rating

### LANDSCAPING

> Minimum of 3m2 of low water use species used in the development

### BASIX NOTES:

THE APPLICANT MUST COMPLY WITH THE BASIX COMMITMENTS WITHIN BASIX CERTIFICATE PROVIDED DURING THE CONSTRUCTION OF THIS PROPOSED DEVELOPMENT.

# THERMAL COMFORT

> See Typical Section, Floor Plan and Basix Certificate for further Thermal Comfort Commitments.

BASIX COMMITMENTS - Dwelling Two

> The proposed construction must have the following applied to the floors, walls and ceiling / roof of the dwelling.

| CONSTRUCTION                                    | ADDITIONAL INSULATION REQUIRED               | OTHER  |
|---|--|--|
| Floor - concrete slab on ground                 | Nil  |  |
| External wali - brick veneer/framed # cladded   | R2.06/R2.2 (or R2.60 including construction) |  |
| Internal wall shared with Garage - plasterboard | Nil  |  |
| Ceiling and roof - flat ceiling / pitched roof  | Ceiling: R4.0 (up), Roof: foil / sarking     | Unventilated; Dark (solar absorptance >0.70) |

ARTIFICIAL LIGHTING:

### **ENERGY**

### HOT WATER

> A Gas Instantaneous Hot Water System must be installed with 4.5 star rating

### COOLING # HEATING SYSTEM: Day/night zoned

- > Living Area 1-phase air conditioning, 3.5 Star (cold zone)
- > Bedroom I-phase air conditioning, 3.5 Star (cold zone) VENTILATION EXHAUST SYSTEMS:
- > At least | Bathroom individual fan not ducted manual on/off
- > Kitchen individual fan, not ducted manual on/off

### NATURAL LIGHTING:

> A window and / or skylight must be installed in 2 bathrooms / toilet(s) of the development

- > Laundry natural ventilation only.

### GLAZING REQUIREMENTS

### WINDOWS ¢ GLAZED DOORS

> The applicant must install all proposed windows, glazed doors and shading devices as listed within the Basix Certificate numbers listed above.

OTHER:

| WINDOW/DOOR NO.              | ORIENTATION |  | OVER-<br>SHADOWING |                  | TYPE                     |
|------------------------------|-------------|--|--------------------|------------------|--------------------------|
| Bed I, ENS                   | N           | 1.8x2.4, 0.9X0.6                       | 0                  | E-0.45, A/H-0.0  | Aluminium, single, clear |
| Living                       | N           | 2.0x2.4                                | 0                  | E-3.00, A/H-2.25 | Aluminium, single, clear |
| Living, Bed3, Kitchen, Meals | E           | 1.8x 1.5, 1.5x 1.5, 1.8x 0.6, 1.8x 1.5 | 0                  | E-0.45, A/H-0.0  | Aluminium, single, clear |
| Bed 4                        | 5           | 1.8x0.7 (x2)                           | 0                  | E-0.45, A/H-0.05 | Aluminium, single, clear |
| Bath, Laundry, Bed 2         | W           | 0.9x1.2, 2.0x1.5, 1.5x1.5              | 0                  | E-0.45, A/H-0.0  | Aluminium, single, clear |
|                              |             |  |                    |                  |                          |

> Note: E = Eave | A/H = Above Head | S/O = Solid Overhang | A/B = Above Base

### WATER

### **FIXTURES**

- > Showerheads 4 Star (>4.5 <=6L/min)
- > Toilet Flushing System 4 Star Rating
- > Kitchen Taps 4 Star Rating
- > Bathroom Basin Taps 4 Star Rating

### LANDSCAPING

> Minimum of 3m2 of low water use species used in the development

- > A rainwater tank of at least 2,000L capacity must be installed
- > The rainwater tank must collect rainwater from at least 195.86m2 of the roof area

> The primary type of lighting in the following rooms must be fluorescent or LED:

> Each refrigerator space must be constructed so that it is well ventilated

- All hallways (dedicated)

- At least 4 of the bedrooms / study (dedicated)

> A fixed outdoor clothes drying line must be installed

- The kitchen (dedicated)

- The laundry (dedicated)

- At least 2 of the living / dining rooms (dedicated)

- > The rainwater tank must be connected to:
  - The cold water tap that supplies each clothes washer, and at least one outdoor tap in the development

### BASIX NOTES:

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| В   | 15/10/2021 | REVISED PLANS FOR REVIEW         |
| С   | 11/02/2022 | FINAL PLANS REVISED AS REQUESTED |
| D   | 22/02/2022 | FINAL PLANS FOR PCA APPROVAL     |
|     |            |                                  |

ALL DRAWINGS TO BE READ IN CONJUNCTION 17H -ALL SHEETS TO THIS SET OF PLANS SEPERATE SPECIFICATION DOCUMENTS STRUCTURAL ENGINEERS DOCUMENTATION PCA DOCUMENTS (WHERE APPLICABLE) BASIX CERTIFICATE ALL RELEVANT CODES, STANDARDS & APPROVAL ALL RELEVANT CODES,



LYNCH BUILDING GROUP PROPOSED DETACHED DUAL OCCUPANCY LOT 407, 4 SUTTOR AVENUE CAERLEON NSW 2850






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BASIX COMMITMENTS


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THE CONTOURS OF THE SITE, BUT
AS SHOWN IN THE DRAWING TO
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THE DESIGN STORM EVENT,

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CTIONS OF FABRIC AT A SUPPORT POST WITH A VERLAP.

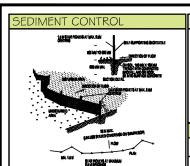

CONSTRUCTION NOTES
1. INSTALL FILTERS TO KERB INLETS ONLY AT SAG POINTS.
2. FABRICATE A SLEEVE MADE FROM GEOTEXTILE OR WIRE MESH LONGER THAN THE LENGTH OF THE INLET PIT AND FILL IT WITH 25 MM TO 50 MM GRAVEL. 3. FORM AN ELLIPTICAL CROSS-SECTION ABOUT 150 MM

HIGH X 400 MM WIDE.

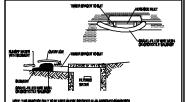HIGH X 400 MM WIDE.

4. PLACE THE FILTER AT THE OPENING LEAVING AT LEAST A
100-MM SPACE BETWEEN IT AND THE KERB INLET.
MAINTAIN THE OPENING WITH SPACER BLOCKS. 5. FORM A SEAL WITH THE KERB TO PREVENT SEDIMENT BYPASSING THE FILTER.

. SANDBAGS FILLED WITH GRAVEL CAN SUBSTITUTE FOR THE MESH OR GEOTEXTILE PROVIDING THEY ARE PLACED SO THAT THEY FIRMLY ABUT EACH OTHER AND SEDIMENT-LADEN WATERS CANNOT PASS BETWEEN.

### SITE NOTES

- CONFIRM ALL DIMENSIONS ON SITE TO EXISTING RESIDENCE PRIOR TO COMMENCEMENT OF ANY WORK. THIS PLAN DOES NOT PROVIDE SPECIFIC LANDSCAPE
- PLANTING LOCATIONS THE EXACT LOCATION OF UNDERGROUND AND ABOVEGROUND SERVICES SHALL BE PROVEN ON SITE. NO GUARANTEE IS GIVEN THAT ALL EXISTING SERVICES
- ARE SHOWN THIS DRAWING SET TO BE READ IN CONJUNCTION WITH
- THE SPECIFICATION PROVIDED.

  BEWARE OF EXISTING SERVICES, CONFIRM LOCATIONS
- PRIOR TO EXCAVATION. TAKE EXTREME CARE

### I FGFND

TEMPORARY SITE MATERIAL DISPOSAL ARE DURING CONSTRUCTION. TO BE PROTECTED BY A SEDIMENT FENCE OR STRAW BALE FILTER.

SITE ACCESS DURING CONSTRUCTION.

### SITE COVERAGE

TOTAL GEA EXCLUDING PORCH & ALFRESCO = 327 92M

LANDSCAPING LANDSCAPING - INCLUDING GRAVEL AREAS

= 701.56M<sup>2</sup> = 101.89M<sup>2</sup> = 599.67M<sup>2</sup>

56.25%

# SUBDIVISION NOTES

OT 407 SUTTOR AVENUE CAERLEON DP - 1272614 - ZONING RT GENERAL RESIDENTIAL

TOTAL LOT 407 AREA = 1066.00M PROPOSED LOT L (DWELLING ONE) PROPOSED LOT 2 (DWELLING TWO) 605.50M

- CONFIRM ALL DIMENSIONS BACK TO SPECIFIC SURVEY PLANS PRIOR TO COMMENCEMENT OF ANY WORK.
- . PROPOSED DIVIDING SUBDIVISION BOUNDARY IS APPROXIMATE ONLY AND TO BE CONFIRMED AS ABOVE PROPOSED LOT AREAS ARE APPROXIMATE ONLY & SHOULE
  BE READ IN CONJUNCTION WITH SPECIFIC SURVEY PLANS.

### LANDSCAPING DETAILS

## SURFER BOY (PHORMIUM)

- BRONZE BABY (PHORIUM)
- GOLF BABY (PITTOSPORUM)
   GOLF BABY (PITTOSPORUM)
   SMALL ORNAMENTAL TREES TO 3.0M HIGH
   MANCHURIAN PEAR (PYRUS USSURIENSIS)

CONSULT LOCAL NURSERY FOR AVAILABILITY AND BUITABILITY OF THE SPECIES LISTED & SUBSTITUTE SIMILAR PLANTING IF REQUIRED.

MULCH BEDS WITH WOODCHIP OR PEBBLES & FILL OUT OR LINE BEDS WITH GROUND COVERS OR SIMILAR SMALL

EDGE BEDS WITH INSITU FORMED CONCRETE ROLLED EDGE, SLEEPERS, MASONRY BLOCK EDGING OR SIMILAR AS SELECTED.

KIKUYU TURF TO ALL AREAS, UNLESS GRAVEL IS STATED AND DISPLAYED OTHERWISE.

AT BUILDERS DISCRETION SUBSTITUTE SHRUBS AND TREES MAY BE USED TO REPLACE THE ABOVE MENTIONED SPECIES AND ALSO THE LOCATION OF GARDEN BEDS. SHOULD THE SITE LEAD TO AN ALTERNATIVE / MORE SUITABLE OPTION.



-SITE LOCATION - LOT 407 SUTTOR AVENUE "CAERLEON ESTATE", CAERLEON NSW 2850

SCALE: NTS

ALL DRAWINGS TO BE READ IN CONJUNCTION

WITH ALL SHEETS TO THIS SET OF PLANS
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AVENUE

SUTTOR

BOUNDARY 36 005M OUTDOOR CLOTHES DRYING LINE - SEWER EASEMENT TO 3.0M WIDE X 20M LONG PRIVATE OPEN SPACE RIVATE OPEN SPACE 3.0M ACCE: GATE FIXED MAIL BOX -H BOUNDARY B. 93 (ARC AVENUE FIXED MAIL BOX AS SELECTED

23.25M

PROPOSED NEW BOUNDARY - LOT 2

LOCATION PLAN

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15/10/2021 REVISED PLANS FOR REVIEW FINAL FLANS REVISED AS REQUESTED 11/02/2022 22/02/2022 FINAL PLANS FOR PCA APPROVAL

**BUILDING DESIGNERS** 

LYNCH BUILDING GROUP PROPOSED DETACHED DUAL OCCUPANCY LOT 407, 4 SUTTOR AVENUE CAERLEON NSW 2850



SITE, LANDSCAPE & SUBDIVISION PLAN

LYNCH BUILDING GROUP

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ILE NO: 0462-A0 DESIGN: LBG DRAFTED: J.LYNCH CHECKED: ALYNCH PAPER SIZE: A3 DRAWING NO:


12.75M

PROPOSED NEW BOUNDARY - LOT

03 OF 10





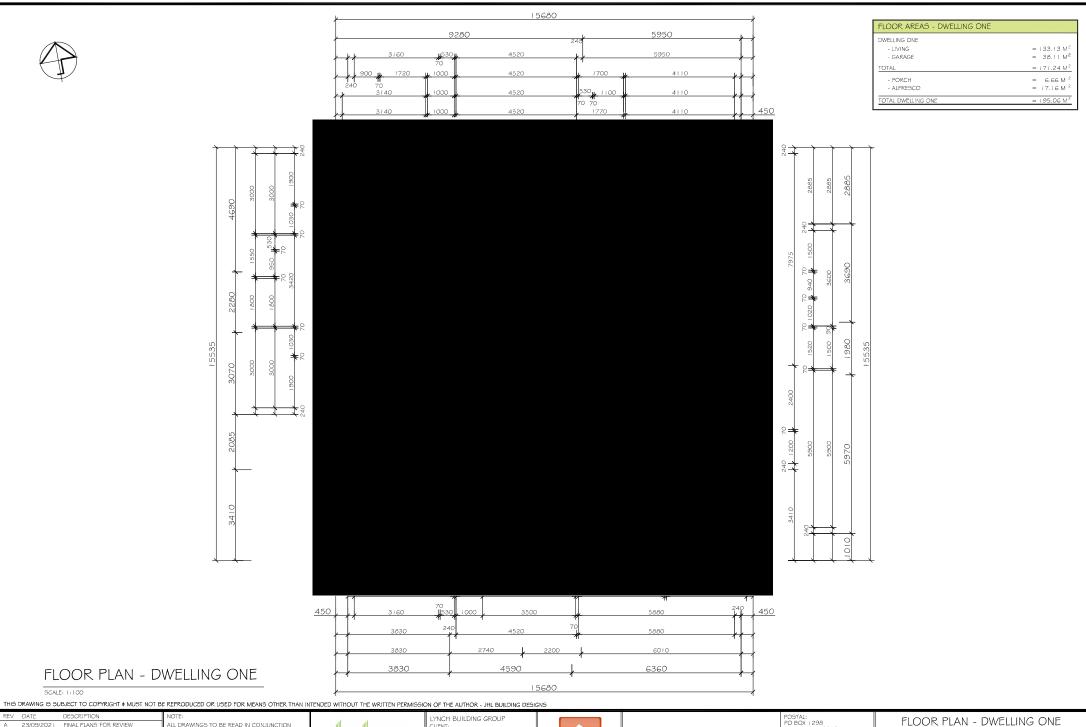

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|------|--|--|--|--|
| ABCD | 23/09/2021<br>15/10/2021<br>11/02/2022<br>22/02/2022 | FINAL PLANS FOR REVIEW<br>REVISED PLANS FOR REVIEW<br>FINAL FLANS REVISED AS REQUESTED<br>FINAL PLANS FOR PCA APPROVAL | ALL DRAWINGS TO BE READ IN CONJUNCTION WITH:  - ALL SHEETS TO THIS SET OF PLANS - SPERRATE SPECIFICATION DOCUMENTS - STRUCTURAL ENGINEERS DOCUMENTATION - PCA DOCUMENTS (WHERE APPLICABLE) - BASIX CERTIFICATE - ALL RELEVANT CODES, STANDARDS & APPROVALS |  |

BUILDING DESIGNERS ASSOCIATION OF AUSTRALIA

CLIENT: PROPOSED DETACHED DUAL OCCUPANCY LOT 407, 4 SUTTOR AVENUE CAERLEON NSW 2850 PROJECT:



LYNCH BUILDING

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|---|---|
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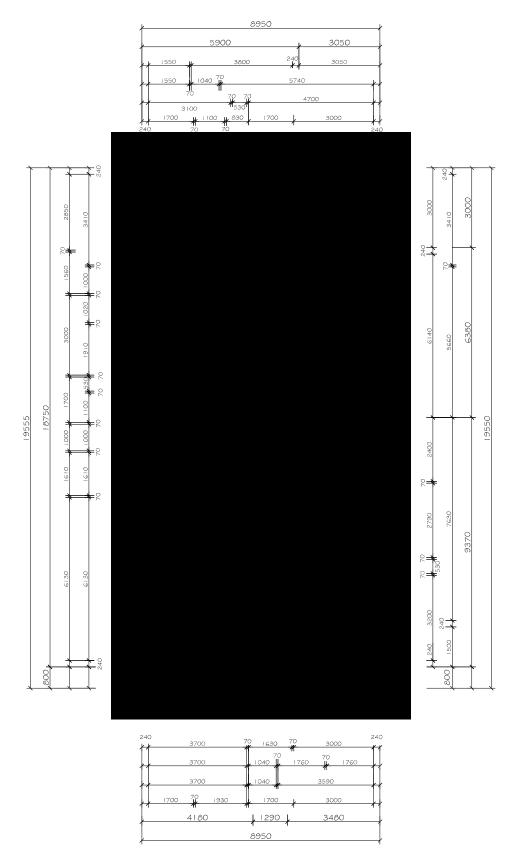
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ELEVATIONS - DWELLING ONE DRAWING TITLE:

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# FLOOR PLAN - DWELLING TWO

SCALE: 1:100

| FLOOR AREAS - DWELLING TWO                          |   |
|---|---|
| PROPOSED RESIDENCE - DWELLING TWO - LIVING - GARAGE | = 131.26 M <sup>2</sup><br>= 25.45 M <sup>2</sup> |
| TOTAL   | = 156.71 M <sup>2</sup>                           |
| - ALFRESCO<br>- PORCH                               | $= 09.15 M^2$<br>$= 3.52 M^2$                     |
| TOTAL GFA - DWELLING TWO                            | = 169.38 M <sup>2</sup>                           |

# NOTES

- PORCH ¢ ALFRESCO POST POSITION(S)

  MAY VARY THROUGH ENGINEERS DESIGNS ¢

  DURING CONSTRUCTION.
- MH = MAN HOLE LOCATION

==== ALL OPENINGS ARE SHOWN WITH WIDTH DISPLAYED ON FLOOR PLAN. HEAD HEIGHTS SHALL BE NO LESS THAN 2.2M FROM F.F.L. UNLESS STATED OTHERWISE

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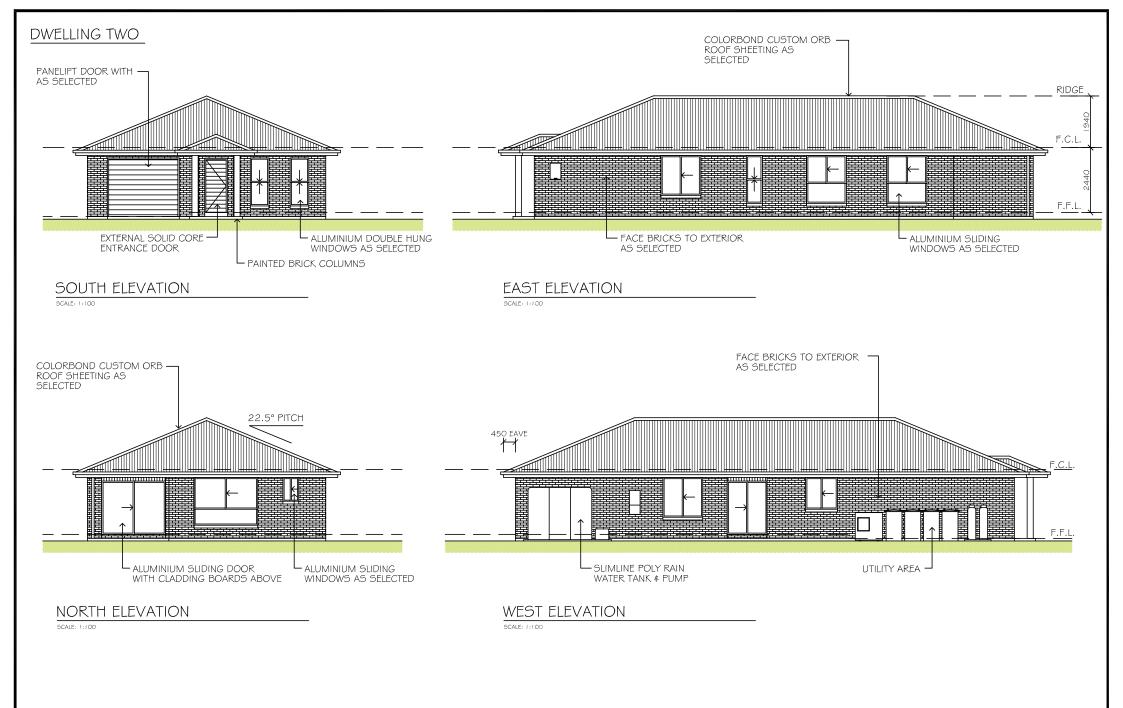








FLOOR PLAN - DWELLING TWO
AVANG TITLE:
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|------|--|--|--------------------|
|      |  |  | - BASIX            |

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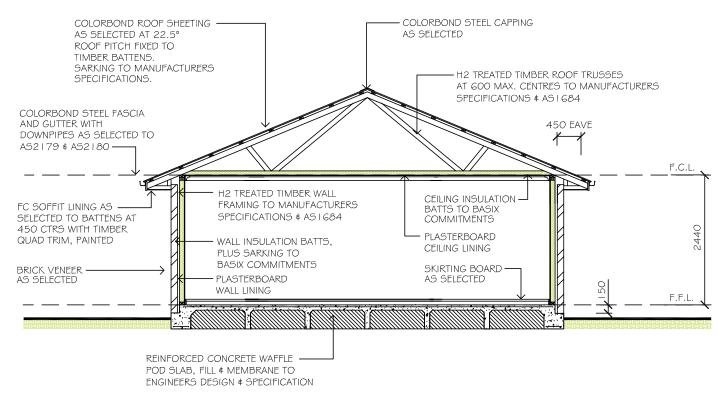
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**ELEVATIONS - DWELLING TWO** DRAWING TITLE:

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# TYPICAL SECTION

### SECTION NOTES

- FOR COMPLETE SLAB DETAILS # DESIGN REFER TO ENGINEERS SPECIFICATIONS # DESIGNS.
- 2 TERMITE TREATMENT SHALL BE INCLUDED TO PROTECT AGAINST INFESTATION TO AS3660.1-2000
- 31 PARTY WALL DETAILS -
  - SEPARATING PARTY WALL MUST, NOT BE CROSSED BY TIMBER OR OTHER COMBUSTIBLE BUILDING ELEMENTS WITH THE EXCEPTION OF STEEL ROOFING BATTENS WITH DIMENSIONS 75x50MM OR ROOF SARKING, MUST ALSO BE PACKED USING FIRE RESISTANT MATERIAL IN ACCORDANCE WITH THE B.C.A.
  - 25MM GYPROCK SHAFT LINER PANEL BETWEEN STEEL "H" WITH 20-40MM OF SEPERATION BETWEEN FRAMES # GYPROCK SHAF
  - STUDS AT GOOMM MAXIMUM CENTRES
  - I OMM GYPROCK "SUPERCHEK" PLASTERBOARD WALL LINING TO FACE OF PARTY WALL (GYPROCK EWFA 45743 CSR 360 PARTY WALL SYSTEM)
  - SELECT WALL FRAMING WITH R2.7 GOLD WALL INSULATION BATTS TO BE INSTALLED.
  - FIRE RESISTANT MINERAL FIRE BLANKET TO BE INSTALLED DIRECTLY ABOVE PARTY WALL TO UNDERSIDE OF ROOFING IN ACCORDANCE WITH THE B.C.A

### GENERAL NOTES

- PLANS DOCUMENTED FOR THE EXCLUSIVE USE OF THE NOTED CLIENTS BELOW ONLY # SUBJECT TO COPYRIGHT LAWS.
- 2 ALL DIMENSIONS # INFORMATION WITHIN THESE SET OF PLANS ARE DOCUMENTED WITH DUE CARE.
- ALL DRAWINGS WITHIN THIS SET OF PLANS SHALL BE READ IN CONJUNCTION WITH OTHER CONSULTANTS DRAWINGS, DESIGNS # SPECIFICATIONS & WITH OTHER WRITTEN INSTRUCTIONS ISSUED DURING ESTIMATIONS & CONSTRUCTION WITH SELECTED BUILDER.
- ALL DISCREPANCIES SHALL BE REFERRED TO, IN WRITING TO, JHL BUILDING DESIGNS FOR A DECISION BEFORE PROCEEDING WITH THE WORK
- ALL DIMENSIONS ARE IN MILLIMETRES UNLESS STATED OTHERWISE. DIMENSIONS ARE TO STRUCTURAL ELEMENTS OF THE DRAWING # NOT TO FINISHED SURFACES IF, TILING, PLASTERBOARD FTC.
- ALL RELEVANT DIMENSIONS ARE TO BE CONFIRMED BY THE CONTRACTOR PRIOR TO CONSTRUCTION # FABRICATION WITH REGARDS TO ONSITE # OFF SITE REQUIREMENTS # WORK

- THE RELEVANT SERVICE AUTHORITIES SHALL BE CONSULTED IN REGARDS TO CONFIRMING / CHECKING ALL DIMENSIONS, LEVELS, SERVICES & SITE CONDITIONS PRIOR TO CONSTRUCTION.
- THE RELEVANT STATUTORY AUTHORITIES SHALL BE NOTIFIED € APPROVAL SORT FROM / OBTAINED PRIOR TO CONSTRUCTION. IF ≰ WHEN NECESSARY
- STUD WALL & TRUSSED ROOF DESIGN, BRACING & TIE DOWN TO SELECTED FRAME & TRUSS MANUFACTURERS ENGINEERED. SPECIFICATIONS & TO AS L684 WHERE APPLICABLE
- 101 SHALL NO WIND CLASSIFICATION BE NOTED, CLIENT TO BE ADVISED BY PCA OR ENGINEERING CONSULTANT
- SITE CLASSIFICATION TO BE DETERMINED BY QUALIFIED. GEOTECHNICAL ENGINEER & ALL REINFORCED CONCRETE FOOTINGS & SLABS TO BE CONSTRUCTED TO ASSAGO
- 12 | ALL STORM WATER FROM ROOF TO BE DISPURSED TO REQUIRED DOWNPIPES \$ TO STREET / RAIN WATER TANK TO AUSTRALIAN STANDARDS & PCA REQUIREMENTS

- 13 A MINIMUM WATER ALLOWANCE SHALL BE PROVIDED FOR RURAL PROPERTIES FOR FIRE FIGHTING PURPOSES AS SPECIFIED BY PCA.
- 14 WHERE A SITE REQUIRES CUT # FILL TO OCCUR OR RETAINING WALLS CONSTRUCTED, ENGINEERS SHALL BE CONSULTED WHERE NECESSARY # BUILDING CONTRACTOR TO ENSURE ALL FINAL LEVELS, GROUND LINES # GRADIENTS DIVERT ALL SURFACE STORM WATER FROM THE PROPOSED RESIDENCE EITHER BY MEANS OF PIPES, DETENTION AREAS OR GRADING TO KERB. NEIGHBOURING PROPERTIES MUST BE TAKEN INTO CONSIDERATION WITH THE DESIGN OF THE FLOW OF STORM WATER
- 15 SEWER DRAINAGE LINES TO BE CONNECTED TO SEWER MAIN OR IN THE CASE OF A RURAL PROPERTY, CONNECTED TO A SEPTIC SYSTEM IN ACCORDANCE WITH THE RELEVANT AUSTRALIAN STANDARDS # LOCAL PCA.
- I 6 A QUALIFIED CONTRACTOR SHALL COMPLETE THE FINAL DRAINAGE LAYOUT TO BE SUBMITTED TO THE LOCAL PCA FOR THEIR RECORDS # APPROVAL.

- 17 THE HOT WATER SYSTEM IS AS SPECIFIED WITHIN THE BASIX CERTIFICATE & LOCATION NOTED OF FLOOR PLAN.
- 18 TERMITE PROTECTION SHALL BE IN ACCORDANCE WITH AS3660.
- 191 WHERE BRICK VENEER CONSTRUCTION IS SPECIFIED, CONTROL JOINTS FOR ARTICULATION MUST BE PROVIDED AT NOMINAL 6.0N MAY CENTRES OR TO STRUCTURAL ENGINEERS DETAILS.

| REV | DATE       | DESCRIPTION                      |
|-----|------------|----------------------------------|
| A   | 23/09/2021 | FINAL PLANS FOR REVIEW           |
| В   | 15/10/2021 | REVISED PLANS FOR REVIEW         |
| C   | 11/02/2022 | FINAL PLANS REVISED AS REQUESTED |
| D   | 22/02/2022 | SIMIAL DUANG FOR DOA APPROVAL    |

ALL DRAWINGS TO BE READ IN CONJUNCTION WITH -- ALL SHEETS TO THIS SET OF PLANS - SEPERATE SPECIFICATION DOCUMENTS - STRUCTURAL ENGINEERS DOCUMENTATION - PCA DOCUMENTS (WHERE APPLICABLE) - BASIX CERTIFICATE - ALL RELEVANT CODES, STANDARDS & APPROVAL



YNCH BUILDING GROUP PROPOSED DETACHED DUAL OCCUPANCY LOT 407, 4 SUTTOR AVENUE CAERLEON NSW 2850



LYNCH BUILDING GROUP

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|       | TYPICAL | SECTION |
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|-----------|---------|------------|----------|
| DESIGN:   | LBG     | FILE NO: ( | 0462-A01 |
| DRAFTED:  | J.LYNCH |            | ۸.0      |
| CHECKED.  | ATMICH  | PAPER SIZ  | ⊧. A.3.  |



# DWELLING ONE

ELECTRICAL PLAN

LEGEND SINGLE POWER POINT (DISTANCE ABOVE F.F.L.) (2) 3ô0 XX 300 DOUBLE POWER POINT (DISTANCE ABOVE F.F.L.) (15)  $\Box$ FLUORESCENT LIGHTS - SINGLE (2) DOWN LIGHT (20) 0 EXTERNAL WALL LIGHT (-)  $\boxtimes$ SENSOR LIGHT (1)  $\otimes$ STANDARD BATTEN (6) 88 TASTIC LIGHT - 4 LIGHT 8 TASTIC LIGHT - 2 LIGHT (1) TV TELEVISION OUTLET NBN NBN OUTLET LOCATION LIGHT SWITCH LOCATION (-) ρ (-) PENDANT LIGHT OXX EXTERNAL DOUBLE POWER POINT (2) CEILING FAN - WITH LIGHT

### ELECTRICAL NOTES

- I ALL ELECTRICAL WORK SHALL BE CARRIED OUT BY A LICENSED CONTRACTOR, ALL WORK SHALL BE IN ACCORDANCE WITH AS/NZ30 | 2 # ALL LINENSING REQUIREMENTS.
- 2 | THE SELECTION OF FITTINGS AND THE LAYOUT TO BE CARRIED OUT BY THE BUILDER & DESIGNED TO THE CLIENT'S REQUIREMENTS.
- 3 | ALL APPROVED SMOKE ALARMS / DETECTORS TO BE INSTALLED TO AS3786 BY A LICENSED CONTRACTOR.

| LEGEND |                                    |  |
|--------|------------------------------------|--|
|        | OUTDOOR AIR CONDITIONER UNIT       |  |
|        | ZONES                              |  |
|        | SUPPLY AIR GRILLS                  |  |
|        | RETURN AIR GRILLS                  |  |
|        | AIR CONDITIONER UNIT IN ROOF SPACE |  |
| -      | AIR CONDITIONER CONTROL PANEL      |  |
|        | INDOOR WALL MOUNTED SPLIT SYSTEM   |  |
|        |                                    |  |
|        |                                    |  |

### MECHANICAL NOTES

- ALL MECHANICAL WORKS REGARDING AIR CONDITIONING SHALL BE CARRIED OUT BY A LICENSED CONTRACTOR, ALL WORK SHALL BE IN ACCORDANCE WITH AS STANDARDS & ALL LINENSING REQUIREMENTS.
- 2 THE SELECTION OF FITTINGS AND THE LAYOUT TO BE CONFIRMED BY THE BUILDER & DESIGNED TO THE CLIENT'S REQUIREMENTS.

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ALL DRAWINGS TO BE READ IN CONJUNCTION 15/10/2021 REVISED PLANS FOR REVIEW WITH -- ALL SHEETS TO THIS SET OF PLANS - SEPERATE SPECIFICATION DOCUMENTS - STRUCTUREL PENGMERS DOCUMENTATION - PCA DOCUMENTS (WHERE APPLICABLE) - BASIV CERTIFICATE - ALL RELEVANT CODES, STANDARDS & APPROVALI 11/02/2022 FINAL FLANS REVISED AS REQUESTED 22/02/2022 FINAL FLANS FOR PCA APPROVAL



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ELECTRICAL # MECHANICAL PLANS - DWELLING ONE DRAWING TITLE:

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09 OF 10

# **DWELLING TWO**

ELECTRICAL PLAN

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| KEV     | DAIE   | DESCRIPTION  | NOTE:  |
|---------|--|--|--|
| A B C D | 23/09/2021<br>15/10/2021<br>11/02/2022<br>22/02/2022 | FINAL PLANS FOR REVIEW<br>REVISED PLANS FOR REVIEW<br>FINAL PLANS REVISED AS REQUESTED<br>FINAL PLANS FOR PCA APPROVAL | ALL DRAWINGS TO BE READ IN CONJUNCTION WITH SHETS TO THIS SET OF PLANS SEPREMET SPECIFICATION DOCUMENTS SETEMATE SPECIFICATION DOCUMENTS SETEMATION PCA DOCUMENTS WHERE APPLICABLE) BASIX CERTIFICAT ALL RETEXANT CODES STANDARDS & APPROXIMENTS STAND |



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LEGEND

 $\Box$ 

SINGLE POWER POINT (DISTANCE ABOVE F.F.L.)

DOUBLE POWER POINT (DISTANCE ABOVE F.F.L.)

FLUORESCENT LIGHTS - SINGLE

DOWN LIGHT

SENSOR LIGHT

EXTERNAL WALL LIGHT

STANDARD BATTEN

TASTIC LIGHT - 4 LIGHT

TASTIC LIGHT - 2 LIGHT

NBN OUTLET LOCATION LIGHT SWITCH LOCATION

EXTERNAL DOUBLE POWER POINT

I ALL ELECTRICAL WORK SHALL BE CARRIED OUT BY A LICENSED CONTRACTOR, ALL WORK SHALL BE IN ACCORDANCE WITH AS/NZ30 | 2 # ALL LINENSING REQUIREMENTS. 2 | THE SELECTION OF FITTINGS AND THE LAYOUT TO BE CARRIED OUT BY THE BUILDER ¢ DESIGNED TO THE CLIENT'S REQUIREMENTS. 3 | ALL APPROVED SMOKE ALARMS / DETECTORS TO BE INSTALLED TO AS3786 BY A LICENSED CONTRACTOR.

OUTDOOR AIR CONDITIONER UNIT

AIR CONDITIONER UNIT IN ROOF SPACE

INDOOR WALL MOUNTED SPLIT SYSTEM

AIR CONDITIONER CONTROL PANEL

CEILING FAN - WITH LIGHT

TELEVISION OUTLET

PENDANT LIGHT

ELECTRICAL NOTES

ZONES

MECHANICAL NOTES

SUPPLY AIR GRILLS RETURN AIR GRILLS (2)

(16)

(18)

(1)

(7)

(-) (-)

(2)

ELECTRICAL # MECHANICAL PLANS - DWELLING TWO DRAWING TITLE:

ILE NO: 0462-A01 DESIGN: LBG 10 OF 10 DRAFTED: J.LYNCH CHECKED: ALLYNCH PAPER SIZE: A3 DRAWING NO:

ALL MECHANICAL WORKS REGARDING AIR CONDITIONING SHALL BE

CARRIED OUT BY A LICENSED CONTRACTOR, ALL WORK SHALL BE IN ACCORDANCE WITH AS STANDARDS & ALL LINENSING REQUIREMENTS. 2 THE SELECTION OF FITTINGS AND THE LAYOUT TO BE CONFIRMED BY THE BUILDER & DESIGNED TO THE CLIENT'S REQUIREMENTS. 3 GENERAL LAYOUT OF SUPPLY AIR GRILLS ETC IS TO BE VIEWED AS AN EXAMPLE ONLY & CAN CHANGE THROUGHOUT INSTALLATION