


LIVING 151.72
GARAGE 24.38
PATIO 4.09
REAR PATIO 12.42
TOTAL 192.61 sq.m.

(20.73 sq.)

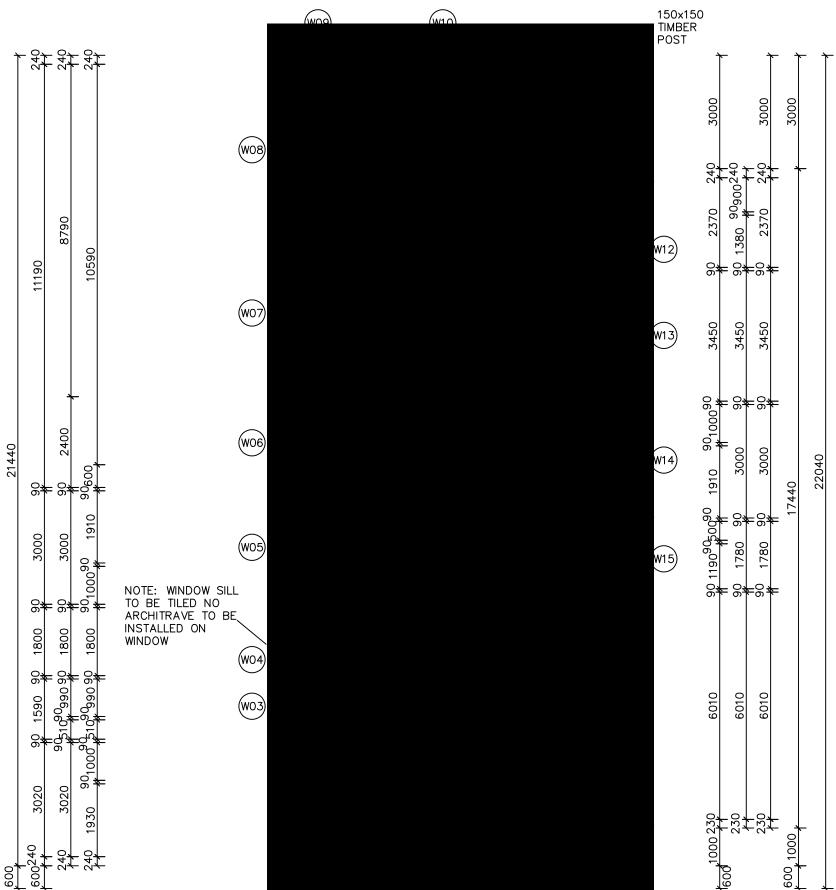

* ALL DIMENSIONS ARE TO BE CONFIRMED BY THE BUILDER PRIOR TO CONSTRUCTION. DO NOT SCALE FROM DRAWINGS. BUILDING SET OUT & SITE BOUNDARY DETAILS TO BE CONFIRMED BY A REGISTERED SURVEYOR. ALL WORK TO BE CARRIED OUT TO RELEVANT STANDARDS AND BUILDING CODES.

* NOTE: EXTERNAL LIGHTING

ABOVE THE HORIZONTAL PLANE.

BE SHIELDED.

ALL EXTERNAL LIGHT FITTINGS ARE TO

DOES NOT PERMIT LIGHT TO SHINE

90 800, 1200 90 24090090 1800 1410 2150 240100090 240 90 1200 90 2500 3650 90,510,01200 90 240 2990 3650 3570 3630 9100

NOTES - STAIR TREADS TO COMPLY WITH BCA 3.9.1.3

●SA SMOKE ALARM

8 EXHAUST FAN

EXHAUST SYSTEMS INSTALLED (INCLUDING TASTIC & LIGHT VENT COMBO) TO HAVE MINIMUM FLOW RATE IN ACCORDANCE WITH PART 3.8.7 NCC 2019

EXHAUST SYSTEMS (INCLUDING TASTIC & LIGHT VENT COMBO) TO DISCHARGE TO OUTSIDE AIR OR VENTILATED ROOF SPACE AS PER PART 3.8.7 NCC 2019. METHOD CHOSEN IS TO MATCH COMPLIANCE WITH THE RELEVANT BASIX CERTIFICATE.

PLIABLE BUILDING MEMBRANE INSTALLED IN EXTERNAL WALLS TO BE A VAPOR PERMEABLE TYPE, COMPLY WITH AS/NZS 4200.1 AND BE INSTALLED AS PER AS4200.2

EXTERNAL DOORS AND OPENABLE WINDOWS IN CONDITIONED SPACES TO BE SEALED TO RESTRICT AIR INFILTRATION AS PER PART 3.12.3 NCC 2019


"BELMORE SG"


MAAS
NAPODEDTIES
▶PROPERTIES

DATE: 29.11.21	SCALE: 1:100 (A3)	DRAWN: WP	DRAWING: FLOOR PLAN - DWELLING A LOT 75 THE LOGAN, MUDGEE
SHEET: 1 / 8	JOB No: 21093	ISSUE:	MAAS GROUP PROPERTIES




Ph: (02) 6885 3594 / Mob: 0408 296 502

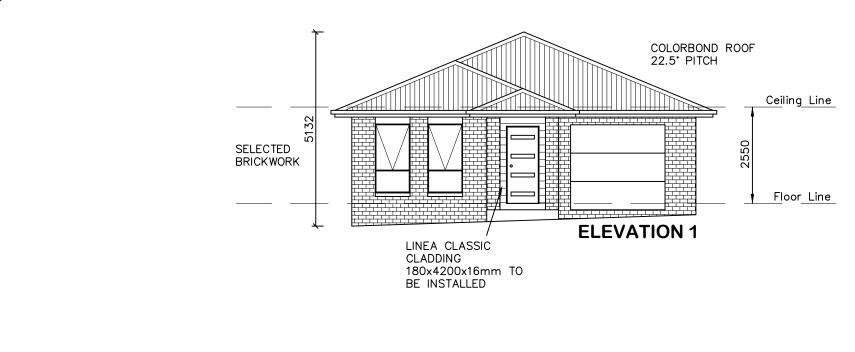

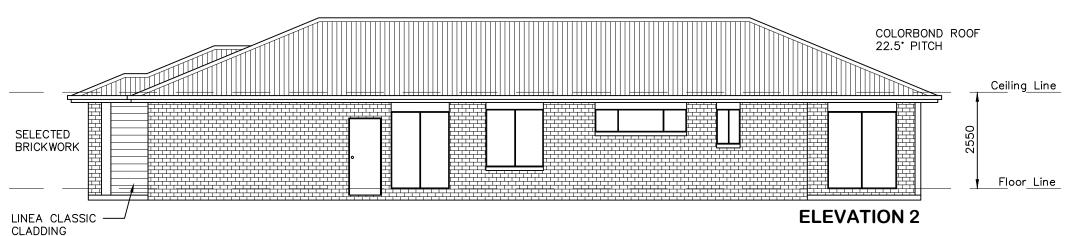



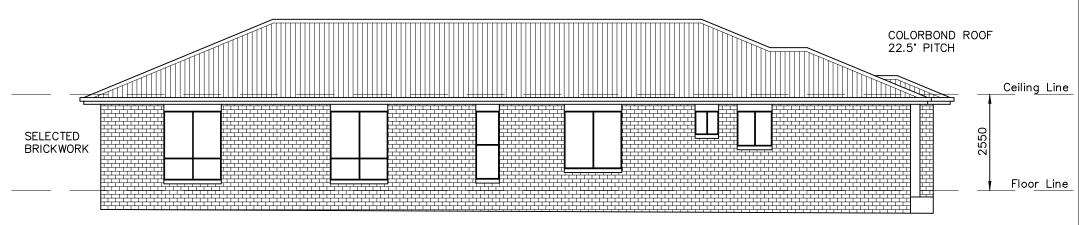

ELEVATION 4

* ALL DIMENSIONS ARE TO BE CONFIRMED BY THE BUILDER PRIOR TO CONSTRUCTION. DO NOT SCALE FROM DRAWINGS. BUILDING SET OUT & SITE BOUNDARY DETAILS TO BE CONFIRMED BY A REGISTERED SURVEYOR.
ALL WORK TO BE CARRIED OUT TO RELEVANT STANDARDS AND BUILDING CODES.

180x4200x16mm TO BE INSTALLED

"BELMORE SG"



	SCALE: 1:100 (A3)	DRAWN: WP
SHEET:	JOB No:	ISSUE:

D

21093


2 / 8


DRAWING: ELEVATIONS - DWELLING A LOT75 THE LOGAN, MUDGEE MAAS GROUP PROPERTIES





LIVING 146.66
GARAGE 40.34
PORCH 3.04
PATIO 10.82
TOTAL 200.86 sq.m.
(21.62 sq.)

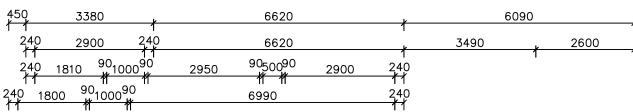

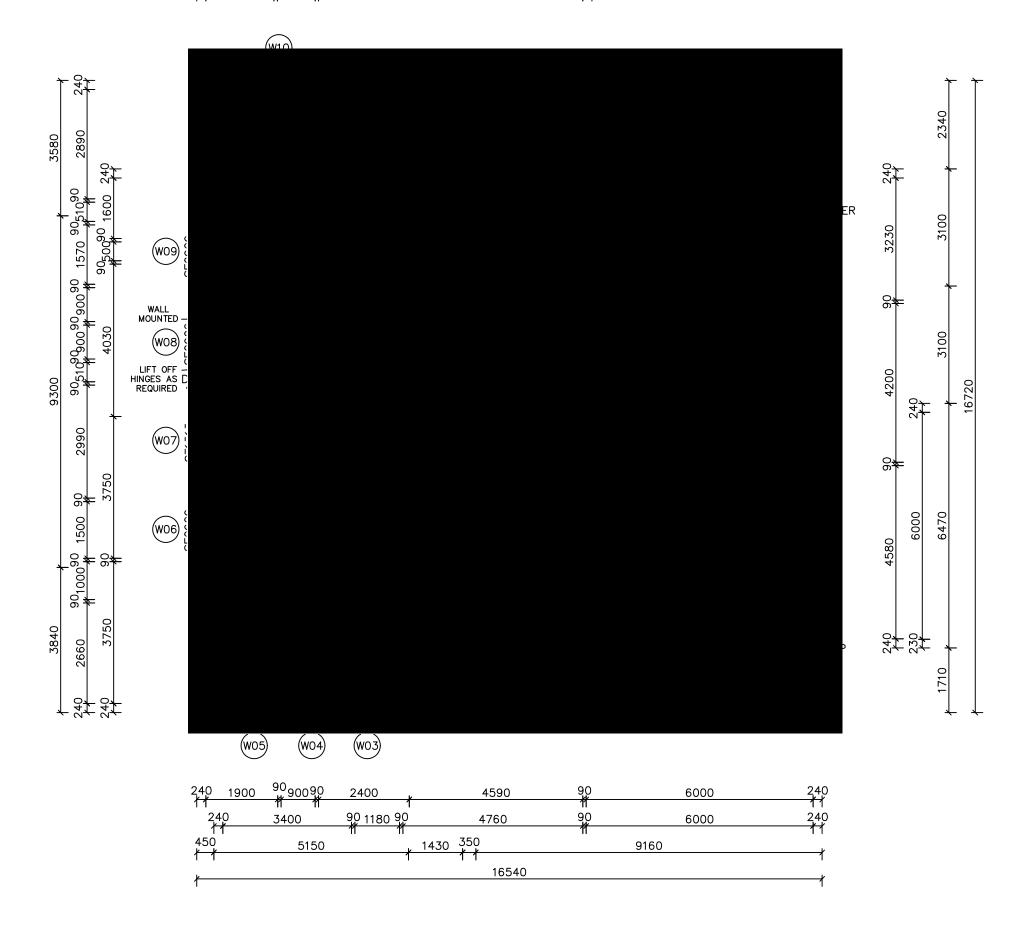

* NOTE: EXTERNAL LIGHTING

ALL EXTERNAL LIGHT FITTINGS ARE TO BE SHIELDED.

I.E. DOES NOT PERMIT LIGHT TO SHINE ABOVE THE HORIZONTAL PLANE.

* ALL DIMENSIONS ARE TO BE CONFIRMED BY THE BUILDER PRIOR TO CONSTRUCTION. DO NOT SCALE FROM DRAWINGS. BUILDING SET OUT & SITE BOUNDARY DETAILS TO BE CONFIRMED BY A REGISTERED SURVEYOR. ALL WORK TO BE CARRIED OUT TO RELEVANT STANDARDS AND BUILDING CODES.

NOTES - STAIR TREADS TO COMPLY WITH BCA 3.9.1.3

●SA SMOKE ALARM

EXHAUST FAN

"GIPPS DG"

EXHAUST SYSTEMS INSTALLED (INCLUDING TASTIC & LIGHT VENT COMBO) TO HAVE MINIMUM FLOW RATE IN ACCORDANCE WITH PART 3.8.7 NCC 2019

EXHAUST SYSTEMS (INCLUDING TASTIC & LIGHT VENT COMBO) TO DISCHARGE TO OUTSIDE AIR OR VENTILATED ROOF SPACE AS PER PART 3.8.7 NCC 2019. METHOD CHOSEN IS TO MATCH COMPLIANCE WITH THE RELEVANT BASIX CERTIFICATE.

PLIABLE BUILDING MEMBRANE INSTALLED IN EXTERNAL WALLS TO BE A VAPOR PERMEABLE TYPE, COMPLY WITH AS/NZS 4200.1 AND BE INSTALLED AS PER AS4200.2

EXTERNAL DOORS AND OPENABLE WINDOWS IN CONDITIONED SPACES TO BE SEALED TO RESTRICT AIR INFILTRATION AS PER PART 3.12.3 NCC 2019




DATE: 29.11.21	SCALE: 1:100 (A3)	DRAWN: WP	
SHEET:	JOB No:	ISSUE:	
3 / 8	21093	ם	

DRAWING: FLOOR PLAN - DWELLING B LOT 75 THE LOGAN, MUDGEE MAAS GROUP PROPERTIES





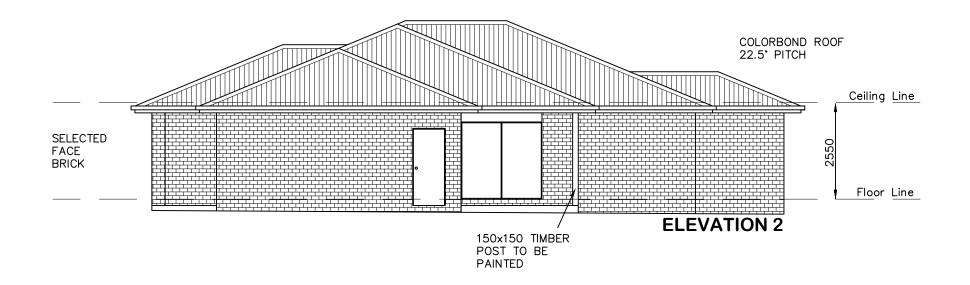





* ALL DIMENSIONS ARE TO BE CONFIRMED BY THE BUILDER PRIOR TO CONSTRUCTION.
DO NOT SCALE FROM DRAWINGS.
BUILDING SET OUT & SITE BOUNDARY DETAILS TO BE CONFIRMED BY A REGISTERED SURVEYOR.
ALL WORK TO BE CARRIED OUT TO RELEVANT STANDARDS AND BUILDING CODES.

"GIPPS DG"




DATE:	SCALE:	DRAWN:
29.11.21	1:100 (A3)	WP
	, ,	
SHEET:	JOB No:	ISSUE:
4/8	21093	D

DRAWING: ELEVATIONS - DWELLING B LOT 75 THE LOGAN, MUDGEE MAAS GROUP PROPERTIES



(C) - EASEMENT TO DRAIN SEWAGE 3m WIDE & VARIABLE WIDTH

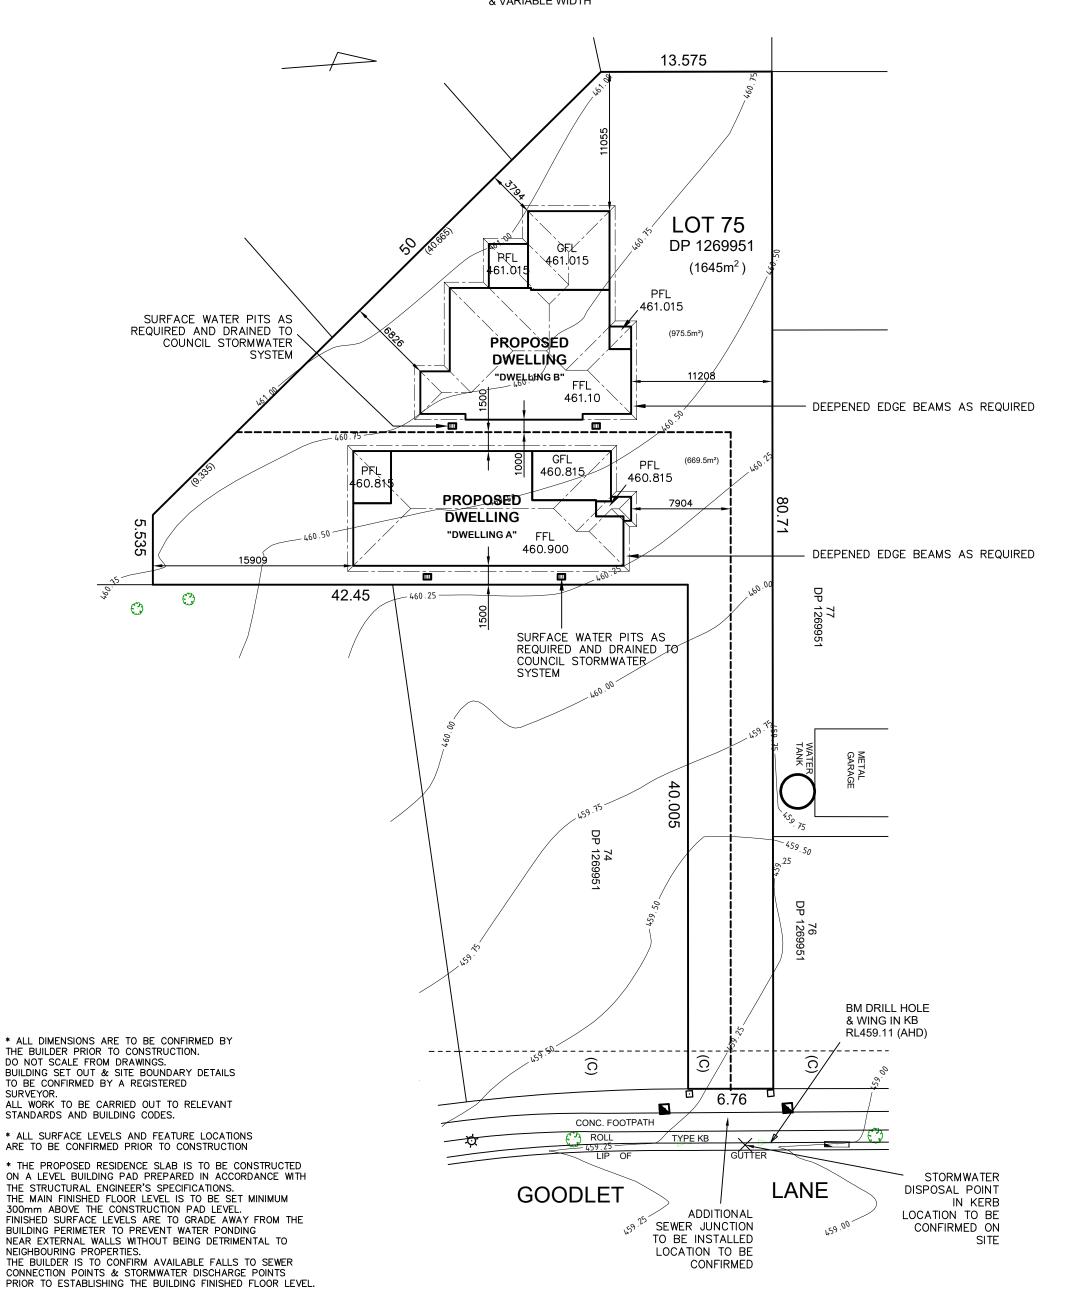



DATE:	SCALE:	DRAWN:
29.11.21	1:300 (A3)	WP
SHEET:	JOB No:	ISSUE:


D

21093

5 / 8

DRAWING: SITE PLAN LOT 75 THE LOGAN, MUDGEE MAAS GROUP PROPERTIES



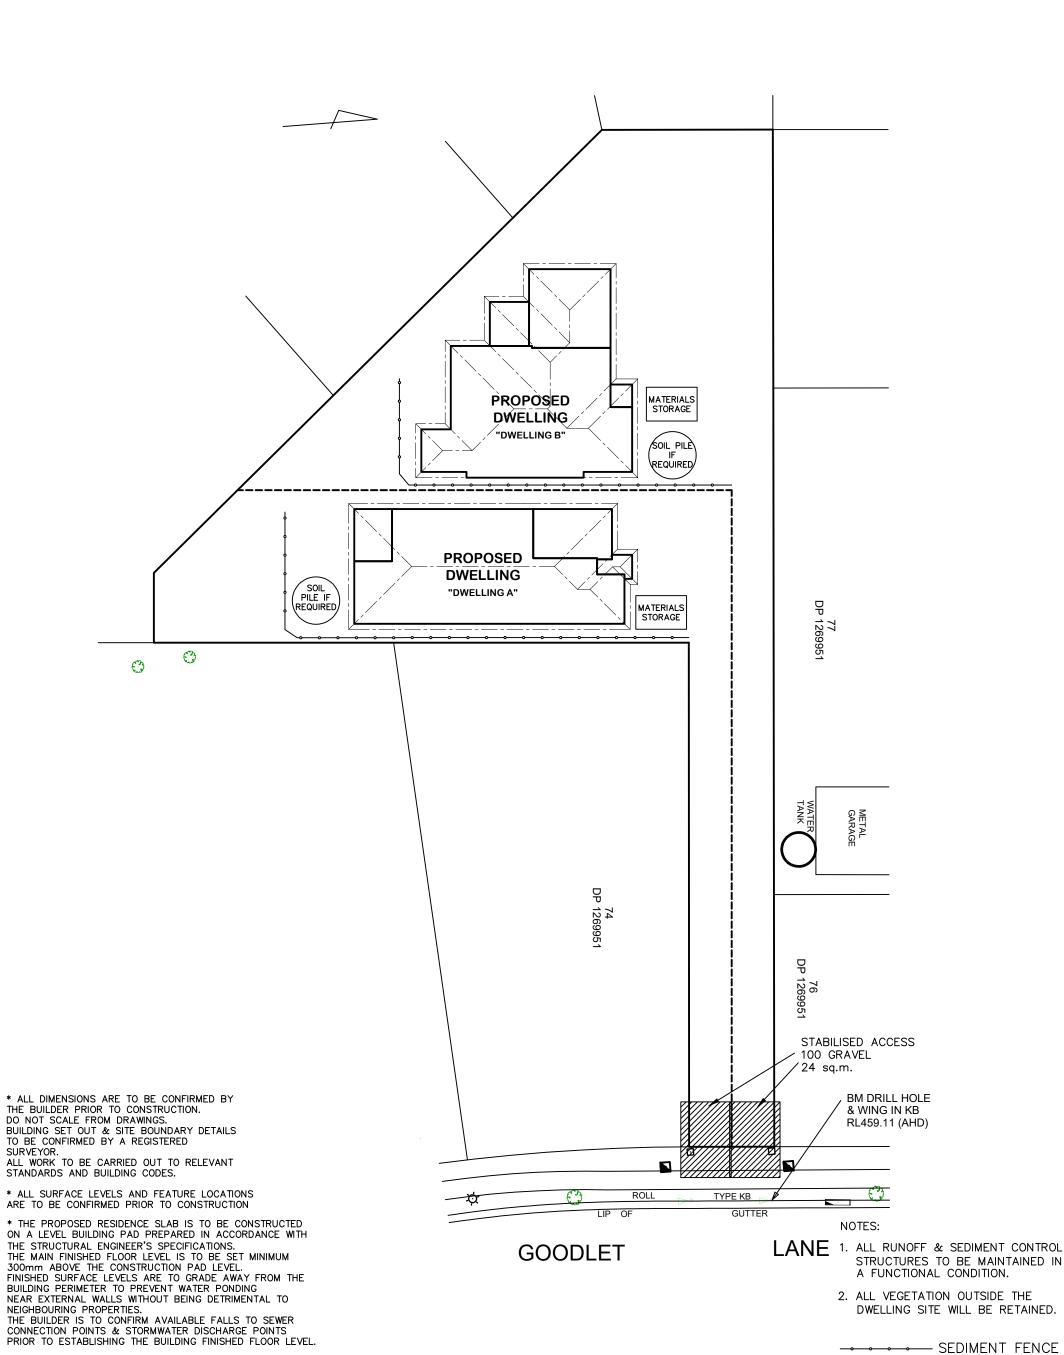


SCALE: DATE: **DRAWN**: 29.11.21 1:300 (A3) **WP** JOB No: **ISSUE**: SHEET: 6 / 8 21093 D

DRAWING: SEDIMENT & EROSION CONTROL PLAN LOT 75 THE LOGAN, MUDGEE MAAS GROUP PROPERTIES



— SEDIMENT FENCE

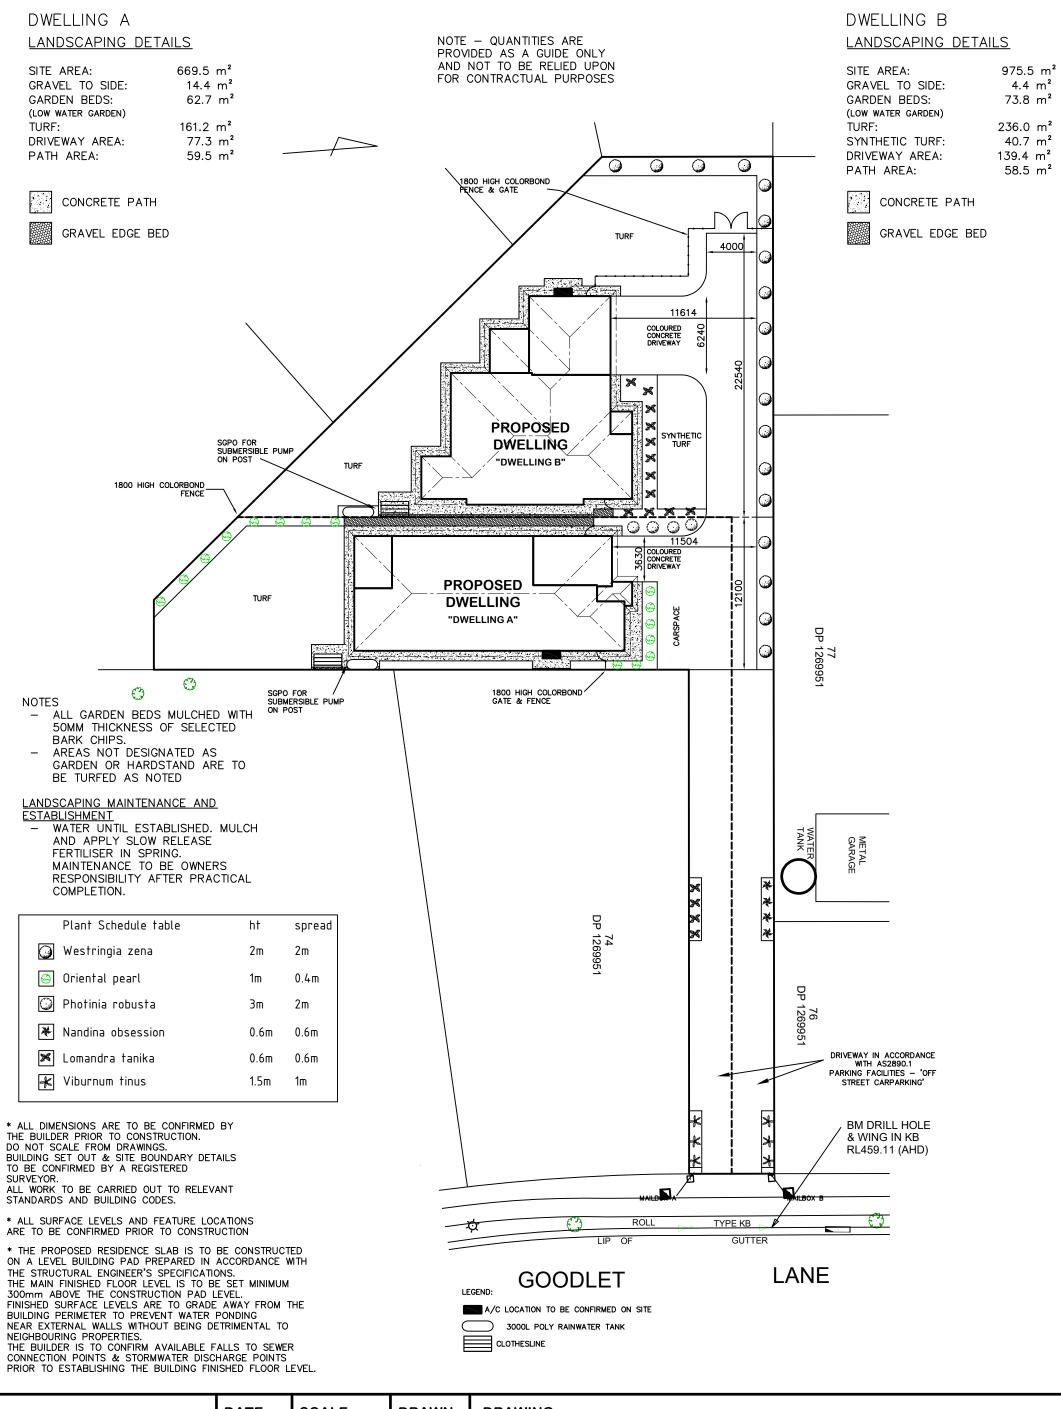



SHEET:	JOB No:	ISSUE:
29.11.21	1:300 (A3)	WP
DATE:	SCALE:	DRAWN:

D

21093

7 / 8

DRAWING:
BASIX COMMITMENTS PLAN
LOT 75 THE LOGAN, MUDGEE
MAAS GROUP PROPERTIES



BASIX COMMITMENTS - DWELLING A WATER COMMITMENTS LANDSCAPE
AREA LOW WATER USE SPECIES OF VEGETATION 62.7 SQ.M. MIN RATING 4 STAR 4 STAR 5 STAR 5 STAR FIXTURES
SHOWER HEAD RATING SHOWER HEAD KAING
TOILET FLUSHING SYSTEM RATING
KITCHEN TAPS
BASIN TAPS
BASIN TAPS
ALTERNATIVE WATER
RAINWATER TANK
RAINWATER TANK CAPACITY
ROOF COLLECTION AREA FOR R/W 3000 LITRE 100 SQ.M. MIN 1 No. OUTDOOR TAP ALL TOILETS IN DWELLING THE COLD WATER TAP THAT SUPPLIES THE CLOTHES WASHER R/W TANK CONNECTED TO

THERMAL COMFORT COMMITMENTS
GENERAL REQUIREMENTS -CLASS 1 DWELLING WITH NOT MORE THAN 2 STOREYS
CONDITIONED FLOOR AREA NOT EXCEEDING 300 SQUARE METRES
MUST NOT HAVE OPEN MEZZANINE OF MORE THAN 25 SQUARE METRES
NOT CONTAIN THIRD LEVEL HABITABLE ATTIC ROOM

GROUND FLOOR CONSTRUCTION CONCRETE SLAB ON GROUND EXTERNAL WALL EXTERNAL WALL BRICK VENEER - R2.60 INC CONSTRUCTION
OTHER/UNDECIDED - R2.60 INC CONSTRUCTION INTERNAL WALL SHARED WITH GARAGE

FLAT CEILING/PITCHED ROOF — CEILING R4, ROOF — SARKING — UNVENTILATED — DARK (SOLAR ABSORPTANCE > 0.7)

THERMAL COMFORT COMMITMENTS - WINDOWS & GLAZED DOORS

WINDOW	ORIENTATION	MAXIMUM HEIGHT (mm)	MAXIMUM WIDTH (mm)	TYPE	SHADING	OVERSHADOWING
W01	N	1800	900	ALUMINIUM, SINGLE, CLEAR	EAVE 600mm, 180mm ABOVE HEAD OF WINDOW OR GLAZED DOOR	NOT OVERSHADOWED
W02	N	1800	900	ALUMINIUM, SINGLE, CLEAR	EAVE 600mm, 180mm ABOVE HEAD OF WINDOW OR GLAZED DOOR	NOT OVERSHADOWED
W03	E	900	900	ALUMINIUM, SINGLE, CLEAR	EAVE 600mm, 180mm ABOVE HEAD OF WINDOW OR GLAZED DOOR	NOT OVERSHADOWED
W04	E	600	600	ALUMINIUM, SINGLE, CLEAR	EAVE 600mm, 180mm ABOVE HEAD OF WINDOW OR GLAZED DOOR	NOT OVERSHADOWED
W05	E	1500	1500	ALUMINIUM, SINGLE, CLEAR	EAVE 600mm, 180mm ABOVE HEAD OF WINDOW OR GLAZED DOOR	NOT OVERSHADOWED
W06	E	1800	600	ALUMINIUM, SINGLE, CLEAR	EAVE 600mm, 180mm ABOVE HEAD OF WINDOW OR GLAZED DOOR	NOT OVERSHADOWED
W07	E	1800	1500	ALUMINIUM, SINGLE, CLEAR	EAVE 600mm, 180mm ABOVE HEAD OF WINDOW OR GLAZED DOOR	NOT OVERSHADOWED
W08	E	1800	1500	ALUMINIUM, SINGLE, CLEAR	EAVE 600mm, 180mm ABOVE HEAD OF WINDOW OR GLAZED DOOR	NOT OVERSHADOWED
W09	s	1800	900	ALUMINIUM, SINGLE, CLEAR	EAVE 600mm, 180mm ABOVE HEAD OF WINDOW OR GLAZED DOOR	NOT OVERSHADOWED
W10	S	1800	900	ALUMINIUM, SINGLE, CLEAR	EAVE 600mm, 180mm ABOVE HEAD OF WINDOW OR GLAZED DOOR	NOT OVERSHADOWED
W11	w	2100	1800	ALUMINIUM, SINGLE, CLEAR	EAVE 4740mm, 240mm ABOVE HEAD OF WINDOW OR GLAZED DOOR	NOT OVERSHADOWED
W12	w	900	600	ALUMINIUM, SINGLE, CLEAR	EAVE 600mm, 180mm ABOVE HEAD OF WINDOW OR GLAZED DOOR	NOT OVERSHADOWED
W13	w	600	2400	ALUMINIUM, SINGLE, CLEAR	EAVE 600mm, 180mm ABOVE HEAD OF WINDOW OR GLAZED DOOR	NOT OVERSHADOWED
W14	W	1500	1500	ALUMINIUM, SINGLE, CLEAR	EAVE 600mm, 180mm ABOVE HEAD OF WINDOW OR GLAZED DOOR	NOT OVERSHADOWED
W15	w	2100	1500	ALUMINIUM, SINGLE, CLEAR	EAVE 600mm, 240mm ABOVE HEAD OF WINDOW OR GLAZED DOOR	NOT OVERSHADOWED
ENERGY COMMITMENTS HOT WATER SYSTEM COOLING SYSTEM HEATING SYSTEM HEATING SYSTEM BATHROOM BATHROOM BATHROOM LAUNDRY EXTRACT FAN DUCTED TO ROOF OR FACADE — MANUAL ON/OFF NATURAL VENTURATION ONLY						
ARTIFICIAL LIGHTING KITCHEN BATHROOMS/TOILETS LAUNDRY HALLWAYS HALWAYS PRIMARY TYPE OF ARTIFICIAL LIGHTING IS FLUORESCENT OR LIGHT EMITTING DIODE (LED) PRIMARY TYPE OF ARTIFICIAL LIGHTING IS FLUORESCENT OR LIGHT EMITTING DIODE (LED) PRIMARY TYPE OF ARTIFICIAL LIGHTING IS FLUORESCENT OR LIGHT EMITTING DIODE (LED) PRIMARY TYPE OF ARTIFICIAL LIGHTING IS FLUORESCENT OR LIGHT EMITTING DIODE (LED) PRIMARY TYPE OF ARTIFICIAL LIGHTING IS FLUORESCENT OR LIGHT EMITTING DIODE (LED) X 2 PRIMARY TYPE OF ARTIFICIAL LIGHTING IS FLUORESCENT OR LIGHT EMITTING DIODE (LED) X 4						

NATURAL LIGHTING WINDOW x 3 BATHROOMS/TOILETS <u>APPLIANCES</u>

PRIMARY TYPE OF ARTIFICIAL LIGHTING IS FLUORESCENT OR LIGHT EMITTING DIODE (LED) X 4

KITCHEN WELL VENTILATED AS BASIX DEFINITION OUTDOOR CLOTHES DRYING LINE REFRIGERATOR SPACE CLOTHES DRYING

BATHROOMS/TOILETS LAUNDRY HALLWAYS LIVING AREAS BEDROOMS

These are the specifications upon which the Basix assessment is based. These specifications take precedence over the drawings or other specific

BASIX COMMITMENTS - DWELLING B WATER COMMITMENTS LANDSCAPE
AREA LOW WATER USE SPECIES OF VEGETATION
FIXTURES
SHOWER HEAD RATING 73.8 SQ.M. MIN RATING 4 STAR 4 STAR

TOILET FLUSHING SYSTEM RATING TOTAL PLUSHING STSTEM RATING
KITCHEN TAPS
BASIN TAPS
ALTERNATIVE WATER
RANNWATER TANK
RANNWATER TANK CAPACITY
ROOF COLLECTION AREA FOR R/W

3000 LITRE 100 SQ.M.

MIN 1 No. OUTDOOR TAP ALL TOILETS IN DWELLING THE COLD WATER TAP THAT SUPPLIES THE CLOTHES WASHER

THERMAL COMFORT COMMITMENTS
GENERAL REQUIREMENTS —

R/W TANK CONNECTED TO

CLASS 1 DWELLING WITH NOT MORE THAN 2 STOREYS
CONDITIONED FLOOR AREA NOT EXCEEDING 300 SQUARE METRES
MUST NOT HAVE OPEN MEZZANINE OF MORE THAN 25 SQUARE METRES
NOT CONTAIN THIRD LEVEL HABITABLE ATTIC ROOM

GROUND FLOOR CONSTRUCTION CONCRETE SLAB ON GROUND EXTERNAL WALL SHARED WITH GARAGE CEILING AND ROOF BRICK VENEER - R2.60 INC CONSTRUCTION

FLAT CEILING/PITCHED ROOF — CEILING R4, ROOF — SARKING — UNVENTILATED — DARK (SOLAR ABSORPTANCE > 0.7)

THERMAL C	OMFORT COMMITMEN	NTS – WINDOWS &	GLAZED DOORS			
WINDOW	ORIENTATION	MAXIMUM HEIGHT (mm)	MAXIMUM WIDTH (mm)	TYPE	SHADING	OVERSHADOWING
W01	N	1800	800	ALUMINIUM, SINGLE, CLEAR	EAVE 600mm, 180mm ABOVE HEAD OF WINDOW OR GLAZED DOOR	NOT OVERSHADOWED
W02	N	1800	800	ALUMINIUM, SINGLE, CLEAR	EAVE 600mm, 180mm ABOVE HEAD OF WINDOW OR GLAZED DOOR	NOT OVERSHADOWED
W03	N	1800	600	ALUMINIUM, SINGLE, CLEAR	EAVE 600mm, 180mm ABOVE HEAD OF WINDOW OR GLAZED DOOR	NOT OVERSHADOWED
W04	N	1800	1200	ALUMINIUM, SINGLE, CLEAR	EAVE 600mm, 180mm ABOVE HEAD OF WINDOW OR GLAZED DOOR	NOT OVERSHADOWED
W05	N	1800	600	ALUMINIUM, SINGLE, CLEAR	EAVE 600mm, 180mm ABOVE HEAD OF WINDOW OR GLAZED DOOR	NOT OVERSHADOWED
W06	E	900	900	ALUMINIUM, SINGLE, CLEAR	EAVE 150mm, 180mm ABOVE HEAD OF WINDOW OR GLAZED DOOR	NOT OVERSHADOWED
W07	E	1500	1500	ALUMINIUM, SINGLE, CLEAR	EAVE 150mm, 180mm ABOVE HEAD OF WINDOW OR GLAZED DOOR	NOT OVERSHADOWED
W08	E	900	600	ALUMINIUM, SINGLE, CLEAR	EAVE 150mm, 180mm ABOVE HEAD OF WINDOW OR GLAZED DOOR	NOT OVERSHADOWED
W09	E	900	900	ALUMINIUM, SINGLE, CLEAR	EAVE 150mm, 180mm ABOVE HEAD OF WINDOW OR GLAZED DOOR	NOT OVERSHADOWED
W 10	s	1500	1500	ALUMINIUM, SINGLE, CLEAR	EAVE 600mm, 180mm ABOVE HEAD OF WINDOW OR GLAZED DOOR	NOT OVERSHADOWED
W11	S	900	600	ALUMINIUM, SINGLE, CLEAR	EAVE 600mm, 240mm ABOVE HEAD OF WINDOW OR GLAZED DOOR	NOT OVERSHADOWED
W12	S	1500	1500	ALUMINIUM, SINGLE, CLEAR	EAVE 600mm, 180mm ABOVE HEAD OF WINDOW OR GLAZED DOOR	NOT OVERSHADOWED
W13	w	2100	2100	ALUMINIUM, SINGLE, CLEAR	EAVE 3490mm, 240mm ABOVE HEAD OF WINDOW OR GLAZED DOOR	NOT OVERSHADOWED
HOT WATE COOLING S HEATING S VENTILATIO						
KITCHEN BATHROOM LAUNDRY HALLWAYS LIVING ARI	BATHROOMS/TOILETS PRIMARY TYPE OF ARTIFICIAL LIGHTING IS FLUORESCENT OR LIGHT EMITTING DIODE (LED) LAUNDRY PRIMARY TYPE OF ARTIFICIAL LIGHTING IS FLUORESCENT OR LIGHT EMITTING DIODE (LED)					
KITCHEN	NATURAL LIGHTING KITCHEN BATHROOMS/TOILETS WINDOW x 3					
APPLIANCES KITCHEN REFRIGERATOR SPACE CLOTHES DRYING WELL VENTILATED AS BASIX DEFINITION OUTDOOR CLOTHES DRYING LINE						

These are the specifications upon which the Basix assessment is based. These specifications take precedence over the drawings or other specifications.

ALL DIMENSIONS ARE TO BE CONFIRMED BY THE BUILDER PRIOR TO CONSTRUCTION.
DO NOT SCALE FROM DRAWINGS. & SITE BOUNDARY DETAILS TO BE CONFIRMED BY A REGISTERED SURVEYOR. ALL WORK TO BE CARRIED OUT TO RELEVANT

STANDARDS AND BUILDING CODES.

ALL SURFACE LEVELS AND FEATURE LOCATIONS ARE TO BE CONFIRMED PRIOR TO CONSTRUCTION

THE PROPOSED RESIDENCE SLAB IS TO BE CONSTRUCTED ON A LEVEL BUILDING PAD PREPARED IN ACCORDANCE WITH THE STRUCTURAL ENGINEER'S SPECIFICATIONS. THE MAIN FINISHED FLOOR LEVEL IS TO BE SET MINIMUM 300mm ABOVE THE CONSTRUCTION PAD LEVEL. FINISHED SURFACE LEVELS ARE TO GRADE AWAY FROM THE BUILDING PERIMETER TO PREVENT WATER PONDING NEAR EXTERNAL WALLS WITHOUT BEING DETRIMENTAL TO NEICHBOURING PROPERTIES.
THE BUILDER IS TO CONFIRM AVAILABLE FALLS TO SEWER CONNECTION POINTS & STORMWATER DISCHARGE POINTS
PRIOR TO ESTABLISHING THE BUILDING FINISHED FLOOR LEVEL.

TO BE N2 SELECTED COLORBOND SHEET ROOFING ON ROOF PITCH 22.5° CEILING LINE FRAME AND ROOF TRUSSES
TO BE TIMBER IN
ACCORDANCE WITH AS1684 600 PLASTERBOARD LININGS TIE DOWN AND BRACING
DETAILS TO BE SUPPLIED BY
MANUFACTURER <u>THROUGHOUT</u> FLOOR LINE TYPICAL SECTION CONCRETE SLAB TO ENGINEERS DETAILS

DATE: SCALE: **DRAWN**: 29.11.21 N/A **WP** SHEET: JOB No: **ISSUE:**

D

21093

8 / 8

DRAWING: BASIX COMMITMENTS & TYP SECTION LOT 75 THE LOGAN, MUDGEE MAAS GROUP PROPERTIES

NOT TO SCALE



* NOTE - WIND CLASSIFICATION