

SURVEYOR.
ALL WORK TO BE CARRIED OUT TO RELEVANT STANDARDS AND BUILDING CODES.

A		
▶ PR	OPEF	?TIES □

DATE:	SCALE:	DRAWN:
03.12.21	1:100 (A3)	WP
SHEET:	JOB No:	ISSUE:


Ε

21088

2 / 6

DRAWING: ELEVATIONS LOT 69 THE LOGAN, MUDGEE MAAS GROUP PROPERTIES



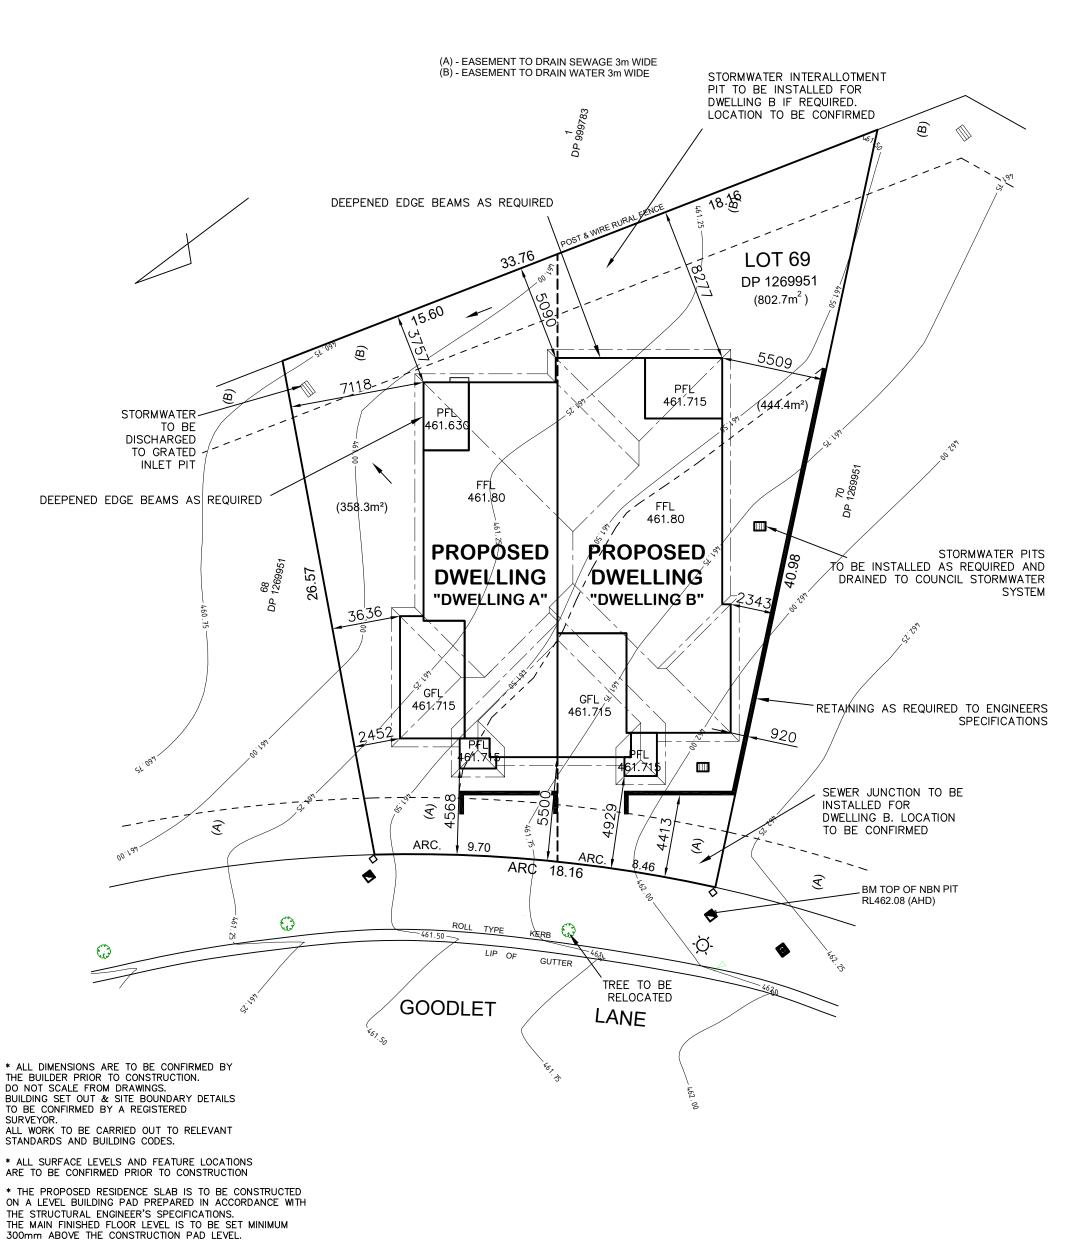

ON A LEVEL BUILDING PAD PREPARED IN ACCORDANCE WITH THE STRUCTURAL ENGINEER'S SPECIFICATIONS. THE MAIN FINISHED FLOOR LEVEL IS TO BE SET MINIMUM 300mm ABOVE THE CONSTRUCTION PAD LEVEL. FINISHED SURFACE LEVELS ARE TO GRADE AWAY FROM THE BUILDING PERIMETER TO PREVENT WATER PONDING NEAR EXTERNAL WALLS WITHOUT BEING DETRIMENTAL TO THE BUILDER IS TO CONFIRM AVAILABLE FALLS TO SEWER CONNECTION POINTS & STORMWATER DISCHARGE POINTS PRIOR TO ESTABLISHING THE BUILDING FINISHED FLOOR LEVEL.


DENOTES DIRECTION OF SURFACE WATER ON COMPLETION OF LANDSCAPING.



DATE: 03.12.21	SCALE: 1:200 (A3)	DRAWN: WP
SHEET:	JOB No:	ISSUE:
3 / 6	21088	E

DRAWING: SITE PLAN **LOT 69 THE LOGAN, MUDGEE MAAS GROUP PROPERTIES**



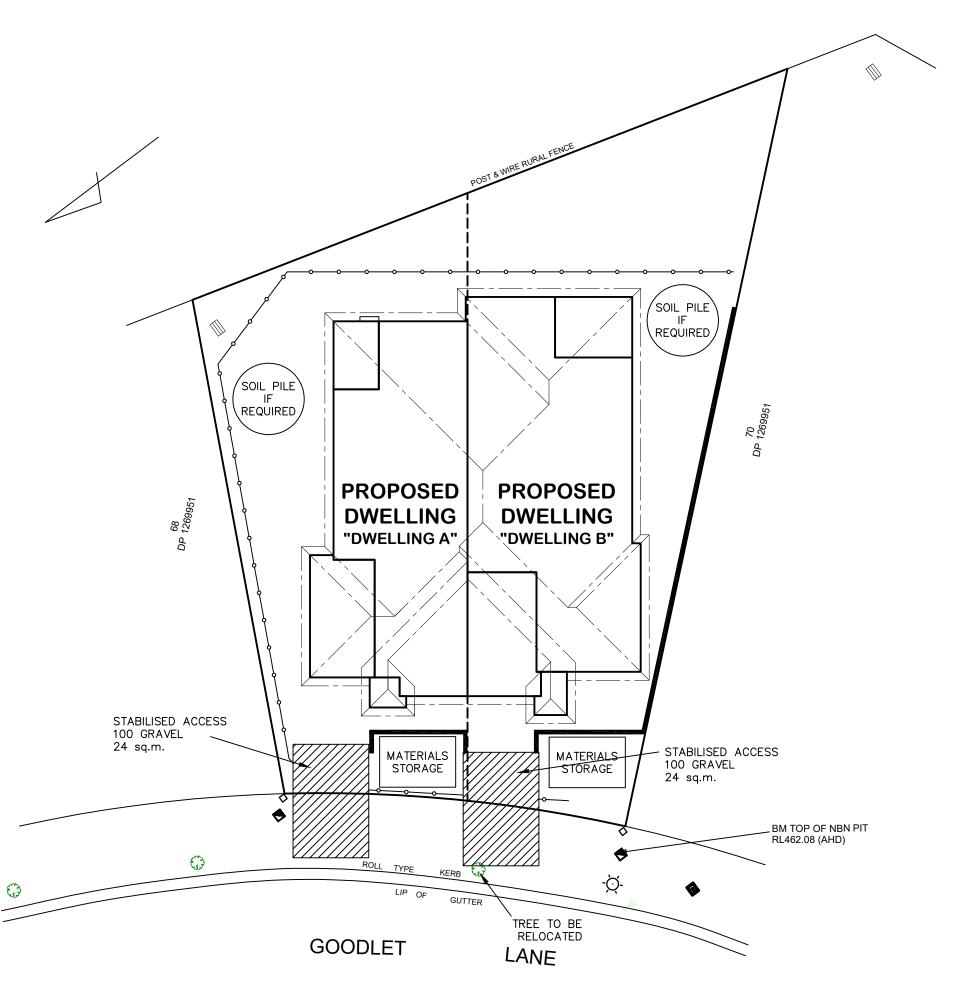

ALL DIMENSIONS ARE TO BE CONFIRMED BY THE BUILDER PRIOR TO CONSTRUCTION.
DO NOT SCALE FROM DRAWINGS.
BUILDING SET OUT & SITE BOUNDARY DETAILS TO BE CONFIRMED BY A REGISTERED SURVEYOR.
ALL WORK TO BE CARRIED OUT TO RELEVANT

STANDARDS AND BUILDING CODES.

- * ALL SURFACE LEVELS AND FEATURE LOCATIONS ARE TO BE CONFIRMED PRIOR TO CONSTRUCTION
- * THE PROPOSED RESIDENCE SLAB IS TO BE CONSTRUCTED ON A LEVEL BUILDING PAD PREPARED IN ACCORDANCE WITH THE STRUCTURAL ENGINEER'S SPECIFICATIONS.
 THE MAIN FINISHED FLOOR LEVEL IS TO BE SET MINIMUM
 300mm ABOVE THE CONSTRUCTION PAD LEVEL.
 FINISHED SURFACE LEVELS ARE TO GRADE AWAY FROM THE
 BUILDING PERIMETER TO PREVENT WATER PONDING
 NEAR EXTERNAL WALLS WITHOUT BEING DETRIMENTAL TO NEIGHBOURING PROPERTIES.

 THE BUILDER IS TO CONFIRM AVAILABLE FALLS TO SEWER
 CONNECTION POINTS & STORMWATER DISCHARGE POINTS
 PRIOR TO ESTABLISHING THE BUILDING FINISHED FLOOR LEVEL.

NOTES:

- 1. ALL RUNOFF & SEDIMENT CONTROL STRUCTURES TO BE MAINTAINED IN A FUNCTIONAL CONDITION.
- 2. ALL VEGETATION OUTSIDE THE DWELLING SITE WILL BE RETAINED.

→ SEDIMENT FENCE

 \ \\\\	VA-12	rananan
	A	
A		
▶ PRC)PER	TIES

DATE:	SCALE:	DRAWN:
03.12.21	1:200 (A3)	WP
SHEET:	JOB No:	ISSUE:

Ε

21088

4 / 6

DRAWING: SEDIMENT & EROSION CONTROL PLAN LOT 69 THE LOGAN, MUDGEE MAAS GROUP PROPERTIES



DWELLING A LANDSCAPING DETAILS


SITE AREA: 358.3 m²
GRAVEL TO SIDE: 1.2 m²
GARDEN BEDS: 46.4 m²
(LOW WATER GARDEN)
TURF: 99.8 m²
DRIVEWAY AREA: 33.6 m²
PATH AREA: 43.5 m²

NOTE — QUANTITIES ARE PROVIDED AS A GUIDE ONLY AND NOT TO BE RELIED UPON FOR CONTRACTUAL PURPOSES

DWELLING B LANDSCAPING DETAILS

SITE AREA: 444.4 m²
GRAVEL TO SIDE: 1.7 m²
GARDEN BEDS: 44.1 m²
(LOW WATER GARDEN)
TURF: 155.1 m²
DRIVEWAY AREA: 36.3 m²
PATH AREA: 39.1 m²

CONCRETE PATH

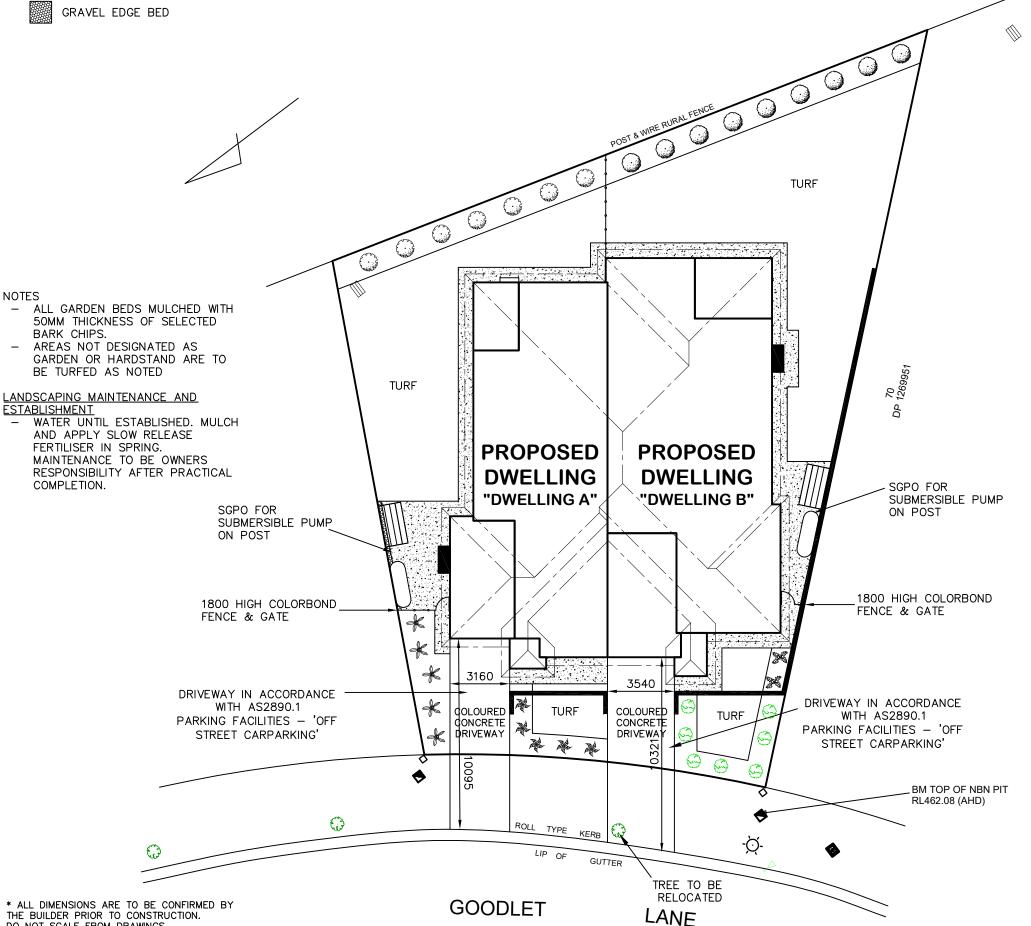

THE BUILDER PRIOR TO CONSTRUCTION.
DO NOT SCALE FROM DRAWINGS.
BUILDING SET OUT & SITE BOUNDARY DETAILS
TO BE CONFIRMED BY A REGISTERED
SURVEYOR.

SURVEYOR.

ALL WORK TO BE CARRIED OUT TO RELEVANT
STANDARDS AND BUILDING CODES.

* ALL SURFACE LEVELS AND FEATURE LOCATIONS ARE TO BE CONFIRMED PRIOR TO CONSTRUCTION

* THE PROPOSED RESIDENCE SLAB IS TO BE CONSTRUCTED ON A LEVEL BUILDING PAD PREPARED IN ACCORDANCE WITH THE STRUCTURAL ENGINEER'S SPECIFICATIONS.

THE MAIN FINISHED FLOOR LEVEL IS TO BE SET MINIMUM 300mm ABOVE THE CONSTRUCTION PAD LEVEL.

FINISHED SURFACE LEVELS ARE TO GRADE AWAY FROM THE BUILDING PERIMETER TO PREVENT WATER PONDING NEAR EXTERNAL WALLS WITHOUT BEING DETRIMENTAL TO NEIGHBOURING PROPERTIES.

THE BUILDER IS TO CONFIRM AVAILABLE FALLS TO SEWER CONNECTION POINTS & STORMWATER DISCHARGE POINTS PRIOR TO ESTABLISHING THE BUILDING FINISHED FLOOR LEVEL.

LEGEND:

Ε

A/C LOCATION TO BE CONFIRMED ON SITE

3000L POLY RAINWATER TANK

CLOTHESLINE

	Plant Schedule table	ht	spread
	Westringia zena	2m	2m
(3)	Oriental pearl	1m	0.4m
	Photinia robusta	3m	2m
*	Nandina obsession	0.6m	0.6m
×	Lomandra tanika	0.6m	0.6m
×	Viburnum tinus	1.5m	1m
			-



DATE:	SCALE:	DRAWN:
03.12.21	1:200 (A3)	WP
SHEET:	JOB No:	ISSUE:

21088

5 / 6

DRAWING: BASIX COMMITMENTS PLAN LOT 69 THE LOGAN, MUDGEE MAAS GROUP PROPERTIES



BASIX COMMITMENTS - DWELLING A WATER COMMITMENTS LANDSCAPE AREA LOW WATER USE SPECIES OF VEGETATION 46.4 SQ.M. MIN RATING FIXTURES SHOWER HEAD RATING 4 STAR 4 STAR 5 STAR 5 STAR SHOWER HEAD KAING
TOILET FLUSHING SYSTEM RATING
KITCHEN TAPS
BASIN TAPS
BASIN TAPS
ALTERNATIVE WATER
RAINWATER TANK
RAINWATER TANK CAPACITY
ROOF COLLECTION AREA FOR R/W 100 SQ.M. MIN 1 No. OUTDOOR TAP ALL TOILETS IN DWELLING THE COLD WATER TAP THAT SUPPLIES THE CLOTHES WASHER R/W TANK CONNECTED TO THERMAL COMFORT COMMITMENTS
GENERAL REQUIREMENTS -CLASS 1 DWELLING WITH NOT MORE THAN 2 STOREYS
CONDITIONED FLOOR AREA NOT EXCEEDING 300 SQUARE METRES
MUST NOT HAVE OPEN MEZZANINE OF MORE THAN 25 SQUARE METRES
NOT CONTAIN THIRD LEVEL HABITABLE ATTIC ROOM GROUND FLOOR CONSTRUCTION CONCRETE SLAB ON GROUND EXTERNAL WALL SHARED WITH GARAGE BRICK VENEER - R2.60 INC CONSTRUCTION NIL Flat Ceiling/Pitched Roof – Ceiling R4, Roof – Sarking – Unventilated – Dark (Solar Absorptance > 0.7) CFILING AND ROOF THERMAL COMFORT COMMITMENTS - WINDOWS & GLAZED DOORS WINDOW ORIENTATION MAXIMUM SHADING OVERSHADOWING MAXIMUM TYPE HEIGHT (mm WIDTH (mm) EAVE 600mm, 180mm ABOVE HEAD OF WINDOW OR GLAZED DOOR W01 1200 1500 ALUMINIUM, SINGLE, CLEAR NOT Overshadowed EAVE 600mm, 180mm ABOVE HEAD OF WINDOW OR GLAZED DOOR ALUMINIUM, SINGLE, CLEAR W02 1200 1500 NOT OVERSHADOWED ALUMINIUM, SINGLE, CLEAR EAVE 600mm, 180mm ABOVE HEAD OF WINDOW OR GLAZED DOOR W03 1800 900 NOT OVERSHADOWED EAVE 3000mm, 240mm ABOVE HEAD OF WINDOW OR GLAZED DOOR W04 N 2100 1800 ALUMINIUM, SINGLE, CLEAR NOT OVERSHADOWED EAVE 4200mm, 180mm ABOVE HEAD OF WINDOW OR GLAZED DOOR W05 ALUMINIUM, SINGLE, CLEAR Ε 1000 1200 NOT OVERSHADOWED W06 1800 ALUMINIUM, SINGLE, CLEAR EAVE 600mm, 180mm ABOVE HEAD OF WINDOW OR GLAZED DOOR Ε 600 NOT OVERSHADOWED EAVE 600mm, 180mm ABOVE HEAD OF WINDOW OR GLAZED DOOR W07 Ε 1800 600 ALUMINIUM, SINGLE, CLEAR NOT Overshadowed EAVE 600mm, 180mm ABOVE HEAD OF WINDOW OR GLAZED DOOR NOT Overshadowed 600 ALUMINIUM, SINGLE, CLEAR W08 1800 EAVE 600mm, 180mm ABOVE HEAD OF WINDOW OR GLAZED DOOR W09 W 1800 600 ALUMINIUM, SINGLE, CLEAR NOT Overshadowed ENERGY COMMITMENTS HOT WATER SYSTEM gas instantaneous – 5 star reverse cycle: eer 3.0–3.5 with day/night zoning between living/bed areas reverse cycle: eer 3.0–3.5 with day/night zoning between living/bed areas COOLING SYSTEM
HEATING SYSTEM
VENTILATION
BATHROOM EXTRACT FAN DUCTED TO ROOF OR FACADE — MANUAL ON/OFF EXTRACT FAN DUCTED TO ROOF OR FACADE — MANUAL ON/OFF EXTRACT FAN DUCTED TO ROOF OR FACADE — MANUAL ON/OFF KITCHEN Laundry ARTIFICIAL LIGHTING KITCHEN BATHROOMS/TOILETS PRIMARY TYPE OF ARTIFICIAL LIGHTING IS FLUORESCENT OR LIGHT EMITTING DIODE (LED) (DEDICATED)
PRIMARY TYPE OF ARTIFICIAL LIGHTING IS FLUORESCENT OR LIGHT EMITTING DIODE (LED) (DEDICATED)
PRIMARY TYPE OF ARTIFICIAL LIGHTING IS FLUORESCENT OR LIGHT EMITTING DIODE (LED) (DEDICATED)
PRIMARY TYPE OF ARTIFICIAL LIGHTING IS FLUORESCENT OR LIGHT EMITTING DIODE (LED) X 2 (DEDICATED)
PRIMARY TYPE OF ARTIFICIAL LIGHTING IS FLUORESCENT OR LIGHT EMITTING DIODE (LED) X 3 (DEDICATED)
PRIMARY TYPE OF ARTIFICIAL LIGHTING IS FLUORESCENT OR LIGHT EMITTING DIODE (LED) X 3 (DEDICATED) LAUNDRY HALL WAYS LIVING AREAS BEDROOMS NATURAL LIGHTING WINDOW x 1 KITCHEN BATHROOMS/TOILETS

These are the specifications upon which the Basix assessment is based. These specifications take precedence over the drawings or other specifications

WELL VENTILATED AS BASIX DEFINITION

OUTDOOR CLOTHES DRYING LINE

BASIX COMMITMENTS - DWELLING B WATER COMMITMENTS LANDSCAPE
AREA LOW WATER USE SPECIES OF VEGETATION
FIXTURES
SHOWER HEAD RATING 44.1 SQ.M. MIN RATING 4 STAR 4 STAR TOILET FLUSHING SYSTEM RATING KITCHEN TAPS BASIN TAPS ALTERNATIVE WATER
RAINWATER TANK
RAINWATER TANK CAPACITY
ROOF COLLECTION AREA FOR R/W 3000 LITRE 100 SQ.M.

THERMAL COMFORT COMMITMENTS GENERAL REQUIREMENTS

R/W TANK CONNECTED TO

CLASS 1 DWELLING WITH NOT MORE THAN 2 STOREYS

CONDITIONED FLOOR AREA NOT EXCEEDING 300 SQUARE METRES MUST NOT HAVE OPEN MEZZANINE OF MORE THAN 25 SQUARE METRES NOT CONTAIN THIRD LEVEL HABITABLE ATTIC ROOM GROUND FLOOR CONSTRUCTION CONCRETE SLAB ON GROUND

EXTERNAL WALL SHARED WITH GARAGE CEILING AND ROOF BRICK VENEER - R2.60 INC CONSTRUCTION FLAT CEILING/PITCHED ROOF — CEILING R4, ROOF — SARKING — UNVENTILATED — DARK (SOLAR ABSORPTANCE > 0.7)


MIN 1 No. OUTDOOR TAP ALL TOILETS IN DWELLING THE COLD WATER TAP THAT SUPPLIES THE CLOTHES WASHER

WINDOW	ORIENTATION	MAXIMUM HEIGHT (mm)	MAXIMUM WIDTH (mm)	TYPE	SHADING	OVERSHADOWING
W01	E	900	2700	ALUMINIUM, SINGLE, CLEAR	EAVE 600mm, 180mm ABOVE HEAD OF WINDOW OR GLAZED DOOR	NOT OVERSHADOWED
W02	E	2100	2600	ALUMINIUM, SINGLE, CLEAR	EAVE 3800mm, 240mm ABOVE HEAD OF WINDOW OR GLAZED DOOR	NOT OVERSHADOWED
W03	S	2100	2600	ALUMINIUM, SINGLE, CLEAR	EAVE 4680mm, 240mm ABOVE HEAD OF WINDOW OR GLAZED DOOR	NOT OVERSHADOWED
W04	s	1800	600	ALUMINIUM, SINGLE, CLEAR	EAVE 600mm, 180mm ABOVE HEAD OF WINDOW OR GLAZED DOOR	NOT OVERSHADOWED
W05	S	1800	600	ALUMINIUM, SINGLE, CLEAR	EAVE 600mm, 180mm ABOVE HEAD OF WINDOW OR GLAZED DOOR	NOT OVERSHADOWED
W06	s	900	2100	ALUMINIUM, SINGLE, CLEAR	EAVE 600mm, 180mm ABOVE HEAD OF WINDOW OR GLAZED DOOR	NOT OVERSHADOWED
W07	S	900	2100	ALUMINIUM, SINGLE, CLEAR	EAVE 600mm, 180mm ABOVE HEAD OF WINDOW OR GLAZED DOOR	NOT OVERSHADOWED
W08	s	900	1200	ALUMINIUM, SINGLE, CLEAR	EAVE 600mm, 180mm ABOVE HEAD OF WINDOW OR GLAZED DOOR	NOT OVERSHADOWED
W09	s	600	1800	ALUMINIUM, SINGLE, CLEAR	EAVE 600mm, 180mm ABOVE HEAD OF WINDOW OR GLAZED DOOR	NOT OVERSHADOWED
W10	w	1800	600	ALUMINIUM, SINGLE, CLEAR	EAVE 600mm, 180mm ABOVE HEAD OF WINDOW OR GLAZED DOOR	NOT OVERSHADOWED
W11	w	1800	600	ALUMINIUM, SINGLE, CLEAR	EAVE 600mm, 180mm ABOVE HEAD OF WINDOW OR GLAZED DOOR	NOT OVERSHADOWED
W12	w	1800	600	ALUMINIUM, SINGLE, CLEAR	EAVE 600mm, 180mm ABOVE HEAD OF WINDOW OR GLAZED DOOR	NOT OVERSHADOWED
ENERGY C HOT WATE COOLING S HEATING S VENTILATIO BATHROOM KITCHEN LAUNDRY	System System <u>In</u>	REVERSE CY REVERSE CY EXTRACT FA EXTRACT FA	(CLE: EER 3.5—4 N DUCTED TO R N DUCTED TO R	tar 1.0 with day/night zoning betwee 1.0 with day/night zoning betwee 100f or facade — Manual on/ofi 00f or facade — Manual on/ofi 00f or facade — Manual on/of	en lwing/bed areas F	•

ARTIFICIAL LIGHTING KITCHEN PRIMARY TYPE OF ARTIFICIAL LIGHTING IS FLUORESCENT OR LIGHT EMITTING DIODE (LED) (DEDICATED) BATHROOMS/TOILETS PRIMARY TYPE OF ARTIFICIAL LIGHTING IS FLUORESCENT OR LIGHT EMITTING DIODE (LED) (DEDICATED)
PRIMARY TYPE OF ARTIFICIAL LIGHTING IS FLUORESCENT OR LIGHT EMITTING DIODE (LED) (DEDICATED)
PRIMARY TYPE OF ARTIFICIAL LIGHTING IS FLUORESCENT OR LIGHT EMITTING DIODE (LED) (DEDICATED)
PRIMARY TYPE OF ARTIFICIAL LIGHTING IS FLUORESCENT OR LIGHT EMITTING DIODE (LED) X 2 (DEDICATED) LAUNDRY HALLWAYS LIVING AREAS BEDROOMS PRIMARY TYPE OF ARTIFICIAL LIGHTING IS FLUORESCENT OR LIGHT EMITTING DIODE (LED) X 3 (DEDICATED)

NATURAL LIGHTING KITCHEN BATHROOMS/TOILETS WINDOW x 1 <u>APPLIANCES</u> GAS COOKTOP & ELECTRIC OVEN KITCHEN WELL VENTILATED AS BASIX DEFINITION
OUTDOOR & INDOOR CLOTHES DRYING LINE REFRIGERATOR SPACE CLOTHES DRYING

These are the specifications upon which the Basix assessment is based. These specifications take precedence over the drawings or other specifications.

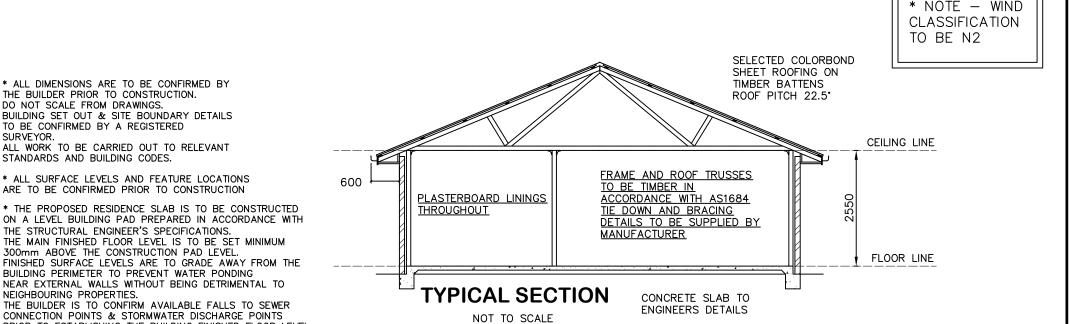

ALL DIMENSIONS ARE TO BE CONFIRMED BY

ALL WORK TO BE CARRIED OUT TO RELEVANT

ALL SURFACE LEVELS AND FEATURE LOCATIONS

PRIOR TO ESTABLISHING THE BUILDING FINISHED FLOOR LEVEL.

ARE TO BE CONFIRMED PRIOR TO CONSTRUCTION

THE STRUCTURAL ENGINEER'S SPECIFICATIONS.

DETAILS

6 / 6

THE BUILDER PRIOR TO CONSTRUCTION. DO NOT SCALE FROM DRAWINGS.

TO BE CONFIRMED BY A REGISTERED SURVEYOR.

STANDARDS AND BUILDING CODES.

NEIGHBOURING PROPERTIES.

<u>APPLIANCES</u> KITCHEN REFRIGERATOR SPACE

CLOTHES DRYING

DATE: SCALE: **DRAWN**: 03.12.21 N/A **WP** SHEET: JOB No: **ISSUE:**

Ε

21088

DRAWING:



BASIX COMMITMENTS & TYP SECTION LOT 69 THE LOGAN, MUDGEE MAAS GROUP PROPERTIES