


LIVING 135.64
GARAGE 24.27
PATIO 2.95
REAR PATIO 9.76

TOTAL 172.62 sq.m.
(18.58 sq.)

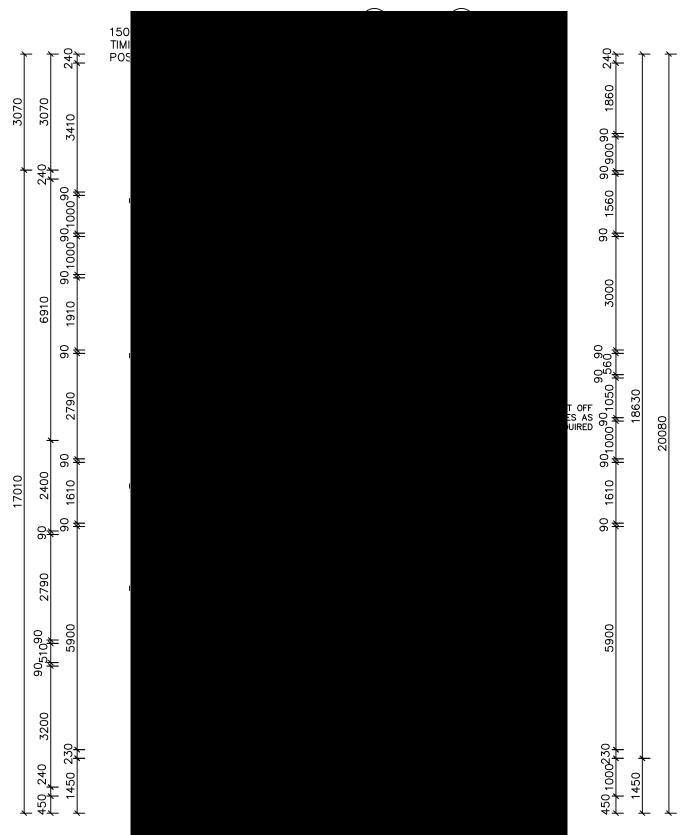

240	3590)	901000 50090	3110	240
11 240 **	1750 90	1750	11 11 11 90 1000 11	3700	11 240
11 240 **	1730 H 3000	24	11 11 0 1290 240	3700	11 240
11 230	3020	17 24	11 0 1290 230	3950	11
11		11	11 8950		1
├					─

NOTES - STAIR TREADS TO COMPLY WITH BCA 3.9.1.3

●SA SMOKE ALARM

EXHAUST FAN

* ALL DIMENSIONS ARE TO BE CONFIRMED BY THE BUILDER PRIOR TO CONSTRUCTION. DO NOT SCALE FROM DRAWINGS. BUILDING SET OUT & SITE BOUNDARY DETAILS TO BE CONFIRMED BY A REGISTERED

ALL EXTERNAL LIGHT FITTINGS ARE TO BE SHIELDED.

I.E. DOES NOT PERMIT LIGHT TO SHINE ABOVE THE HORIZONTAL PLANE.

* NOTE: EXTERNAL LIGHTING

SURVEYOR.
ALL WORK TO BE CARRIED OUT TO RELEVANT STANDARDS AND BUILDING CODES.

"ELIZABETH SG"

EXHAUST SYSTEMS INSTALLED (INCLUDING TASTIC & LIGHT VENT COMBO) TO HAVE MINIMUM FLOW RATE IN ACCORDANCE WITH PART 3.8.7 NCC 2019

EXHAUST SYSTEMS (INCLUDING TASTIC & LIGHT VENT COMBO) TO DISCHARGE TO OUTSIDE AIR OR VENTILATED ROOF SPACE AS PER PART 3.8.7 NCC 2019. METHOD CHOSEN IS TO MATCH COMPLIANCE WITH THE RELEVANT BASIX CERTIFICATE.

PLIABLE BUILDING MEMBRANE INSTALLED IN EXTERNAL WALLS TO BE A VAPOR PERMEABLE TYPE, COMPLY WITH AS/NZS 4200.1 AND BE INSTALLED AS PER AS4200.2

EXTERNAL DOORS AND OPENABLE WINDOWS IN CONDITIONED SPACES TO BE SEALED TO RESTRICT AIR INFILTRATION AS PER PART 3.12.3 NCC 2019



DATE:	SCALE:	DRAWN:
24.11.21	1:100 (A3)	WP
SHEET:	JOB No:	ISSUE:


D

21084

1 / 8


DRAWING: FLOOR PLAN - DWELLING A LOT 65 THE LOGAN, MUDGEE MAAS GROUP PROPERTIES



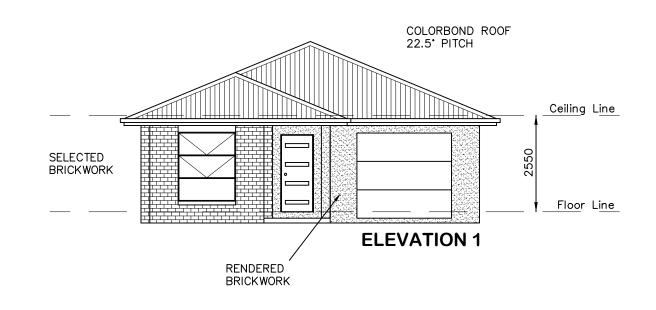





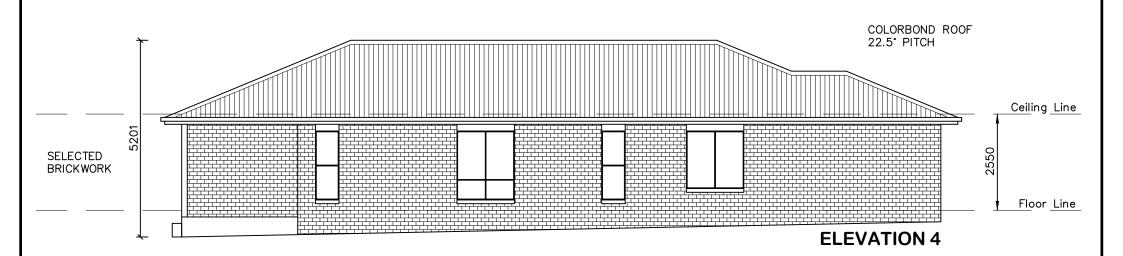

* ALL DIMENSIONS ARE TO BE CONFIRMED BY THE BUILDER PRIOR TO CONSTRUCTION. DO NOT SCALE FROM DRAWINGS. BUILDING SET OUT & SITE BOUNDARY DETAILS TO BE CONFIRMED BY A REGISTERED SURVEYOR.
ALL WORK TO BE CARRIED OUT TO RELEVANT STANDARDS AND BUILDING CODES.

"ELIZABETH SG"



	SCALE: 1:100 (A3)	DRAWN: WP
SHEET:	JOB No:	ISSUE:

D


21084

2 / 8

DRAWING: ELEVATIONS - DWELLING A LOT 65 THE LOGAN, MUDGEE MAAS GROUP PROPERTIES






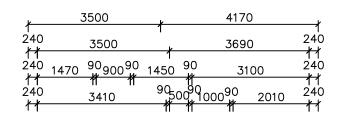

LIVING 140.78
GARAGE 20.81
PATIO 1.94
REAR PATIO 11.55

175.08 sq.m. (18.85 sq.)

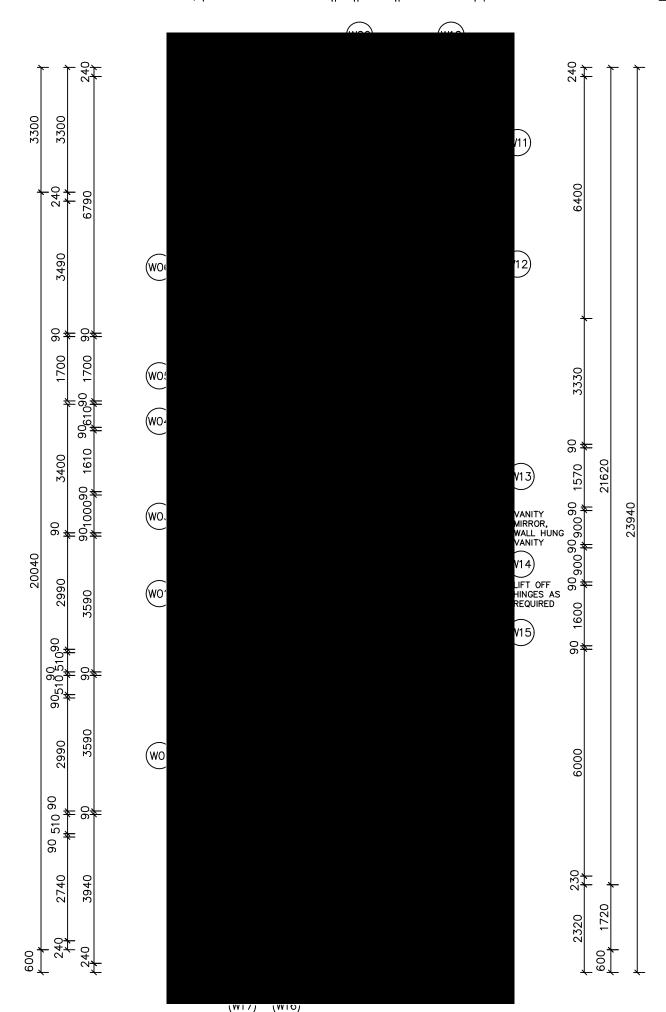

NOTES - STAIR TREADS TO COMPLY WITH BCA 3.9.1.3

●SA SMOKE ALARM

8 EXHAUST FAN

EXHAUST SYSTEMS INSTALLED (INCLUDING TASTIC & LIGHT VENT COMBO) TO HAVE MINIMUM FLOW RATE IN ACCORDANCE WITH PART 3.8.7 NCC 2019

EXHAUST SYSTEMS (INCLUDING TASTIC & LIGHT VENT COMBO) TO DISCHARGE TO OUTSIDE AIR OR VENTILATED ROOF SPACE AS PER PART 3.8.7 NCC 2019. METHOD CHOSEN IS TO MATCH COMPLIANCE WITH THE RELEVANT BASIX CERTIFICATE.

PLIABLE BUILDING MEMBRANE INSTALLED IN EXTERNAL WALLS TO BE A VAPOR PERMEABLE TYPE, COMPLY WITH AS/NZS 4200.1 AND BE INSTALLED AS PER AS4200.2

EXTERNAL DOORS AND OPENABLE WINDOWS IN CONDITIONED SPACES TO BE SEALED TO RESTRICT AIR INFILTRATION AS PER PART 3.12.3 NCC 2019

* NOTE: EXTERNAL LIGHTING

ALL EXTERNAL LIGHT FITTINGS ARE TO BE SHIELDED.
I.E. DOES NOT PERMIT LIGHT TO SHINE ABOVE THE HORIZONTAL PLANE.

* ALL DIMENSIONS ARE TO BE CONFIRMED BY THE BUILDER PRIOR TO CONSTRUCTION. DO NOT SCALE FROM DRAWINGS. BUILDING SET OUT & SITE BOUNDARY DETAILS TO BE CONFIRMED BY A REGISTERED SURVEYOR. ALL WORK TO BE CARRIED OUT TO RELEVANT


"TALBRAGAR SG"

	AC
A	
▶PROF	PERTIES

STANDARDS AND BUILDING CODES.

DATE: 24.11.21	SCALE: 1:100 (A3)	DRAWN: WP	DRAWING: FLOOR PLAN - DWELLING B LOT 65 THE LOGAN, MUDGEE
SHEET: 3 / 8	JOB No: 21084	ISSUE:	MAAS GROUP PROPERTIES



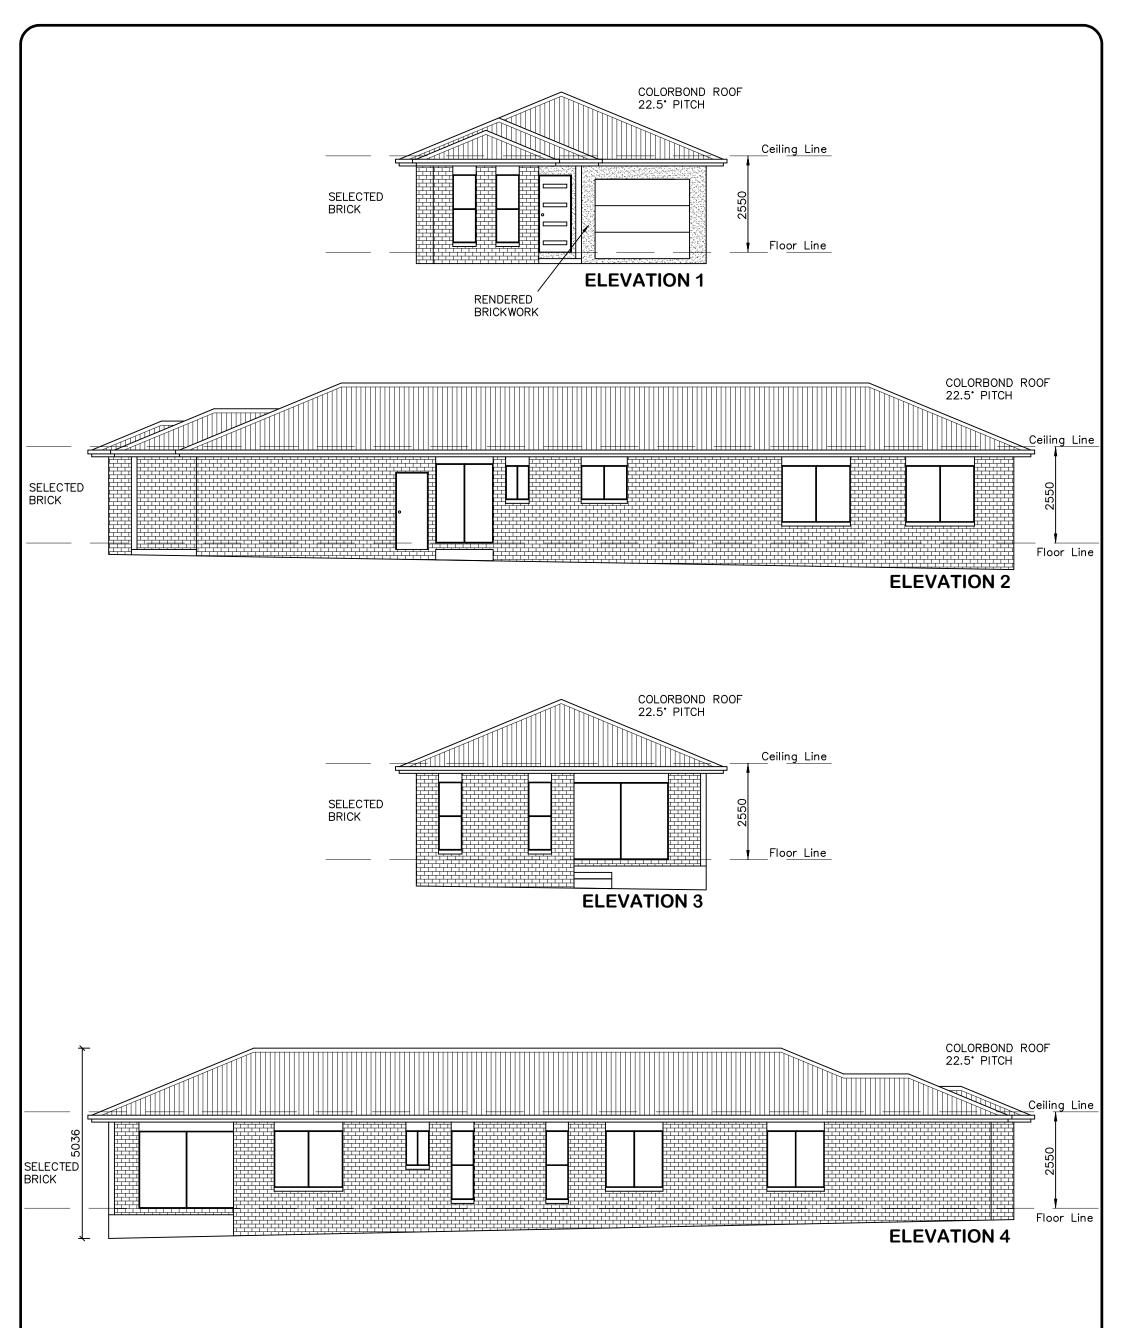

* ALL DIMENSIONS ARE TO BE CONFIRMED BY THE BUILDER PRIOR TO CONSTRUCTION. DO NOT SCALE FROM DRAWINGS. BUILDING SET OUT & SITE BOUNDARY DETAILS TO BE CONFIRMED BY A REGISTERED SURVEYOR.
ALL WORK TO BE CARRIED OUT TO RELEVANT STANDARDS AND BUILDING CODES.

"TALBRAGAR SG"



DATE:	SCALE:	DRAWN:
24.11.21	1:100 (A3)	WP
SHEET:	JOB No:	ISSUE:


D


21084

4 / 8

DRAWING: ELEVATIONS - DWELLING B LOT 65 THE LOGAN, MUDGEE MAAS GROUP PROPERTIES



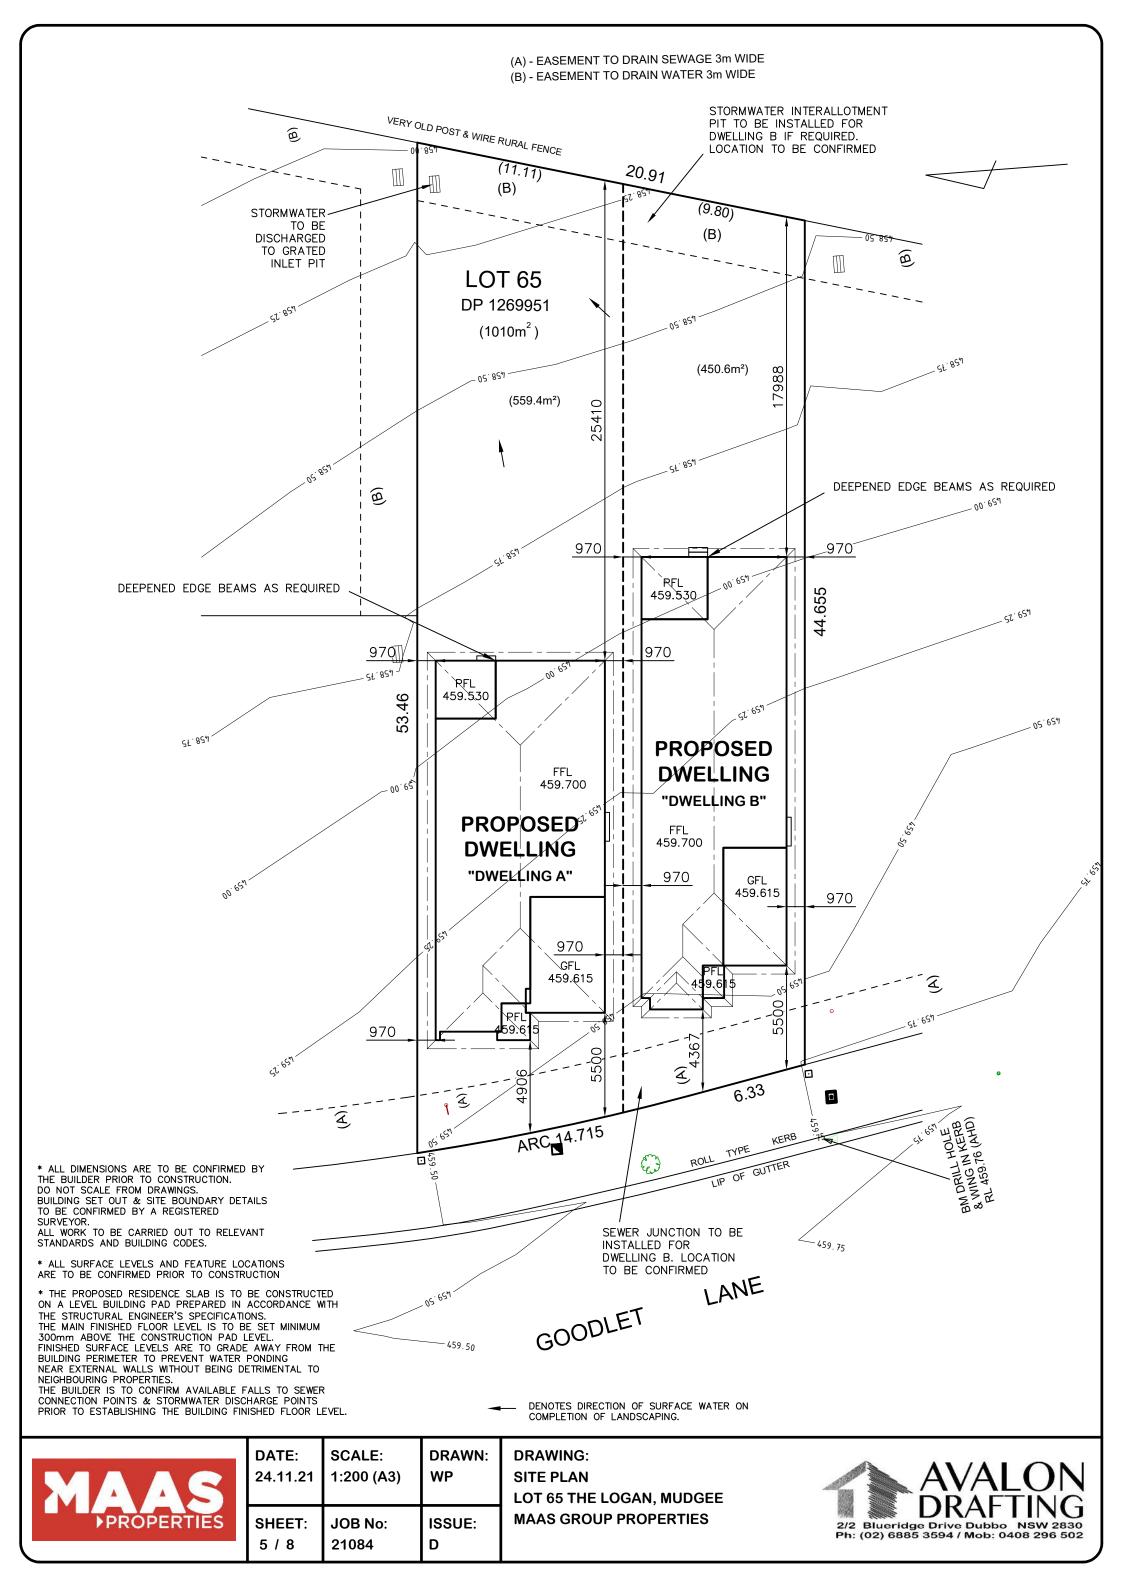

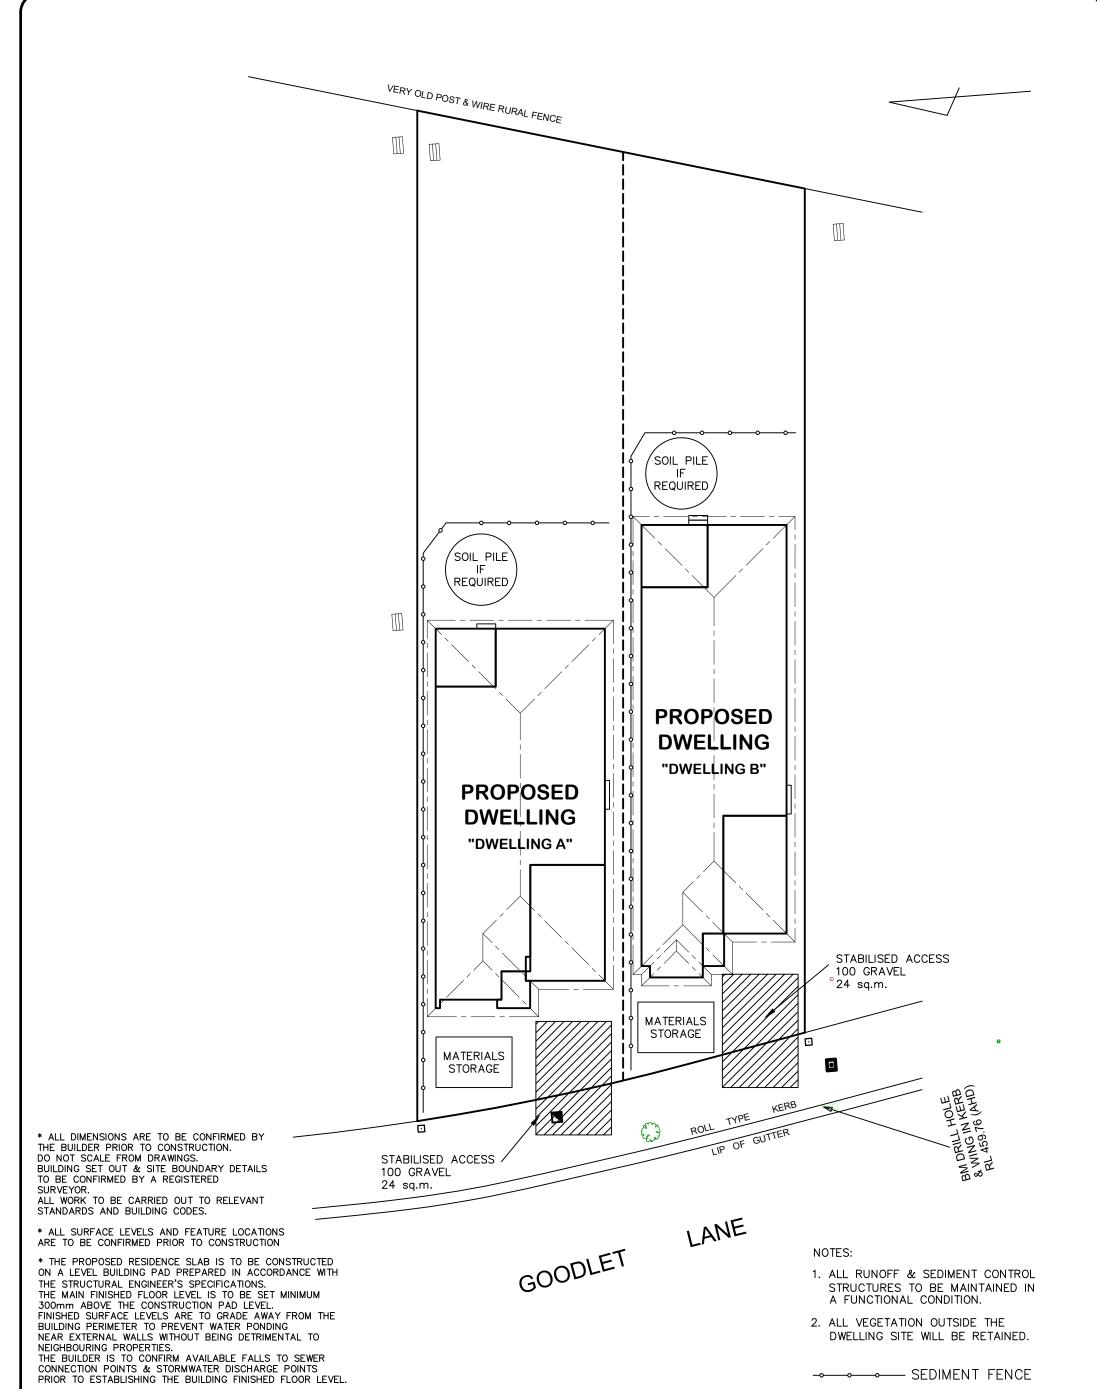

	AG
PROP	ERTIES
ri Kor	LIXTILS

DATE: SCALE: **DRAWN**: 24.11.21 1:200 (A3) **WP ISSUE**: SHEET: JOB No:

D


21084

6 / 8

DRAWING: EROSION & SEDIMENT CONTROL PLAN LOT 65 THE LOGAN, MUDGEE MAAS GROUP PROPERTIES



→ SEDIMENT FENCE

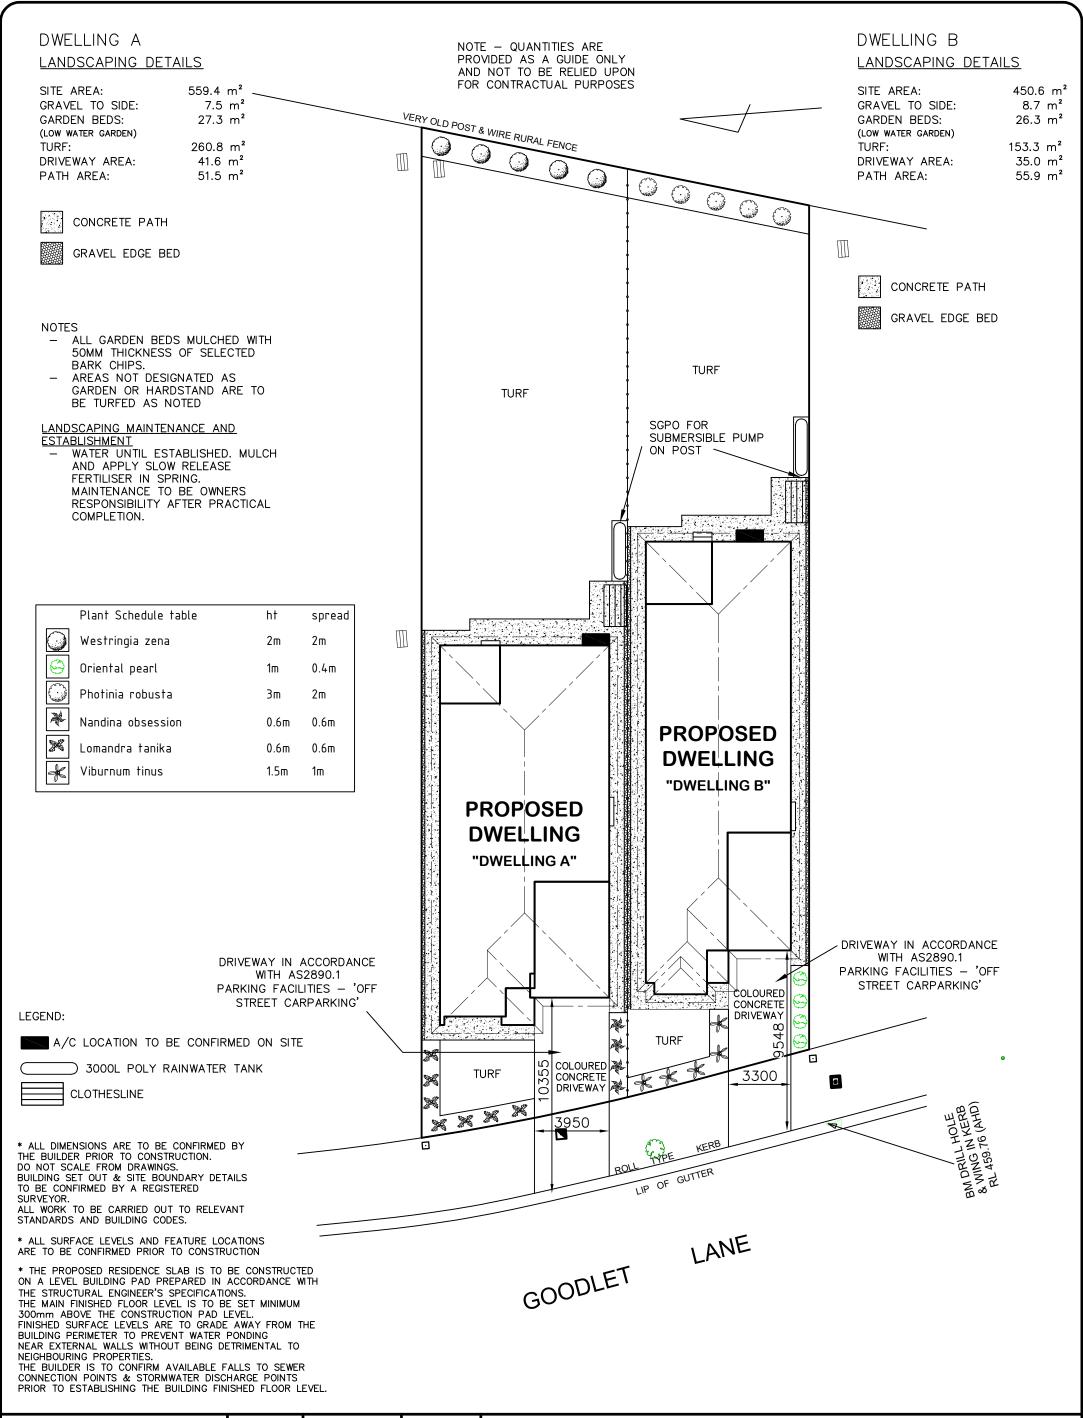



DATE:	SCALE:	DRAWN:
24.11.21	1:200 (A3)	WP
SHEET:	JOB No:	ISSUE:

D

21084

7 / 8

DRAWING:
BASIX COMMITMENTS PLAN
LOT 65 THE LOGAN, MUDGEE
MAAS GROUP PROPERTIES



BASIX COMMITMENTS - DWELLING A WATER COMMITMENTS LANDSCAPE AREA LOW WATER USE SPECIES OF VEGETATION 27.3 SQ.M. MIN RATING FIXTURES
SHOWER HEAD RATING 4 STAR 4 STAR 5 STAR 5 STAR STOWER HEAD ANING
KITCHEN TAPS
BASIN TAPS
ALTERNATIVE WAITER
RAINWATER TANK
RAINWATER TANK
RAINWATER TANK CAPACITY
ROOF COLLECTION AFFA FOR R /A ROOF COLLECTION AREA FOR R/W 100 SQ.M. MIN 1 No. OUTDOOR TAP ALL TOILETS IN DWELLING THE COLD WATER TAP THAT SUPPLIES THE CLOTHES WASHER R/W TANK CONNECTED TO THERMAL COMFORT COMMITMENTS CLASS 1 DWELLING WITH NOT MORE THAN 2 STOREYS
CONDITIONED FLOOR AREA NOT EXCEEDING 300 SQUARE METRES
MUST NOT HAVE OPEN MEZZANINE OF MORE THAN 25 SQUARE METRES
NOT CONTAIN THIRD LEVEL HABITABLE ATTIC ROOM GENERAL REQUIREMENTS CONCRETE SLAB ON GROUND GROUND FLOOR CONSTRUCTION external wall internal wall shared with garage BRICK VENEER - R2.60 INC CONSTRUCTION NIL FLAT CEILING/PITCH<u>ED ROO</u>F — CEILING R4, ROOF — SARKING — UNIVENTILATED — DARK (SOLAR ABSORPTANCE > 0.7) CFILING AND ROOF THERMAL COMFORT COMMITMENTS - WINDOWS & GLAZED DOORS ORIENTATION MAXIMUM SHADING OVERSHADOWING WINDOW MAXIMUM TYPE HEIGHT (mm WIDTH (mm) EAVE 600mm, 180mm ABOVE HEAD OF WINDOW OR GLAZED DOOR W01 1500 1500 ALUMINIUM, SINGLE, CLEAR NOT Overshadowed EAVE 600mm, 180mm ABOVE HEAD OF WINDOW OR GLAZED DOOR ALUMINIUM, SINGLE, CLEAR W02 N 1800 600 not Overshadowed ALUMINIUM, SINGLE, CLEAR EAVE 600mm, 180mm ABOVE HEAD OF WINDOW OR GLAZED DOOR W03 1800 1500 NOT OVERSHADOWED EAVE 600mm, 180mm ABOVE HEAD OF WINDOW OR GLAZED DOOR W04 N 1800 600 ALUMINIUM, SINGLE, CLEAR NOT OVERSHADOWED EAVE 3670mm, 240mm ABOVE HEAD OF WINDOW OR GLAZED DOOR ALUMINIUM, SINGLE, CLEAR W05 Ε 2100 2100 NOT OVERSHADOWED W06 1800 ALUMINIUM, SINGLE, CLEAR EAVE 600mm, 180mm ABOVE HEAD OF WINDOW OR GLAZED DOOR Ε 2400 NOT OVERSHADOWED EAVE 600mm, 180mm ABOVE HEAD OF WINDOW OR GLAZED DOOR W07 Ε 900 600 ALUMINIUM, SINGLE, CLEAR NOT Overshadowed EAVE 600mm, 180mm ABOVE HEAD OF WINDOW OR GLAZED DOOR NOT Overshadowed 1500 ALUMINIUM, SINGLE, CLEAR W08 S 1500 EAVE 600mm, 240mm ABOVE HEAD OF WINDOW OR GLAZED DOOR W09 S 2100 1500 ALUMINIUM, SINGLE, CLEAR NUI OVERSHADOWED FAVF 600mm. 180mm ABOVE HEAD S 600 ALUMINIUM, SINGLE, CLEAR W10 900 NOT OVERSHADOWED OF WINDOW OR GLAZED DOOR EAVE 600mm, 180mm ABOVE HEAD OF WINDOW OR GLAZED DOOR W11 S 900 1200 ALUMINIUM, SINGLE, CLEAR NOT OVERSHADOWED EAVE 1050mm, 180mm ABOVE HEAD OF WINDOW OR GLAZED DOOR ALUMINIUM, SINGLE, CLEAR 1500 W12 W 1800 NOT OVERSHADOWED ENERGY COMMITMENTS HOT WATER SYSTEM COOLING SYSTEM HEATING SYSTEM GAS INSTANTANEOUS - 5 STAR REVERSE CYCLE: EER 3.0-3.5 WITH DAY/NIGHT ZONING BETWEEN LIVING/BED AREAS REVERSE CYCLE: EER 3.0-3.5 WITH DAY/NIGHT ZONING BETWEEN LIVING/BED AREAS VENTILATION BATHROOM EXTRACT FAN DUCTED TO ROOF OR FACADE - MANUAL ON/OFF EXTRACT FAN DUCTED TO ROOF OR FACADE - MANUAL ON/OFF KITCHEN ARTIFICIAL LIGHTING PRIMARY TYPE OF ARTIFICIAL LICHTING IS FLUORESCENT OR LIGHT EMITTING DIODE (LED) PRIMARY TYPE OF ARTIFICIAL LIGHTING IS FLUORESCENT OR LIGHT EMITTING DIODE (LED) PRIMARY TYPE OF ARTIFICIAL LIGHTING IS FLUORESCENT OR LIGHT EMITTING DIODE (LED) BATHROOMS/TOILETS LAUNDRY

These are the specifications upon which the Basix assessment is based. These specifications take precedence over the drawings or other specifications

PRIMARY TYPE OF ARTIFICIAL LIGHTING IS FLUORESCENT OR LIGHT EMITTING DIODE (LED

PRIMARY TYPE OF ARTIFICIAL LIGHTING IS FLUORESCENT OR LIGHT EMITTING DIODE (LED) X 2 PRIMARY TYPE OF ARTIFICIAL LIGHTING IS FLUORESCENT OR LIGHT EMITTING DIODE (LED) X 4

BASIX COMMITMENTS - DWELLING B

WATER COMMITMENTS

LANDSCAPE
AREA LOW WATER USE SPECIES OF VEGETATION
FIXTURES
SHOWER HEAD RATING

TOILET FLUSHING SYSTEM RATING KITCHEN TAPS BASIN TAPS ALTERNATIVE WATER
RAINWATER TANK
RAINWATER TANK CAPACITY
ROOF COLLECTION AREA FOR R/W 26.3 SQ.M. MIN RATING 4 STAR 4 STAR

100 SQ.M.

MIN 1 No. OUTDOOR TAP ALL TOILETS IN DWELLING

THERMAL COMFORT COMMITMENTS

R/W TANK CONNECTED TO

GENERAL REQUIREMENTS

CLASS 1 DWELLING WITH NOT MORE THAN 2 STOREYS CONDITIONED FLOOR AREA NOT EXCEEDING 300 SQUARE METRES MUST NOT HAVE OPEN MEZZANINE OF MORE THAN 25 SQUARE METRES NOT CONTAIN THIRD LEVEL HABITABLE ATTIC ROOM

THE COLD WATER TAP THAT SUPPLIES THE CLOTHES WASHER

GROUND FLOOR CONSTRUCTION

CONCRETE SLAB ON GROUND BRICK VENEER - R2.60 INC CONSTRUCTION

EXTERNAL WALL SHARED WITH GARAGE CEILING AND ROOF

FLAT CEILING/PITCHED ROOF — CEILING R4, ROOF — SARKING — UNVENTILATED — DARK (SOLAR ABSORPTANCE > 0.7)

WINDOW	ORIENTATION	MAXIMUM HEIGHT (mm)	MAXIMUM WIDTH (mm)	TYPE	SHADING	OVERSHADOWING
W01	N	1500	1500	ALUMINIUM, SINGLE, CLEAR	EAVE 4090mm, 240mm ABOVE HEAD OF WINDOW OR GLAZED DOOR	NOT OVERSHADOWED
W02	N	1500	1500	ALUMINIUM, SINGLE, CLEAR	EAVE 600mm, 180mm ABOVE HEAD OF WINDOW OR GLAZED DOOR	NOT OVERSHADOWED
W03	N	1800	600	ALUMINIUM, SINGLE, CLEAR	EAVE 600mm, 240mm ABOVE HEAD OF WINDOW OR GLAZED DOOR	NOT OVERSHADOWED
W04	N	1800	600	ALUMINIUM, SINGLE, CLEAR	EAVE 600mm, 180mm ABOVE HEAD OF WINDOW OR GLAZED DOOR	NOT OVERSHADOWED
W05	N	900	600	ALUMINIUM, SINGLE, CLEAR	EAVE 150mm, 180mm ABOVE HEAD OF WINDOW OR GLAZED DOOR	NOT OVERSHADOWED
W06	N	1500	1800	ALUMINIUM, SINGLE, CLEAR	EAVE 150mm, 180mm ABOVE HEAD OF WINDOW OR GLAZED DOOR	NOT OVERSHADOWED
W 07	N	2100	2600	ALUMINIUM, SINGLE, CLEAR	EAVE 4100mm, 240mm ABOVE HEAD OF WINDOW OR GLAZED DOOR	NOT OVERSHADOWED
W08	E	2100	2600	ALUMINIUM, SINGLE, CLEAR	EAVE 3900mm, 240mm ABOVE HEAD OF WINDOW OR GLAZED DOOR	NOT OVERSHADOWED
W09	E	1800	600	ALUMINIUM, SINGLE, CLEAR	EAVE 600mm, 180mm ABOVE HEAD OF WINDOW OR GLAZED DOOR	NOT OVERSHADOWED
W 10	E	1800	600	ALUMINIUM, SINGLE, CLEAR	EAVE 600mm, 180mm ABOVE HEAD OF WINDOW OR GLAZED DOOR	NOT OVERSHADOWED
W11	s	1500	1800	ALUMINIUM, SINGLE, CLEAR	EAVE 600mm, 180mm ABOVE HEAD OF WINDOW OR GLAZED DOOR	NOT OVERSHADOWED
W12	s	1500	1800	ALUMINIUM, SINGLE, CLEAR	EAVE 600mm, 180mm ABOVE HEAD OF WINDOW OR GLAZED DOOR	NOT OVERSHADOWED
W13	S	900	1200	ALUMINIUM, SINGLE, CLEAR	EAVE 600mm, 180mm ABOVE HEAD OF WINDOW OR GLAZED DOOR	NOT OVERSHADOWED
W14	S	900	600	ALUMINIUM, SINGLE, CLEAR	EAVE 600mm, 180mm ABOVE HEAD OF WINDOW OR GLAZED DOOR	NOT OVERSHADOWED
W 15	s	2100	1500	ALUMINIUM, SINGLE, CLEAR	EAVE 600mm, 240mm ABOVE HEAD OF WINDOW OR GLAZED DOOR	NOT OVERSHADOWED
W16	w	1800	600	ALUMINIUM, SINGLE, CLEAR	EAVE 600mm, 180mm ABOVE HEAD OF WINDOW OR GLAZED DOOR	NOT OVERSHADOWED
W 17	w	1800	600	ALUMINIUM, SINGLE, CLEAR	EAVE 600mm, 180mm ABOVE HEAD OF WINDOW OR GLAZED DOOR	NOT OVERSHADOWED
	YSTEM <u>N</u>	REVERSE CY REVERSE CY	CLE: EER 3.0-	STAR 3.5 WITH DAY/NIGHT ZONING BETWEE 3.5 WITH DAY/NIGHT ZONING BETWEE COOF OR FACADE — MANUAL ON/OF	EN LIVING/BED AREAS	•

KITCHEN EXTRACT FAN DUCTED TO ROOF OR FACADE - MANUAL ON/OFF LAUNDRY ARTIFICIAL LIGHTING KITCHEN PRIMARY TYPE OF ARTIFICIAL LIGHTING IS FLUORESCENT OR LIGHT EMITTING DIODE (LED

BATHROOMS/TOILETS LAUNDRY HALLWAYS PRIMARY TYPE OF ARTIFICIAL LIGHTING IS FLUORESCENT OR LIGHT EMITTING DIODE (LED)
PRIMARY TYPE OF ARTIFICIAL LIGHTING IS FLUORESCENT OR LIGHT EMITTING DIODE (LED)
PRIMARY TYPE OF ARTIFICIAL LIGHTING IS FLUORESCENT OR LIGHT EMITTING DIODE (LED) LIVING AREAS BEDROOMS PRIMARY TYPE OF ARTIFICIAL LIGHTING IS FLUORESCENT OR LIGHT EMITTING DIODE (LED) X 3 PRIMARY TYPE OF ARTIFICIAL LIGHTING IS FLUORESCENT OR LIGHT EMITTING DIODE (LED) X 4

NATURAL LIGHTING KITCHEN BATHROOMS/TOILETS WINDOW x 3 <u>APPLIANCES</u>

KITCHEN REFRIGERATOR SPACE CLOTHES DRYING WELL VENTILATED AS BASIX DEFINITION OUTDOOR CLOTHES DRYING LINE

These are the specifications upon which the Basix assessment is based. These specifications take precedence over the drawings or other specifications.

ALL DIMENSIONS ARE TO BE CONFIRMED BY THE BUILDER PRIOR TO CONSTRUCTION. DO NOT SCALE FROM DRAWINGS. DETAILS TO BE CONFIRMED BY A REGISTERED SURVEYOR. ALL WORK TO BE CARRIED OUT TO RELEVANT STANDARDS AND BUILDING CODES.

WINDOW x 1 WINDOW x 3

WELL VENTILATED AS BASIX DEFINITION OUTDOOR CLOTHES DRYING LINE

HALLWAYS LIVING AREAS BEDROOMS

APPLIANCES KITCHEN REFRIGERATOR SPACE

NATURAL LIGHTING

CLOTHES DRYING

KITCHEN Bathrooms/Toilets

ALL SURFACE LEVELS AND FEATURE LOCATIONS ARE TO BE CONFIRMED PRIOR TO CONSTRUCTION

THE PROPOSED RESIDENCE SLAB IS TO BE CONSTRUCTED ON A LEVEL BUILDING PAD PREPARED IN ACCORDANCE WITH THE STRUCTURAL ENGINEER'S SPECIFICATIONS. THE MAIN FINISHED FLOOR LEVEL IS TO BE SET MINIMUM 300mm ABOVE THE CONSTRUCTION PAD LEVEL. FINISHED SURFACE LEVELS ARE TO GRADE AWAY FROM THE BUILDING PERIMETER TO PREVENT WATER PONDING NEAR EXTERNAL WALLS WITHOUT BEING DETRIMENTAL TO NEIGHBOURING PROPERTIES. THE BUILDER IS TO CONFIRM AVAILABLE FALLS TO SEWER CONNECTION POINTS & STORMWATER DISCHARGE POINTS PRIOR TO ESTABLISHING THE BUILDING FINISHED FLOOR LEVEL.

TO BE N2 SELECTED COLORBOND SHEET ROOFING ON ROOF PITCH 22.5° CEILING LINE FRAME AND ROOF TRUSSES 600 TO BE TIMBER IN PLASTERBOARD LININGS ACCORDANCE WITH AS1684 TIE DOWN AND BRACING
DETAILS TO BE SUPPLIED BY
MANUFACTURER <u>THROUGHOUT</u> FLOOR LINE TYPICAL SECTION CONCRETE SLAB TO **ENGINEERS DETAILS**

DATE: SCALE: **DRAWN**: 24.11.21 N/A **WP** SHEET: JOB No: **ISSUE:**

D

21084

8 / 8

DRAWING: BASIX COMMITMENTS & TYP SECTION LOT 65 THE LOGAN, MUDGEE

NOT TO SCALE



* NOTE - WIND CLASSIFICATION

MAAS GROUP PROPERTIES Ph: (02) 6885 3594 / Mob: 0408 296 502