


1950

6005

LIVING 139.77
GARAGE 37.98
PATIO 4.48
REAR PATIO 11.54
TOTAL 193.77 sq.m.
(20.86 sq.)

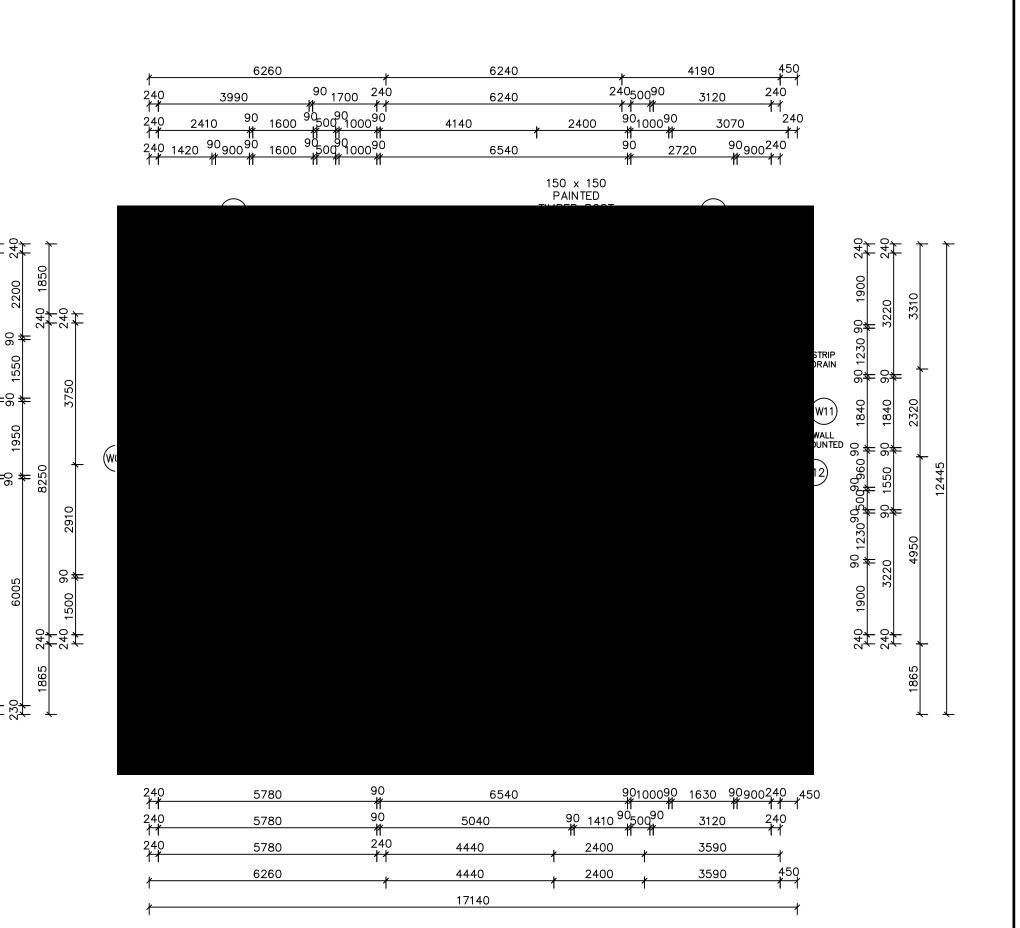

* NOTE: EXTERNAL LIGHTING

ALL EXTERNAL LIGHT FITTINGS ARE TO BE SHIELDED.

I.E. DOES NOT PERMIT LIGHT TO SHINE ABOVE THE HORIZONTAL PLANE.

* ALL DIMENSIONS ARE TO BE CONFIRMED BY THE BUILDER PRIOR TO CONSTRUCTION. DO NOT SCALE FROM DRAWINGS. BUILDING SET OUT & SITE BOUNDARY DETAILS TO BE CONFIRMED BY A REGISTERED SURVEYOR. ALL WORK TO BE CARRIED OUT TO RELEVANT STANDARDS AND BUILDING CODES.

NOTES - STAIR TREADS TO COMPLY WITH BCA 3.9.1.3

●SA SMOKE ALARM

EXHAUST FAN

"ARGYLE"

Ε

EXHAUST SYSTEMS INSTALLED (INCLUDING TASTIC & LIGHT VENT COMBO) TO HAVE MINIMUM FLOW RATE IN ACCORDANCE WITH PART 3.8.7 NCC 2019

EXHAUST SYSTEMS (INCLUDING TASTIC & LIGHT VENT COMBO) TO DISCHARGE TO OUTSIDE AIR OR VENTILATED ROOF SPACE AS PER PART 3.8.7 NCC 2019. METHOD CHOSEN IS TO MATCH COMPLIANCE WITH THE RELEVANT BASIX CERTIFICATE.

PLIABLE BUILDING MEMBRANE INSTALLED IN EXTERNAL WALLS TO BE A VAPOR PERMEABLE TYPE, COMPLY WITH AS/NZS 4200.1 AND BE INSTALLED AS PER AS4200.2

EXTERNAL DOORS AND OPENABLE WINDOWS IN CONDITIONED SPACES TO BE SEALED TO RESTRICT AIR INFILTRATION AS PER PART 3.12.3 NCC 2019




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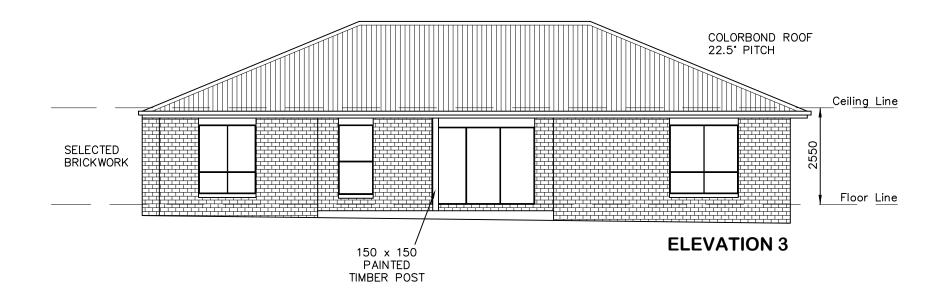
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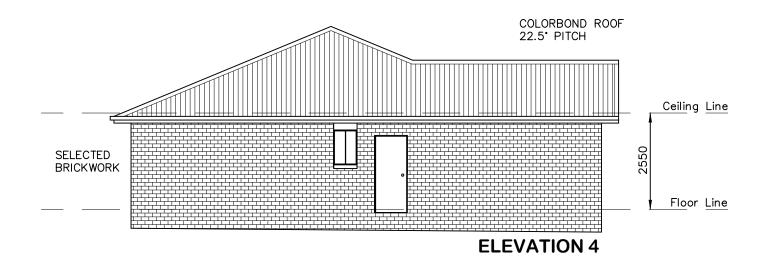
1 / 8

DRAWING: FLOOR PLAN - DWELLING A LOT 62 THE LOGAN, MUDGEE MAAS GROUP PROPERTIES







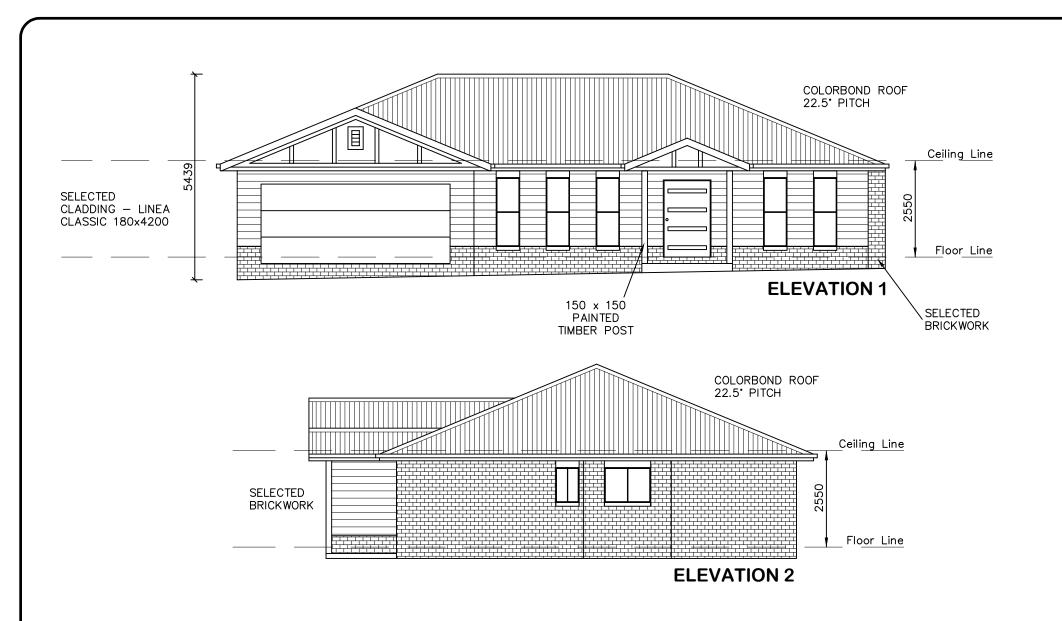

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DO NOT SCALE FROM DRAWINGS.
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ALL WORK TO BE CARRIED OUT TO RELEVANT STANDARDS AND BUILDING CODES.



DATE: 24.11.21	SCALE: 1:100 (A3)	DRAWN: WP
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DRAWING: ELEVATIONS - DWELLING A LOT 62 THE LOGAN, MUDGEE MAAS GROUP PROPERTIES







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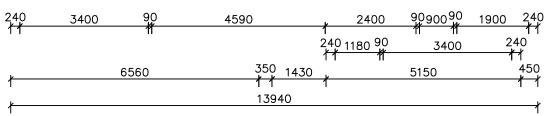
3100

45

LIVING 146.63 **GARAGE** 23.55 **PATIO** 3.04 **REAR PATIO** 10.82 TOTAL 184.04 sq.m. (19.81 sq.)



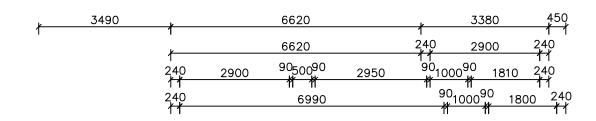

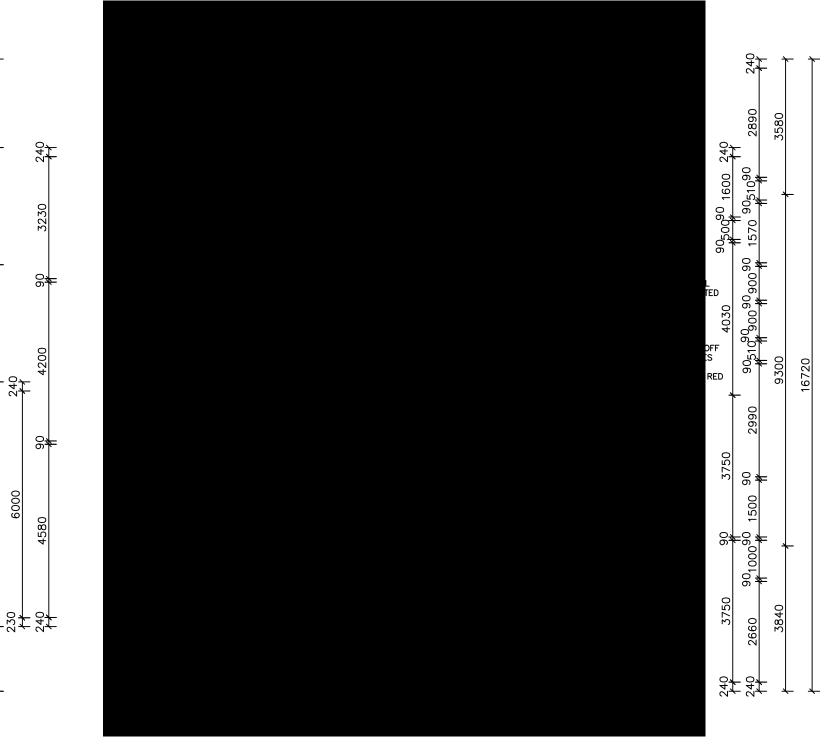

* NOTE: EXTERNAL LIGHTING ALL EXTERNAL LIGHT FITTINGS ARE TO BE SHIELDED. I.E. DOES NOT PERMIT LIGHT TO SHINE ABOVE THE HORIZONTAL PLANE.

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NOTES - STAIR TREADS TO COMPLY WITH BCA 3.9.1.3

> SMOKE ALARM SA

8 EXHAUST FAN

"GIPPS SG"

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EXHAUST SYSTEMS INSTALLED (INCLUDING TASTIC & LIGHT VENT COMBO) TO HAVE MINIMUM FLOW RATE IN ACCORDANCE WITH PART 3.8.7 NCC 2019

EXHAUST SYSTEMS (INCLUDING TASTIC & LIGHT VENT COMBO) TO DISCHARGE TO OUTSIDE AIR OR VENTILATED ROOF SPACE AS PER PART 3.8.7 NCC 2019. METHOD CHOSEN IS TO MATCH COMPLIANCE WITH THE RELEVANT BASIX CERTIFICATE.

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EXTERNAL DOORS AND OPENABLE WINDOWS IN CONDITIONED SPACES TO BE SEALED TO RESTRICT AIR INFILTRATION AS PER PART 3.12.3 NCC 2019




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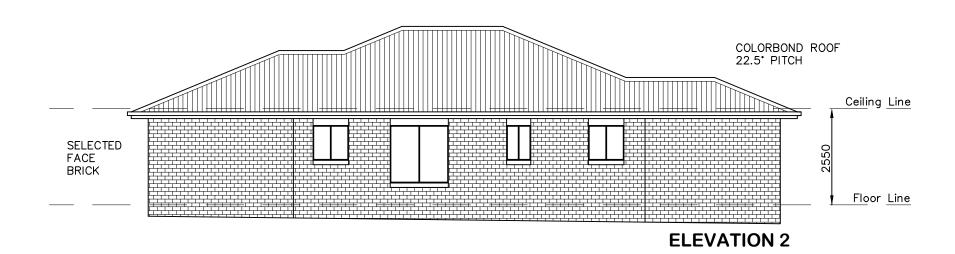
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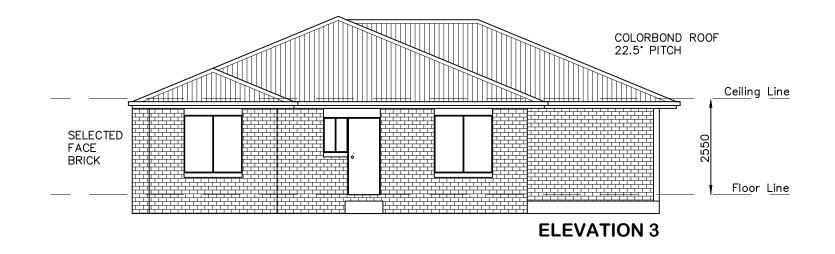
3 / 8


DRAWING: FLOOR PLAN - DWELLING B **LOT 62 THE LOGAN, MUDGEE MAAS GROUP PROPERTIES**







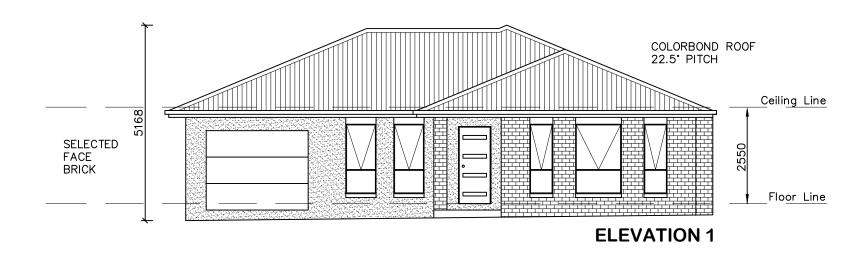

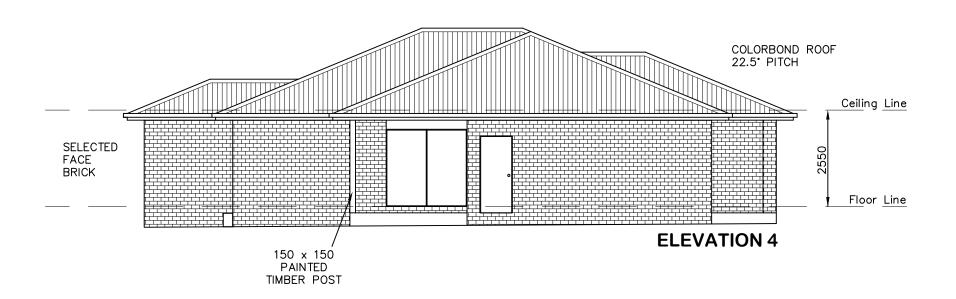

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BUILDING SET OUT & SITE BOUNDARY DETAILS TO BE CONFIRMED BY A REGISTERED SURVEYOR.
ALL WORK TO BE CARRIED OUT TO RELEVANT STANDARDS AND BUILDING CODES.

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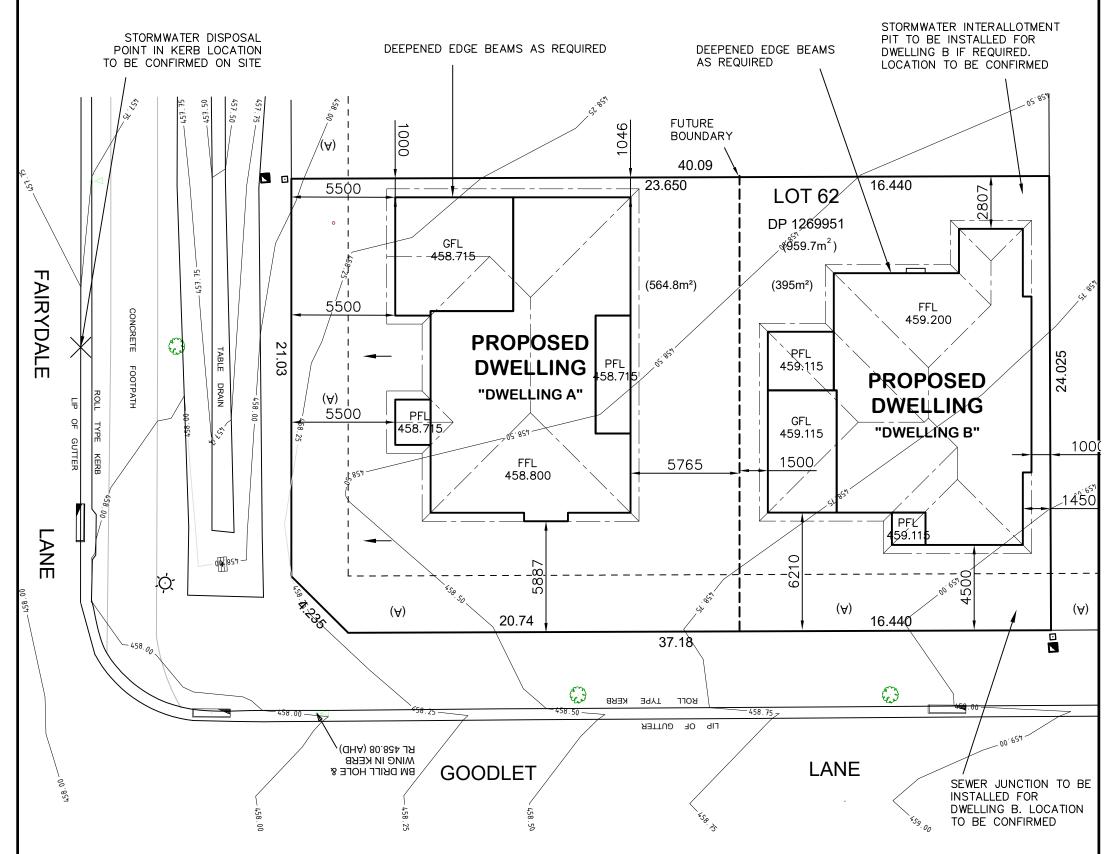
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DRAWING: ELEVATIONS - DWELLING B LOT 62 THE LOGAN, MUDGEE MAAS GROUP PROPERTIES



(A) - EASEMENT TO DRAIN SEWAGE 3m WIDE



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ALL WORK TO BE CARRIED OUT TO RELEVANT

STANDARDS AND BUILDING CODES.

* ALL SURFACE LEVELS AND FEATURE LOCATIONS ARE TO BE CONFIRMED PRIOR TO CONSTRUCTION

THE PROPOSED RESIDENCE SLAB IS TO BE CONSTRUCTED ON A LEVEL BUILDING PAD PREPARED IN ACCORDANCE WITH THE STRUCTURAL ENGINEER'S SPECIFICATIONS. THE MAIN FINISHED FLOOR LEVEL IS TO BE SET MINIMUM 300mm ABOVE THE CONSTRUCTION PAD LEVEL. FINISHED SURFACE LEVELS ARE TO GRADE AWAY FROM THE BUILDING PERIMETER TO PREVENT WATER PONDING NEAR EXTERNAL WALLS WITHOUT BEING DETRIMENTAL TO NEICHBOURING PROPERTIES.
THE BUILDER IS TO CONFIRM AVAILABLE FALLS TO SEWER CONNECTION POINTS & STORMWATER DISCHARGE POINTS PRIOR TO ESTABLISHING THE BUILDING FINISHED FLOOR LEVEL.

DENOTES DIRECTION OF SURFACE WATER ON COMPLETION OF LANDSCAPING.




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DRAWING: SITE PLAN **LOT 62 THE LOGAN, MUDGEE MAAS GROUP PROPERTIES**





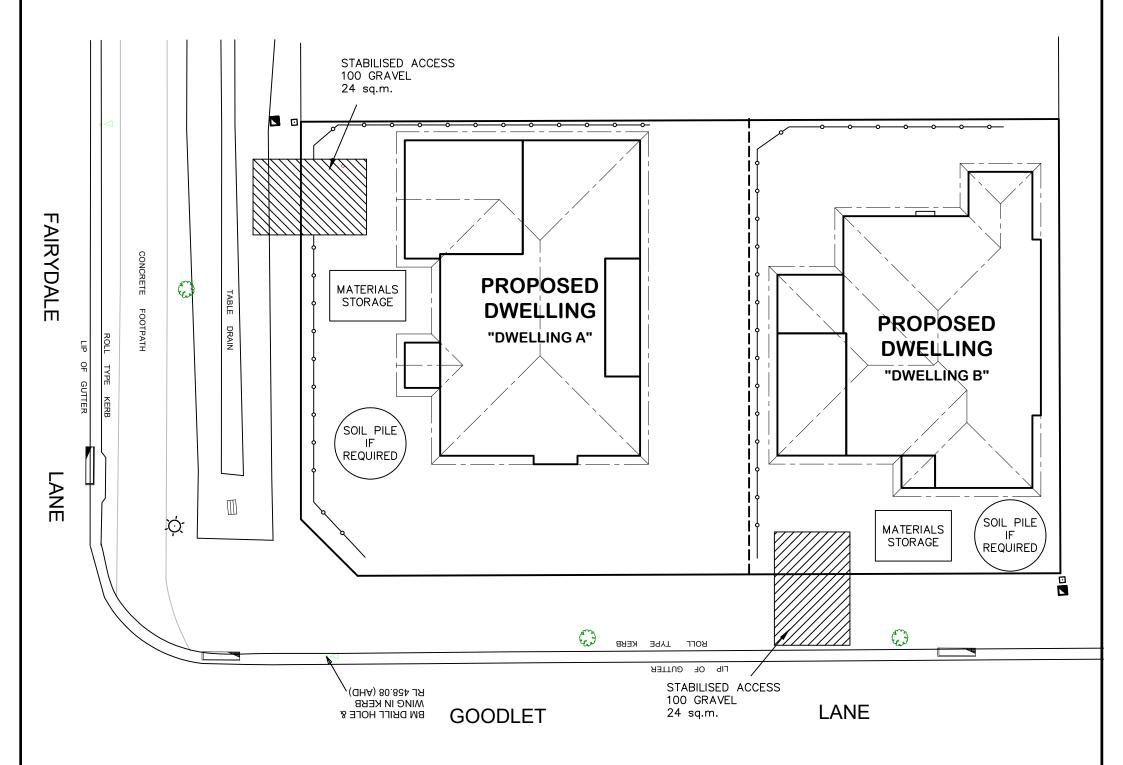

- * ALL DIMENSIONS ARE TO BE CONFIRMED BY THE BUILDER PRIOR TO CONSTRUCTION. DO NOT SCALE FROM DRAWINGS. BUILDING SET OUT & SITE BOUNDARY DETAILS TO BE CONFIRMED BY A REGISTERED SURVEYOR. ALL WORK TO BE CARRIED OUT TO RELEVANT STANDARDS AND BUILDING CODES.
- * ALL SURFACE LEVELS AND FEATURE LOCATIONS ARE TO BE CONFIRMED PRIOR TO CONSTRUCTION
- * THE PROPOSED RESIDENCE SLAB IS TO BE CONSTRUCTED ON A LEVEL BUILDING PAD PREPARED IN ACCORDANCE WITH THE STRUCTURAL ENGINEER'S SPECIFICATIONS.

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 FINISHED SURFACE LEVELS ARE TO GRADE AWAY FROM THE BUILDING PERIMETER TO PREVENT WATER PONDING NEAR EXTERNAL WALLS WITHOUT BEING DETRIMENTAL TO NEIGHBOURING PROPERTIES.

 THE BUILDER IS TO CONFIRM AVAILABLE FALLS TO SEWER CONNECTION POINTS & STORMWATER DISCHARGE POINTS PRIOR TO ESTABLISHING THE BUILDING FINISHED FLOOR LEVEL.

NOTES:

- ALL RUNOFF & SEDIMENT CONTROL STRUCTURES TO BE MAINTAINED IN A FUNCTIONAL CONDITION.
- 2. ALL VEGETATION OUTSIDE THE DWELLING SITE WILL BE RETAINED.

→ SEDIMENT FENCE



DATE:	SCALE:	DRAWN:
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DRAWING: EROSION & SEDIMENT CONTROL PLAN LOT 62 THE LOGAN, MUDGEE MAAS GROUP PROPERTIES



DWELLING A LANDSCAPING DETAILS

564.8 m² SITE AREA: GRAVEL TO SIDE: 3.3 m^2 64.2 m² GARDEN BEDS: (LOW WATER GARDEN) TURF: 200.8 m² DRIVEWAY AREA: 100.5 m² PATH AREA: 54.0 m²

CONCRETE PATH



GRAVEL EDGE BED

NOTE - QUANTITIES ARE PROVIDED AS A GUIDE ONLY AND NOT TO BE RELIED UPON FOR CONTRACTUAL PURPOSES

NOTES

- ALL GARDEN BEDS MULCHED WITH 50MM THICKNESS OF SELECTED BARK CHIPS.
- AREAS NOT DESIGNATED AS GARDEN OR HARDSTAND ARE TO BE TURFED AS NOTED

LANDSCAPING MAINTENANCE AND

ESTABLISHMENT

- WATER UNTIL ESTABLISHED. MULCH AND APPLY SLOW RELEASE FERTILISER IN SPRING. MAINTENANCE TO BE OWNERS RESPONSIBILITY AFTER PRACTICAL COMPLETION.

DWELLING B LANDSCAPING DETAILS

395 m² SITE AREA: GRAVEL TO SIDE: 3.8 m² 44.0 m² GARDEN BEDS: (LOW WATER GARDEN) TURF: 87.2 m² DRIVEWAY AREA: 39.0 m^2

55.6 m²




PATH AREA:

CONCRETE PATH



GRAVEL EDGE BED



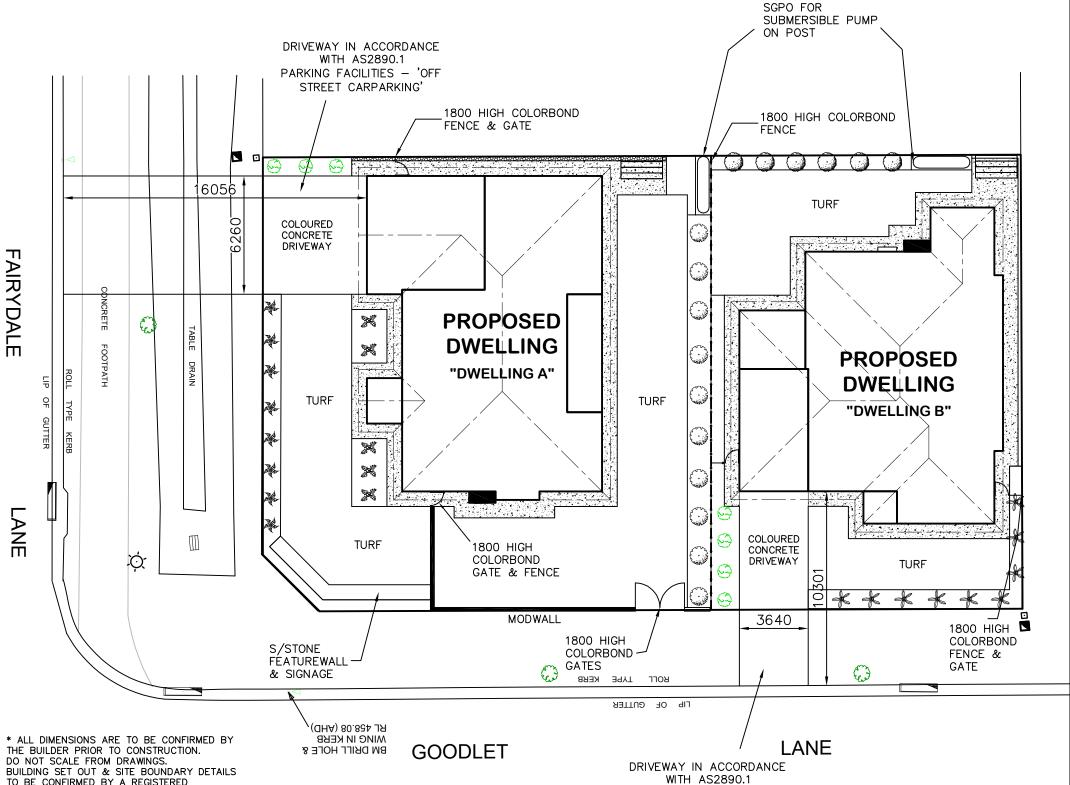

DE LAILS TO BE CONFIRMED BY A REGISTERED SURVEYOR. ALL WORK TO BE CARRIED OUT TO RELEVANT

STANDARDS AND BUILDING CODES.

ALL SURFACE LEVELS AND FEATURE LOCATIONS ARE TO BE CONFIRMED PRIOR TO CONSTRUCTION

THE PROPOSED RESIDENCE SLAB IS TO BE CONSTRUCTED ON A LEVEL BUILDING PAD PREPARED IN ACCORDANCE WITH THE STRUCTURAL ENGINEER'S SPECIFICATIONS. THE MAIN FINISHED FLOOR LEVEL IS TO BE SET MINIMUM 300mm ABOVE THE CONSTRUCTION PAD LEVEL. FINISHED SURFACE LEVELS ARE TO GRADE AWAY FROM THE BUILDING PERIMETER TO PREVENT WATER PONDING NEAR EXTERNAL WALLS WITHOUT BEING DETRIMENTAL TO NEIGHBOURING PROPERTIES. THE BUILDER IS TO CONFIRM AVAILABLE FALLS TO SEWER

CONNECTION POINTS & STORMWATER DISCHARGE POINTS
PRIOR TO ESTABLISHING THE BUILDING FINISHED FLOOR LEVEL.

LEGEND:

A/C LOCATION TO BE CONFIRMED ON SITE

PARKING FACILITIES - 'OFF

STREET CARPARKING'

3000L POLY RAINWATER TANK CLOTHESLINE

Plant Schedule table ht spread Westringia zena 2m 2m6 Oriental pearl 1m 0.4 mPhotinia robusta 3m 2m * Nandina obsession 0.6m 0.6m34 Lomandra tanika 0.6m0.6mViburnum tinus 1.5m 1m



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DRAWING: BASIX COMMITMENTS PLAN LOT 62 THE LOGAN, MUDGEE MAAS GROUP PROPERTIES



BASIX COMMITMENTS - DWELLING A WATER COMMITMENTS LANDSCAPE
AREA LOW WATER USE SPECIES OF VEGETATION 64.2 SQ.M. MIN RATING 4 STAR 4 STAR 5 STAR 5 STAR FIXTURES
SHOWER HEAD RATING SHOWER HEAD RATING
TOILET FILUSHING SYSTEM RATING
KITCHEN TAPS
BASIN TAPS
BASIN TAPS
ALTERNATIVE WATER
RAINWATER TANK
RAINWATER TANK
ROF COLLECTION AREA FOR R/W 3000 LITRE 100 SQ.M. R/W TANK CONNECTED TO

MIN 1 No. OUTDOOR TAP ALL TOILETS IN DWELLING THE COLD WATER TAP THAT SUPPLIES THE CLOTHES WASHER

THERMAL COMFORT COMMITMENTS
GENERAL REQUIREMENTS -CLASS 1 DWELLING WITH NOT MORE THAN 2 STOREYS
CONDITIONED FLOOR AREA NOT EXCEEDING 300 SQUARE METRES
MUST NOT HAVE OPEN MEZZANINE OF MORE THAN 25 SQUARE METRES
NOT CONTAIN THIRD LEVEL HABITABLE ATTIC ROOM

GROUND FLOOR CONSTRUCTION CONCRETE SLAB ON GROUND BRICK VENEER — R2.60 INC CONSTRUCTION
OTHER/UNDECIDED — R2.60 INC CONSTRUCTION EXTERNAL WALL EXTERNAL WALL

INTERNAL WALL SHARED WITH GARAGE CEILING AND ROOF NIL FLAT CEILING/PITCHED ROOF — CEILING R4, ROOF — SARKING — UNVENTILATED — DARK (SOLAR ABSORPTANCE > 0.7)

THERMAL COMFORT COMMITMENTS - WINDOWS & GLAZED DOORS

WINDOW	ORIENTATION	MAXIMUM HEIGHT (mm)	MAXIMUM WIDTH (mm)	TYPE	SHADING	OVERSHADOWING
W01	N	1800	600	ALUMINIUM, SINGLE, CLEAR	EAVE 600mm, 180mm ABOVE HEAD OF WINDOW OR GLAZED DOOR	NOT OVERSHADOWED
W02	N	1800	600	ALUMINIUM, SINGLE, CLEAR	EAVE 600mm, 180mm ABOVE HEAD OF WINDOW OR GLAZED DOOR	NOT OVERSHADOWED
W03	N	1800	600	ALUMINIUM, SINGLE, CLEAR	EAVE 600mm, 180mm ABOVE HEAD OF WINDOW OR GLAZED DOOR	NOT OVERSHADOWED
W04	N	1800	600	ALUMINIUM, SINGLE, CLEAR	EAVE 600mm, 180mm ABOVE HEAD OF WINDOW OR GLAZED DOOR	NOT OVERSHADOWED
W05	N	1800	600	ALUMINIUM, SINGLE, CLEAR	EAVE 600mm, 180mm ABOVE HEAD OF WINDOW OR GLAZED DOOR	NOT OVERSHADOWED
W06	E	900	600	ALUMINIUM, SINGLE, CLEAR	EAVE 600mm, 180mm ABOVE HEAD OF WINDOW OR GLAZED DOOR	NOT OVERSHADOWED
W07	s	1800	1800	ALUMINIUM, SINGLE, CLEAR	EAVE 600mm, 180mm ABOVE HEAD OF WINDOW OR GLAZED DOOR	NOT OVERSHADOWED
W08	s	2100	2700	ALUMINIUM, SINGLE, CLEAR	EAVE 2450mm, 240mm ABOVE HEAD OF WINDOW OR GLAZED DOOR	NOT OVERSHADOWED
W09	s	1800	900	ALUMINIUM, SINGLE, CLEAR	EAVE 2450mm, 180mm ABOVE HEAD OF WINDOW OR GLAZED DOOR	NOT OVERSHADOWED
W10	s	1800	1500	ALUMINIUM, SINGLE, CLEAR	EAVE 600mm, 180mm ABOVE HEAD OF WINDOW OR GLAZED DOOR	NOT OVERSHADOWED
W11	w	900	1200	ALUMINIUM, SINGLE, CLEAR	EAVE 600mm, 180mm ABOVE HEAD OF WINDOW OR GLAZED DOOR	NOT OVERSHADOWED
W12	W	900	600	ALUMINIUM, SINGLE, CLEAR	EAVE 600mm, 180mm ABOVE HEAD OF WINDOW OR GLAZED DOOR	NOT OVERSHADOWED
HOT WATER	ENERGY COMMITMENTS HOT WATER SYSTEM COOLING SYSTEM HEATING SYSTEM HEATING SYSTEM VENTILATION GAS INSTANTANEOUS – 5 STAR REVERSE CYCLE: EER 3.5-4.0 WITH DAY/NIGHT ZONING BETWEEN LIVING/BED AREAS REVERSE CYCLE: EER 3.5-4.0 WITH DAY/NIGHT ZONING BETWEEN LIVING/BED AREAS					

BATHROOM KITCHEN LAUNDRY Extract fan ducted to roof or facade — manual on/off extract fan ducted to roof or facade — manual on/off natural ventilation only ARTIFICIAL LIGHTING KITCHEN BATHROOMS/TOILETS PRIMARY TYPE OF ARTIFICIAL LIGHTING IS FLUORESCENT OR LIGHT EMITTING DIODE (LED)
PRIMARY TYPE OF ARTIFICIAL LIGHTING IS FLUORESCENT OR LIGHT EMITTING DIODE (LED)
PRIMARY TYPE OF ARTIFICIAL LIGHTING IS FLUORESCENT OR LIGHT EMITTING DIODE (LED)
PRIMARY TYPE OF ARTIFICIAL LIGHTING IS FLUORESCENT OR LIGHT EMITTING DIODE (LED)
PRIMARY TYPE OF ARTIFICIAL LIGHTING IS FLUORESCENT OR LIGHT EMITTING DIODE (LED) X 2 LAUNDRY HALLWAYS LIVING AREAS BEDROOMS PRIMARY TYPE OF ARTIFICIAL LIGHTING IS FLUORESCENT OR LIGHT EMITTING DIODE (LED) X 3 NATURAL LIGHTING WINDOW x 1 WINDOW x 3 BATHROOMS/TOILETS APPLIANCES KITCHEN

These are the specifications upon which the Basix assessment is based. These specifications take precedence over the drawings or other specific

WELL VENTILATED AS BASIX DEFINITION OUTDOOR CLOTHES DRYING LINE

BASIX COMMITMENTS - DWELLING B

WATER COMMITMENTS LANDSCAPE
AREA LOW WATER USE SPECIES OF VEGETATION
FIXTURES
SHOWER HEAD RATING SHOWER HEAD KAIING
TOILET FLUSHING SYSTEM RATING
KITCHEN TAPS
BASIN TAPS
ALTERNATIVE WATER
RAINWATER TANK
RAINWATER TANK CAPACITY
ROOF COLLECTION AREA FOR R/W

44 SQ.M. MIN RATING 4 STAR 4 STAR

3000 LITRE 100 SQ.M.

MIN 1 No. OUTDOOR TAP ALL TOILETS IN DWELLING THE COLD WATER TAP THAT SUPPLIES THE CLOTHES WASHER

THERMAL COMFORT COMMITMENTS
GENERAL REQUIREMENTS —

R/W TANK CONNECTED TO

CLASS 1 DWELLING WITH NOT MORE THAN 2 STOREYS
CONDITIONED FLOOR AREA NOT EXCEEDING 300 SQUARE METRES
MUST NOT HAVE OPEN MEZZANINE OF MORE THAN 25 SQUARE METRES
NOT CONTAIN THIRD LEVEL HABITABLE ATTIC ROOM

CONCRETE SLAB ON GROUND GROUND FLOOR CONSTRUCTION EXTERNAL WALL SHARED WITH GARAGE CEILING AND ROOF BRICK VENEER - R2.60 INC CONSTRUCTION

NIL FLAT CEILING/PITCHED ROOF — CEILING R4, ROOF — SARKING — UNVENTILATED — DARK (SOLAR ABSORPTANCE > 0.7)

					•	
THERMAL C	OMFORT COMMITME	NTS – WINDOWS &	: GLAZED DOORS			
WINDOW	ORIENTATION	MAXIMUM HEIGHT (mm)	MAXIMUM WIDTH (mm)	TYPE	SHADING	OVERSHADOWING
W01	N	2100	2100	ALUMINIUM, SINGLE, CLEAR	EAVE 4090mm, 240mm ABOVE HEAD OF WINDOW OR GLAZED DOOR	NOT OVERSHADOWED
W02	E	1500	1500	ALUMINIUM, SINGLE, CLEAR	EAVE 600mm, 180mm ABOVE HEAD OF WINDOW OR GLAZED DOOR	NOT OVERSHADOWED
W03	E	900	600	ALUMINIUM, SINGLE, CLEAR	EAVE 600mm, 240mm ABOVE HEAD OF WINDOW OR GLAZED DOOR	NOT OVERSHADOWED
W04	E	1500	1500	ALUMINIUM, SINGLE, CLEAR	EAVE 600mm, 180mm ABOVE HEAD OF WINDOW OR GLAZED DOOR	NOT OVERSHADOWED
W05	S	900	900	ALUMINIUM, SINGLE, CLEAR	EAVE 150mm, 180mm ABOVE HEAD OF WINDOW OR GLAZED DOOR	NOT OVERSHADOWED
W06	S	900	600	ALUMINIUM, SINGLE, CLEAR	EAVE 150mm, 180mm ABOVE HEAD OF WINDOW OR GLAZED DOOR	NOT OVERSHADOWED
W07	S	1500	1500	ALUMINIUM, SINGLE, CLEAR	EAVE 150mm, 180mm ABOVE HEAD OF WINDOW OR GLAZED DOOR	NOT OVERSHADOWED
W08	s	900	900	ALUMINIUM, SINGLE, CLEAR	EAVE 150mm, 180mm ABOVE HEAD OF WINDOW OR GLAZED DOOR	NOT OVERSHADOWED
W09	w	1800	600	ALUMINIUM, SINGLE, CLEAR	EAVE 600mm, 180mm ABOVE HEAD OF WINDOW OR GLAZED DOOR	NOT OVERSHADOWED
W10	W	1800	1200	ALUMINIUM, SINGLE, CLEAR	EAVE 600mm, 180mm ABOVE HEAD OF WINDOW OR GLAZED DOOR	NOT OVERSHADOWED
W 11	W	1800	600	ALUMINIUM, SINGLE, CLEAR	EAVE 600mm, 180mm ABOVE HEAD OF WINDOW OR GLAZED DOOR	NOT OVERSHADOWED
W12	W	1800	800	ALUMINIUM, SINGLE, CLEAR	EAVE 600mm, 180mm ABOVE HEAD OF WINDOW OR GLAZED DOOR	NOT OVERSHADOWED
W13	W	1800	800	ALUMINIUM, SINGLE, CLEAR	EAVE 600mm, 180mm ABOVE HEAD OF WINDOW OR GLAZED DOOR	NOT OVERSHADOWED
	System <u>On</u>	REVERSE C' REVERSE C' EXTRACT FA EXTRACT FA	/CLE: EER 3.0— N DUCTED TO I	3.5 WITH DAY/NIGHT ZONING BETWEEN 3.5 WITH DAY/NIGHT ZONING BETWEEN ROOF OR FACADE — MANUAL ON/OFF ROOF OR FACADE — MANUAL ON/OFF		
KITCHEN	EAS	PRIMARY TY PRIMARY TY PRIMARY TY PRIMARY TY	PE OF ARTIFICIA PE OF ARTIFICIA PE OF ARTIFICIA PE OF ARTIFICIA	IL LIGHTING IS FLUORESCENT OR LIGHT IL LIGHTING IS FLUORESCENT OR LIGHT	i emitting diode (LED) i emitting diode (LED) i emitting diode (LED) i emitting diode (LED) x 3	
<u>natural</u> Kitchen Bathroon	<u>Lighting</u> Is/toilets	WINDOW x 3	3			
APPLIANCE	<u></u>					

These are the specifications upon which the Basix assessment is based. These specifications take precedence over the drawings or other specifications.

WELL VENTILATED AS BASIX DEFINITION OUTDOOR CLOTHES DRYING LINE

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REFRIGERATOR SPACE


CLOTHES DRYING

STANDARDS AND BUILDING CODES.

* ALL SURFACE LEVELS AND FEATURE LOCATIONS ARE TO BE CONFIRMED PRIOR TO CONSTRUCTION

THE PROPOSED RESIDENCE SLAB IS TO BE CONSTRUCTED ON A LEVEL BUILDING PAD PREPARED IN ACCORDANCE WITH THE STRUCTURAL ENGINEER'S SPECIFICATIONS. THE MAIN FINISHED FLOOR LEVEL IS TO BE SET MINIMUM 300mm ABOVE THE CONSTRUCTION PAD LEVEL. FINISHED SURFACE LEVELS ARE TO GRADE AWAY FROM THE BUILDING PERIMETER TO PREVENT WATER PONDING NEAR EXTERNAL WALLS WITHOUT BEING DETRIMENTAL TO NEICHBOURING PROPERTIES.
THE BUILDER IS TO CONFIRM AVAILABLE FALLS TO SEWER

CONNECTION POINTS & STORMWATER DISCHARGE POINTS
PRIOR TO ESTABLISHING THE BUILDING FINISHED FLOOR LEVEL.

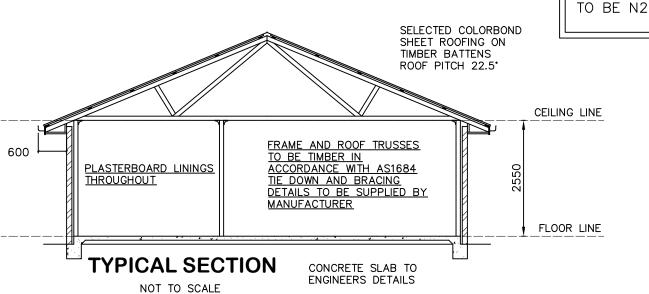

REFRIGERATOR SPACE CLOTHES DRYING

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	PRO	PER	TIES

DATE: 24.11.21	SCALE: N / A	DRAWN: WP
SHEET.	JOB No:	ISSUE:

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DRAWING: BASIX COMMITMENTS & TYP SECTION LOT 62 THE LOGAN, MUDGEE MAAS GROUP PROPERTIES



Ph: (02) 6885 3594 / Mob: 0408 296 502

* NOTF - WIND CLASSIFICATION