

# PROPOSED WORKSHOP

## LOT 1 INDUSTRIAL AVENUE, MUDGEE

### HOT ENGINEERING



#### DRAWING REGISTER

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**FOR APPROVAL**

				<b>DO NOT SCALE</b>		 <p><b>COOK &amp; ROE</b> STRUCTURAL ENGINEERS P 02 6360 2561 F 02 6360 2907 E OFFICE@COOKANDROE.COM.AU PO BOX 1935, ORANGE NSW 2800 <a href="http://COOKANDROE.COM.AU">COOKANDROE.COM.AU</a></p>		Project		Client													
								<b>PROPOSED WORKSHOP</b> <b>LOT 1 INDUSTRIAL AVENUE, MUDGEE</b>		<b>HOT ENGINEERING</b>													
						Title		Drawn		Designed		Approved											
						<b>COVER &amp; DRAWING REGISTER</b>		JTB				-											
								Scale		Date		<small>This Drawing must not be used for Construction unless signed as Approved</small>											
								-		MAY '2021'													
								Job No:		Drawing No:		Rev:											
								37880		S.00		A											
												Original Size											
												A1											
<table border="1"> <thead> <tr> <th>No</th> <th>Revision Description</th> <th>Drawn</th> <th>Approved</th> <th>Date</th> </tr> </thead> <tbody> <tr> <td>A</td> <td>ISSUED FOR APPROVAL</td> <td>JTB</td> <td>-</td> <td>17.05.21</td> </tr> </tbody> </table>				No	Revision Description	Drawn	Approved	Date	A	ISSUED FOR APPROVAL	JTB	-	17.05.21										
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A	ISSUED FOR APPROVAL	JTB	-	17.05.21																			




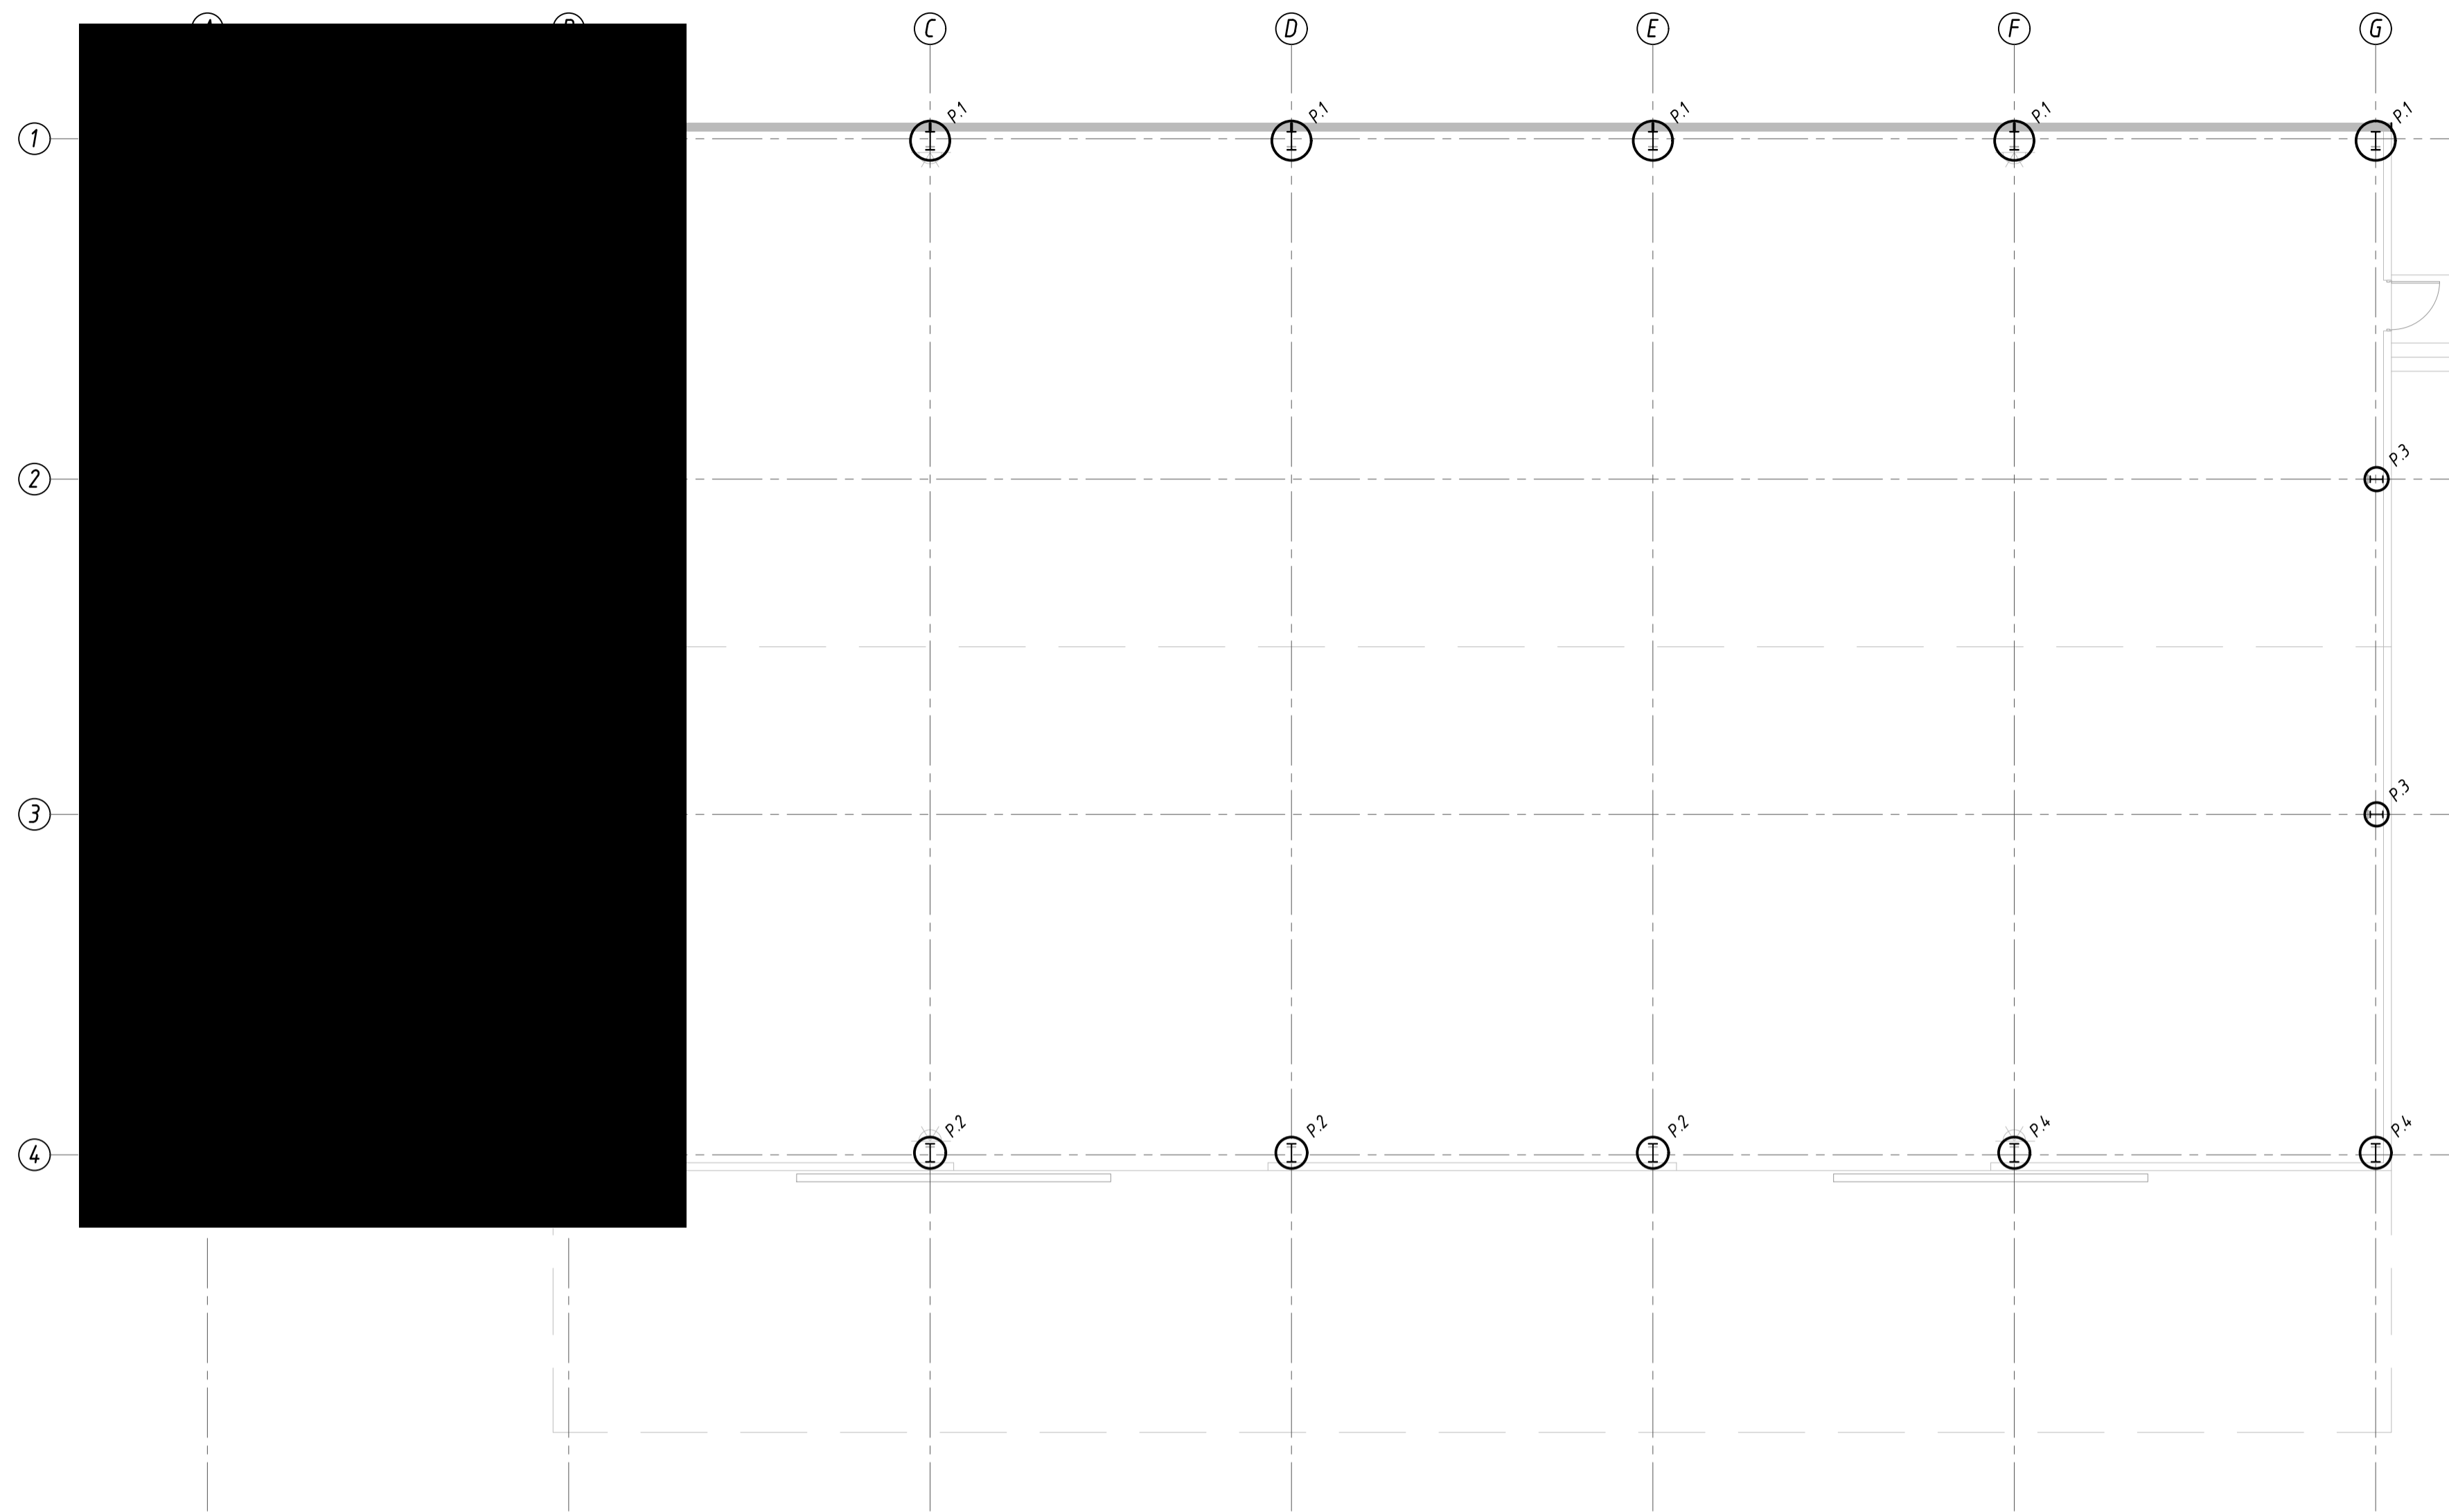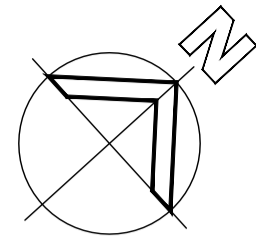

**CONCRETE FOOTING PLAN**

SCALE 1:100

FOOTING SCHEDULE		
MARK	SIZE (mm)	REINFORCEMENT
P.1	Ø750x2500mm DEEP PIER	-
P.2	Ø600x2500mm DEEP PIER	6-N20 BARS + R10-300 TIES
P.3	Ø450x2500mm DEEP PIER	-
P.4	Ø600x2500mm DEEP PIER	-

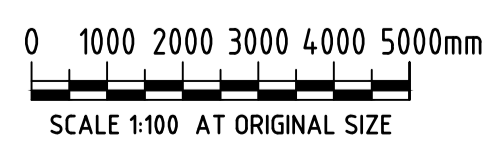

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Project

**PROPOSED WORKSHOP  
 LOT 1 INDUSTRIAL AVENUE, MUDGEE**

Title

**CONCRETE FOOTING PLAN**

Client

**HOT ENGINEERING**

Drawn

JTB

Designed

*[Signature]*

Approved

Scale

AS SHOWN

Date

MAY '2021'

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Job No:

**37880**

Drawing No:


**S.02**

Rev: **A**

**A1**

No	Revision Description	Drawn	Approved	Date
A	ISSUED FOR APPROVAL	JTB	-	17.05.21

**FOR APPROVAL**

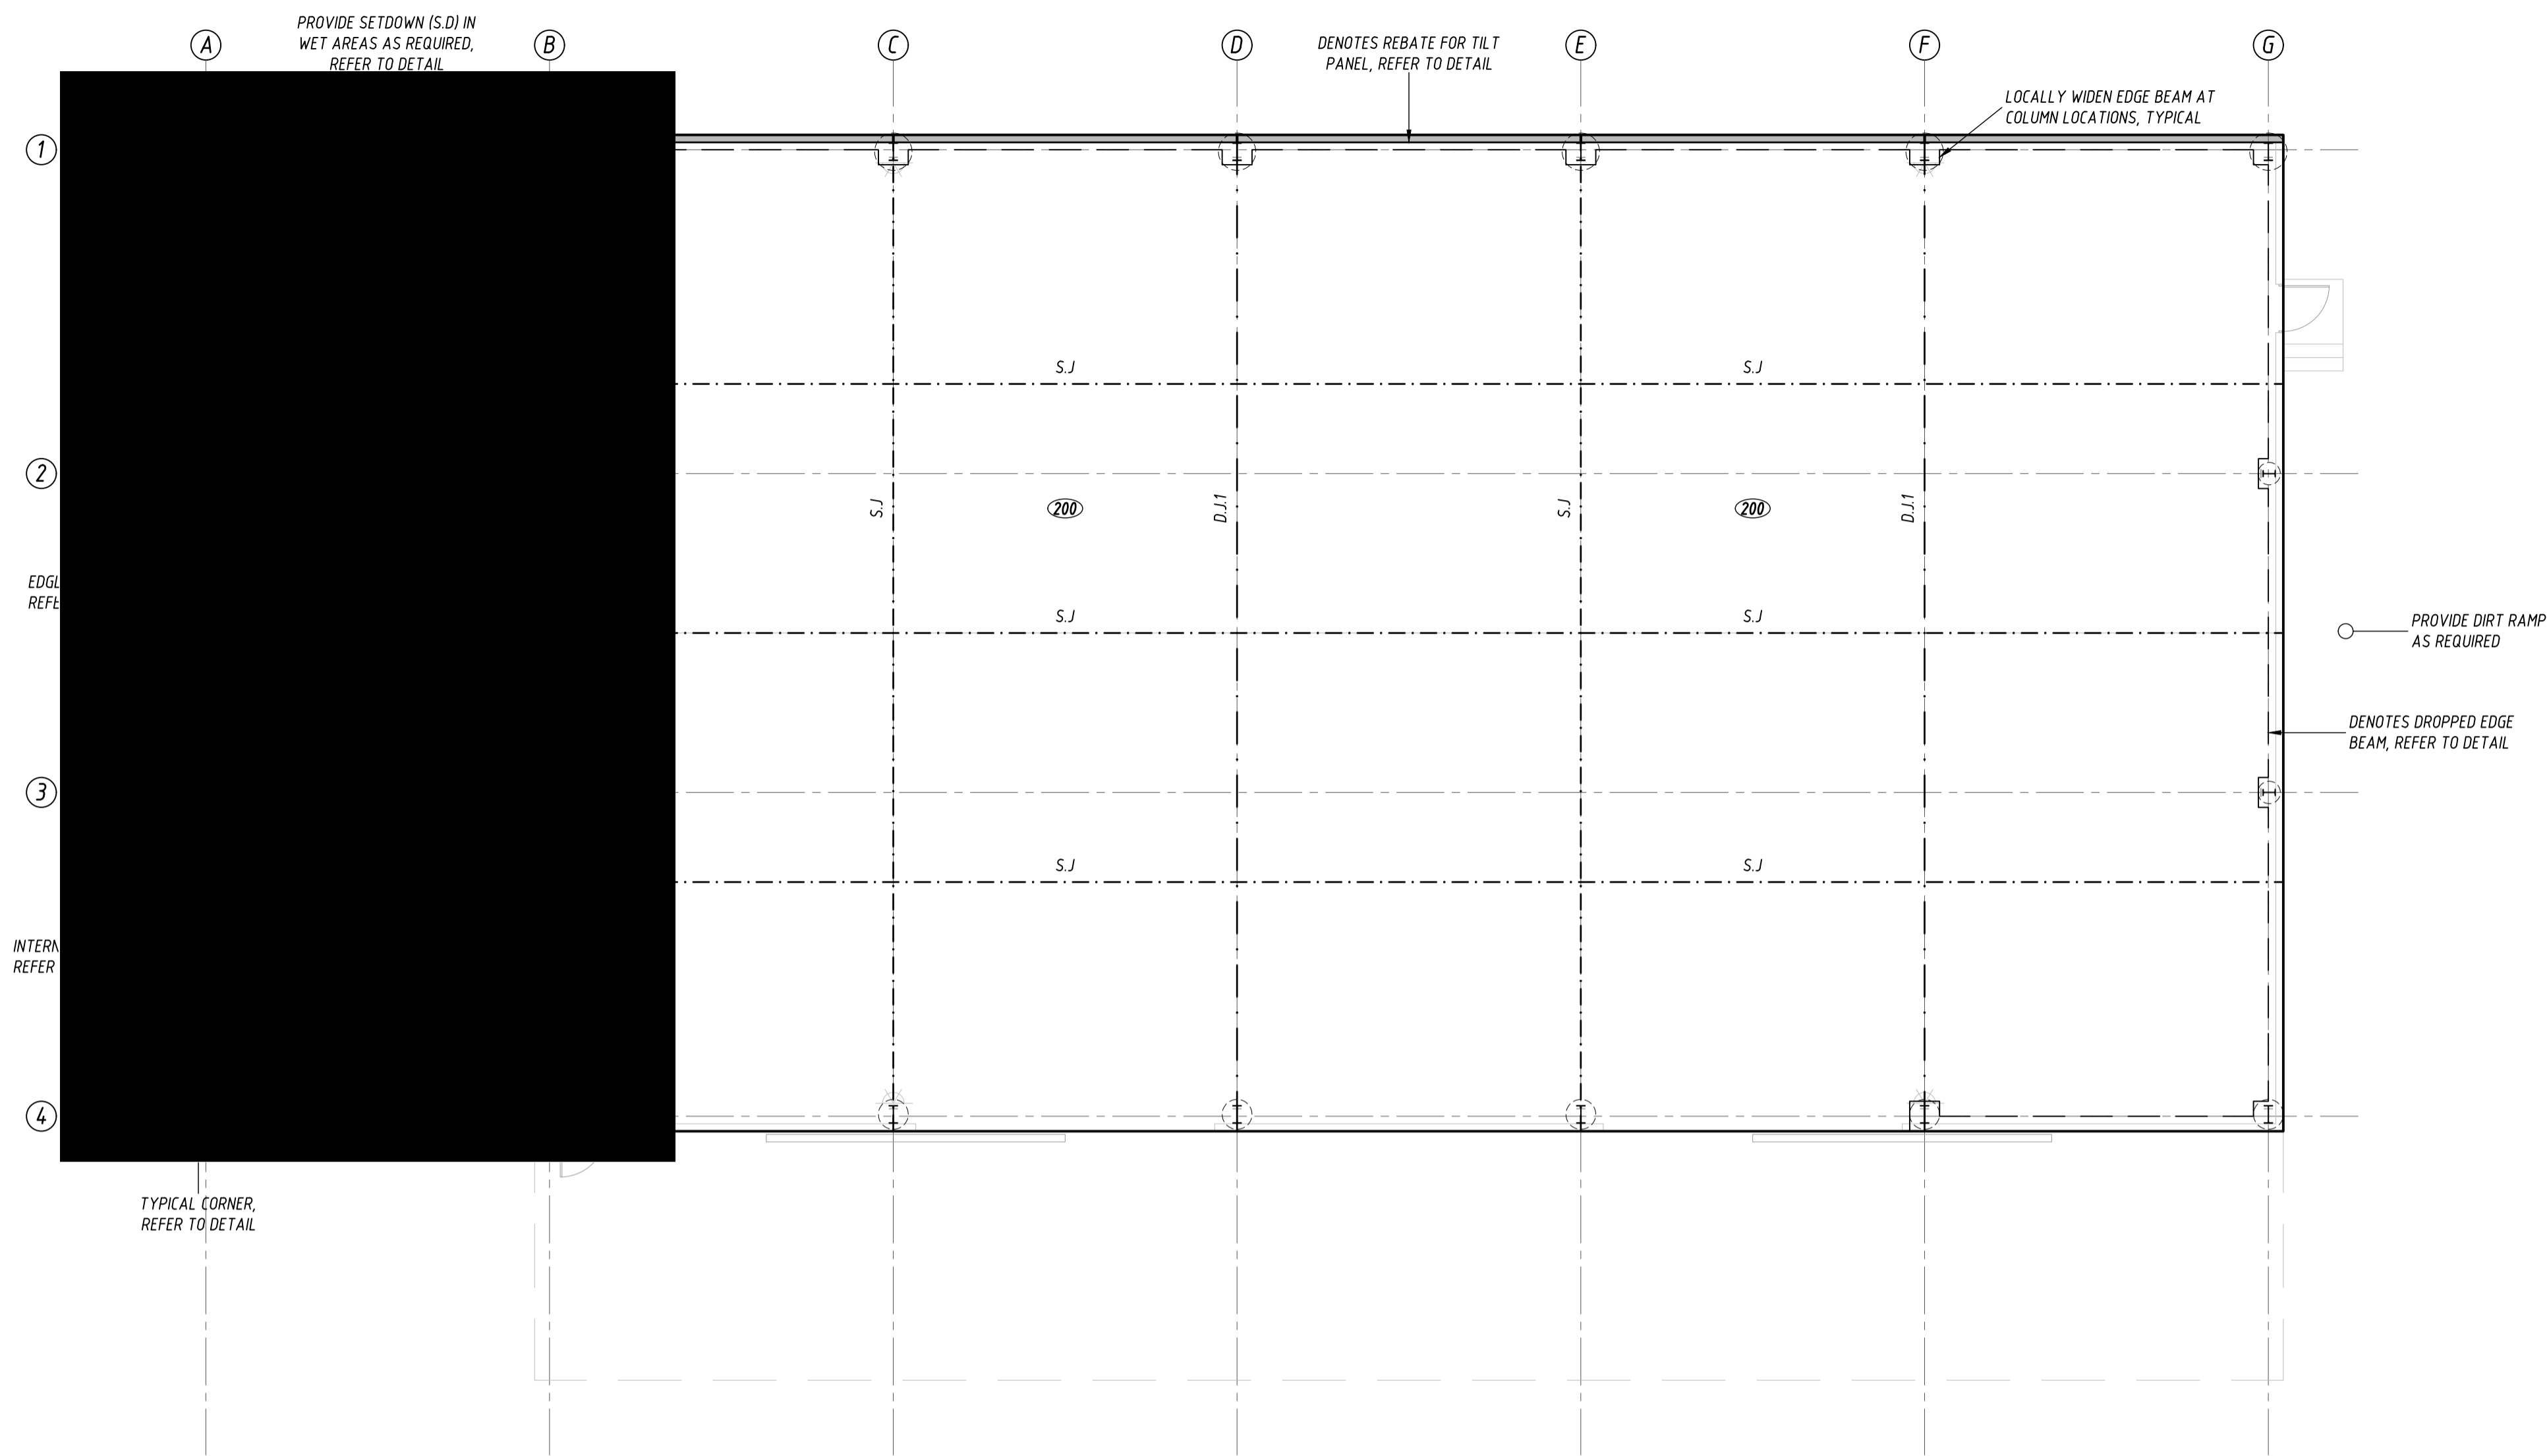

**CONCRETE SLAB PLAN**

SCALE 1:100

**WORKSHOP SLAB**

WORKSHOP SLAB TO BE 200mm MINIMUM THICK, REINFORCED WITH SL92 MESH IN TOP THROUGHOUT (U.N.O.).

WORKSHOP SLAB TO BE PLACED ON 100mm MINIMUM DEPTH OF COMPACTED GRANULAR MATERIAL.

ALL MESH SHALL BE LAPPED BY ONE FULL PANEL, I.E. THE TWO OUTER MOST WIRES OF ONE SHEET OVERLAP THE TWO OUTER MOST WIRES OF THE ADJACENT SHEET.

**OFFICE SLAB**

OFFICE SLAB TO BE 100mm MINIMUM THICK, REINFORCED WITH SL82 MESH IN TOP THROUGHOUT (U.N.O.).

OFFICE SLAB TO BE PLACED ON 50mm NOMINAL COMPACTED SAND LEVELING BED.

**SLAB JOINTS**

S.J. ——— INDICATES SAWN JOINT - REFER TO DETAIL

D.J.1/2 ——— INDICATES DOWELED JOINT - REFER TO DETAILS

XXX DENOTES SLAB THICKNESS OF CONCRETE

**NOTE:** SUBGRADE MUST BE PROOF ROLLED AND PREPARED IN ACCORDANCE WITH NOTE CF.1 ON DRAWING NO.S.01.

No	Revision Description	Drawn	Approved	Date
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Project  
**PROPOSED WORKSHOP  
LOT 1 INDUSTRIAL AVENUE, MUDGEES**

Title  
**CONCRETE SLAB PLAN**

Client  
**HOT ENGINEERING**

Drawn  
JTB

Designed  
*[Signature]*

Approved  
-

Scale  
AS SHOWN

Date  
MAY '2021'


Job No:  
**37880**

Drawing No:  
**S.03**

Rev: **A A1**

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**FOR APPROVAL**

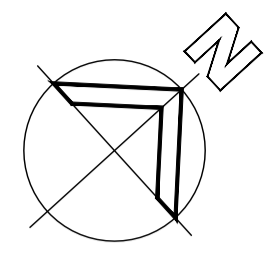

# EXTERNAL PAVEMENT PLAN

SCALE 1:125


## EXTERNAL PAVEMENT

EXTERNAL PAVEMENT TO BE 170mm MINIMUM THICK, REINFORCED WITH S192 MESH IN TOP THROUGHOUT (U.N.O.).  
 EXTERNAL PAVEMENT TO BE PLACED ON 100mm MINIMUM DEPTH OF COMPACTED GRANULAR MATERIAL.  
 ISOLATE SLABS FROM BUILDING AS PER DETAIL Z ON DRAWING NO.S.11.  
 ALL MESH SHALL BE LAPPED BY ONE FULL PANEL, I.E. THE TWO OUTER MOST WIRES OF ONE SHEET OVERLAP THE TWO OUTER MOST WIRES OF THE ADJACENT SHEET.

## SLAB JOINTS


S.J ——— INDICATES SAWN JOINT - REFER TO DETAIL  
 D.E.J ——— INDICATES DOWELED EXPANSION JOINT - REFER TO DETAIL  
 XXX DENOTES SLAB THICKNESS OF CONCRETE

**NOTE:** SUBGRADE MUST BE PROOF ROLLED AND PREPARED IN ACCORDANCE WITH NOTE CF.1 ON DRAWING NO.S.01.

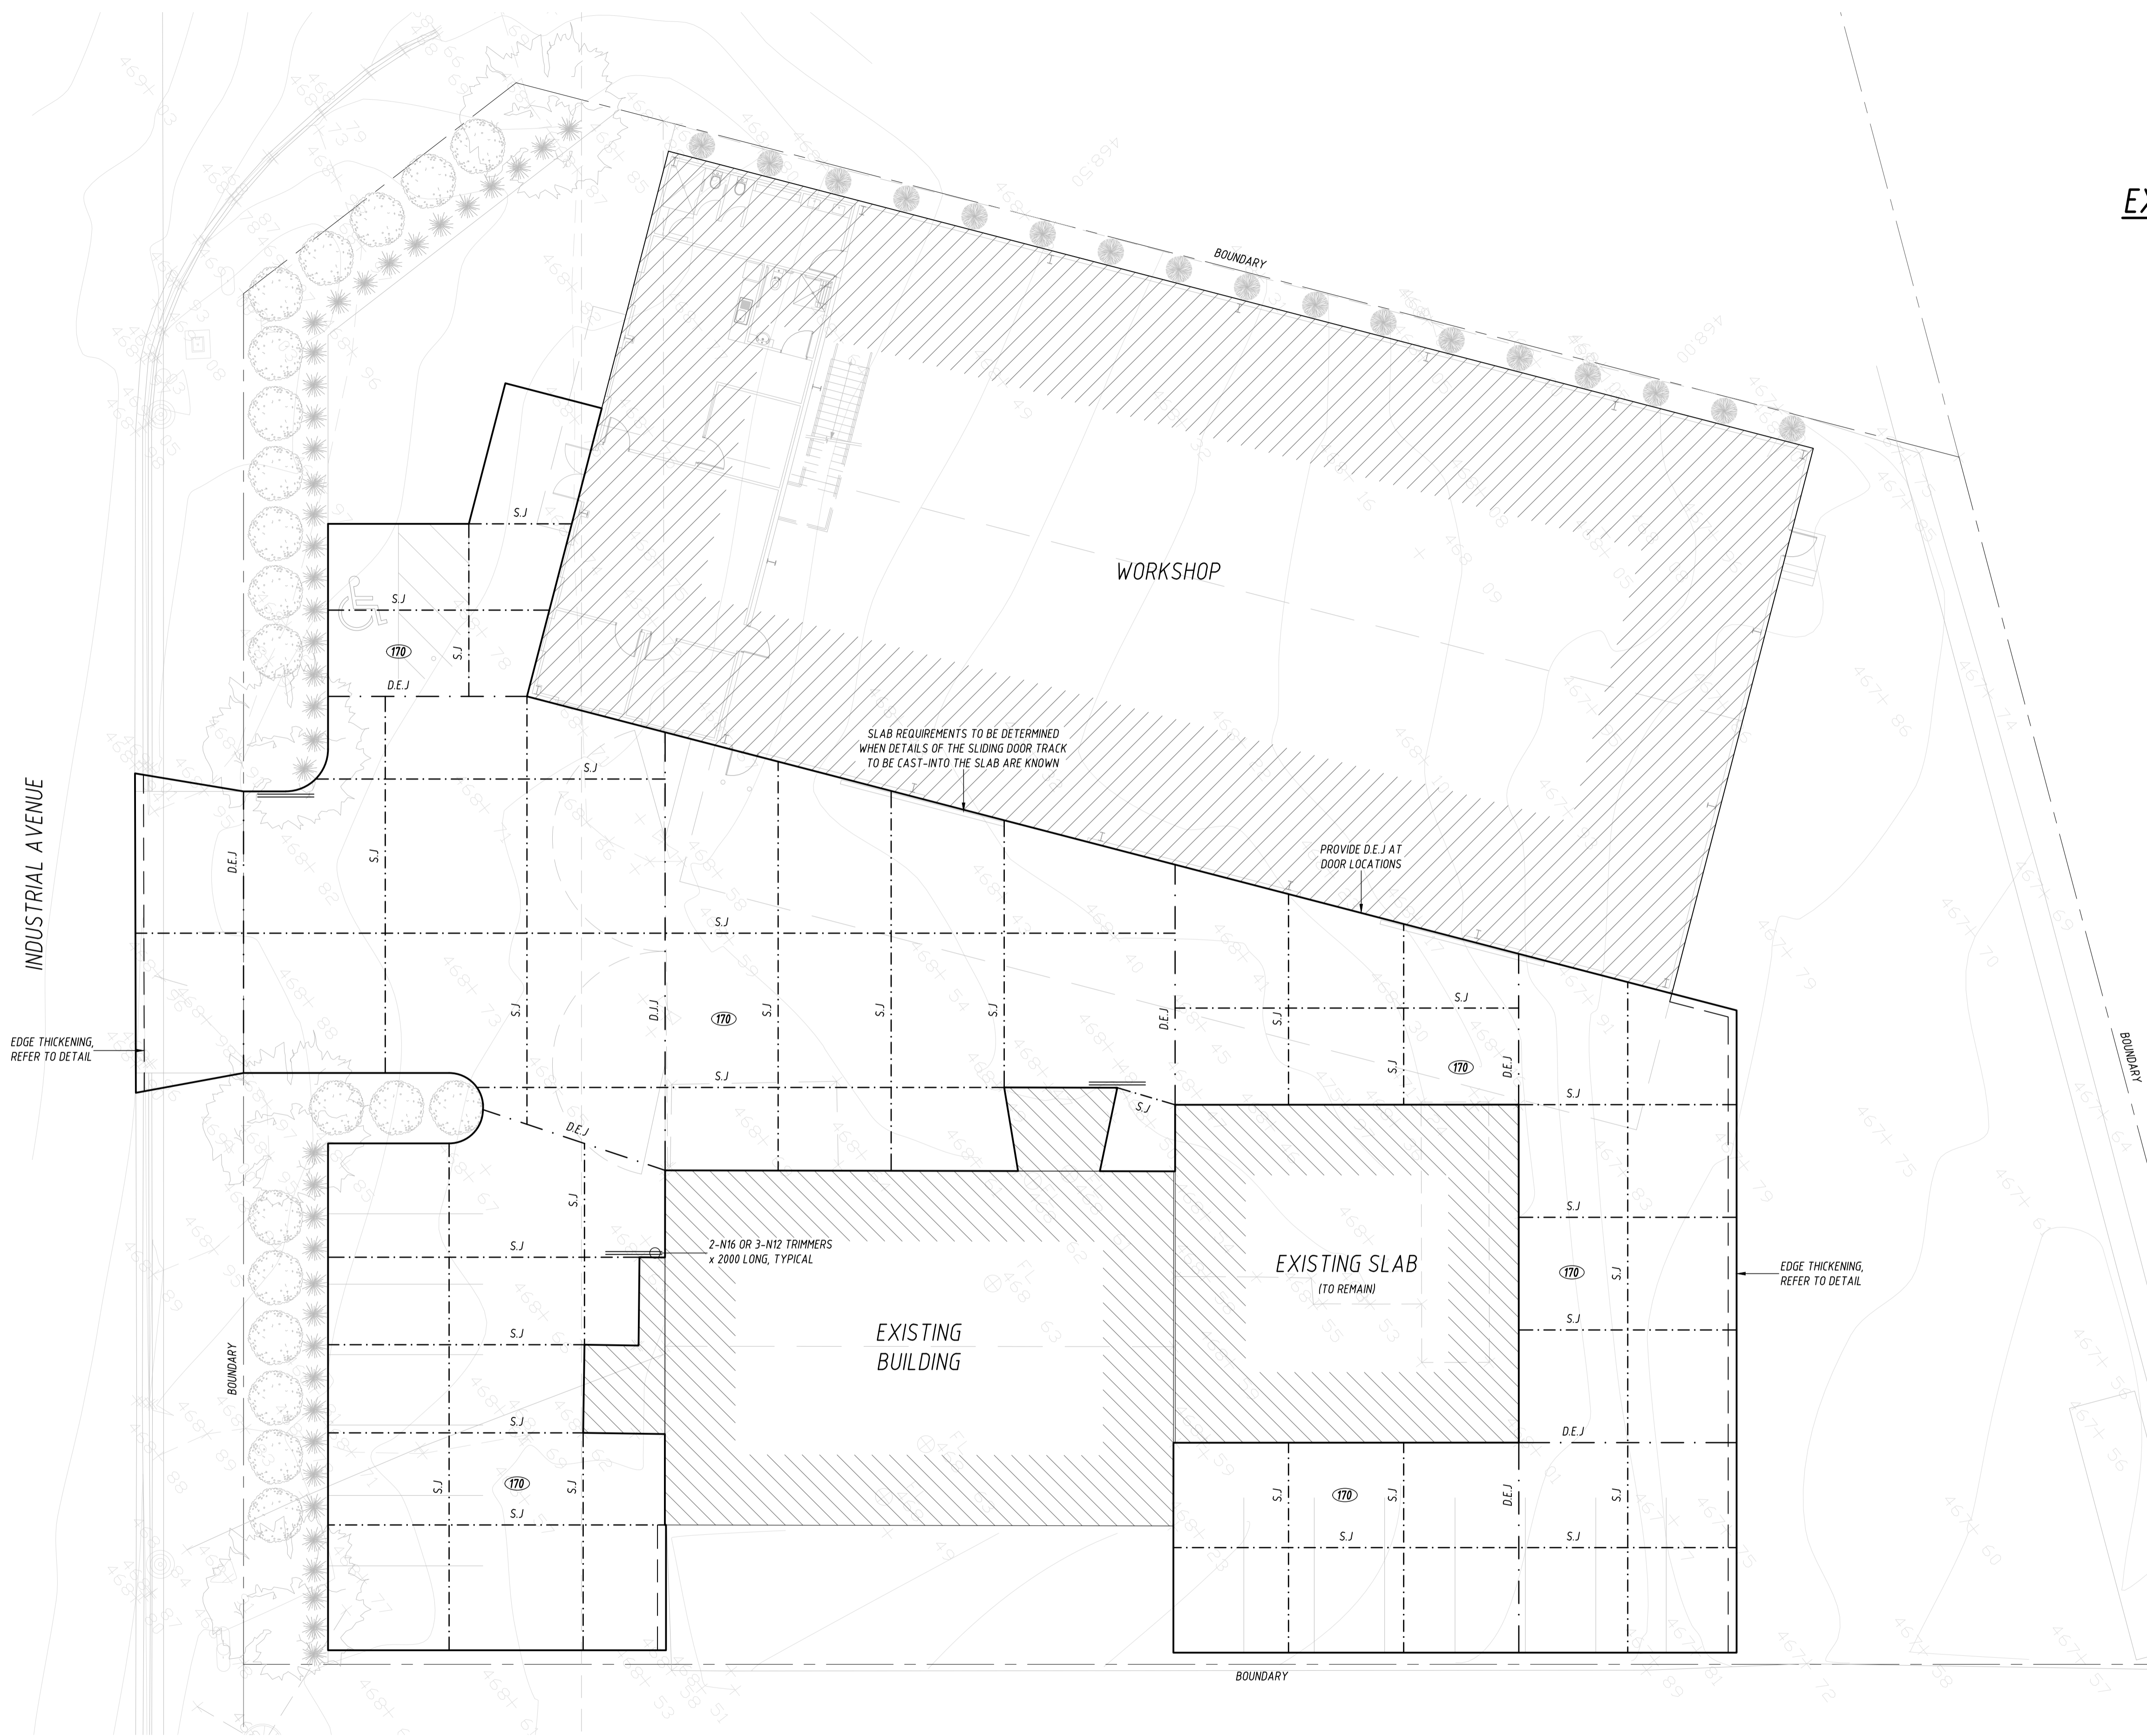

**FOR APPROVAL**

No	Revision Description	Drawn	Approved	Date
A	ISSUED FOR APPROVAL	JTB	-	17.05.21

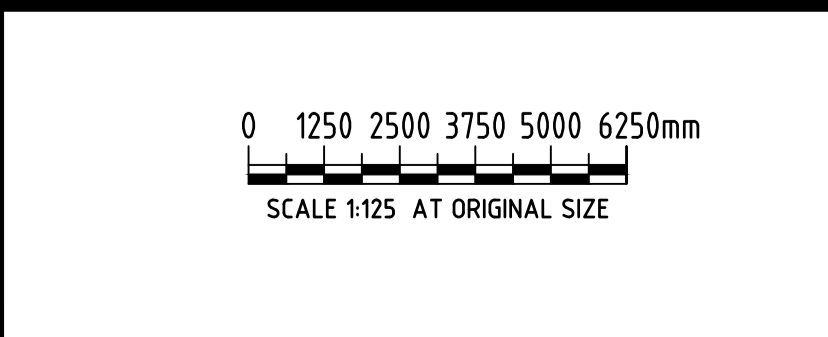



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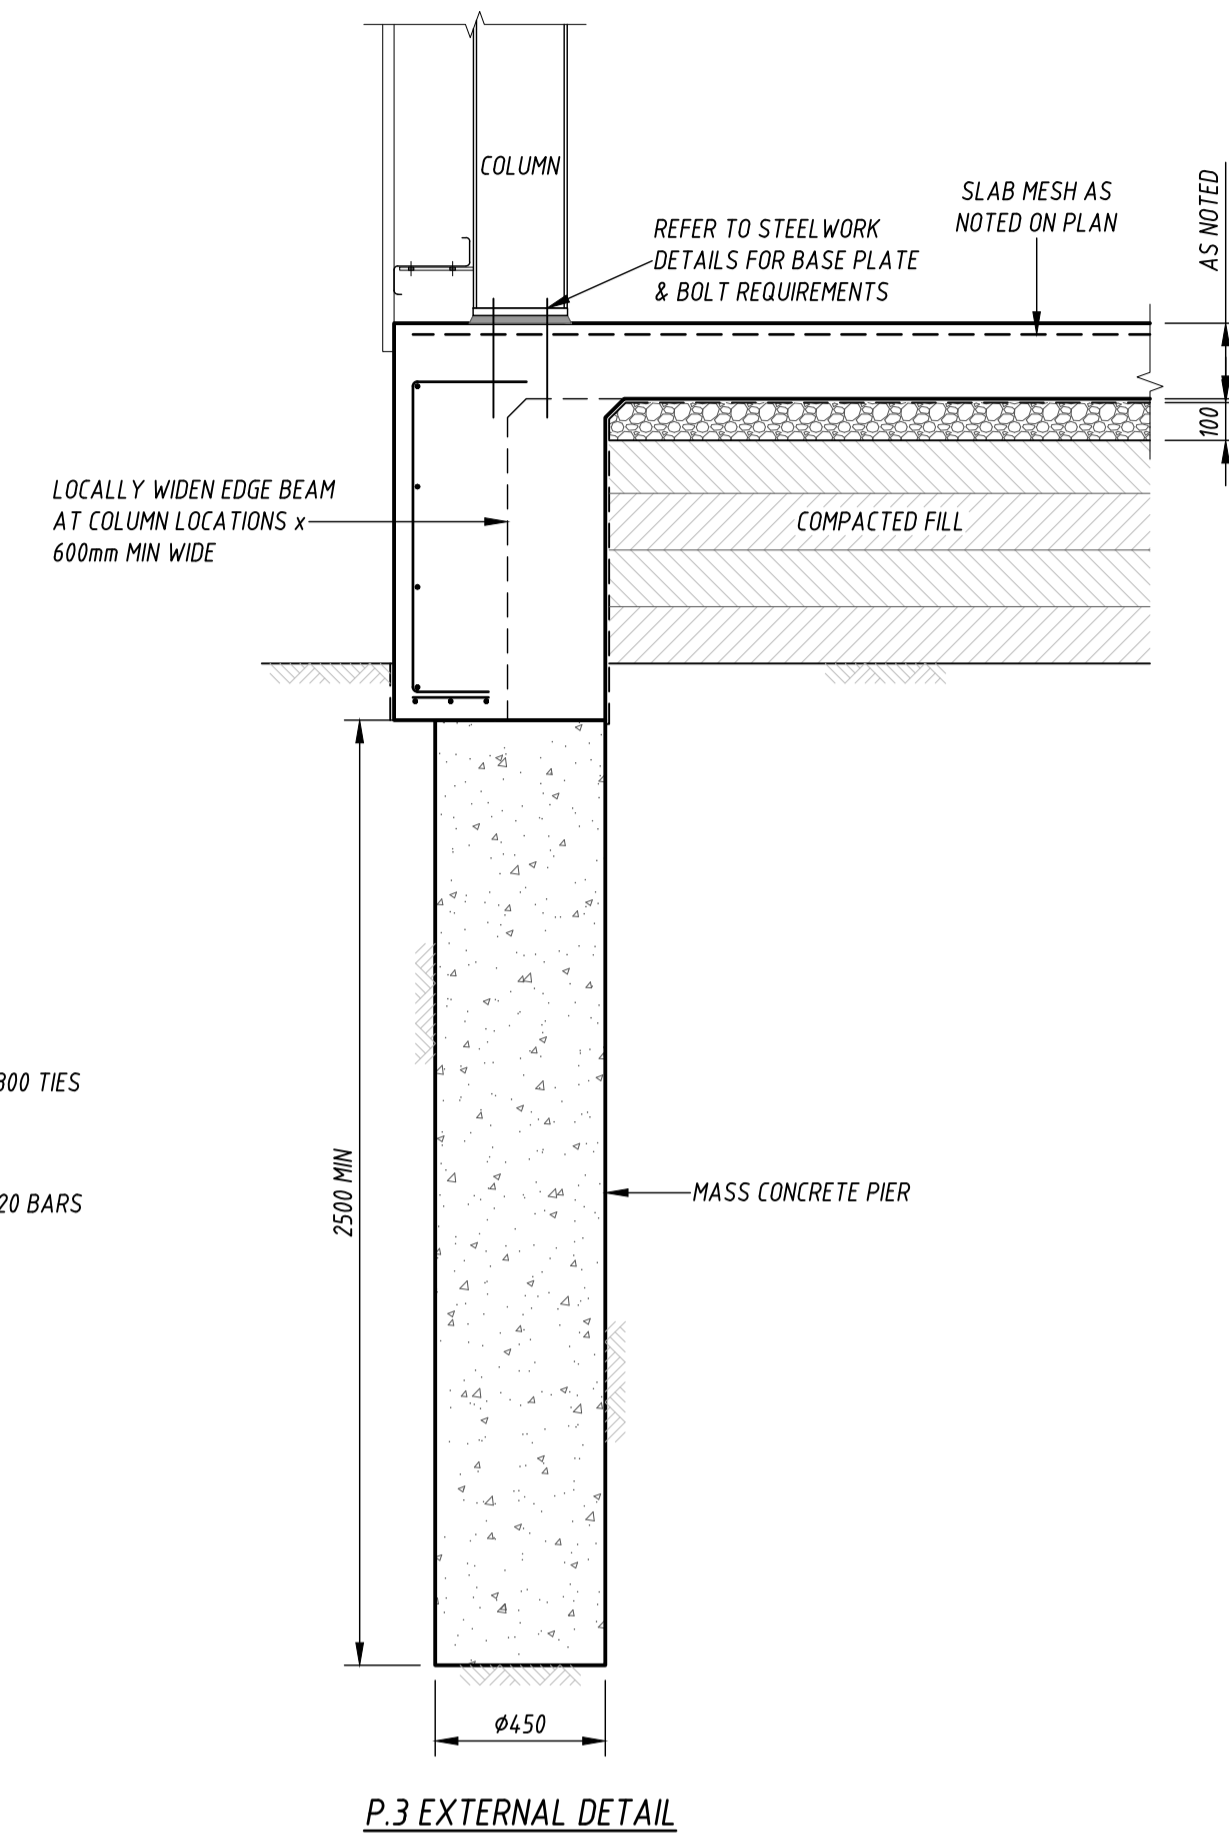
Project **PROPOSED WORKSHOP**  
**LOT 1 INDUSTRIAL AVENUE, MUDGEE**  
 Title **EXTERNAL PAVEMENT PLAN**

Client **HOT ENGINEERING**


Drawn	JTB	Designed	[Signature]	Approved	-
Scale	AS SHOWN	Date	MAY '2021'	This Drawing must not be used for Construction unless signed as Approved	
Job No:	<b>37880</b>	Drawing No:	<b>S.04</b>	Rev:	<b>A</b>
				Original Size	<b>A1</b>



SECTION A  
SCALE 1:20

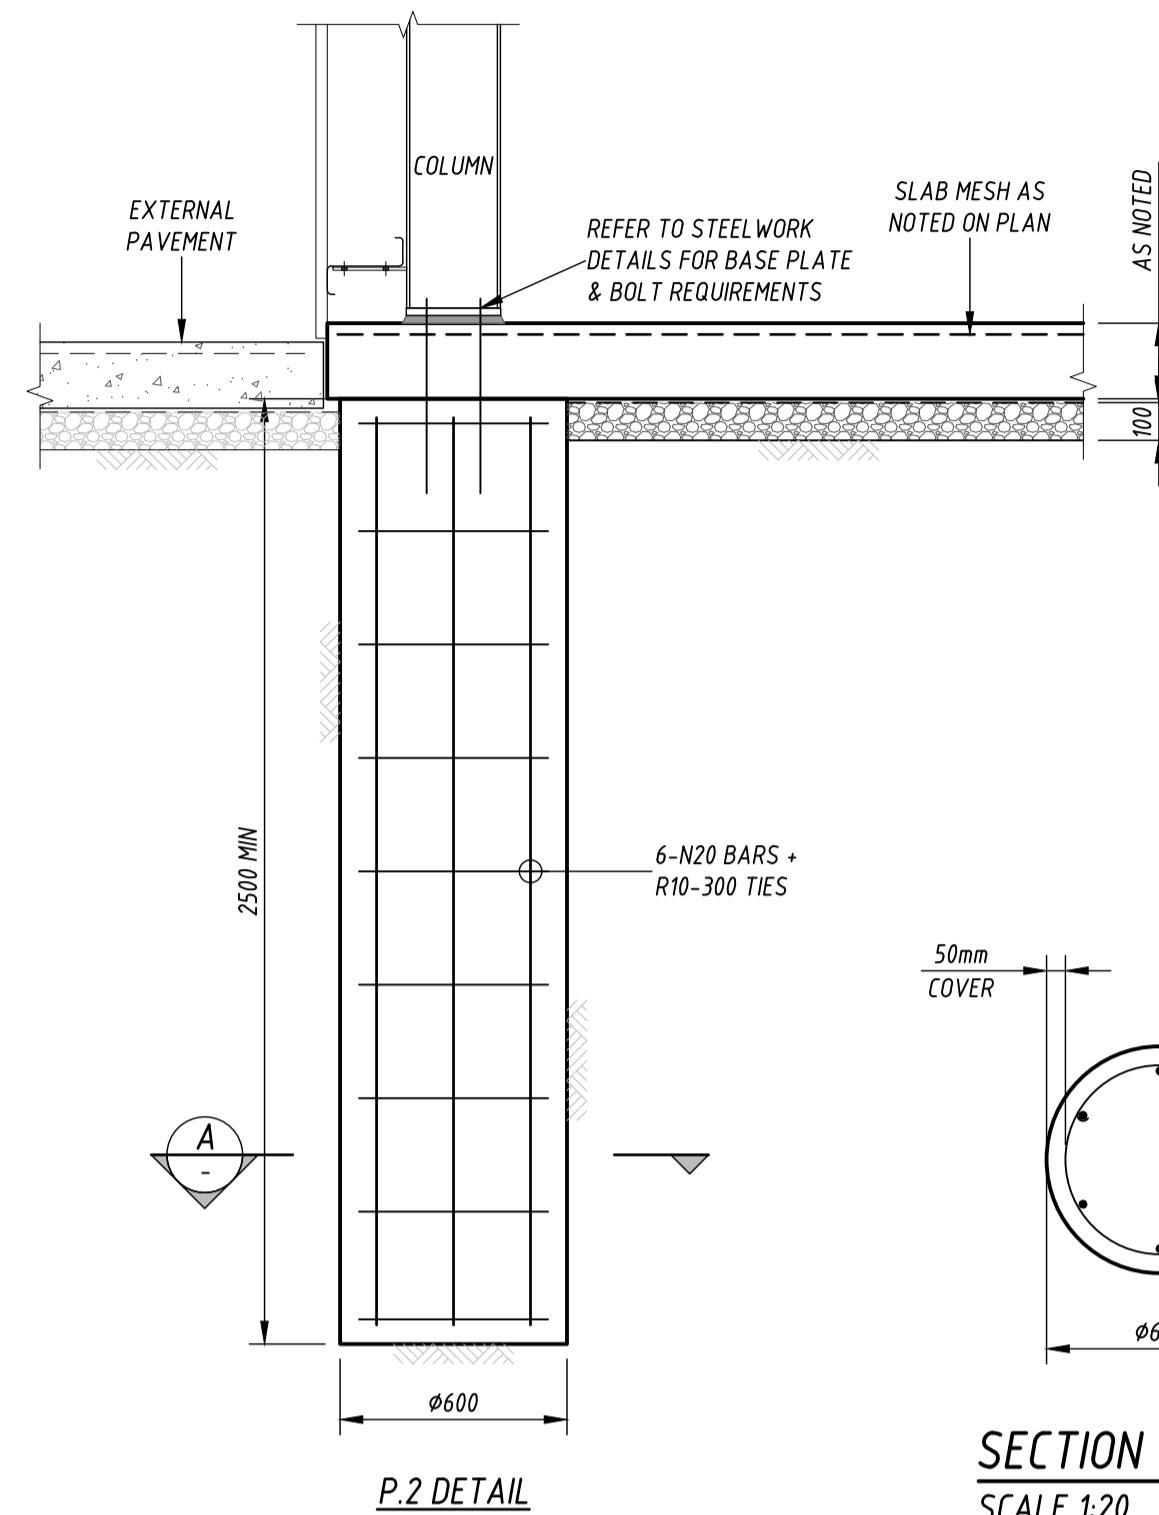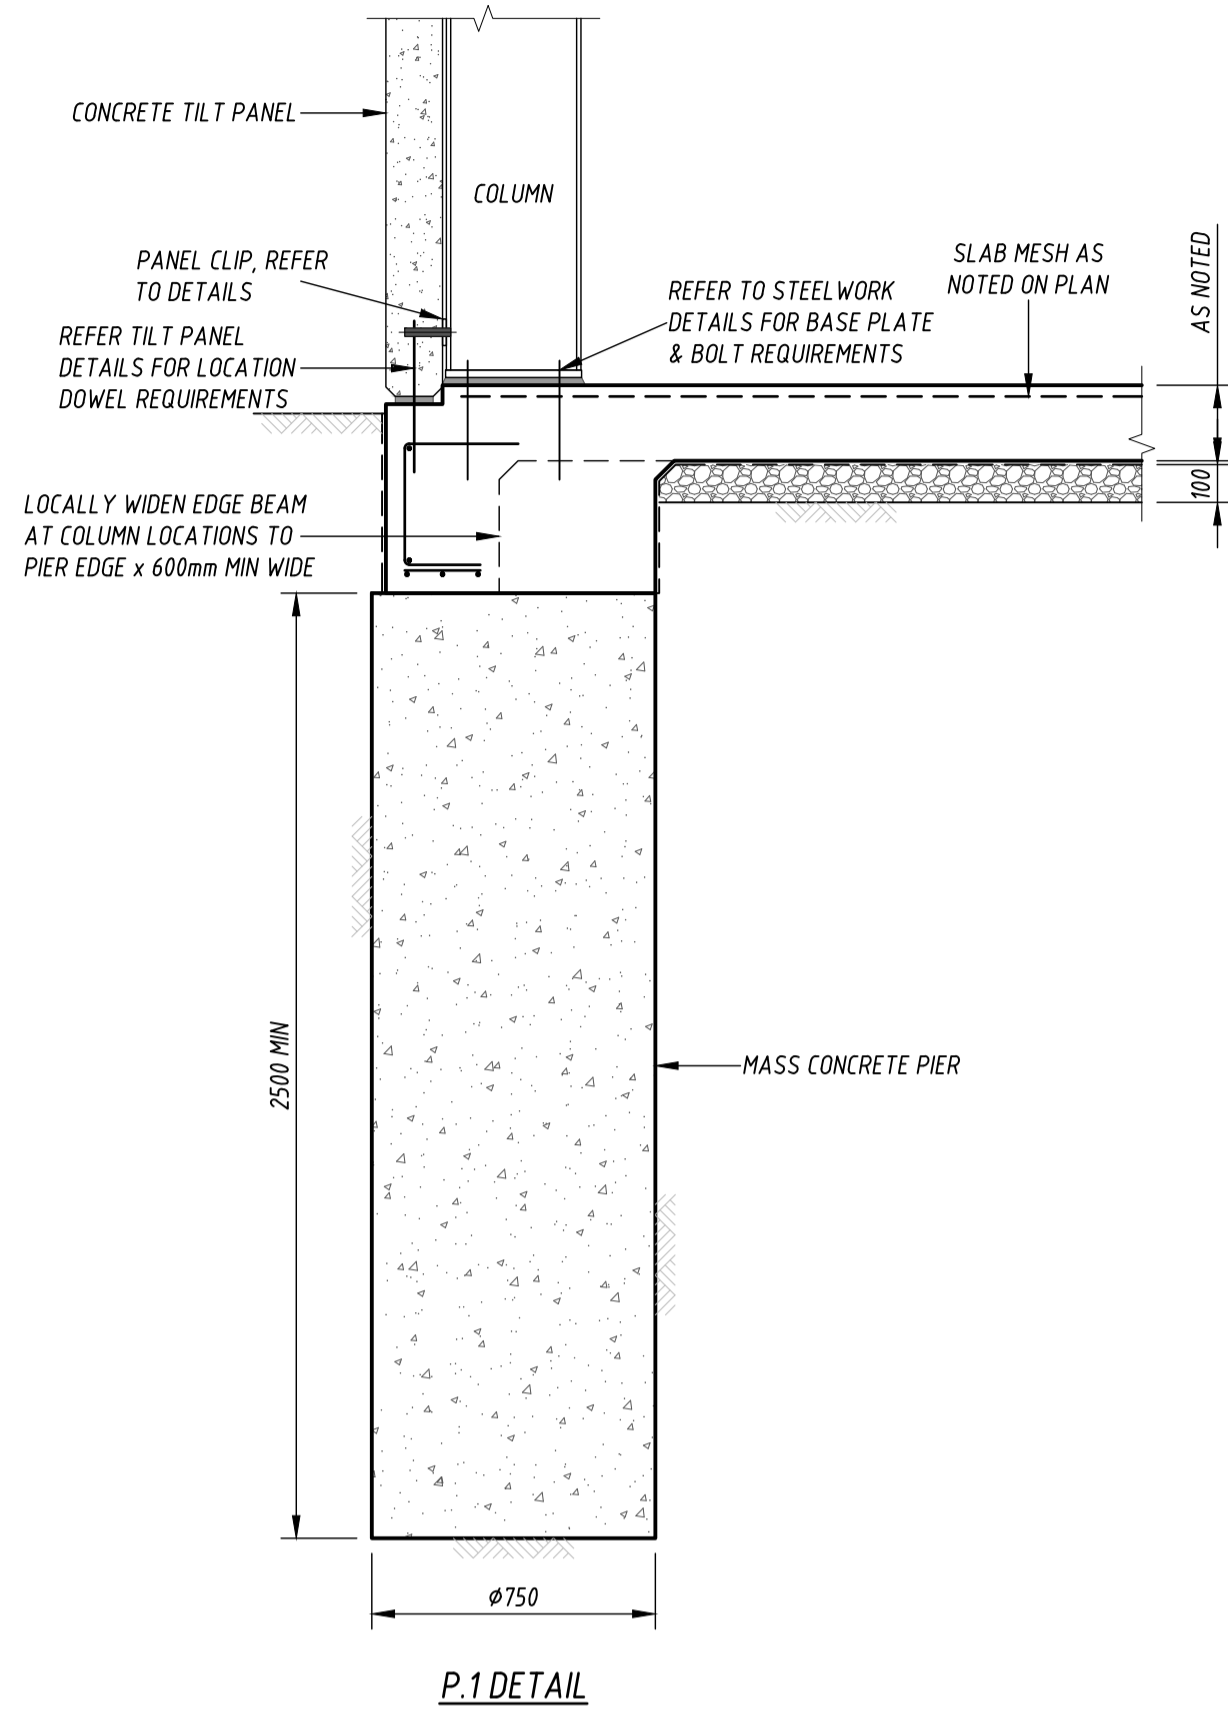


P.3 EXTERNAL DETAIL

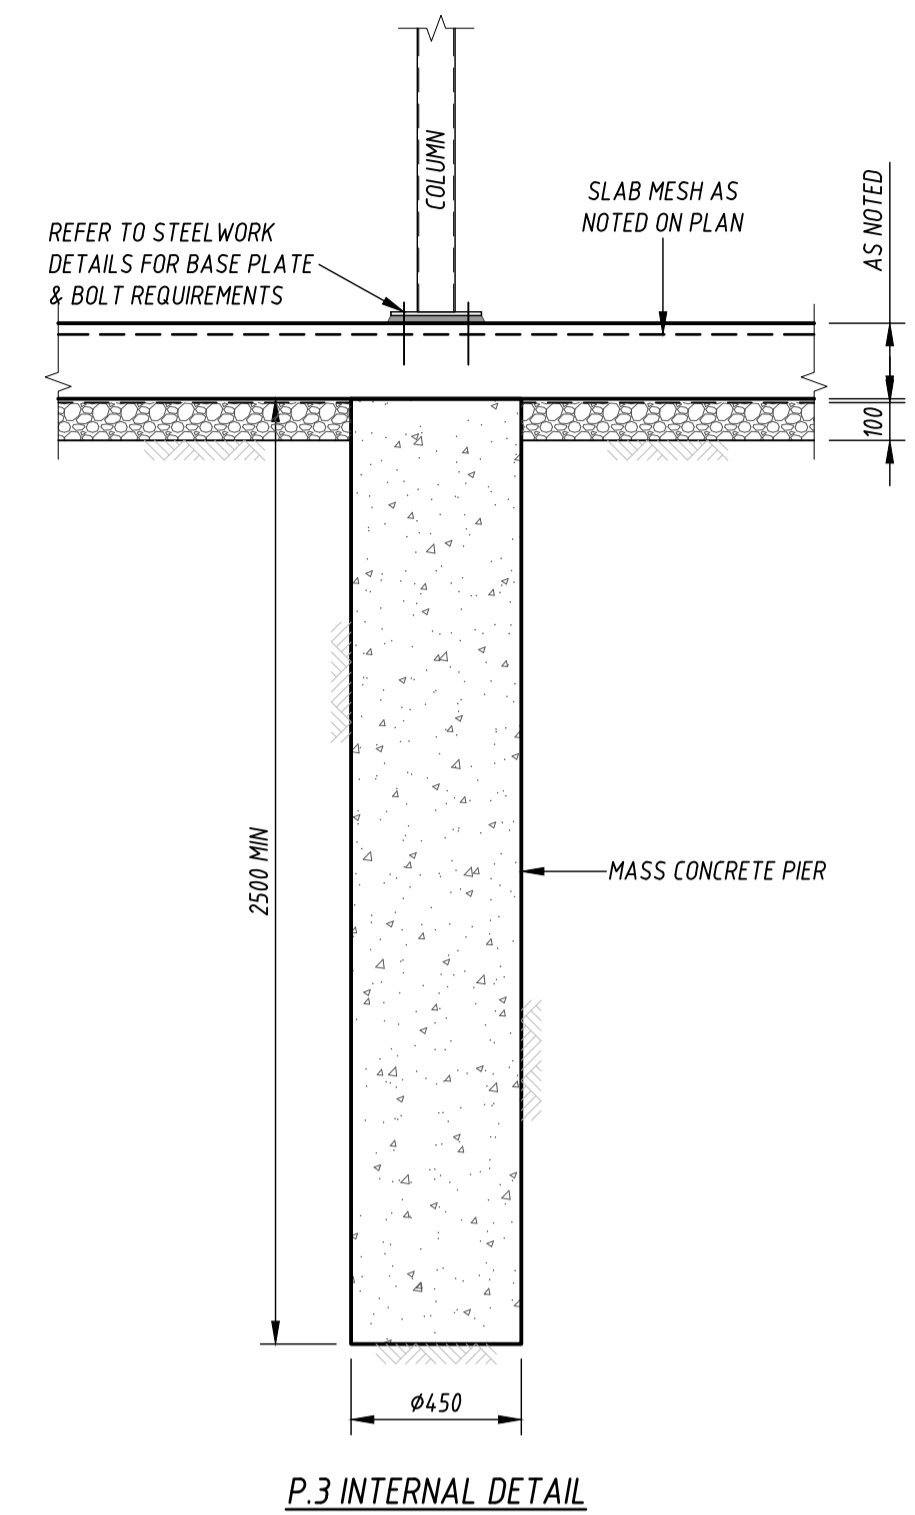


P.3 INTERNAL DETAIL

**CONCRETE PIER DETAILS**  
SCALE 1:20

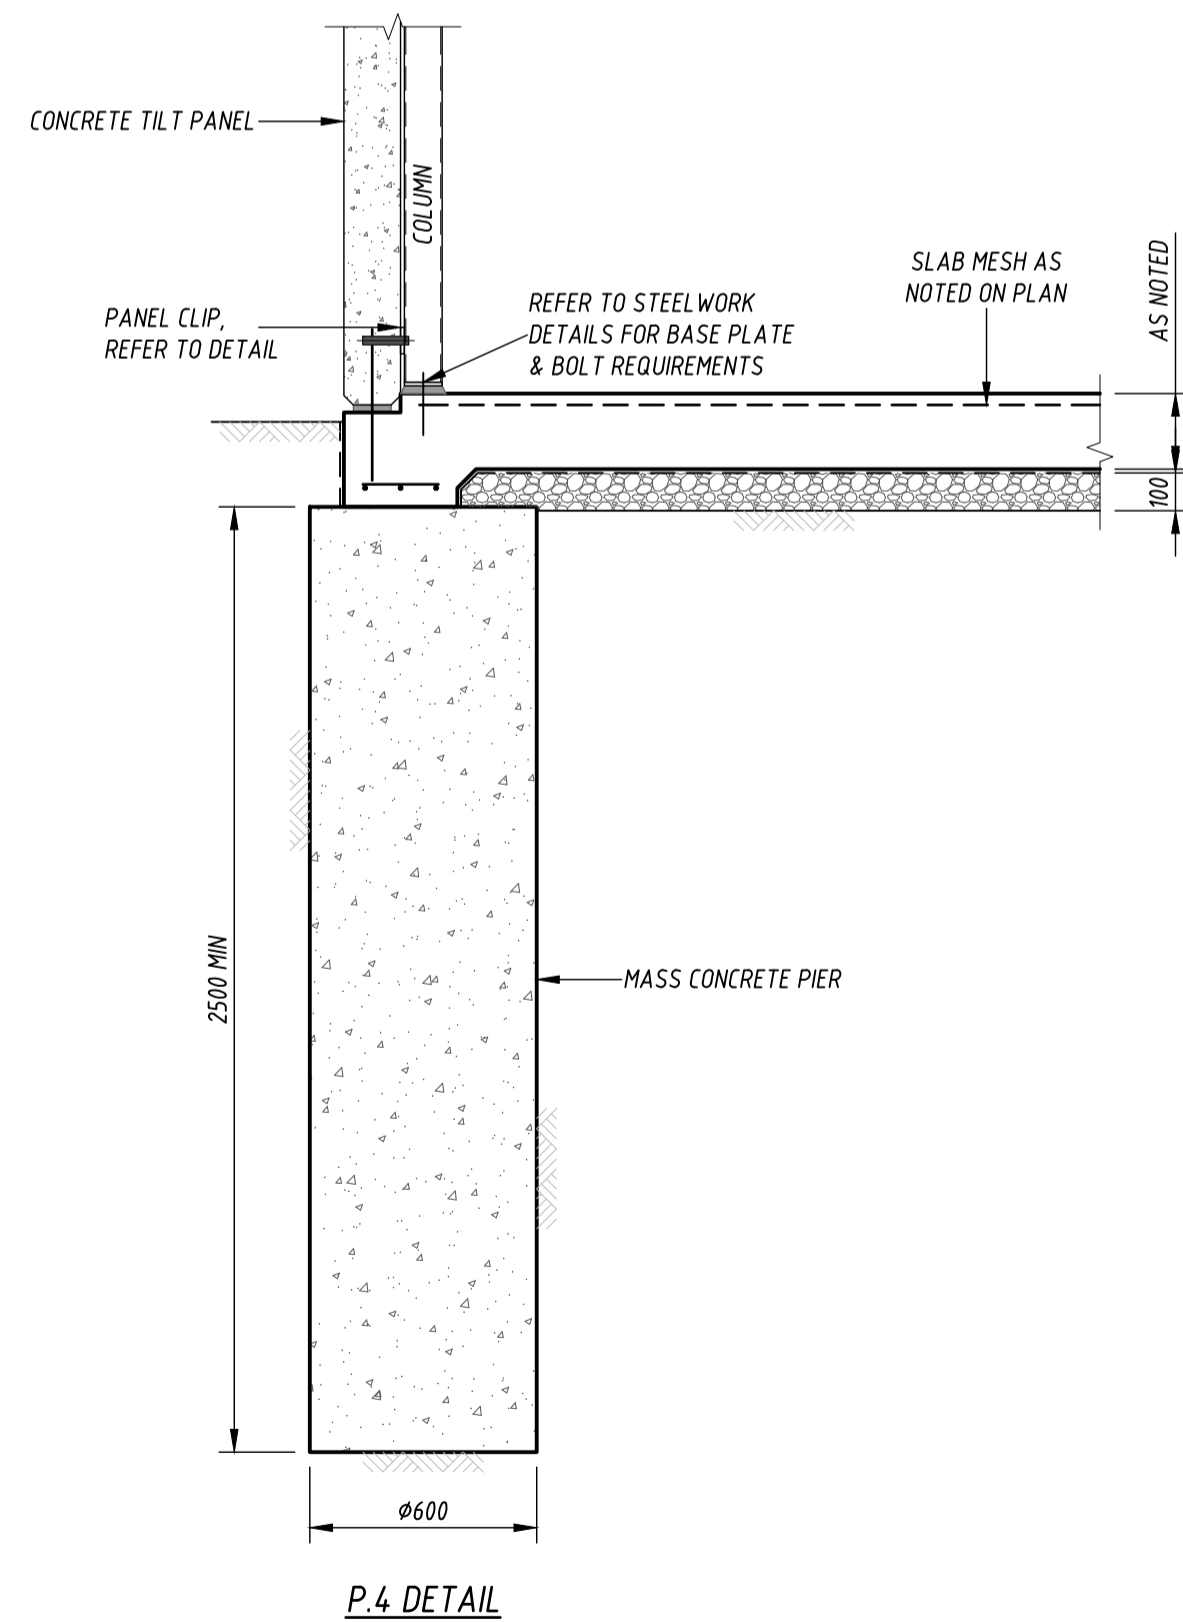

P.4 DETAIL

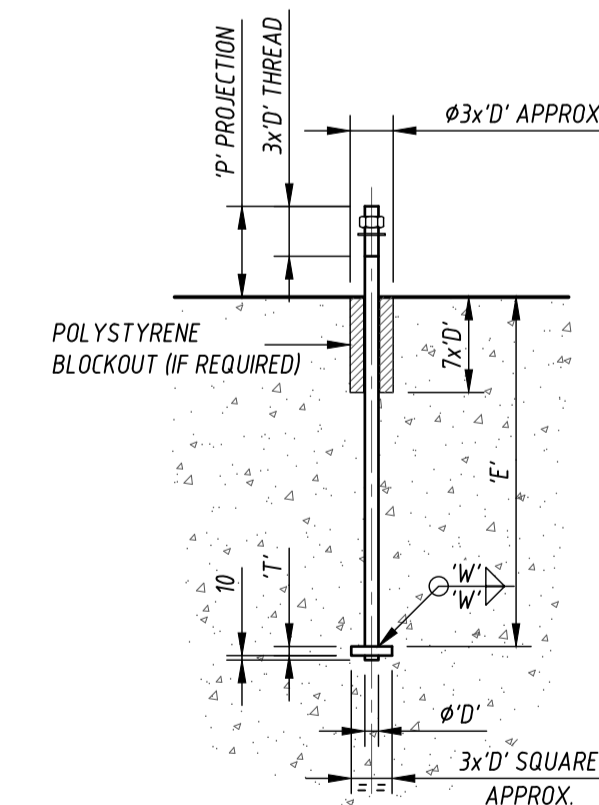

Ø'D'	T'	W'	E'	H'
20	16	6	450	150

PROJECTION 'P' = GROUT + BASE PLATE + 2x'D' MINIMUM, TYPICAL


**HOLD DOWN BOLTS NOTES**  
(APPLICABLE U.N.O. ON DESIGN DRAWINGS)

1. ALL BOLTS SHALL ACCURATELY SET WITH TEMPLATE.
2. ALL POLYSTYRENE SHALL BE REMOVED FROM BLOCKOUTS AFTER CONCRETE HAS CURED.
3. ALL BOLTS SHALL BE SUPPLIED WITH 1 NUT AND 1 FLAT WASHER.
4. ALL BOLTS, NUTS, AND WASHERS SHALL HAVE HOT DIPPED GALVANISED FINISH.
5. ALL BOLTS SHALL BE GRADE 4.6 U.N.O.
6. ALL BOLTS SHALL BE SECURELY FIXED TO ENSURE NO POSSIBLE MOVEMENT DURING CONCRETE PLACEMENT.

**HOLD DOWN (H.D) BOLT DETAIL**  
SCALE N.T.S.

**FOR APPROVAL**

No	Revision Description	Drawn	Approved	Date
A	ISSUED FOR APPROVAL	JTB	-	17.05.21

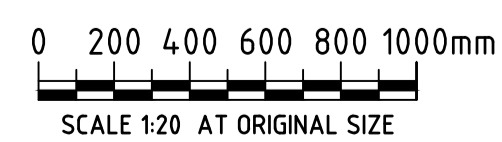


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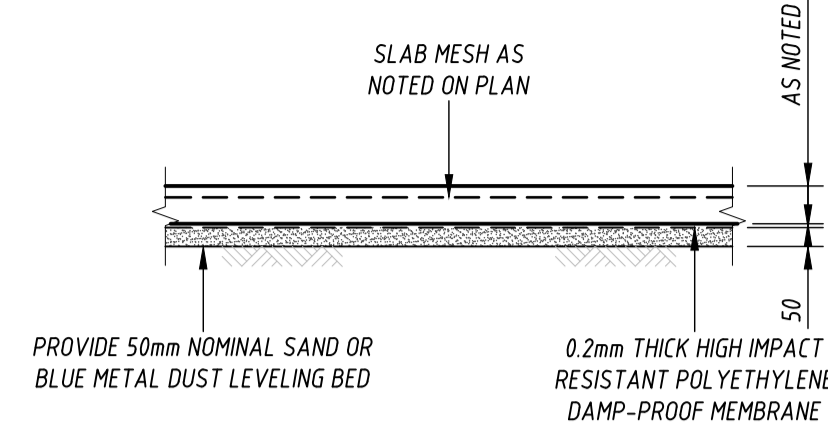
Project  
**PROPOSED WORKSHOP**  
**LOT 1 INDUSTRIAL AVENUE, MUDGEE**  
Title  
**CONCRETE DETAILS '1'**

Client **HOT ENGINEERING**  
Drawn JTB Designed [Signature] Approved -  
Scale AS SHOWN Date MAY '2021'  
Job No: **37880** Drawing No: **S.10** Rev: **A** Original Size **A1**




**TYPICAL SLAB DETAIL**

SCALE 1:20  
NOTE: SUBGRADE TO BE PREPARED IN ACCORDANCE WITH THE NOTES ON DRAWING NO.S.01

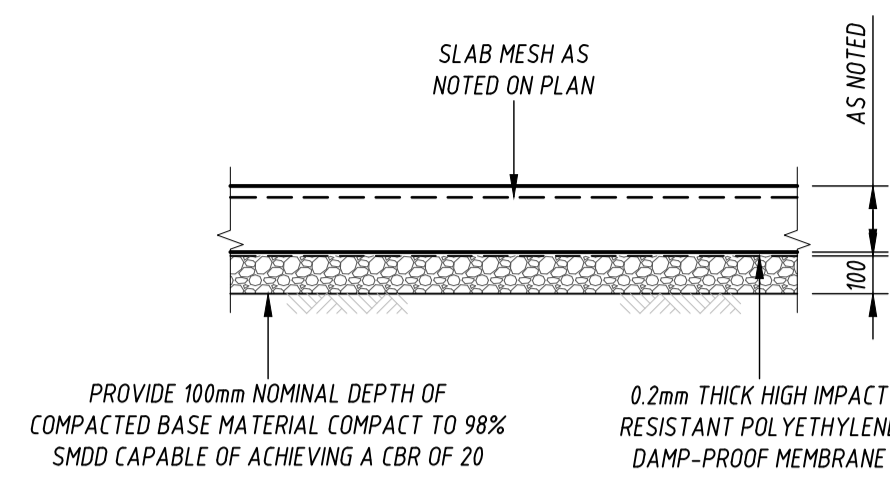


**TYPICAL OFFICE SLAB DETAIL**

SCALE 1:20

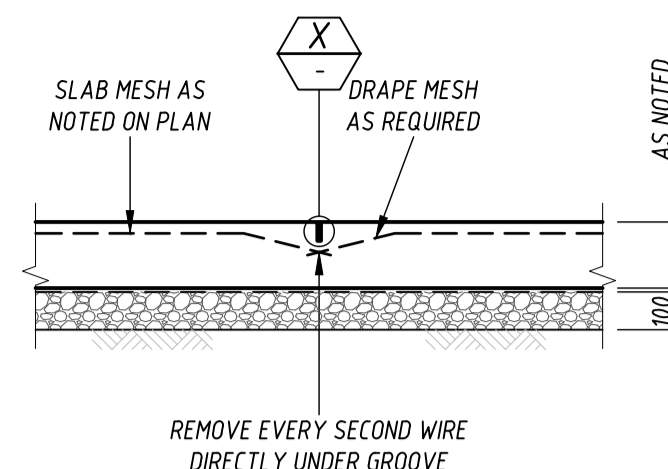


**SAWN JOINT (S.J.) DETAIL**

SCALE 1:20  
NOTE: SAWN JOINTS TO BE CUT AS SOON AS IT IS POSSIBLE (NOT MORE THAN 16 HOURS AFTER PLACEMENT)

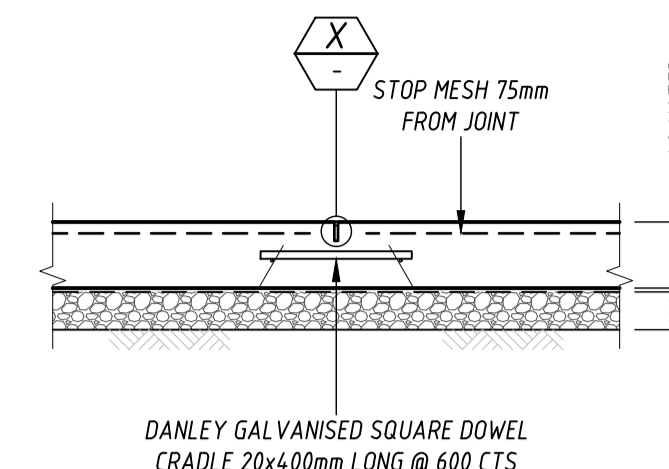


**DOWEL JOINT (D.J.1) DETAIL**

SCALE 1:20

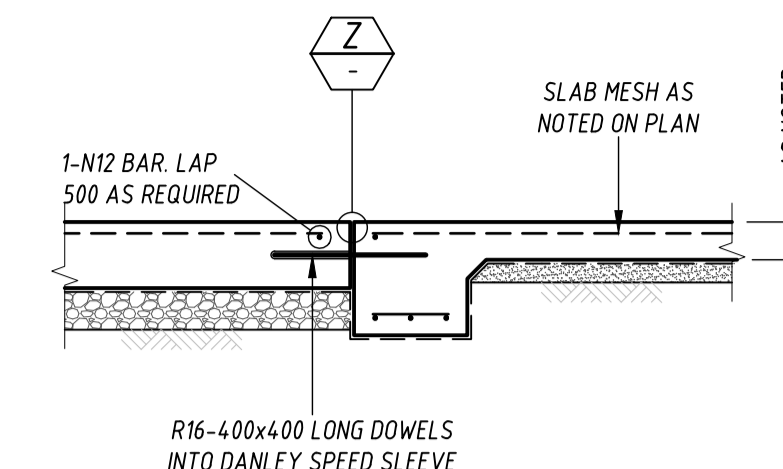


**DOWEL JOINT (D.J.2) DETAIL**

SCALE 1:20

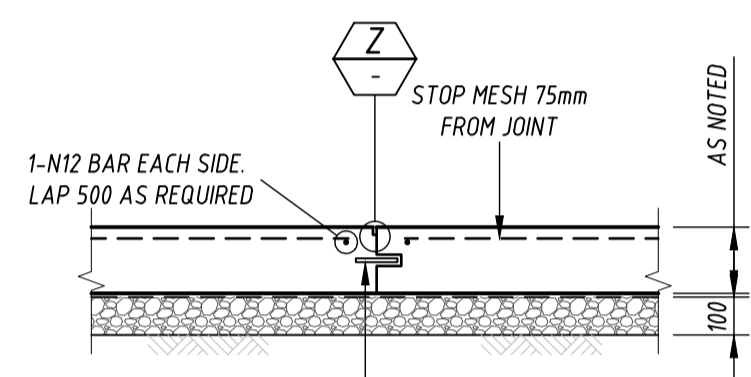


**DOWEL EXPANSION JOINT (D.E.J.) DETAIL**

SCALE 1:20

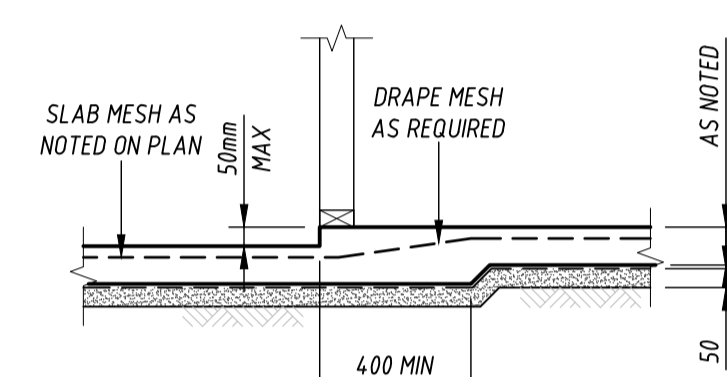

**WET AREA SETDOWN (S.D.) DETAIL**


SCALE 1:20

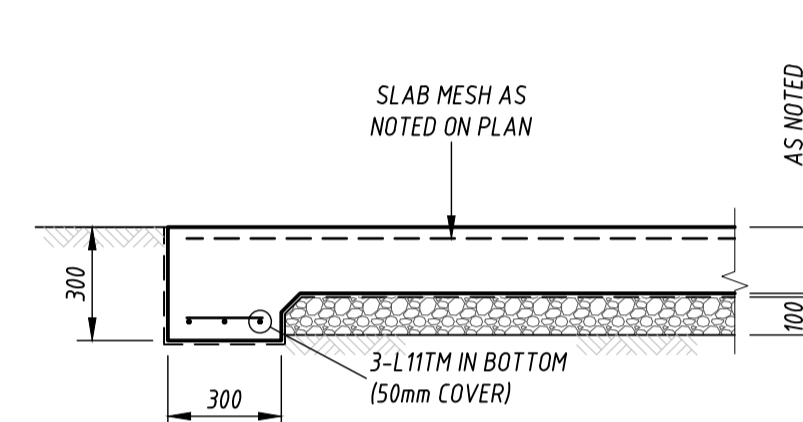

**EDGE THICKENING DETAIL**

SCALE 1:20


3mm WIDE SAWN JOINT - WE RECOMMEND THAT THE JOINT IS FILLED WITH SEALANT SUCH AS 'SIKAFLEX - 11FC' BY SIKA, OR EQUIVALENT

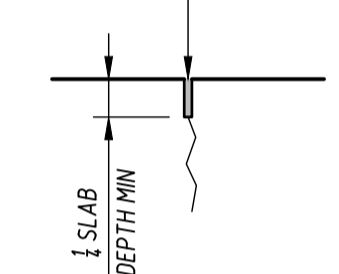

**DETAIL X**

SCALE N.T.S.


WE RECOMMEND THAT THE JOINT IS FILLED WITH SEALANT SUCH AS 'SIKAFLEX - 11FC' BY SIKA, OR EQUIVALENT

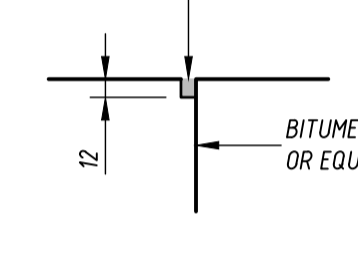

**DETAIL W**


SCALE N.T.S.

JOINT IS FILLED WITH SEALANT SUCH AS 'SIKAFLEX - 11FC' BY SIKA, OR EQUIVALENT

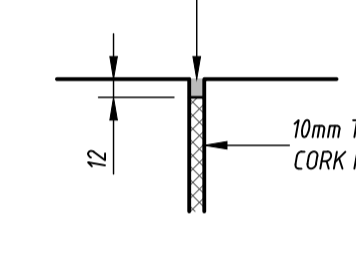

**DETAIL Z**


SCALE N.T.S.

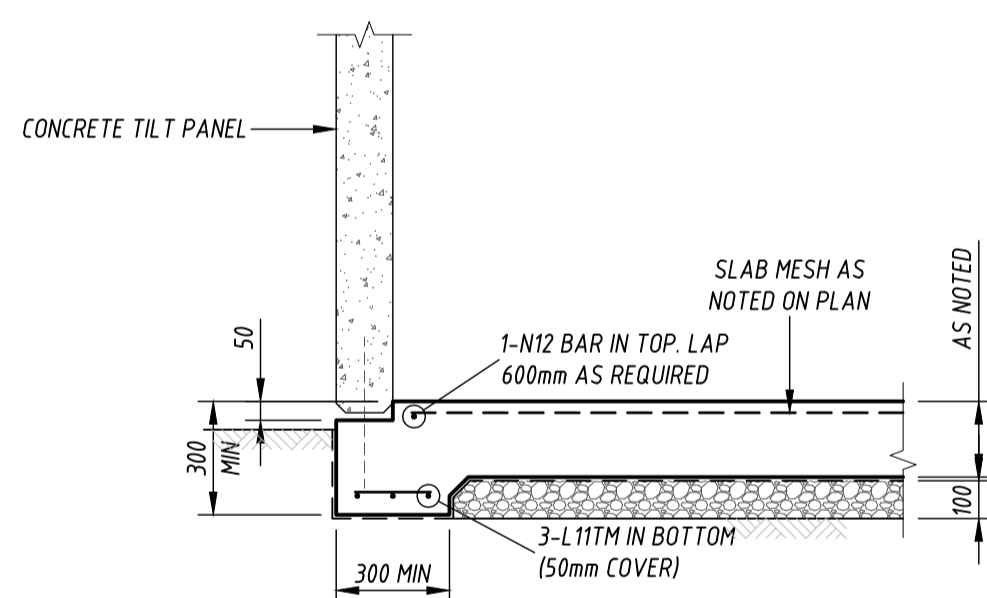


**TILT PANEL DETAIL**

**EDGE BEAM DETAILS**

SCALE 1:20

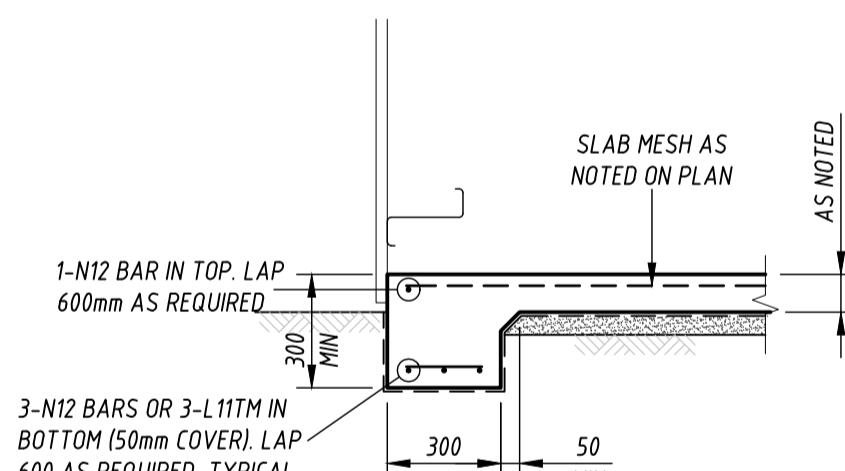


**OFFICE DETAIL**

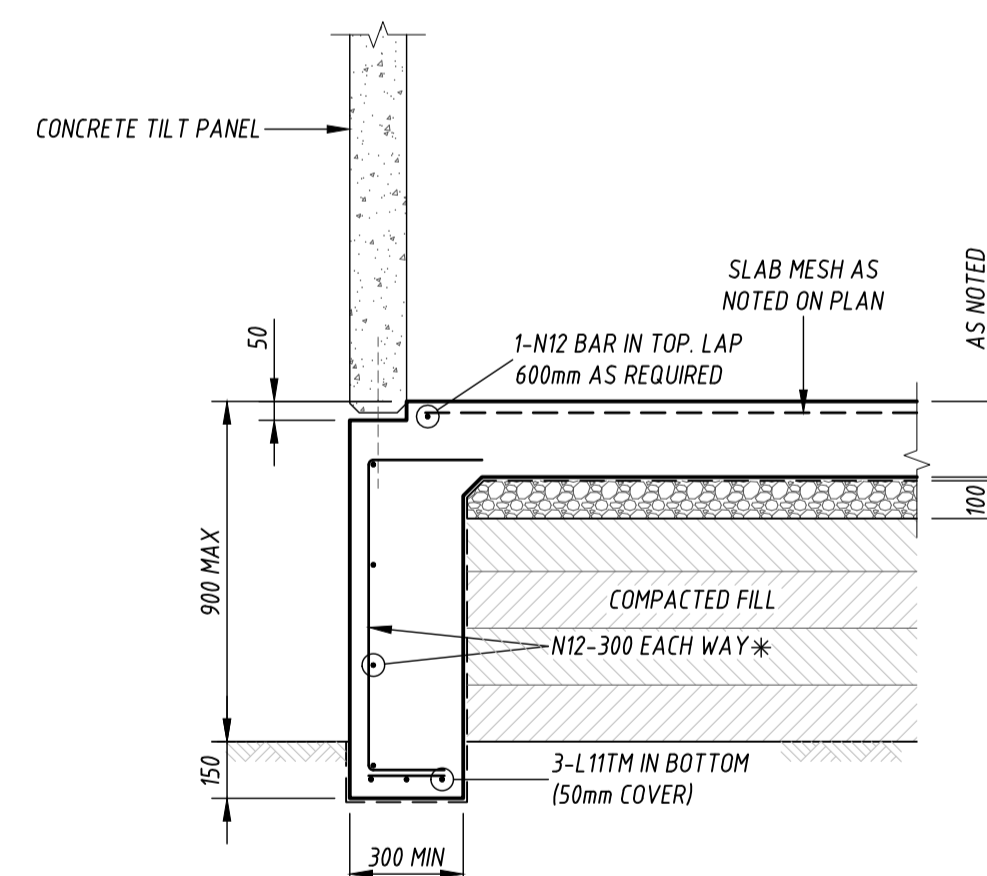

**DROPPED EDGE BEAM DETAIL**

SCALE 1:20


\* NOTE: IF DROPPED EDGE LESS THAN 450mm ABOVE GROUND, N12-300 EACH WAY MAY BE OMITTED.

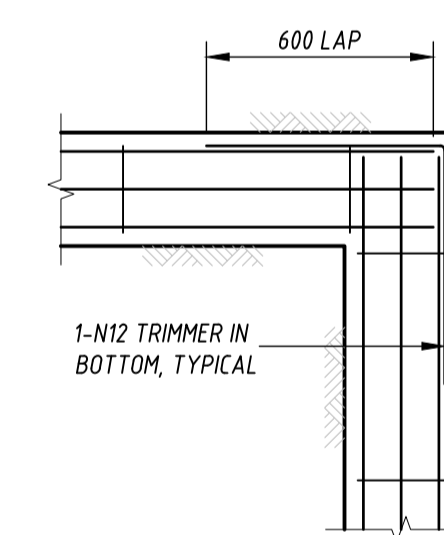

**TYPICAL CORNER DETAIL**

SCALE 1:20

PLAN VIEW: TYPICAL AT ALL CORNERS

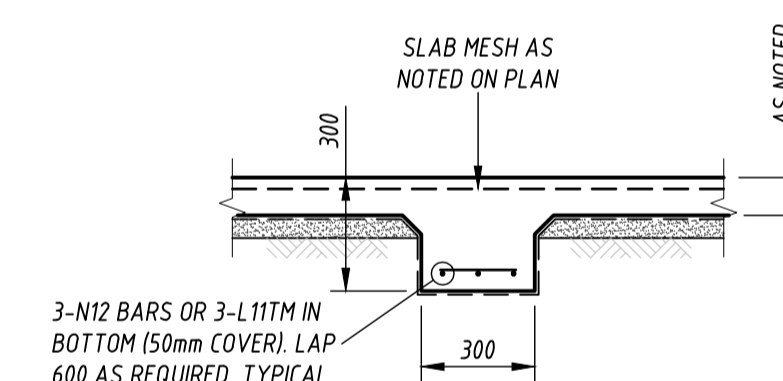


**INTERNAL BEAM DETAIL**

SCALE 1:20

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A	ISSUED FOR APPROVAL	JTB	-	17.05.21

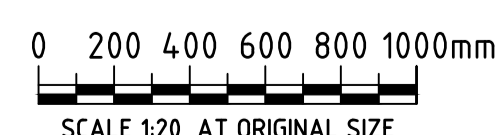

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Project

**PROPOSED WORKSHOP  
LOT 1 INDUSTRIAL AVENUE, MUDGEE**

Title

**CONCRETE DETAILS '2'**

Client **HOT ENGINEERING**

Drawn JTB Designed [Signature] Approved -



Scale AS SHOWN Date MAY '2021'

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Job No: **37880**

Drawing No: **S.11**

Rev: **A** Original Size **A1**

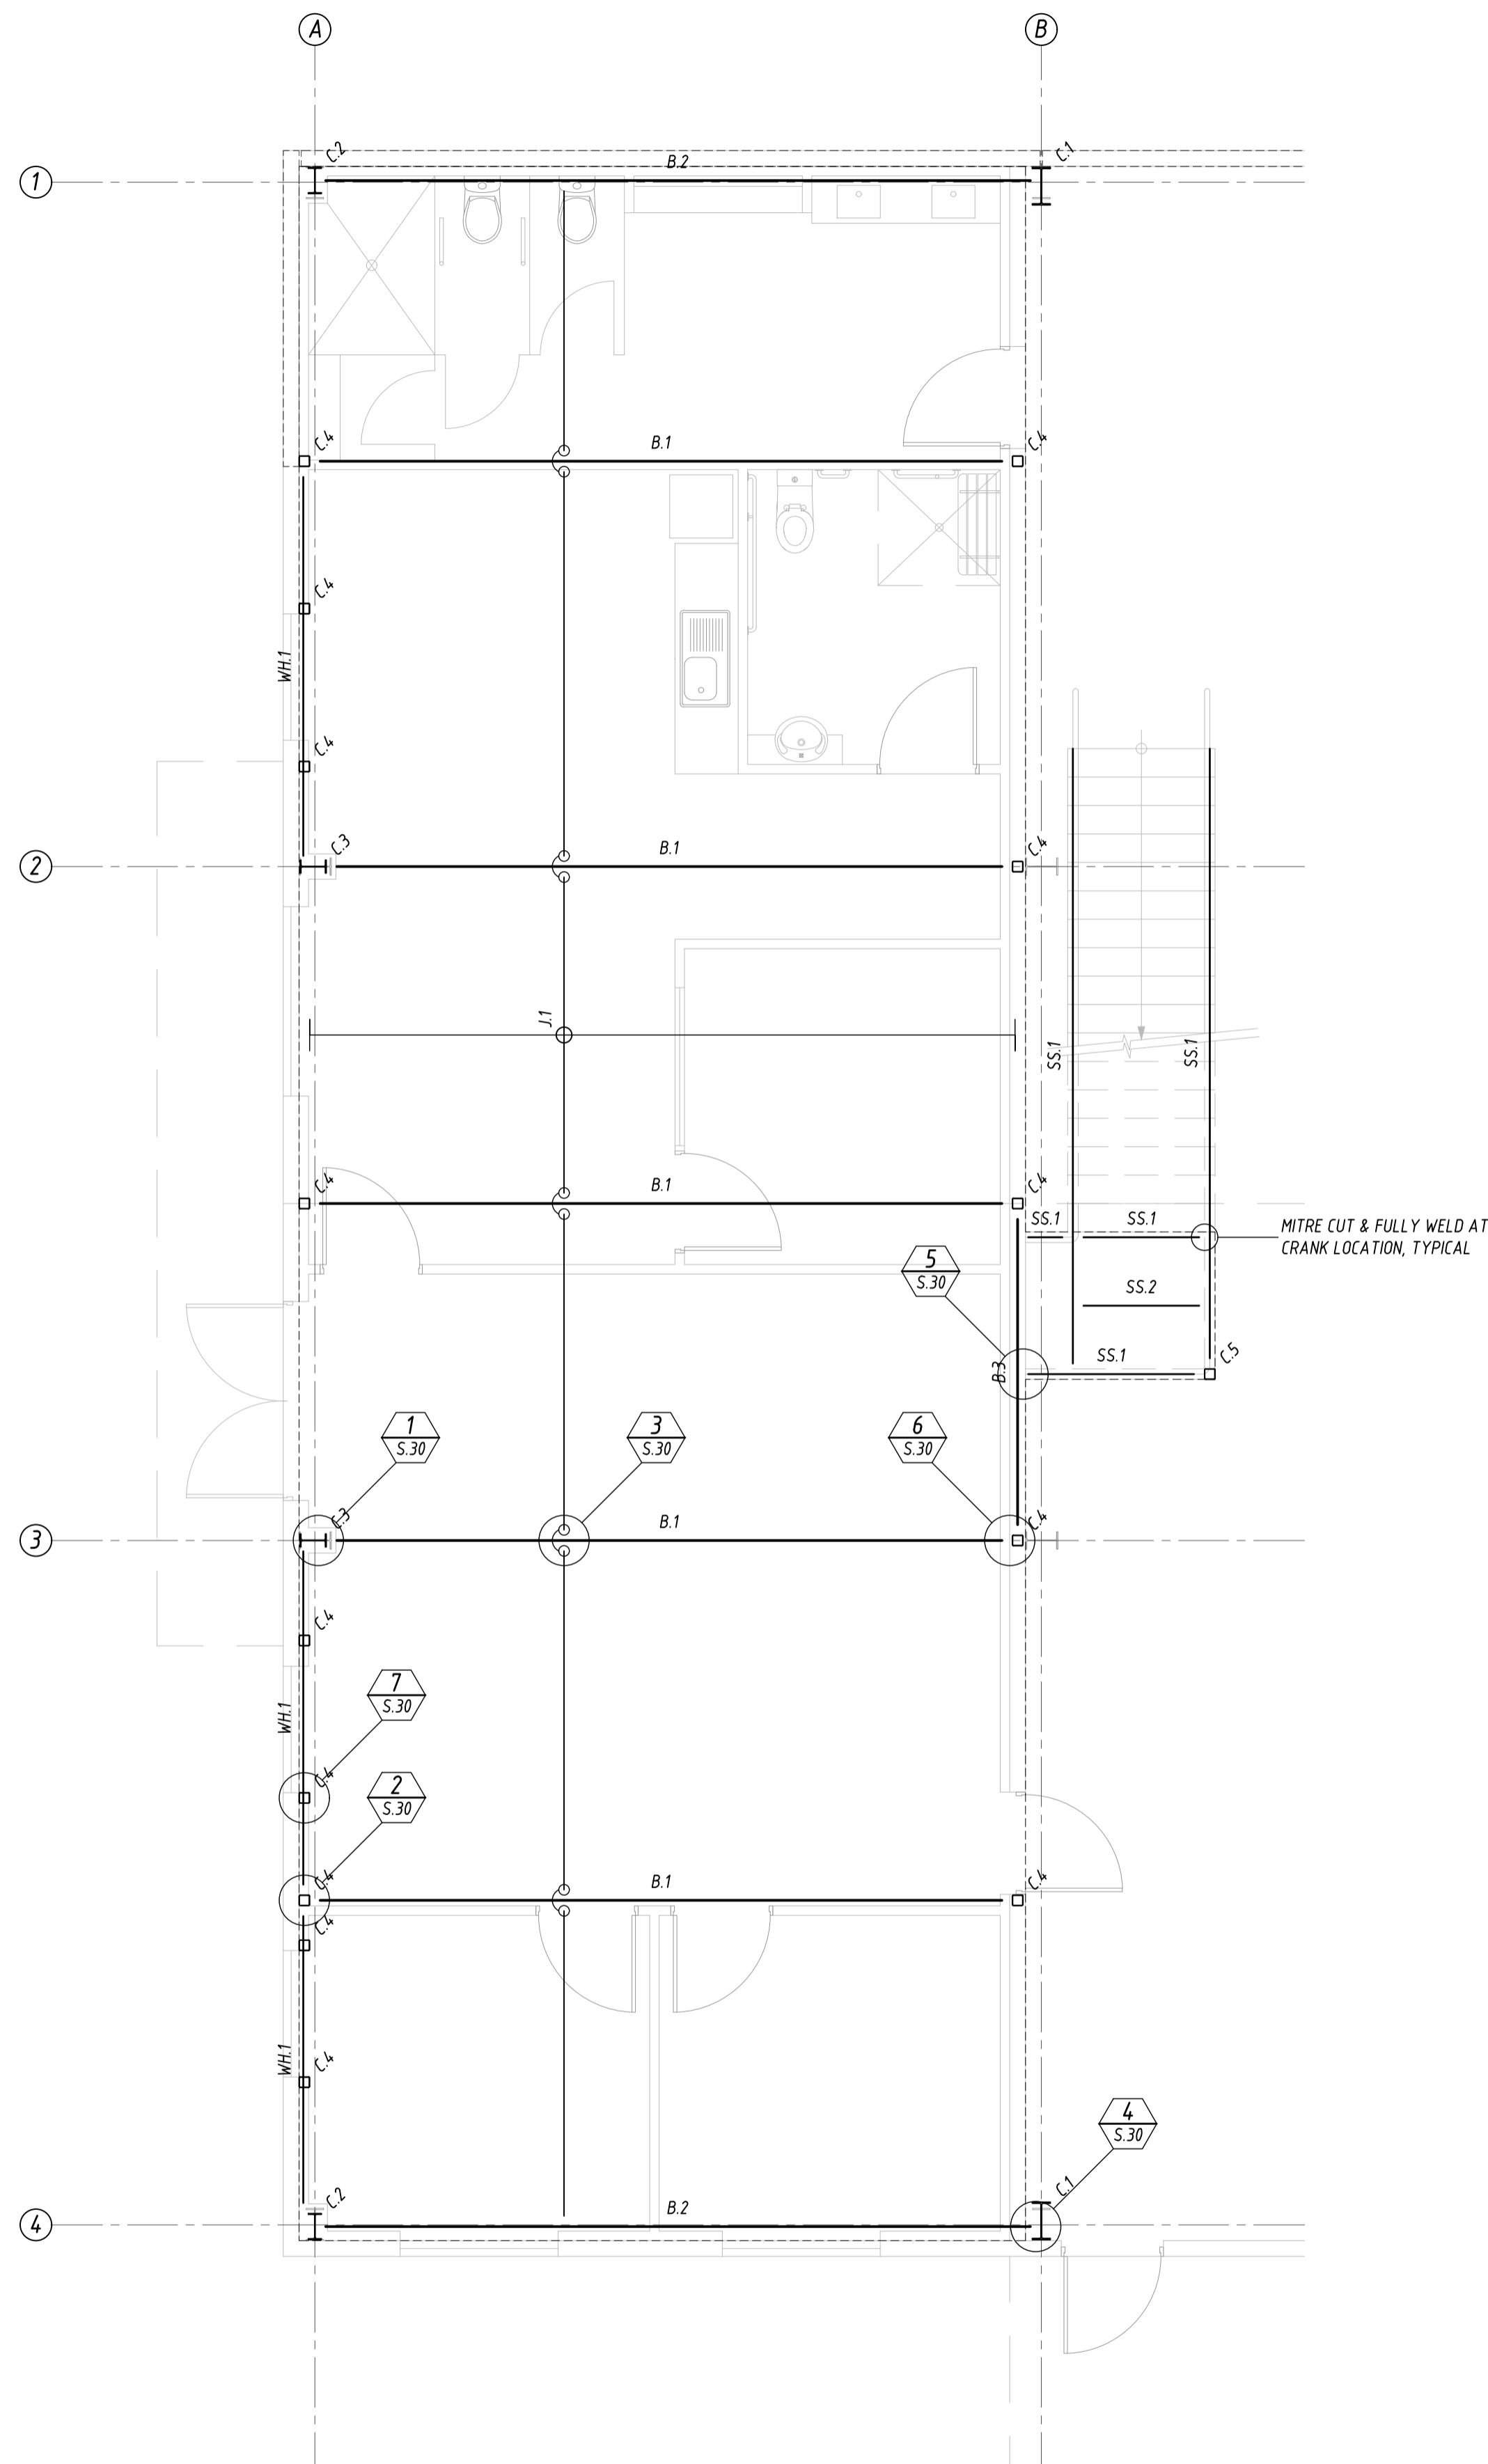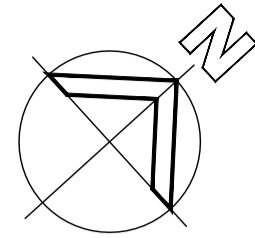


### MEZZANINE MARKING PLAN

SCALE 1:50

STEELWORK MEMBER SCHEDULE		
MARK	SIZE	REMARKS
B.1	360UB50	BEAM
B.2	300 PFC OR 310UB40	-
B.3	200 PFC	-
C.1	360UB50 - 1 FLY BRACE	-
C.2	250UB25	-
C.3	250UB25	-
C.4	100x4 SHS	-
C.5	75x4 SHS	-
J.1	C200 15 OR C150 19 @ 450mm MAX CTS	JOIST
SS.1	200 PFC	STAIR STRINGER
SS.2	75x6 EA	-
WH.1	150x100x4 RHS	WINDOW HEADER

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Project

**PROPOSED WORKSHOP  
 LOT 1 INDUSTRIAL AVENUE, MUDGEE**

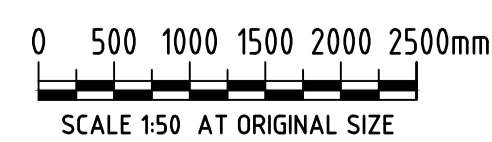
Title

**MEZZANINE MARKING PLAN**


Client **HOT ENGINEERING**

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Job No:	<b>37880</b>	Drawing No:	<b>S.20</b>	Rev:	<b>A A1</b>




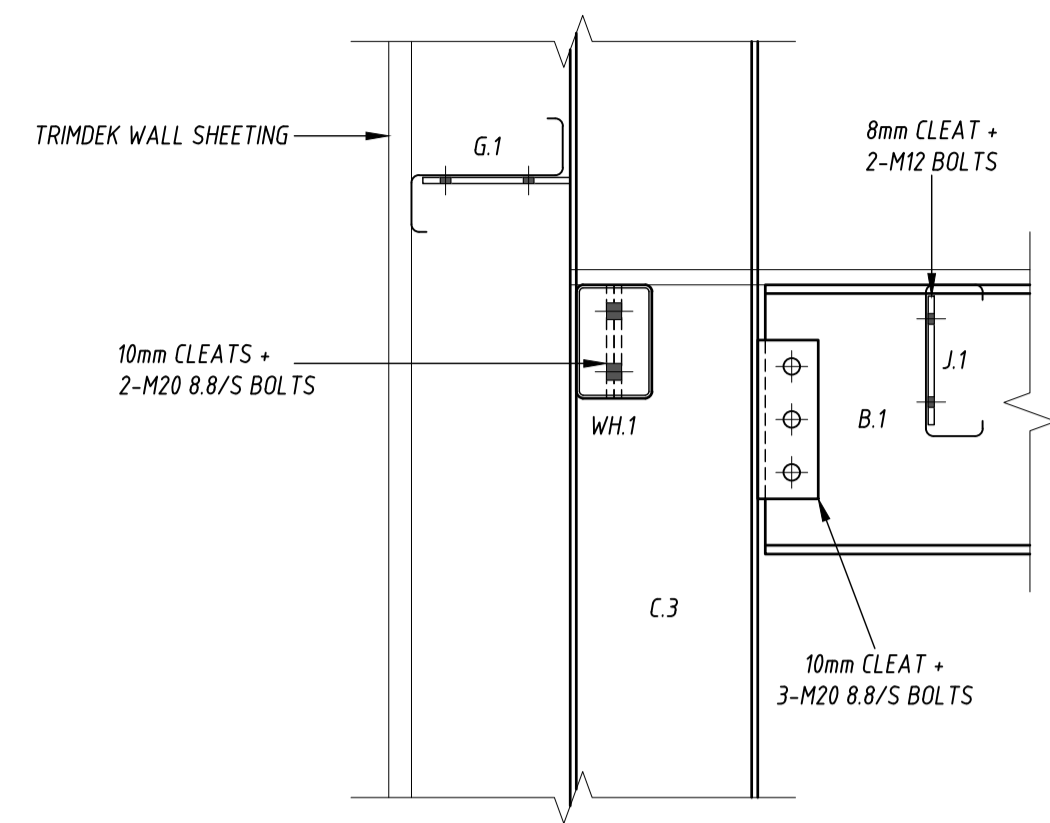


DETAIL 1  
SCALE 1:10 S.20

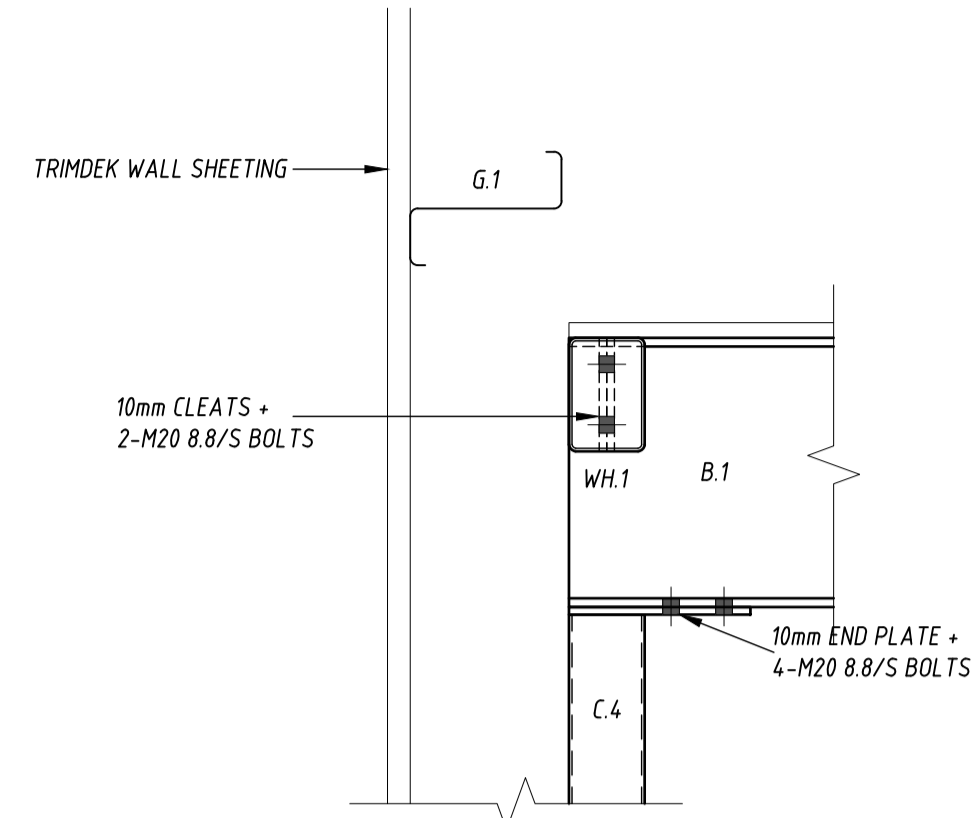


DETAIL 2  
SCALE 1:10 S.20

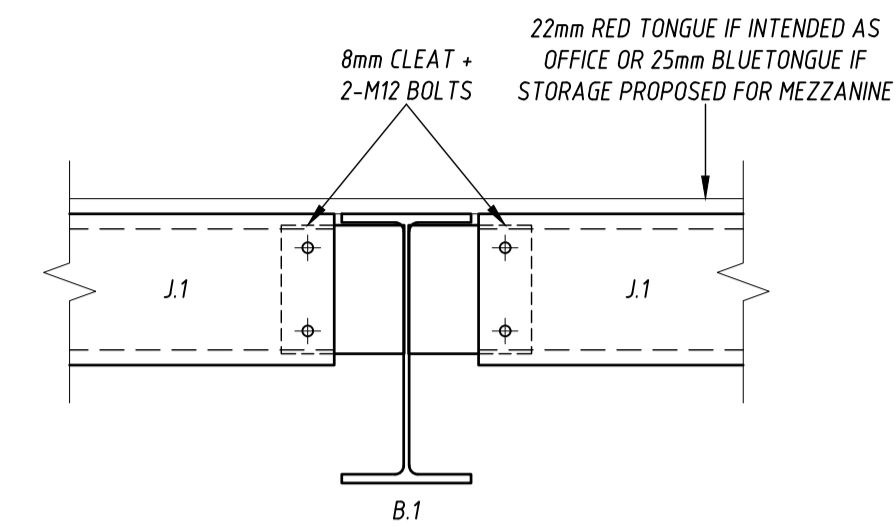


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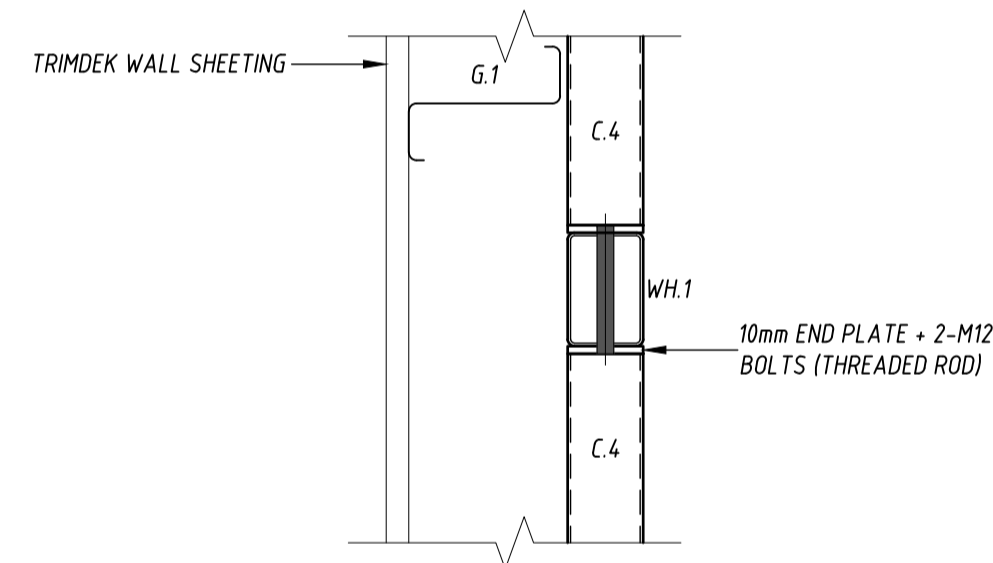
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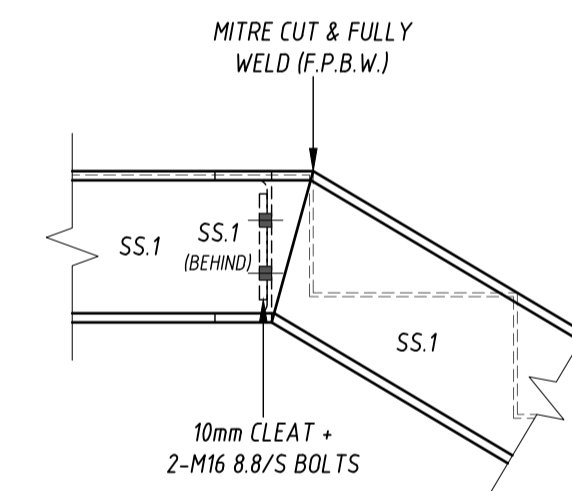
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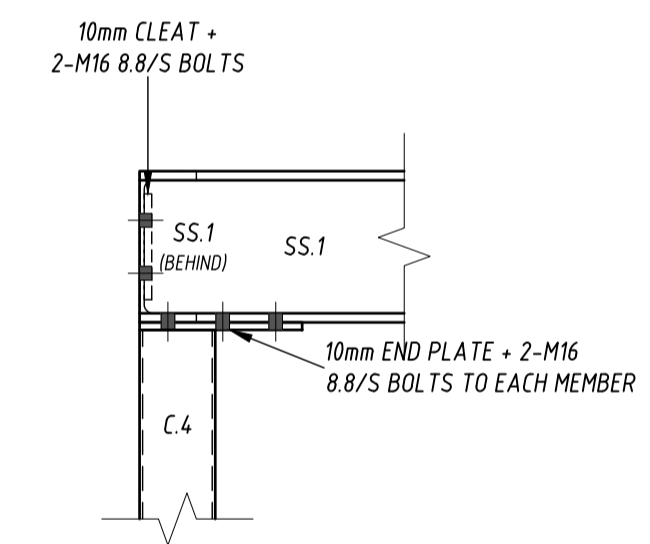
DETAIL 6  
SCALE 1:10 S.20

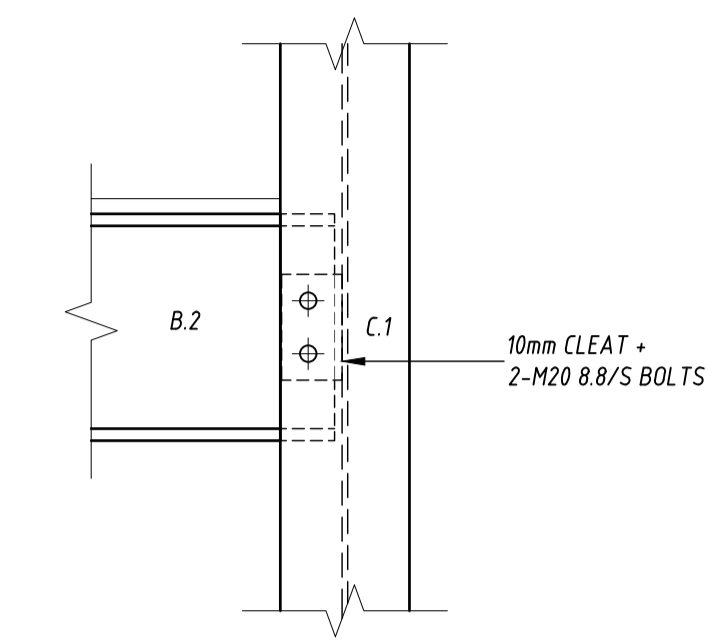

DETAIL 7  
SCALE 1:10 S.20

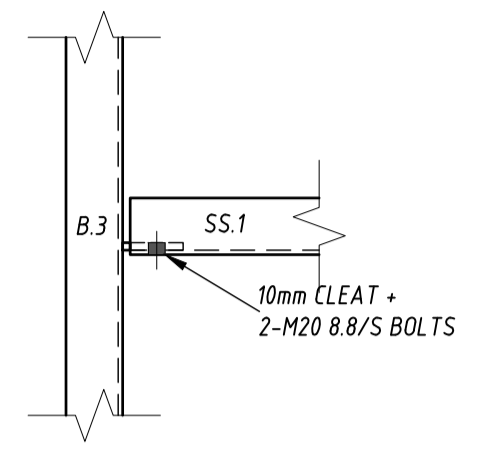

TYPICAL SS.1 AT LANDING DETAIL  
SCALE 1:10

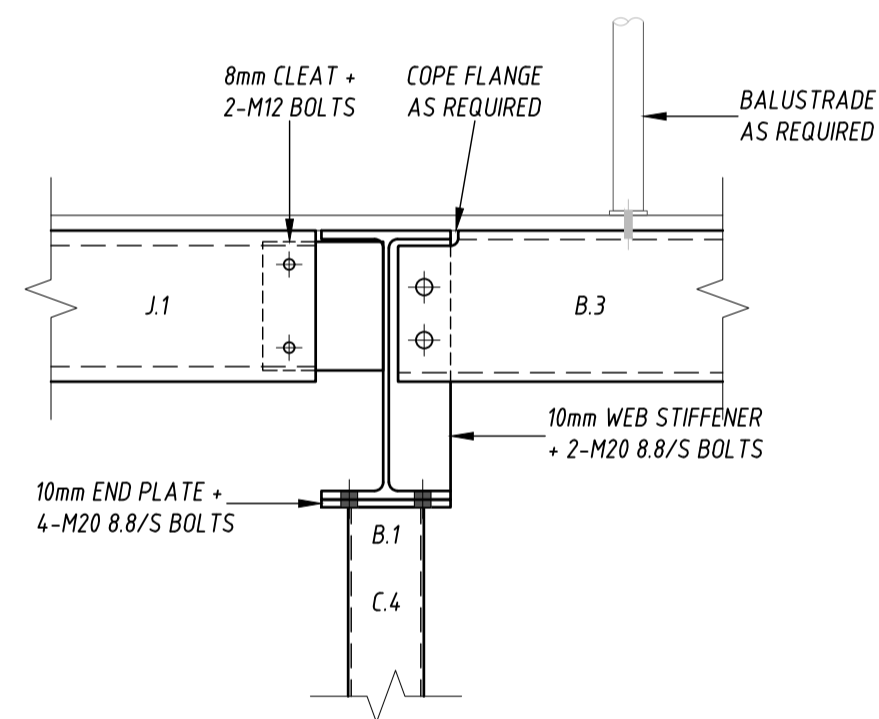


TYPICAL SS.1 TO C.4 DETAIL  
SCALE 1:10

10mm BASE PLATE + 2-M12 ANCHOR STUDS. EPOXY GROUT 110mm MIN INTO SLAB USING CHEMSET RED S02 XTREME. CLEAN OUT HOLES & INSTALL EPOXY IN ACCORDANCE WITH MANUFACTURER'S SPECIFICATIONS

C.4/S DETAIL

3mm STEEL CHEQUER PLATE FOLDED AS REQUIRED. RISERS & GOING TO ARCHITECTURAL DOCUMENTATION

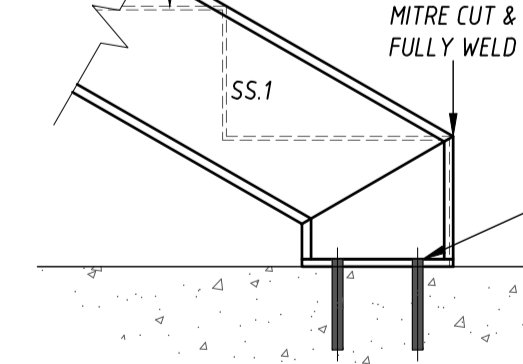

SS.1 DETAIL


TYPICAL BASE PLATE DETAILS

SCALE 1:10  
(REFER TO STEELWORK DETAILS FOR THE REST OF THE BASE PLATE DETAILS)

NOTE: DETAILS SHOW DESIGN INTENT. BUILDER/WORKSHOP DETAILER TO ACCURATELY DETERMINE POSITION OF FRAMING AND CONTACT COOK&ROE IF ANYTHING DIFFERS FROM THE DETAILS SHOWN

FOR APPROVAL

No	Revision Description	Drawn	Approved	Date
A	ISSUED FOR APPROVAL	JTB	-	17.05.21

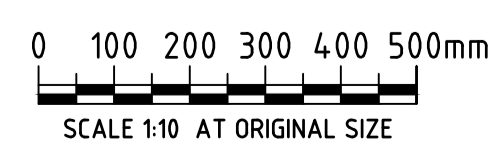

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Project

PROPOSED WORKSHOP  
LOT 1 INDUSTRIAL AVENUE, MUDGEE

Title



MEZZANINE DETAILS

Client **HOT ENGINEERING**

Drawn JTB Designed [Signature] Approved -

Scale AS SHOWN Date MAY '2021' This Drawing must not be used for Construction unless signed as Approved

Job No: **37880** Drawing No: **S.30** Rev: **A** Original Size **A1**

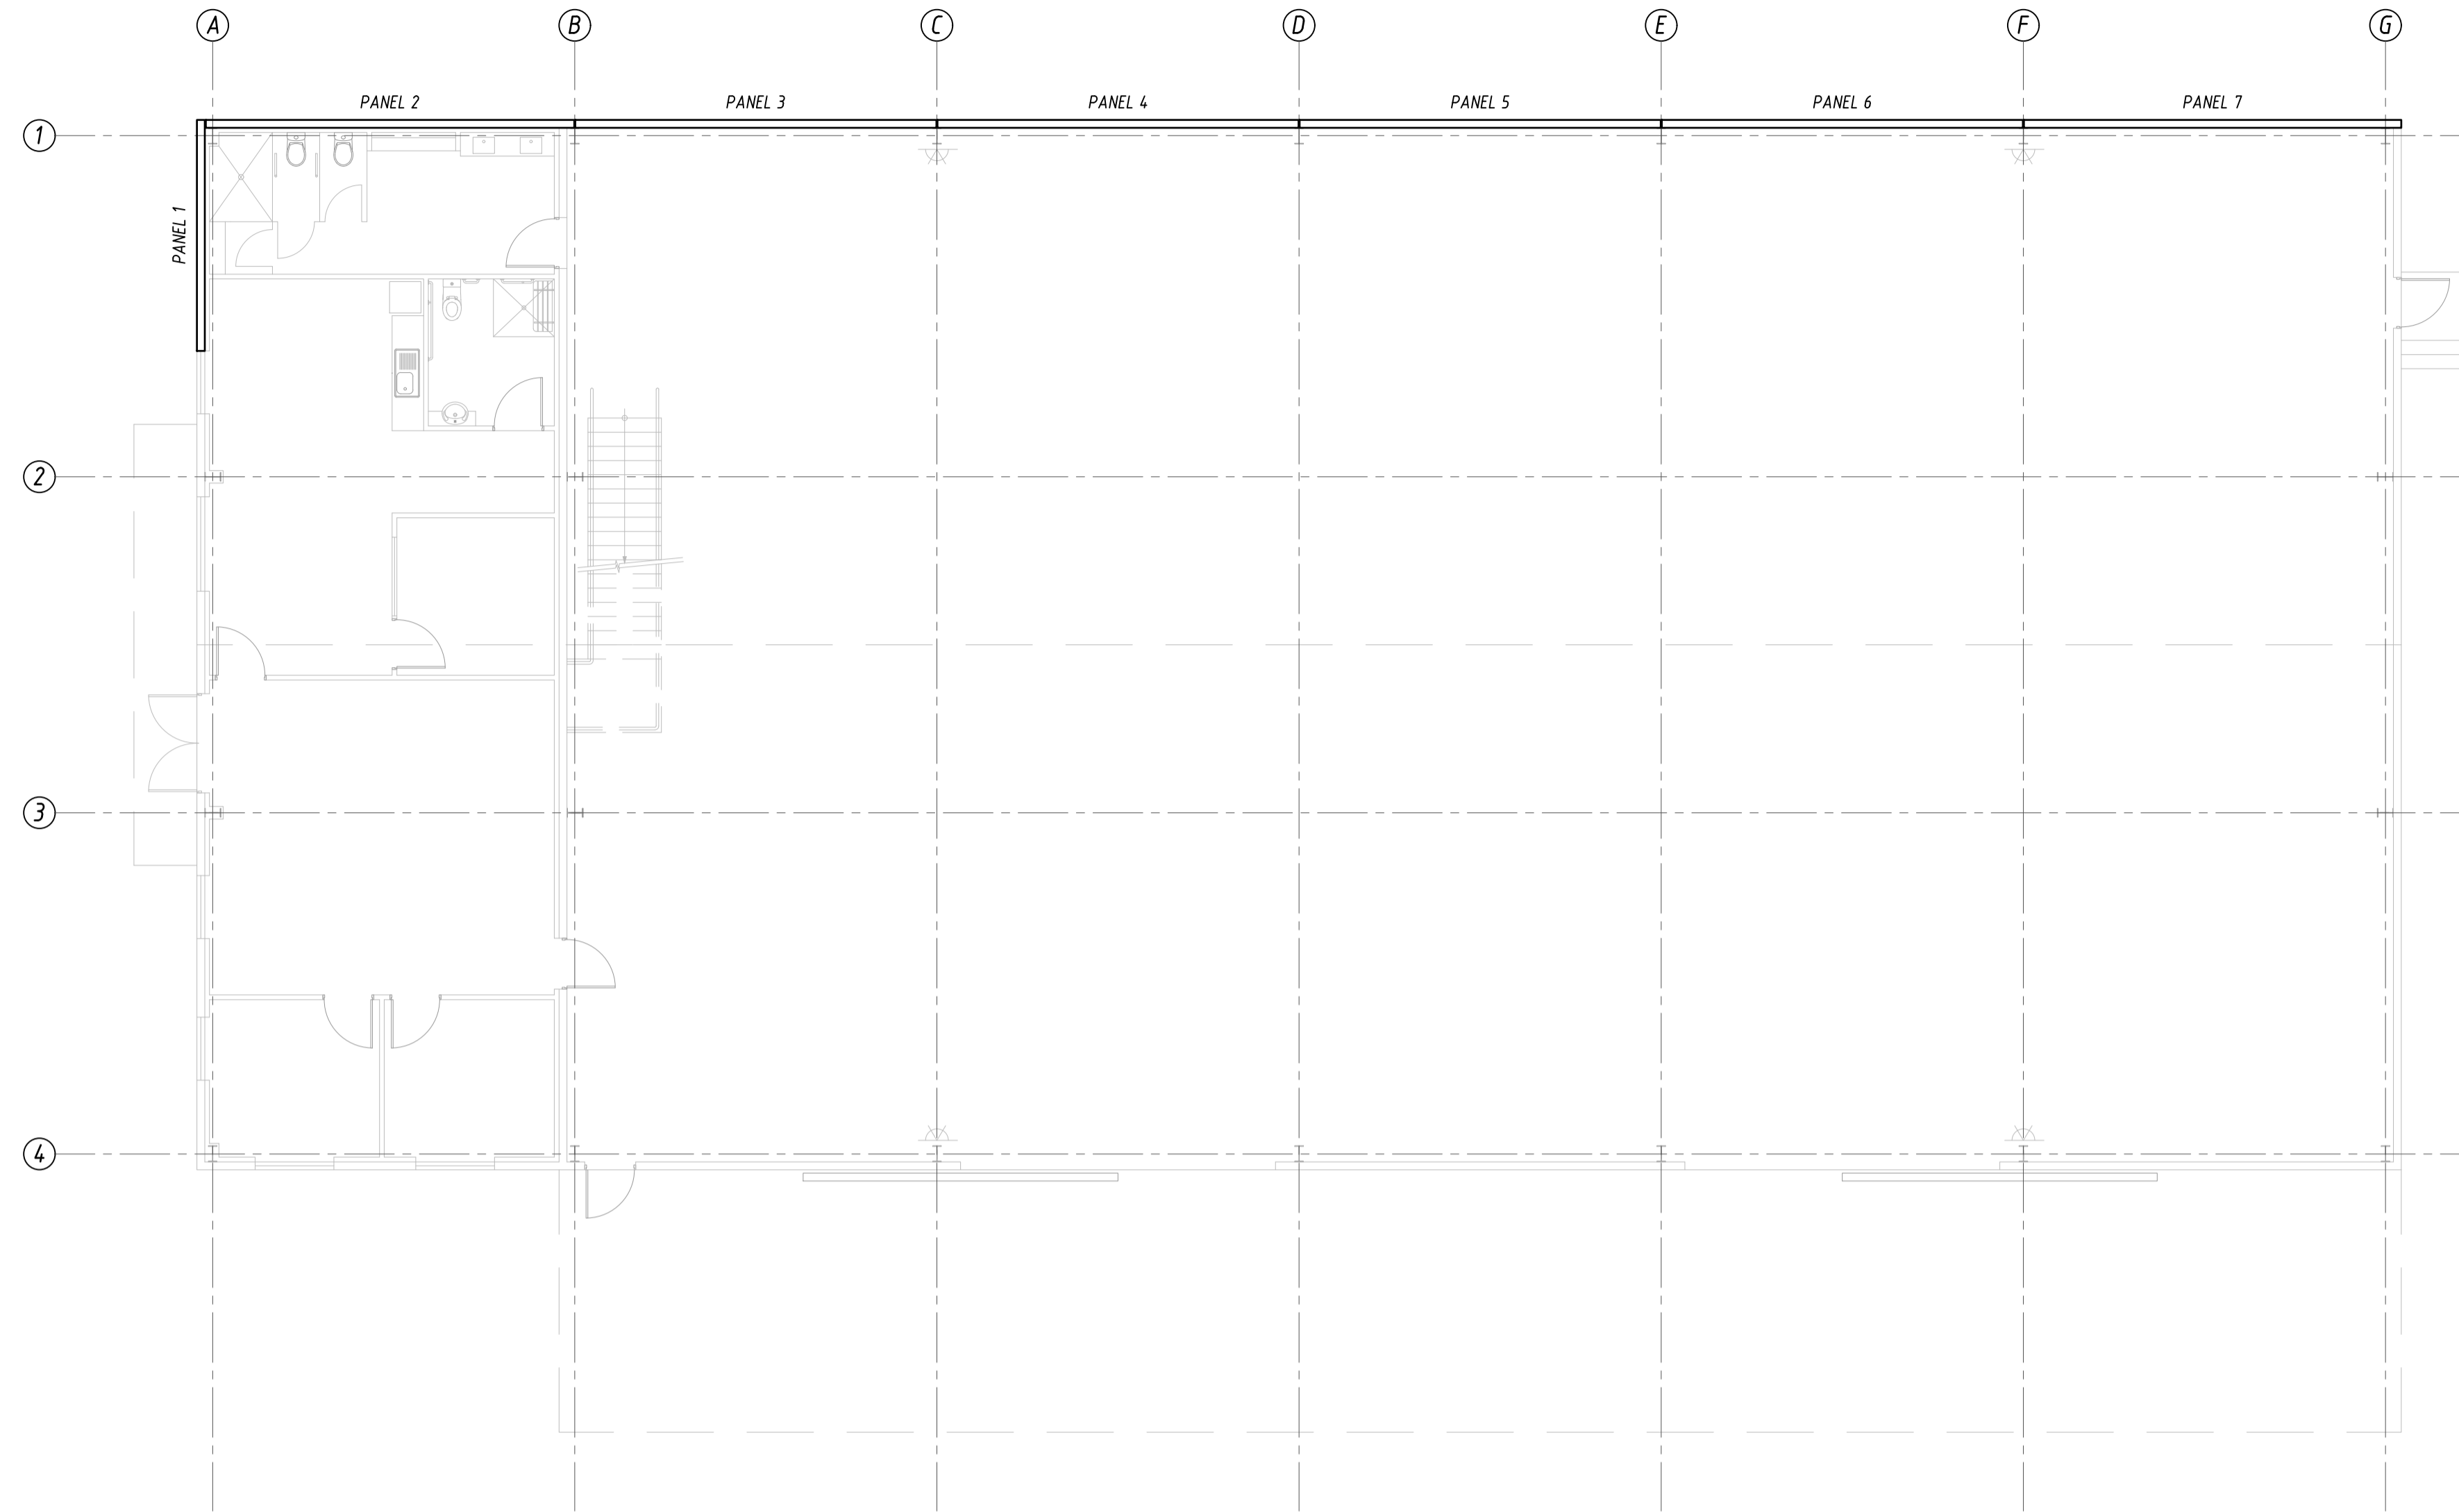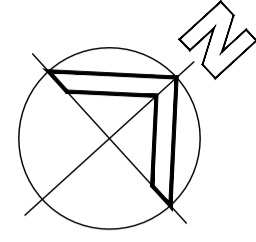

**CONCRETE TILT PANEL LAYOUT**


SCALE 1:100

ALL TILT PANELS TO BE 150mm THICK CONCRETE TILT PANELS U.N.O.

**NOTE:** OUR DESIGN ASSUMES THE USE OF M20x96 ROUND FERRULES FOR PANEL CONNECTIONS TO 150mm THICK TILT PANELS.

**FOR APPROVAL**

No	Revision Description	Drawn	Approved	Date
A	ISSUED FOR APPROVAL	JTB	-	17.05.21

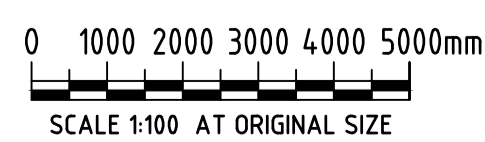

**DO NOT SCALE**


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Project **PROPOSED WORKSHOP  
 LOT 1 INDUSTRIAL AVENUE, MUDGEE**  
 Title **CONCRETE TILT PANEL LAYOUT**


Client **HOT ENGINEERING**

Drawn	JTB	Designed		Approved	-
Scale	AS SHOWN	Date	MAY '2021'	This Drawing must not be used for Construction unless signed as Approved	
Job No:	<b>37880</b>	Drawing No:	<b>S.40</b>	Rev:	<b>A</b>
				Original Size	<b>A1</b>



**NORTH WESTERN ELEVATION**

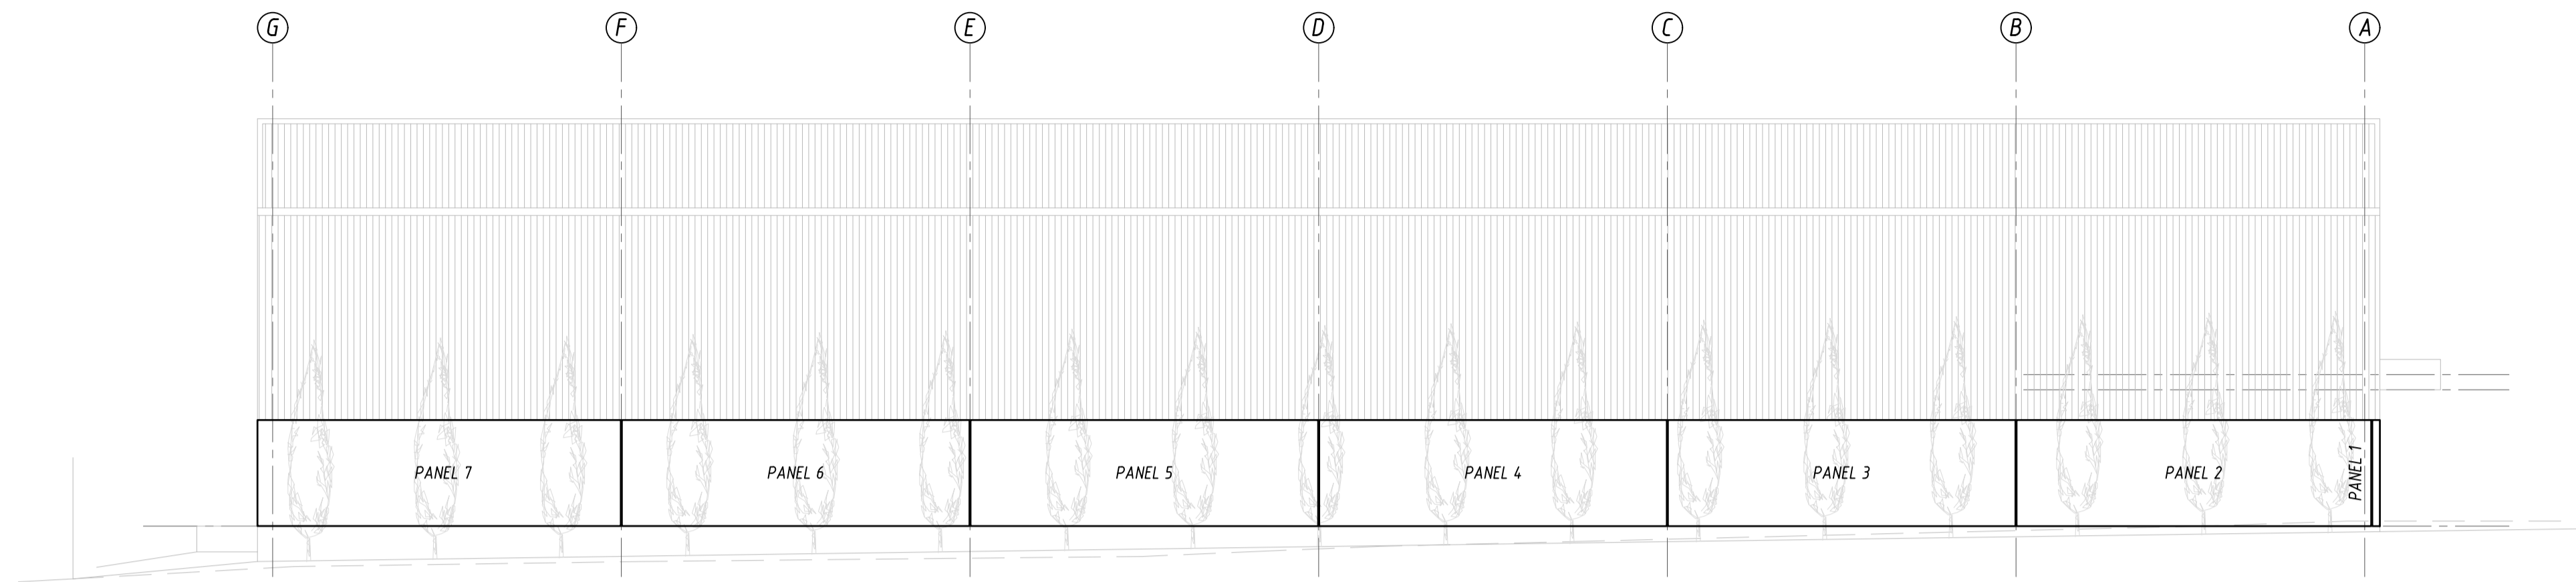SCALE 1:100

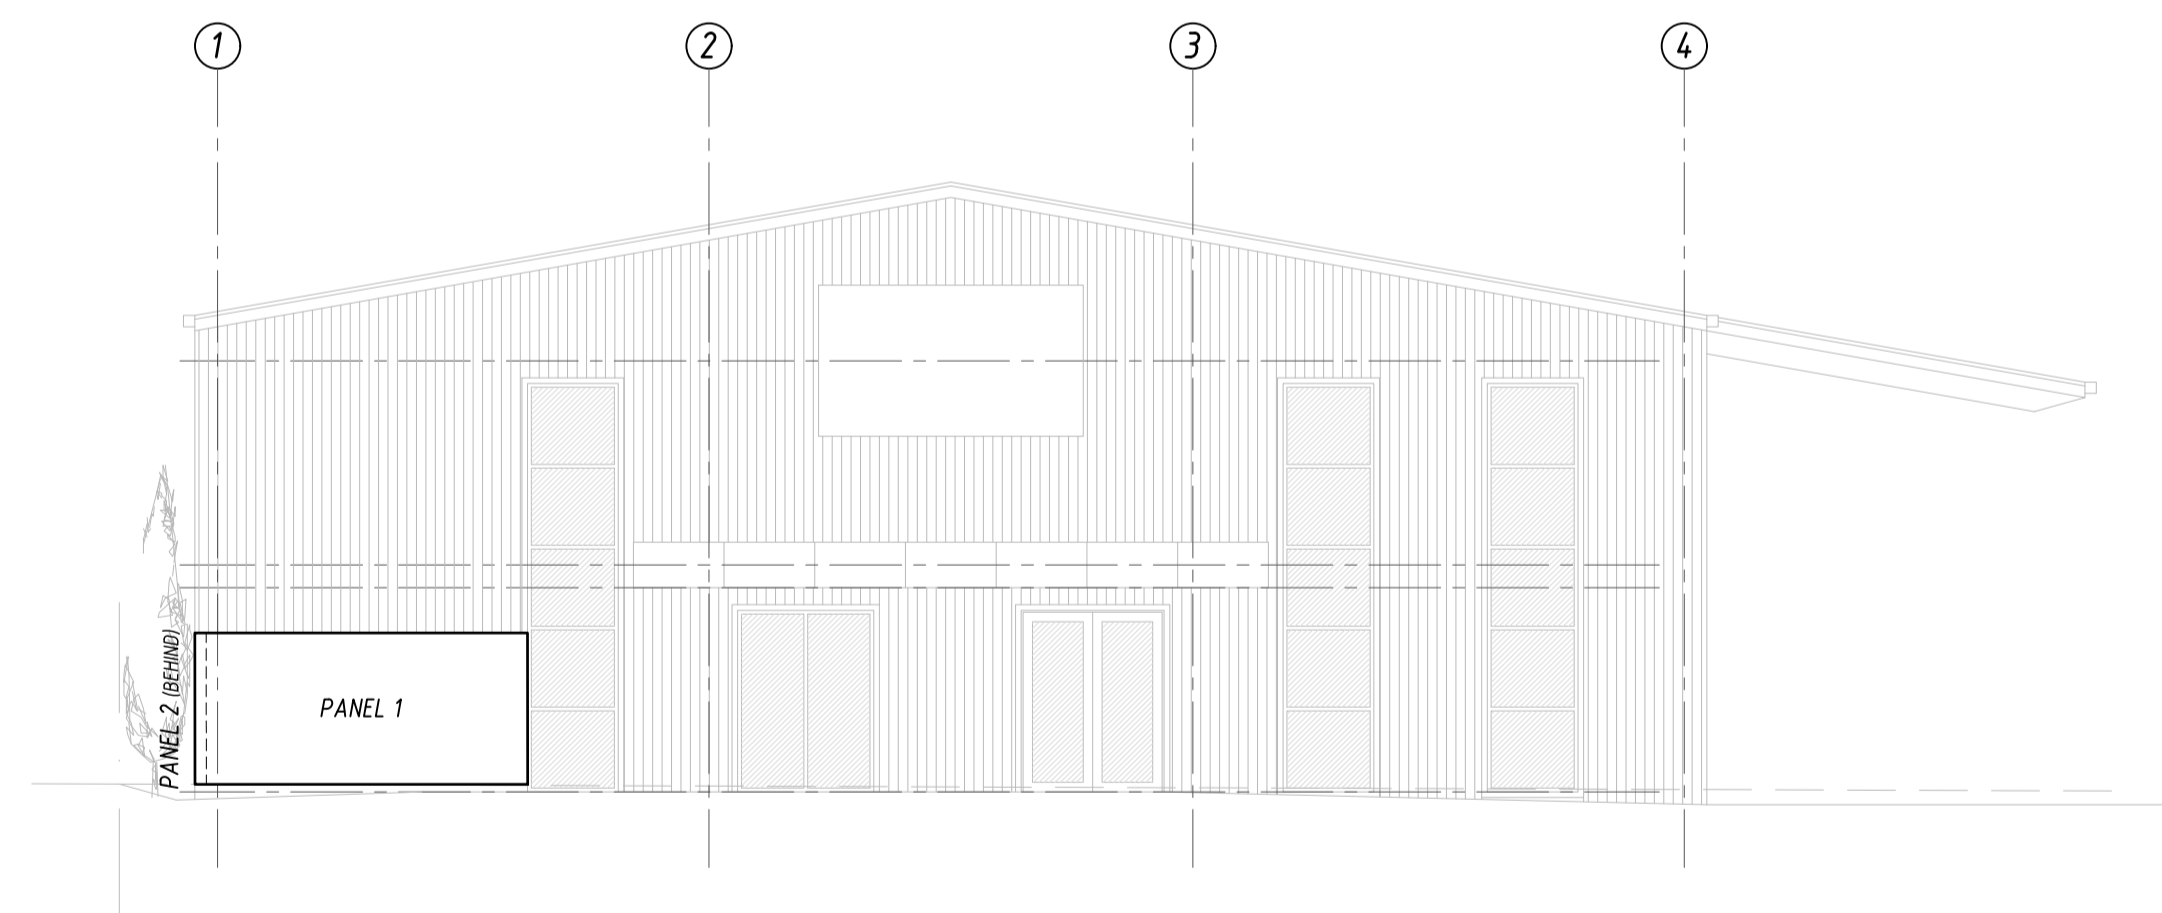


**SOUTH WESTERN ELEVATION**

SCALE 1:100

**FOR APPROVAL**

No	Revision Description	Drawn	Approved	Date
A	ISSUED FOR APPROVAL	JTB	-	17.05.21

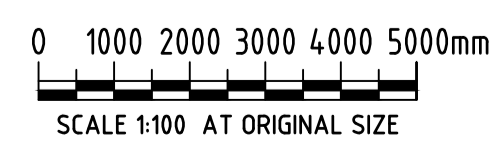


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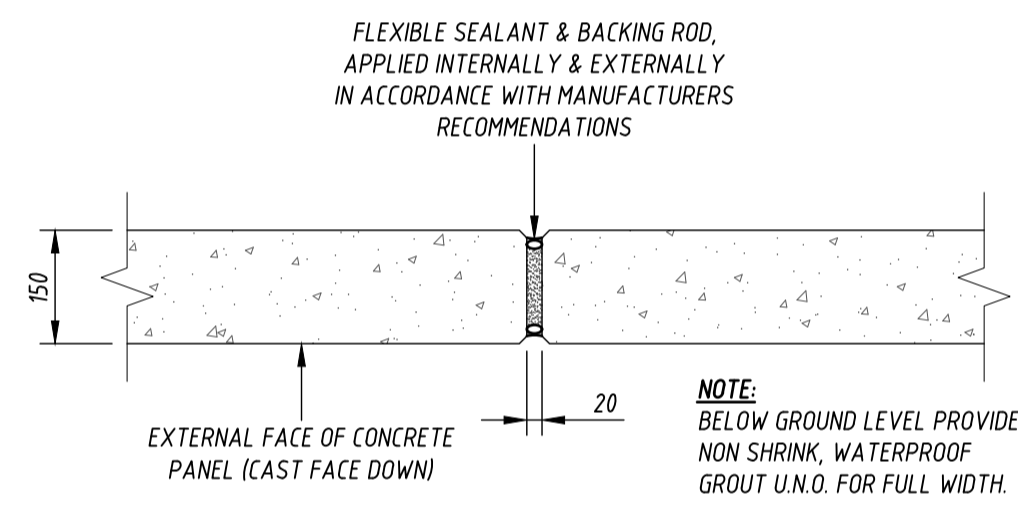
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Project	<b>PROPOSED WORKSHOP LOT 1 INDUSTRIAL AVENUE, MUDGEES</b>			Client	<b>HOT ENGINEERING</b>		
Title	<b>CONCRETE TILT PANEL ELEVATIONS</b>			Drawn	JTB	Designed	Approved
				Scale	AS SHOWN	Date	MAY '2021'
				Job No:	<b>37880</b>	Drawing No:	<b>S.41</b>
				Rev:	<b>A</b>	Original Size	<b>A1</b>




**TYPICAL REINFORCEMENT**  
**150mm THICK DADO PANELS**  
 SCALE N.T.S.


**NOTES:**  
 REINFORCED CONCRETE PANELS HAVE NOT BEEN DESIGNED TO INCLUDE CONSTRUCTION LOADS.  
 PANEL CONTRACTOR TO PROVIDE ADDITIONAL REINFORCEMENT/STRONGBACKS AS REQUIRED FOR CONSTRUCTION LOADS.

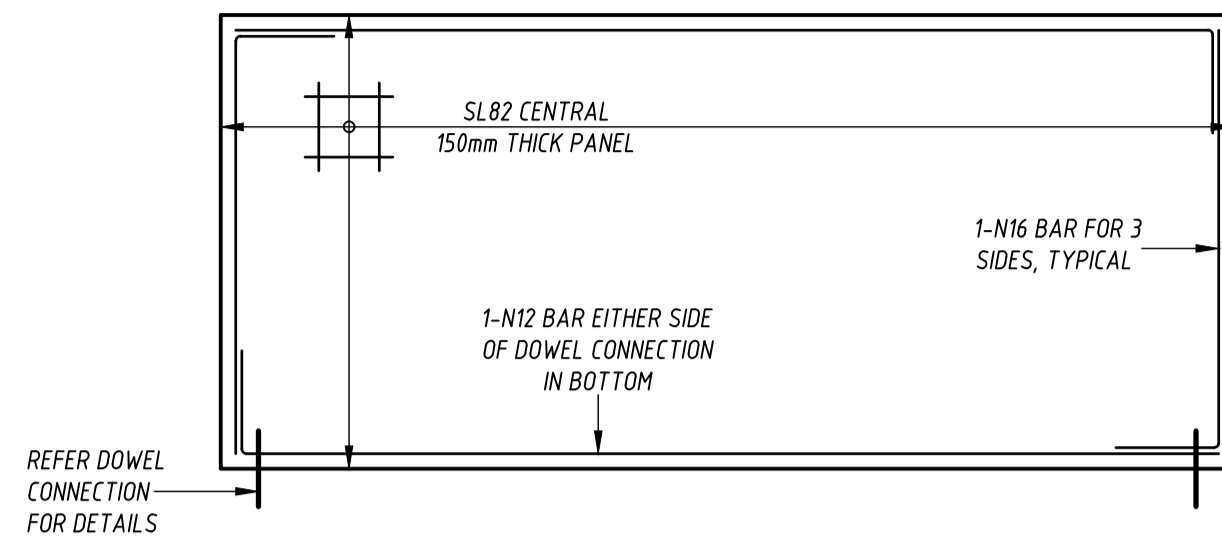


**TYPICAL FIRE RATED JOINT WALL JOINT**  
 SCALE 1:10

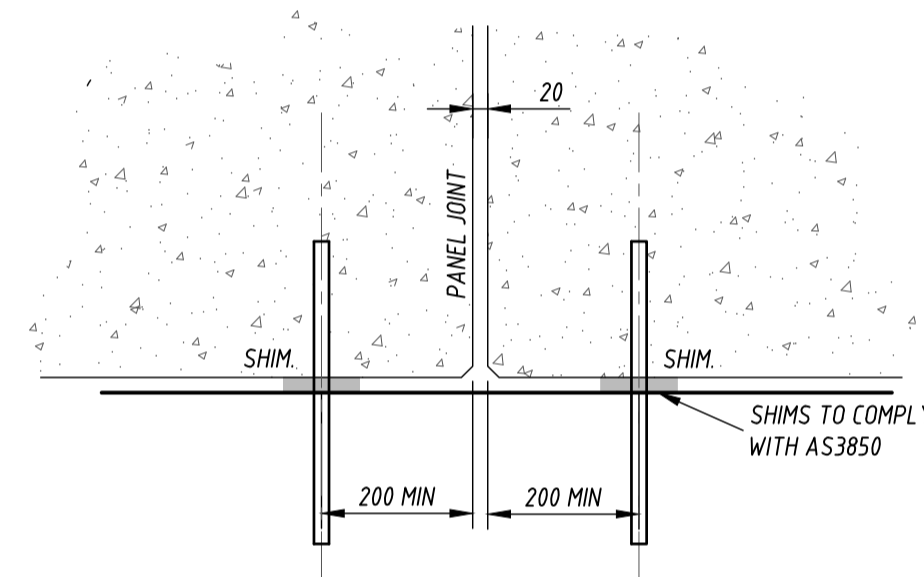


**TYPICAL PANEL BEARING**  
**DETAIL ON FOOTING**  
 SCALE 1:10

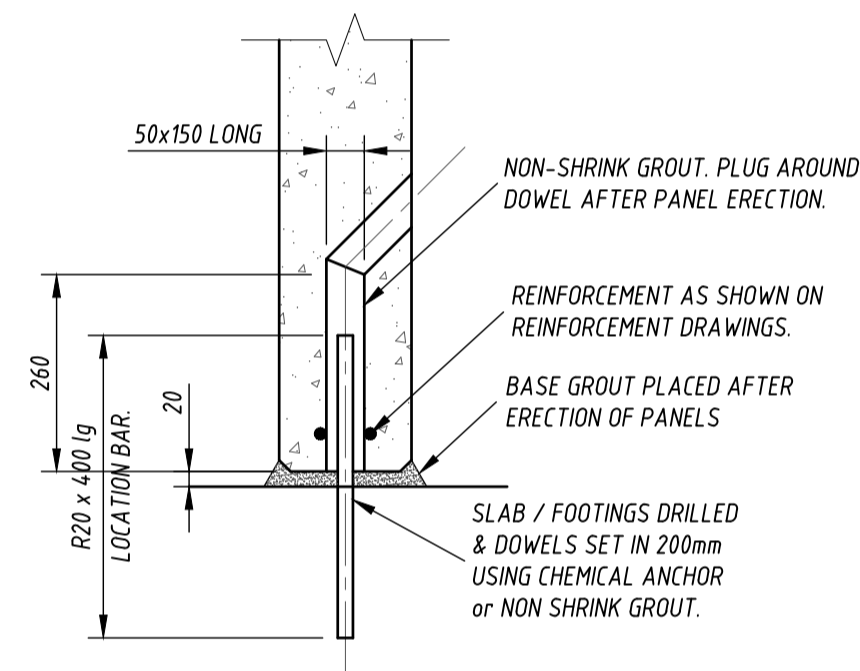

**TYPICAL DOWEL CONNECTION**  
 SCALE 1:10

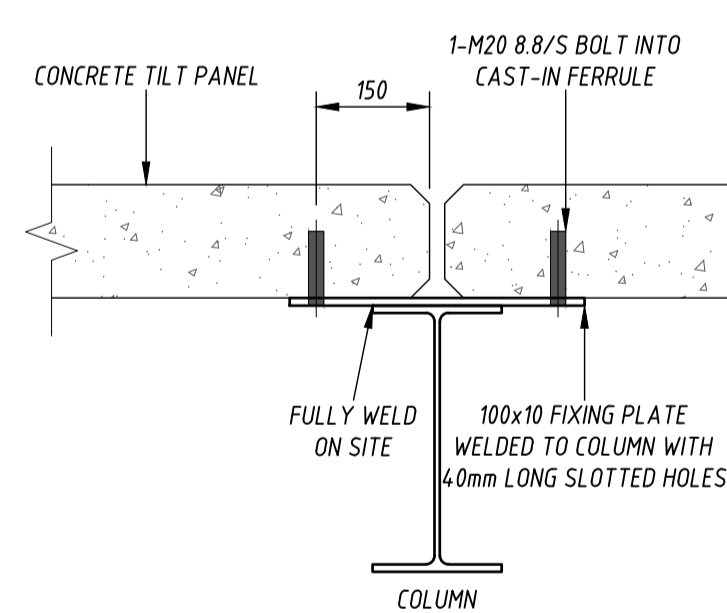


**TYPICAL INTERNAL COLUMN DETAIL**

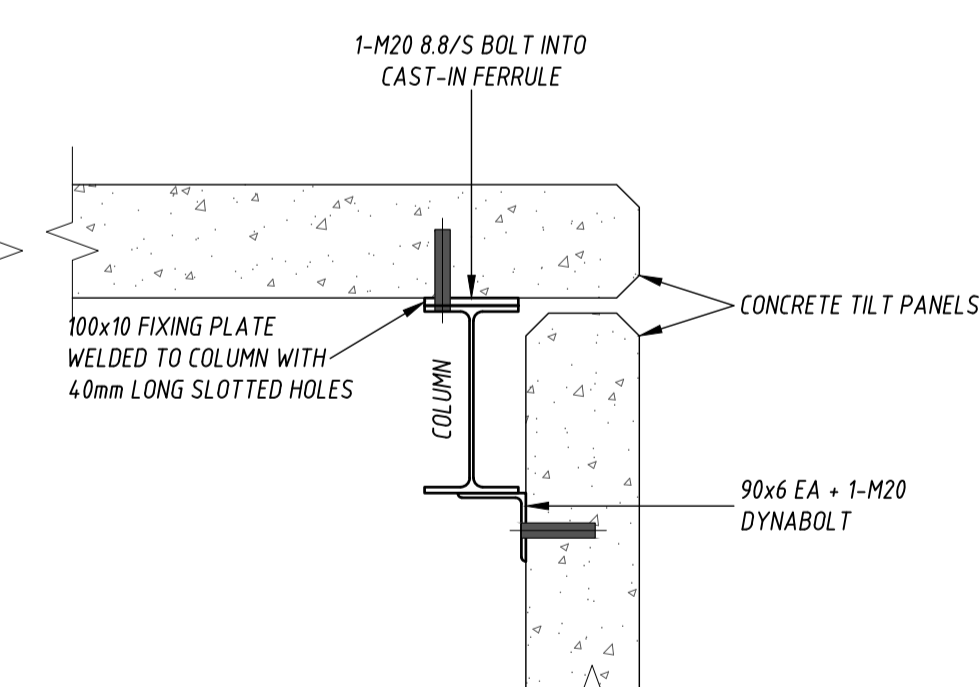


**TYPICAL CORNER COLUMN DETAIL**

**TYPICAL PANEL CLIP DETAILS**  
 SCALE 1:10  
 (PROVIDE 2 CLIPS MINIMUM TO EACH END OF PANEL)

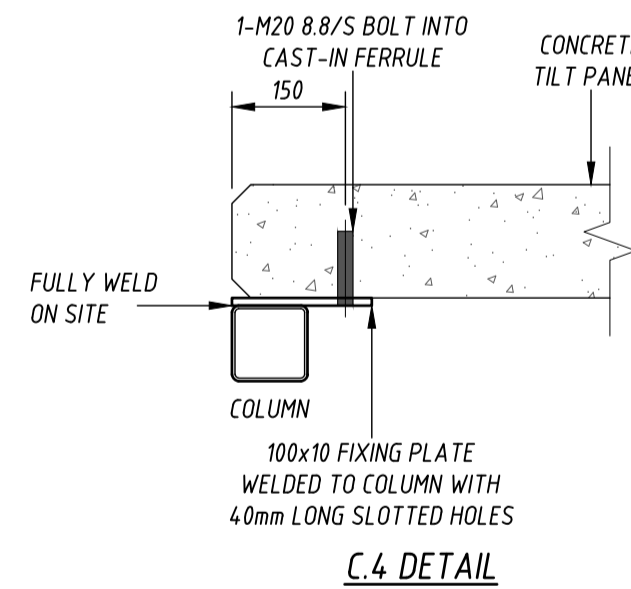


**C.4 DETAIL**

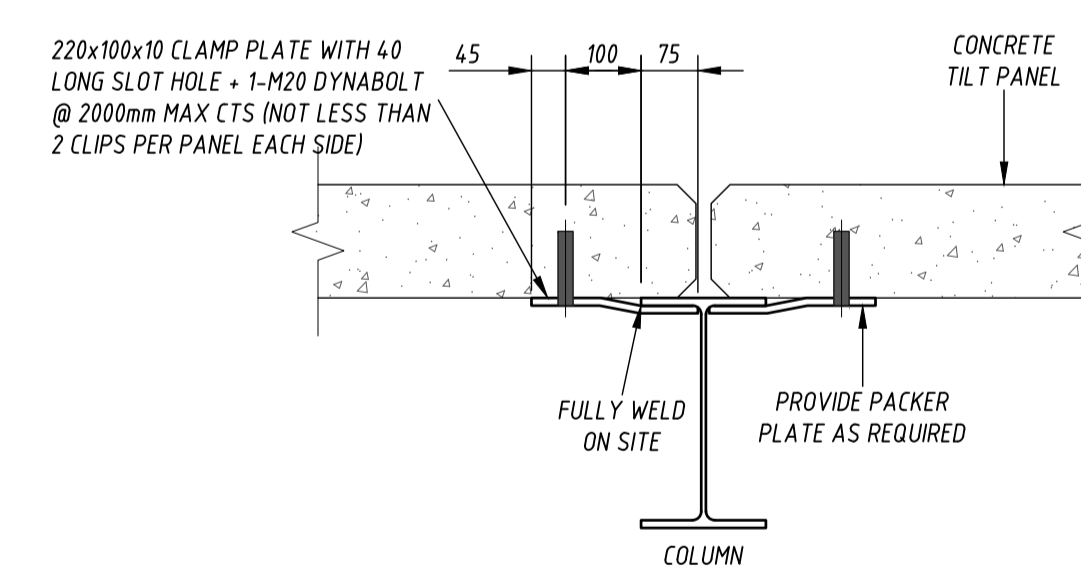

**ALTERNATIVE PANEL CLIP DETAIL**  
 SCALE 1:10

**FOR APPROVAL**

No	Revision Description	Drawn	Approved	Date
A	ISSUED FOR APPROVAL	JTB	-	17.05.21

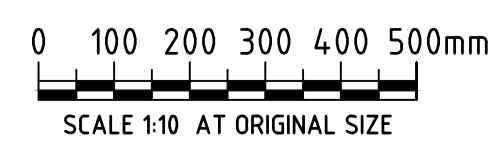

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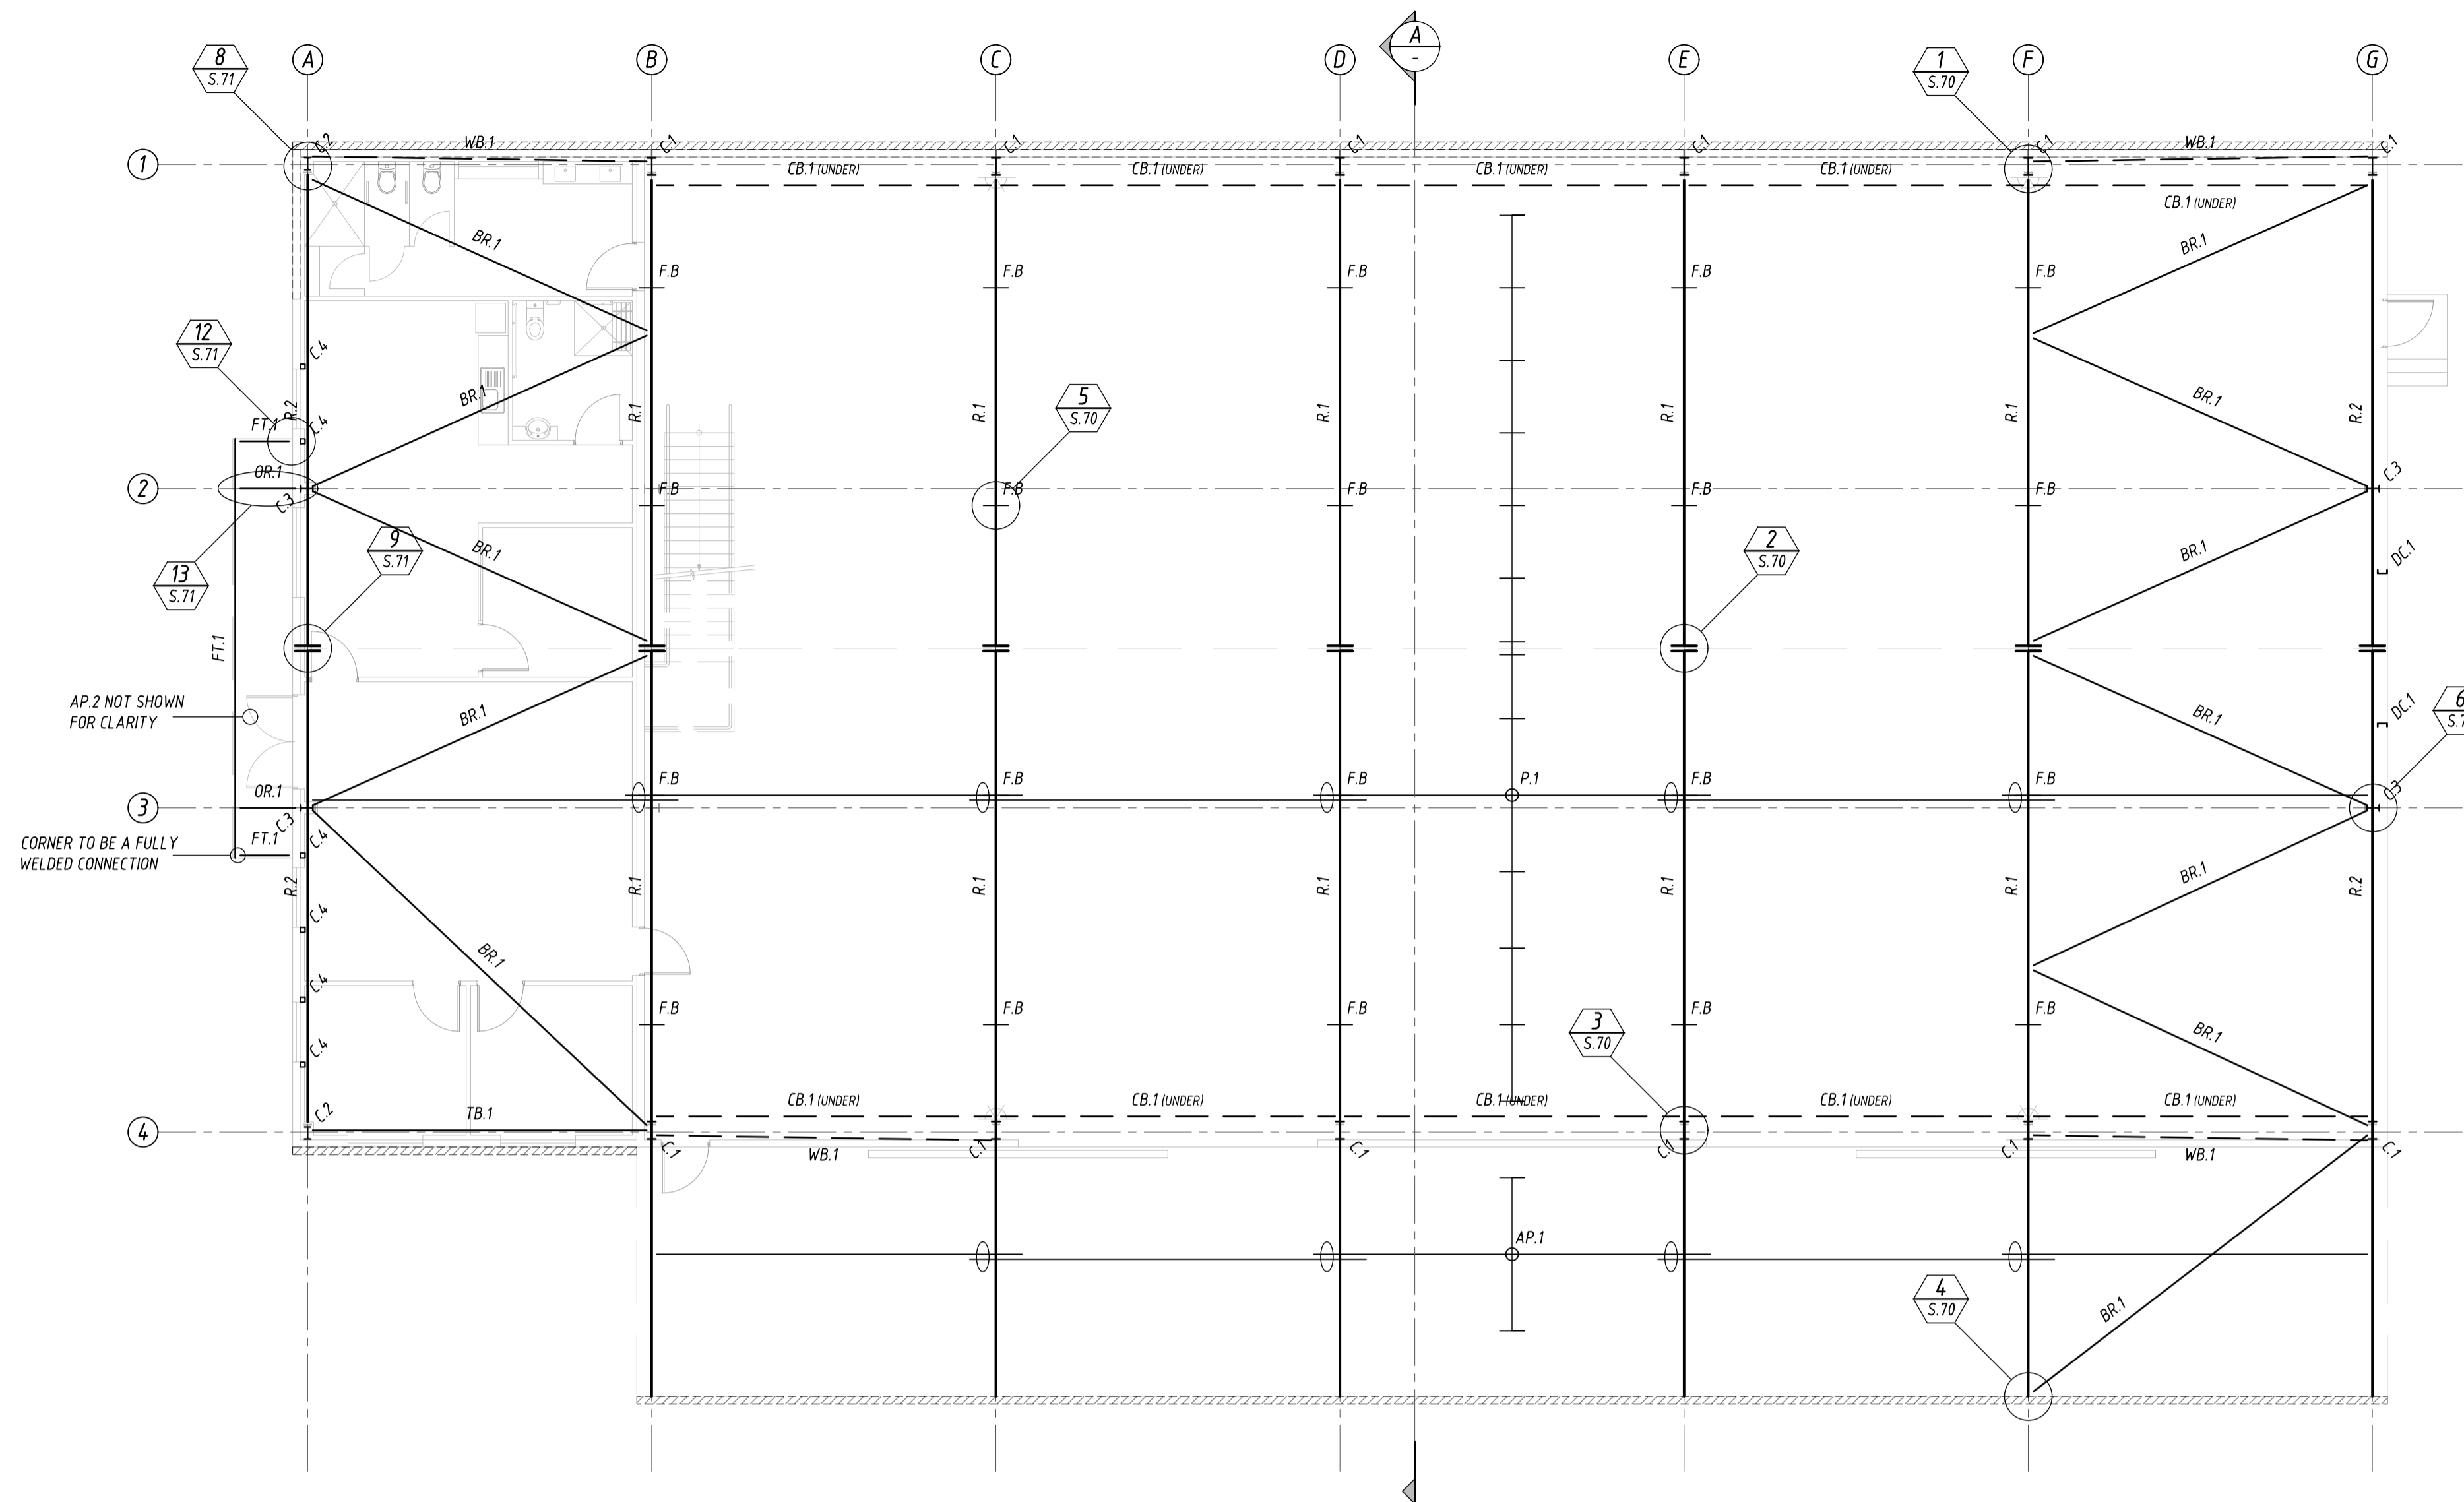
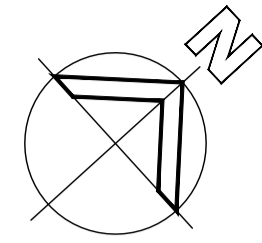
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Project  
**PROPOSED WORKSHOP**  
**LOT 1 INDUSTRIAL AVENUE, MUDGEE**  
 Title  
**CONCRETE TILT PANEL DETAILS**

Client **HOT ENGINEERING**

Drawn	JTB	Designed	Approved
Scale	AS SHOWN	Date	MAY '2021'

Job No: **37880** Drawing No: **S.50** Rev: **A** Original Size: **A1**




### STEEL WORK MARKING PLAN

SCALE 1:100

STEEL WORK MEMBER SCHEDULE		
MARK	SIZE	REMARKS
AP.1	Z200 15 @ 1700mm MAX CTS + 1 ROW OF BRIDGING	AWNING PURLIN
AP.2	C150 15 + 1 ROW OF BRIDGING	-
BR.1	125x4 SHS	BRACING
C.1	360UB50 + 1 FLY BRACE	-
C.2	250UB25	-
C.3	250UB25 + 1 FLY BRACE	-
C.4	100x4 SHS	-
CB.1	410UB60 + 250 PFC	CRANE BEAM
DC.1	200 PFC	DOOR COLUMN
DH.1	250 PFC	DOOR HEADER
DH.2	200 PFC	-
FT.1	600 O/A TRUSS WITH 50x2.5 SHS CHORDS & WEBBING	FASCIA TRUSS CHORDS & WEBBING
G.1	Z200 15 @ 1500mm MAX CTS + 1 ROW OF BRIDGING	GIRT
OR.1	150x100x4 RHS	OUTRIGGER
P.1	Z200 15 @ 1700mm MAX CTS + 1 ROW OF BRIDGING	PURLIN
R.1	360UB44	RAFTER
R.2	250UB25	-
TB.1	100x4 SHS OR 125x4 SHS	TIE BEAM
WB.1	125x4 SHS	WALL BRACING

F.B. - DENOTES FLY BRACING, REFER TO DETAIL.  
 NOTE: DESIGN ASSUMES 0.42mm B.M.T. TRIMDEK ROOF SHEETING U.N.O.  
 NOTE: DESIGN ASSUMES SLIDING DOORS WILL MATCH BAY SPACINGS.  
 DENOTES GUTTER

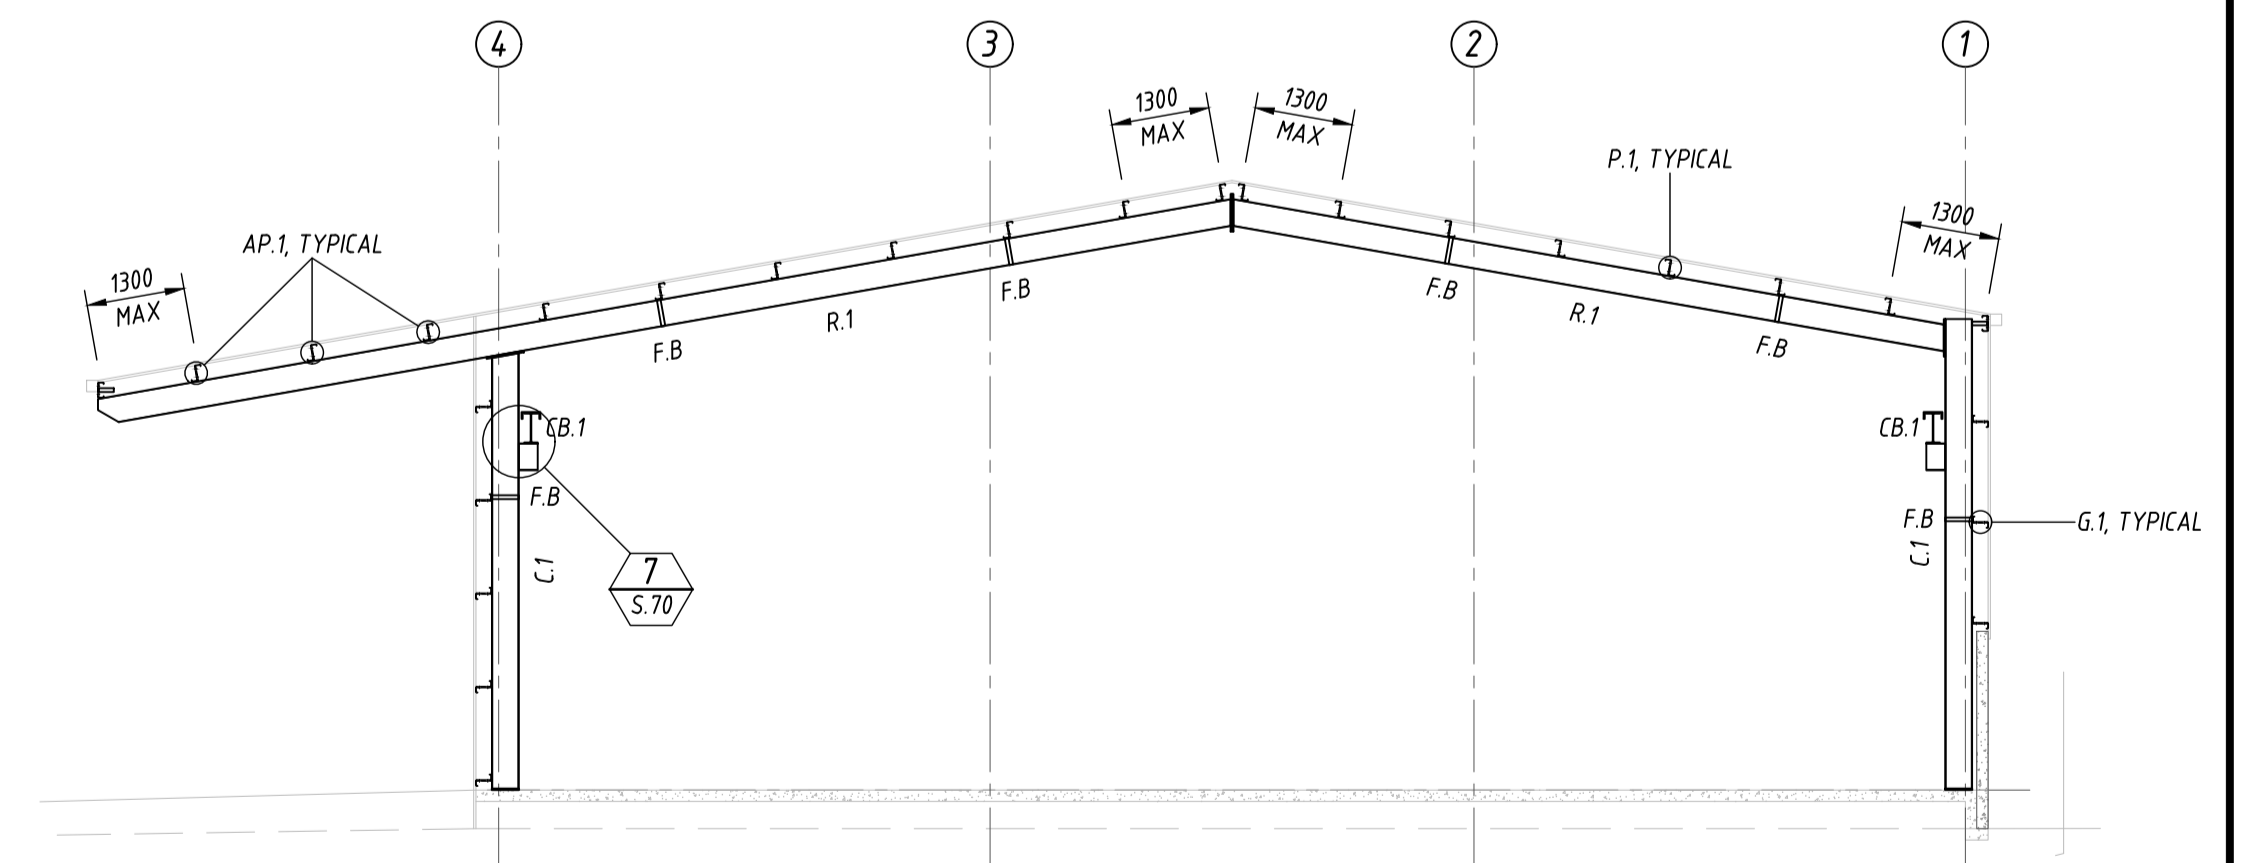


SECTION **A**  
SCALE 1:100

F.B. - DENOTES FLY BRACING, REFER TO DETAIL.

**FOR APPROVAL**

No	Revision Description	Drawn	Approved	Date
A	ISSUED FOR APPROVAL	JTB	-	17.05.21

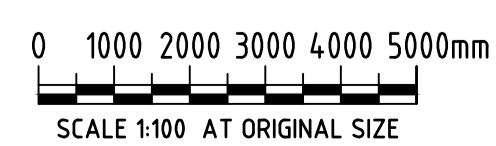


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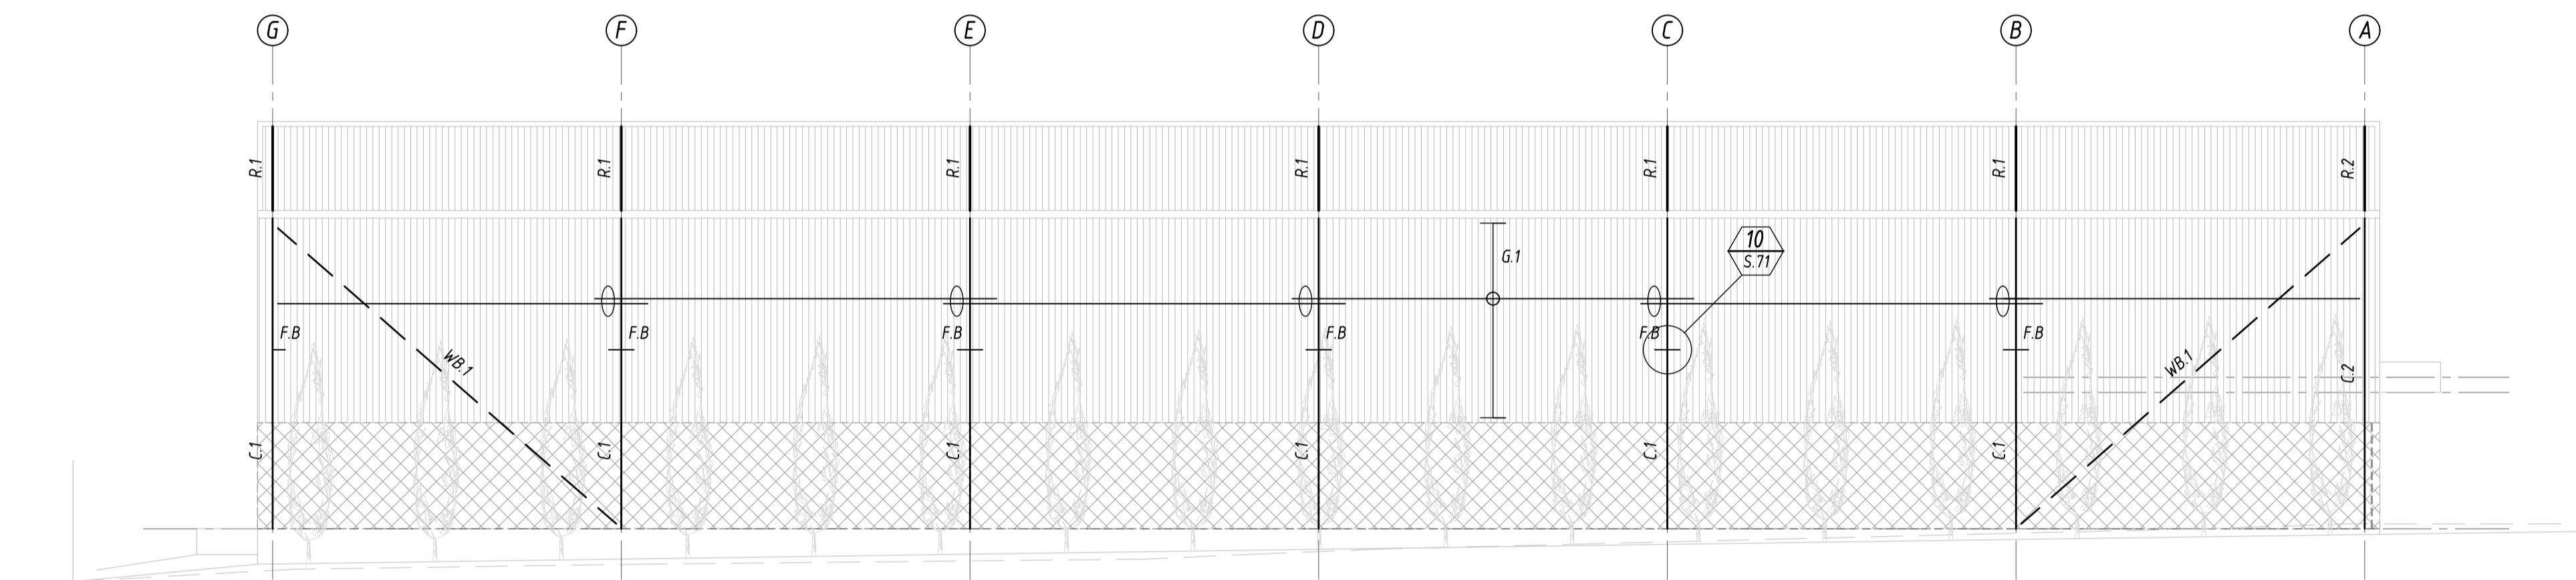
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Project	<b>PROPOSED WORKSHOP LOT 1 INDUSTRIAL AVENUE, MUDGEES</b>			Client	<b>HOT ENGINEERING</b>		
Title	<b>STEELWORK MARKING PLAN</b>			Drawn	JTB	Designed	Approved
				Scale	AS SHOWN	Date	MAY '2021'
				Job No:	<b>37880</b>	Drawing No:	<b>S.60</b>
				Rev:	<b>A</b>	Original Size	<b>A1</b>



**SOUTH EASTERN ELEVATION**


SCALE 1:100

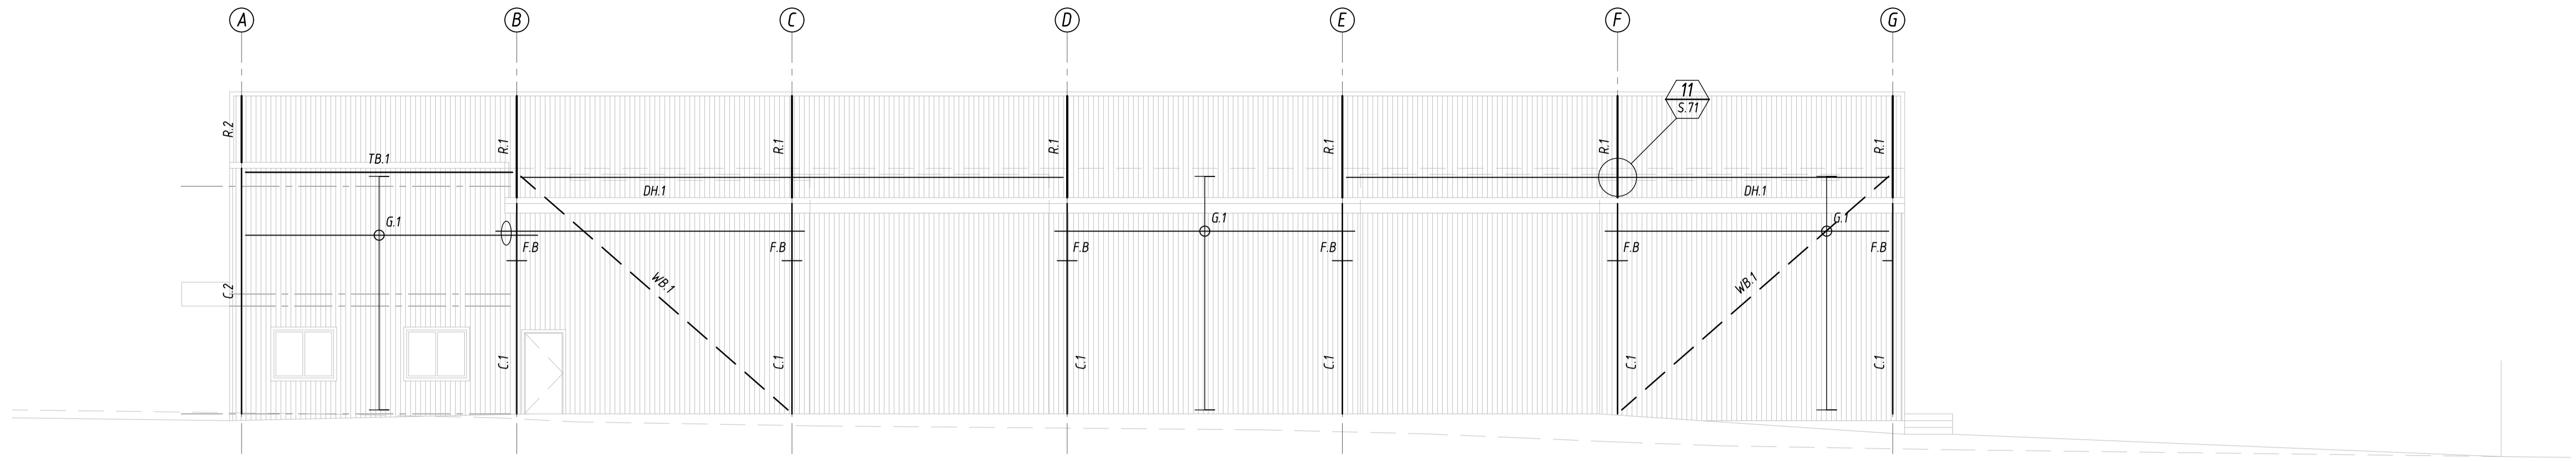

**NORTH WESTERN ELEVATION**

SCALE 1:100

☒ DENOTES CONCRETE TILT PANEL

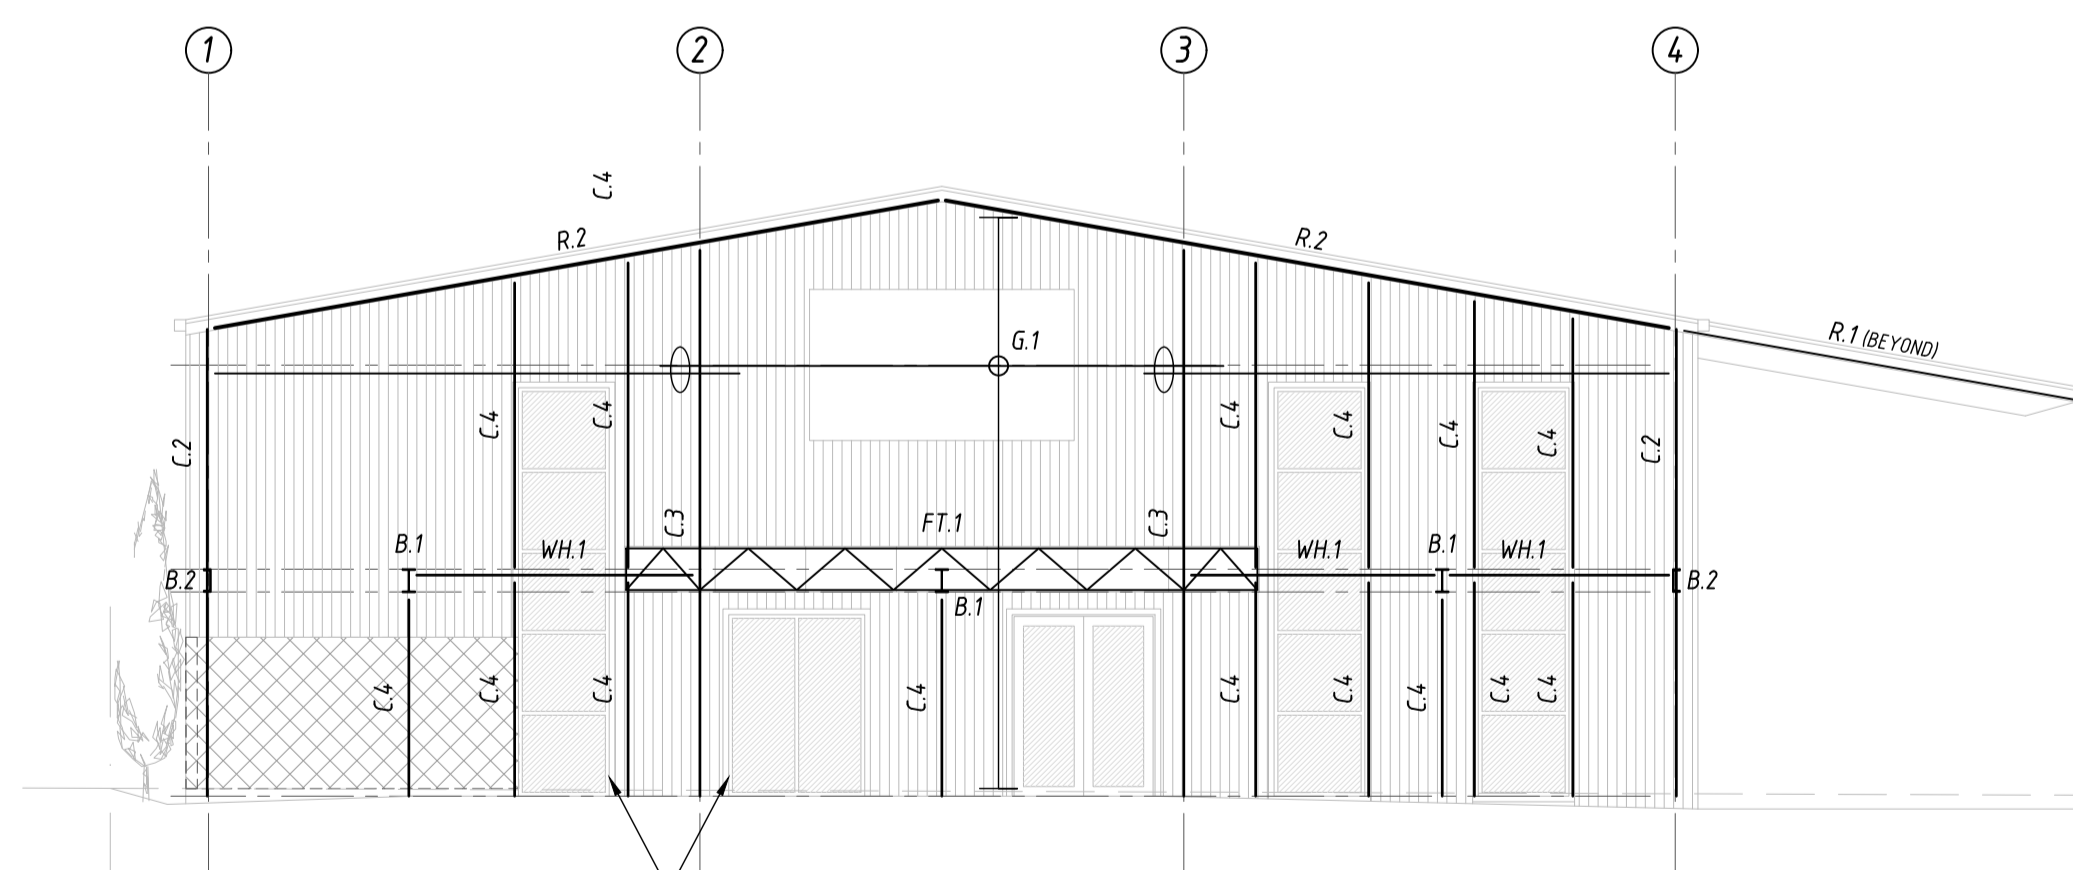


PROVIDE C200 IS TRIMMER GIRTS ADJACENT TO DOORS & FIX TO G.1 ABOVE DOOR WITH LYSAGHT GP BRACKETS OR APPROVED EQUIVALENT, TYPICAL AROUND WINDOWS & PA DOORS U.N.O.

**NORTH EASTERN ELEVATION**

SCALE 1:100

☒ DENOTES CONCRETE TILT PANEL

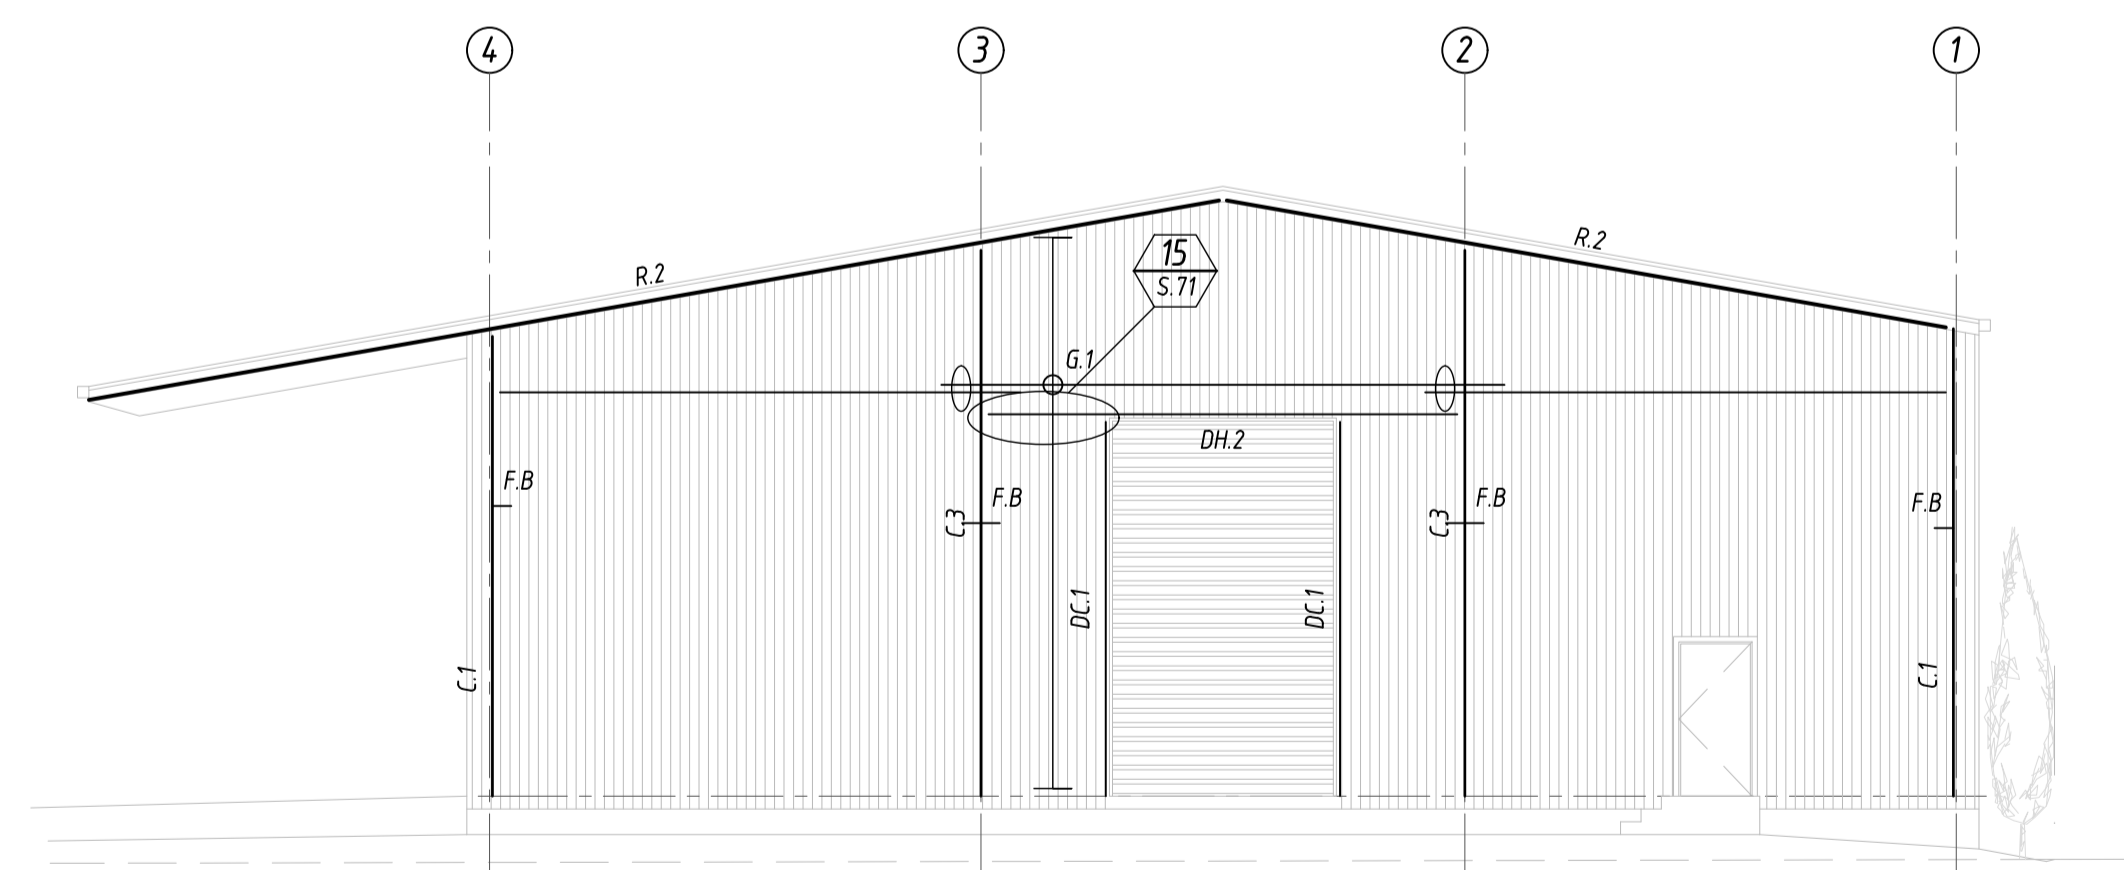


**NORTH EASTERN ELEVATION**

SCALE 1:100

**FOR APPROVAL**

No	Revision Description	Drawn	Approved	Date
A	ISSUED FOR APPROVAL	JTB	-	17.05.21

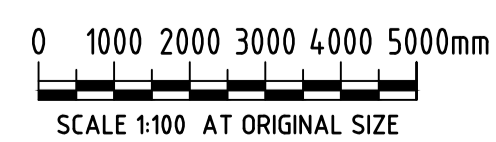


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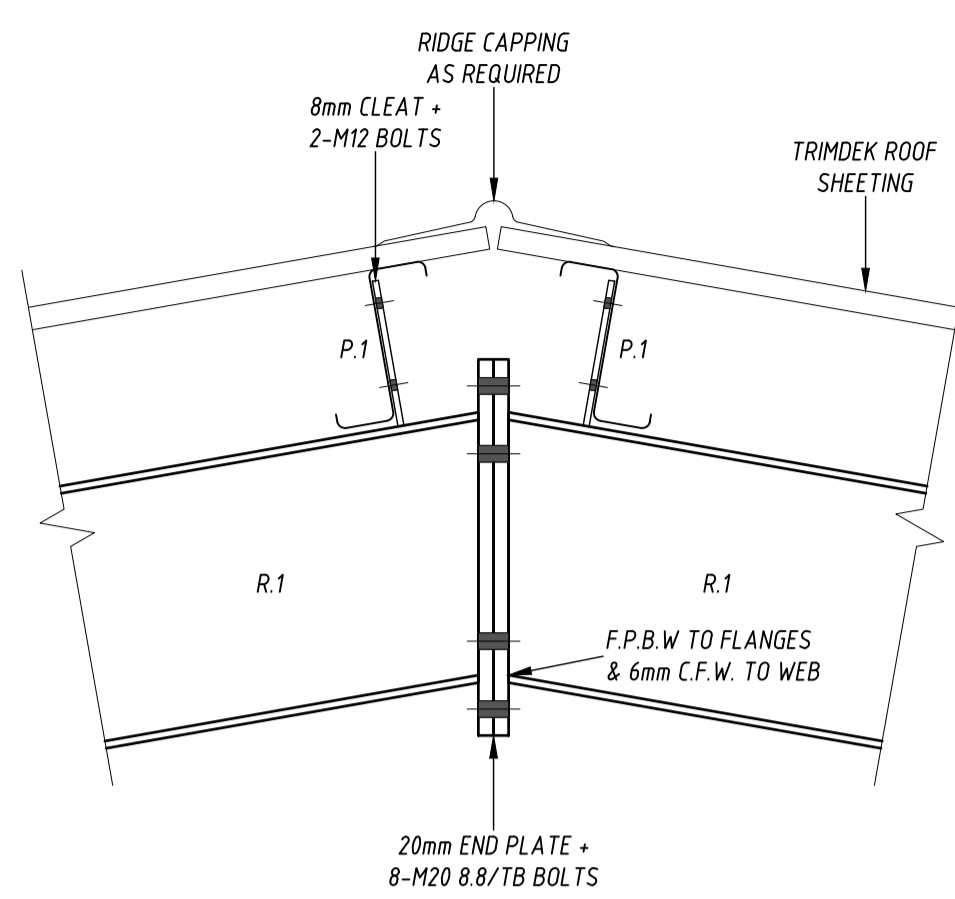
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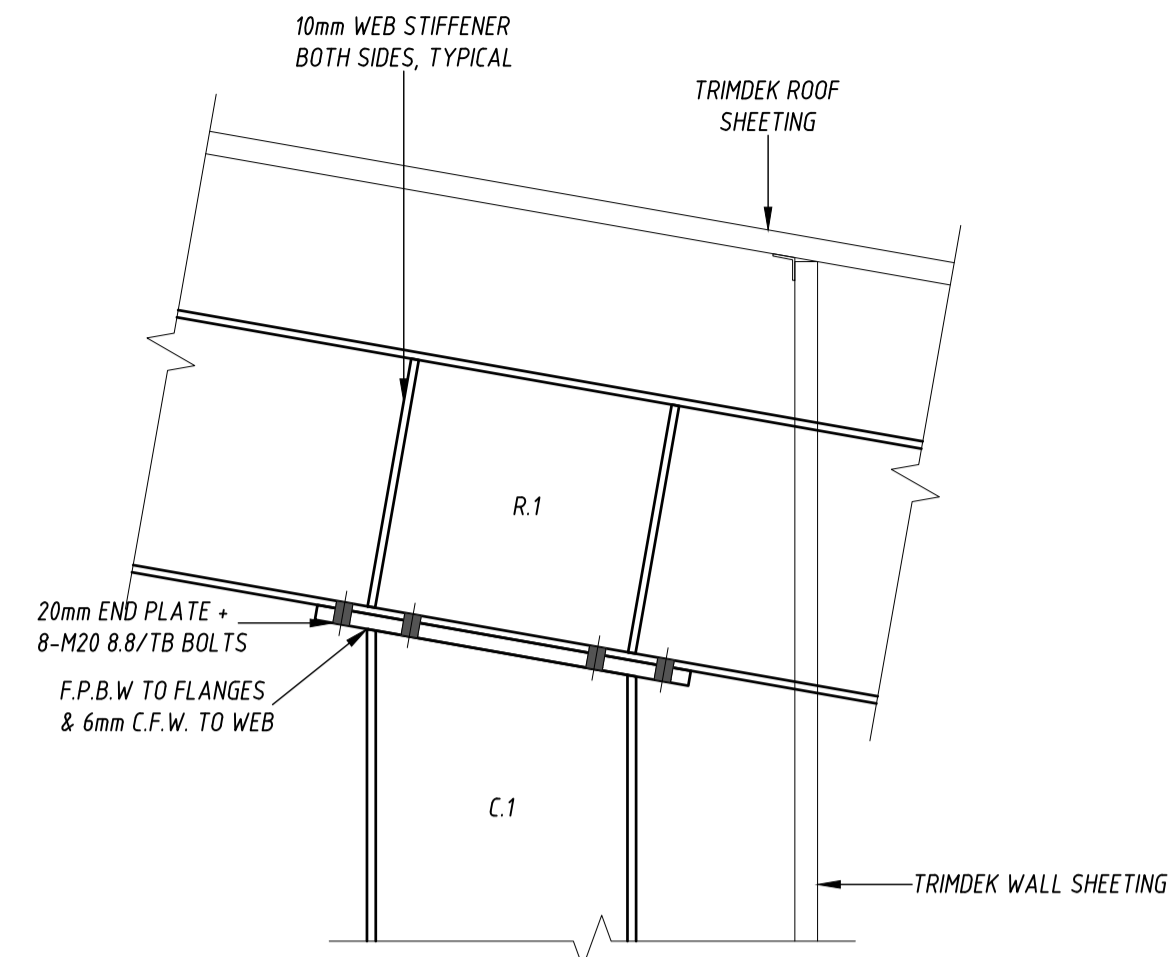
Project	<b>PROPOSED WORKSHOP LOT 1 INDUSTRIAL AVENUE, MUDGEE</b>			Client	<b>HOT ENGINEERING</b>		
Title	<b>STEELWORK ELEVATIONS</b>			Drawn	JTB	Designed	Approved
				Scale	AS SHOWN	Date	MAY '2021'
				Job No:	<b>37880</b>	Drawing No:	<b>S.61</b>
				Rev:	<b>A</b>	Original Size	<b>A1</b>




DETAIL 1  
SCALE 1:10 S.60

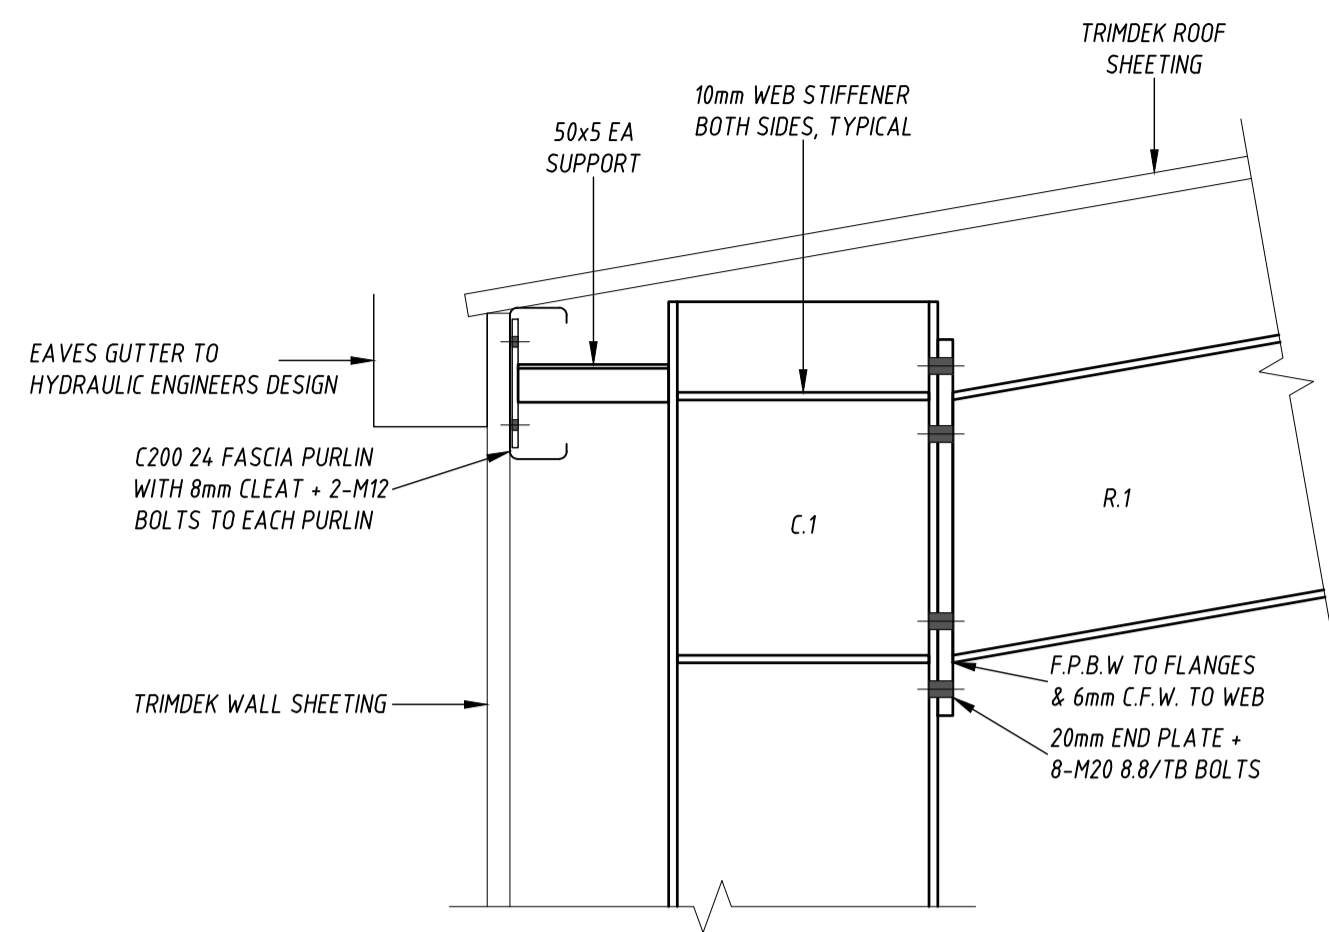


DETAIL 2  
SCALE 1:10 S.60




DETAIL 3  
SCALE 1:10 S.60

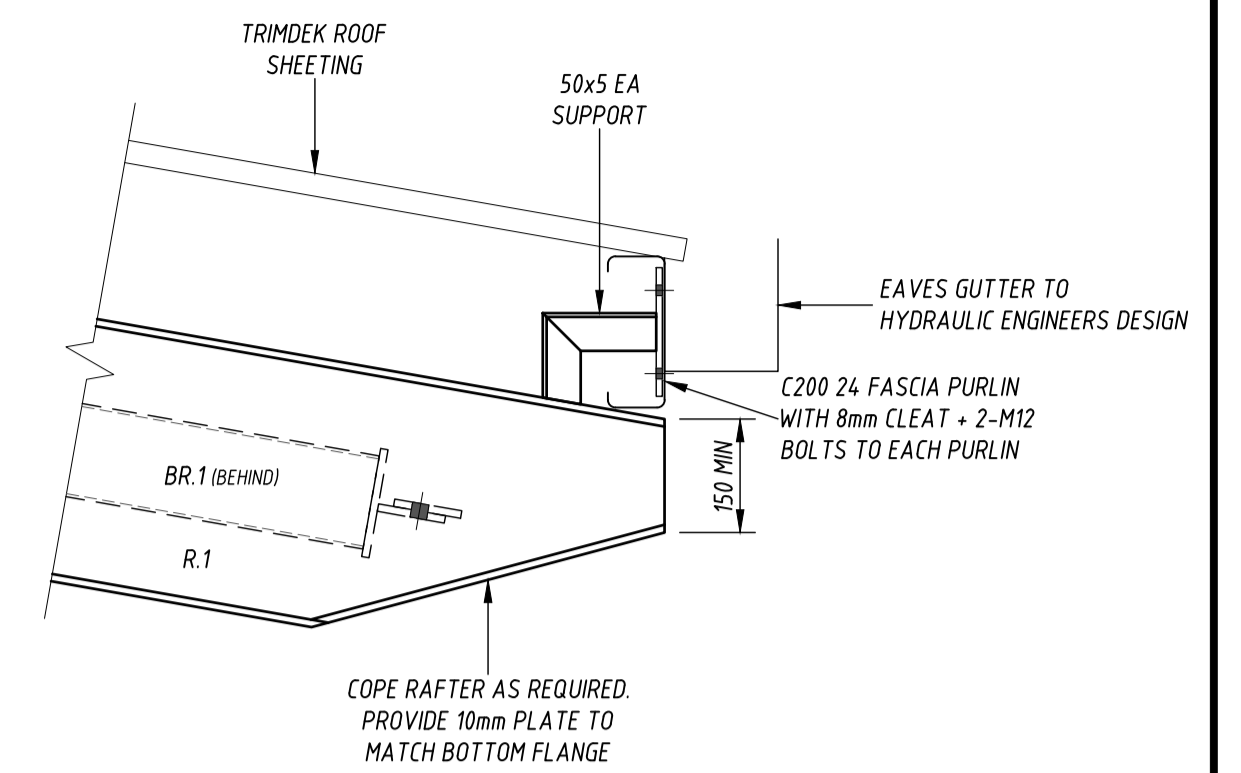


DETAIL 4  
SCALE 1:10 S.60

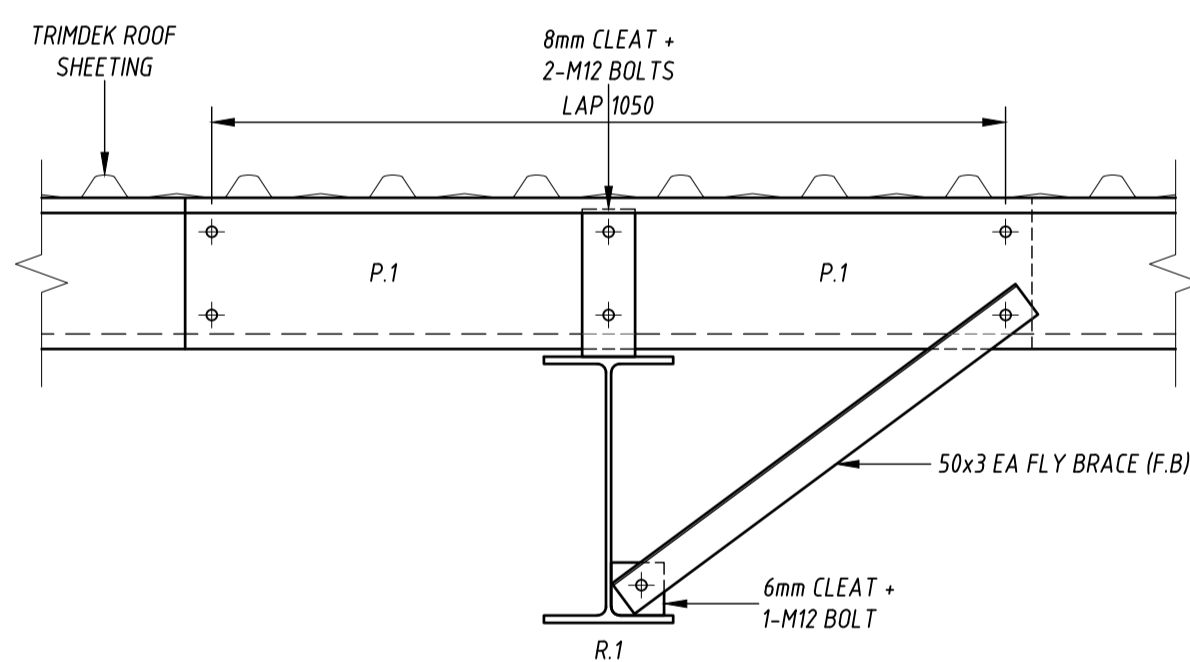

DETAIL 5  
SCALE 1:10 S.60

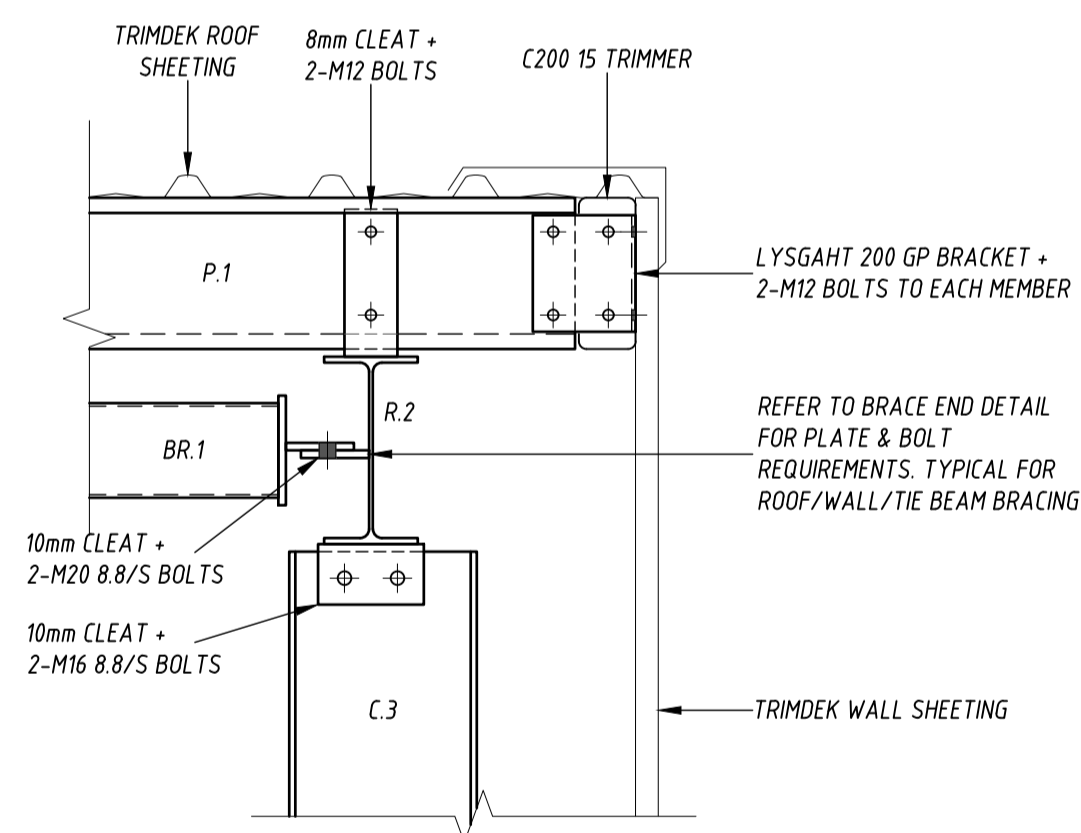


DETAIL 6  
SCALE 1:10 S.60

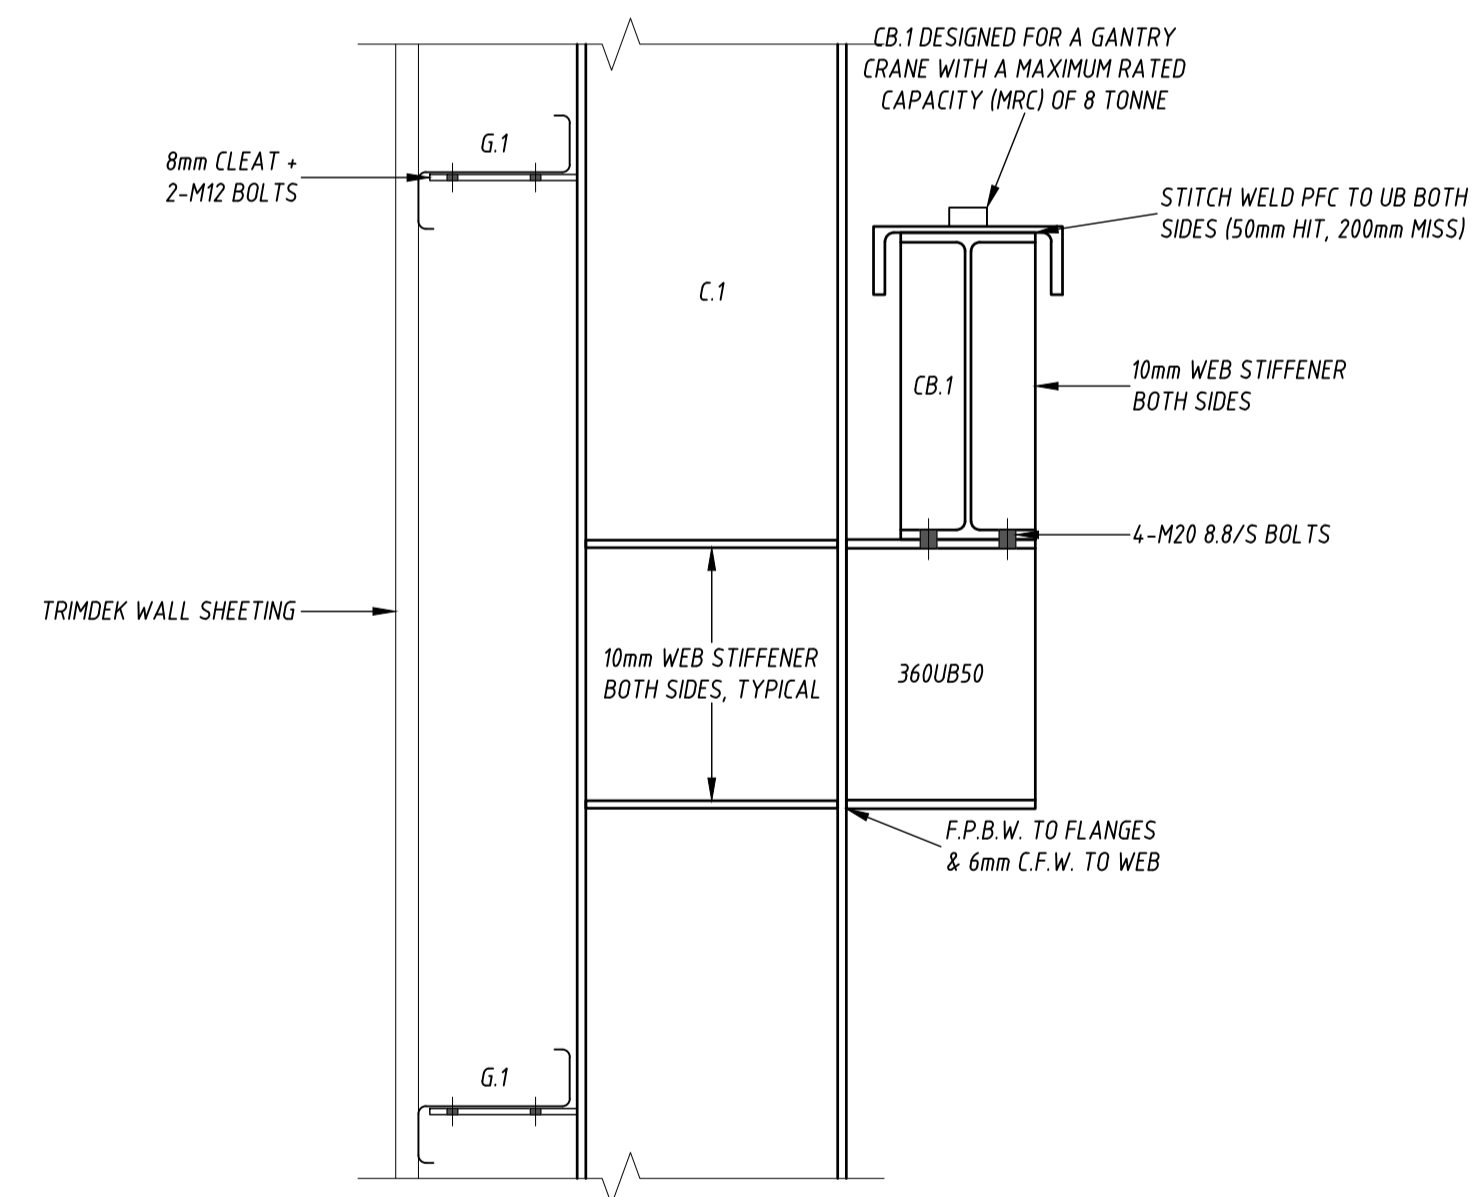

DETAIL 7  
SCALE 1:10 S.60

NOTE: DETAILS SHOW DESIGN INTENT. BUILDER/WORKSHOP DETAILER TO ACCURATELY DETERMINE POSITION OF FRAMING AND CONTACT COOK&ROE IF ANYTHING DIFFERS FROM THE DETAILS SHOWN

No	Revision Description	Drawn	Approved	Date
A	ISSUED FOR APPROVAL	JTB	-	17.05.21

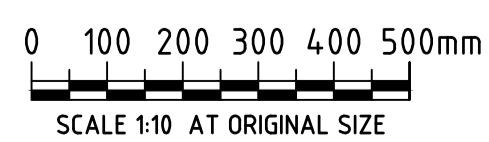

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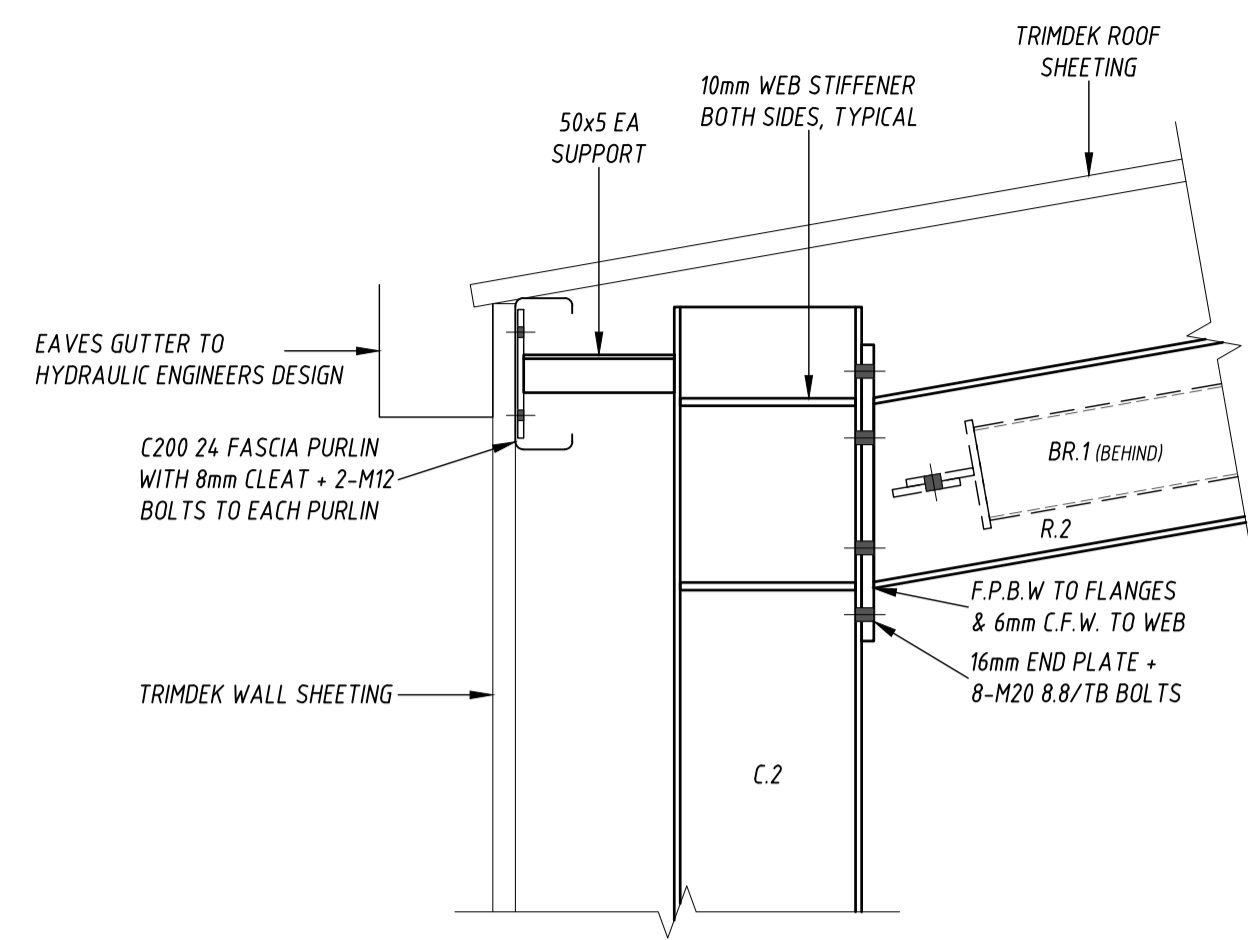
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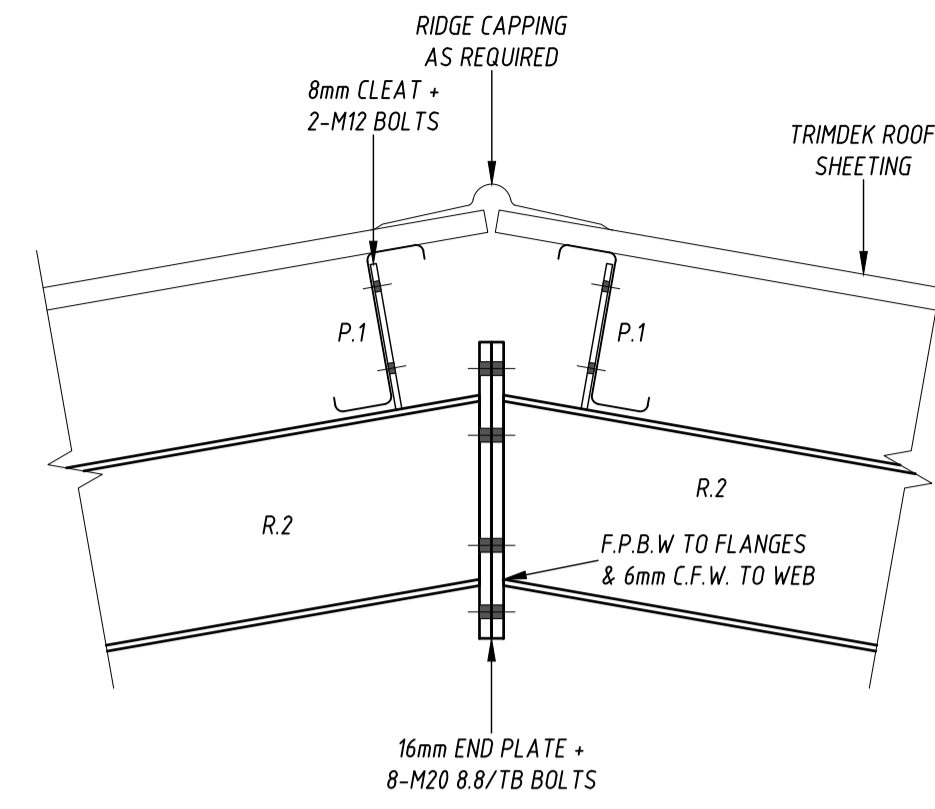
Project  
**PROPOSED WORKSHOP  
LOT 1 INDUSTRIAL AVENUE, MUDGEES**  
Title  
**STEELWORK DETAILS '1'**

Client  
**HOT ENGINEERING**  
Drawn JTB Designed [Signature] Approved -  
Scale AS SHOWN Date MAY '2021'  
Job No: **37880** Drawing No: **S.70** Rev: **A** Original Size **A1**


FOR APPROVAL




DETAIL 8  
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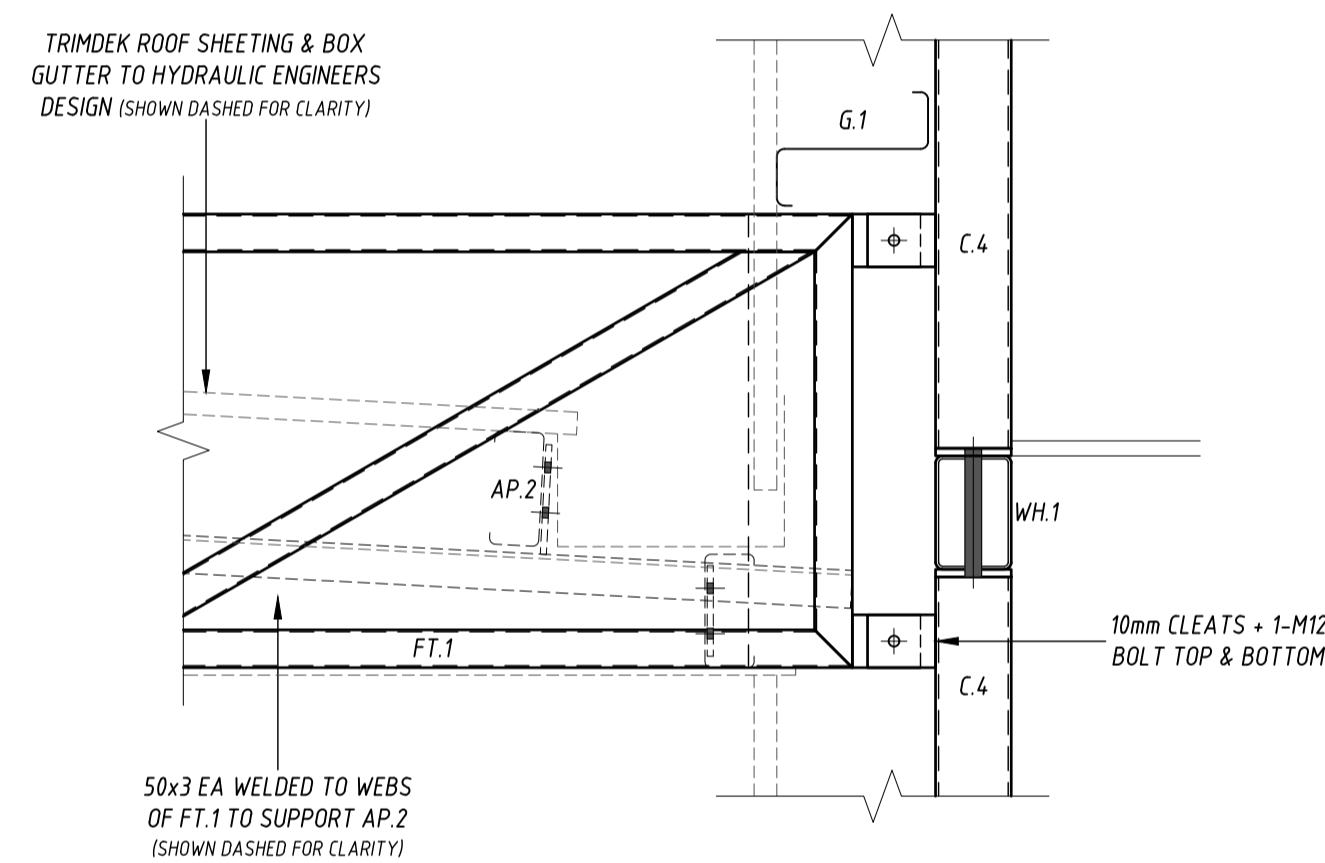
DETAIL 9  
SCALE 1:10 S.60




DETAIL 10  
SCALE 1:10 S.61

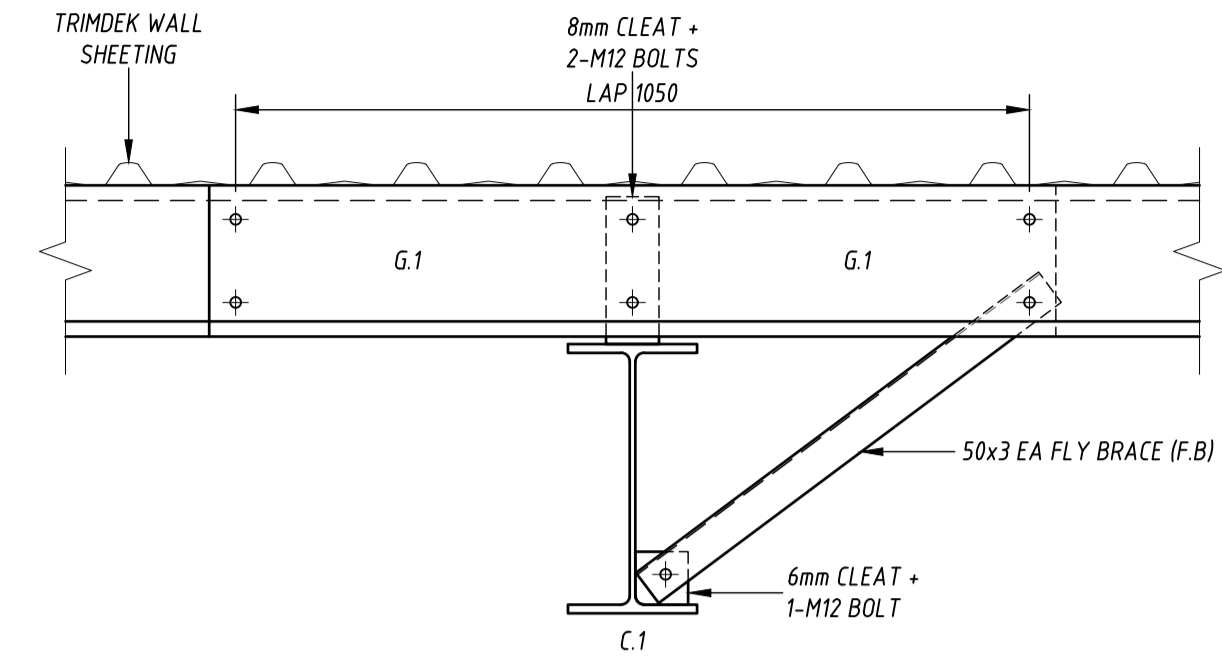


DETAIL 11  
SCALE 1:10 S.61

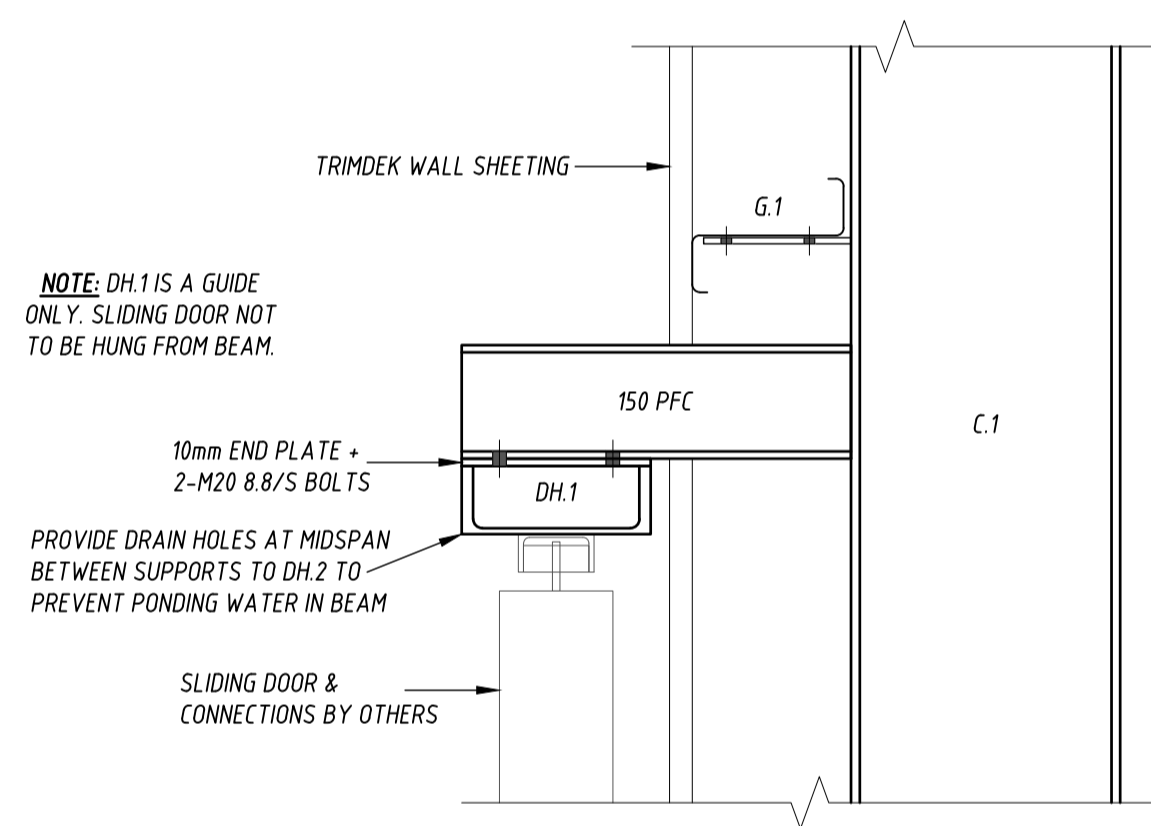


DETAIL 12  
SCALE 1:10 S.60

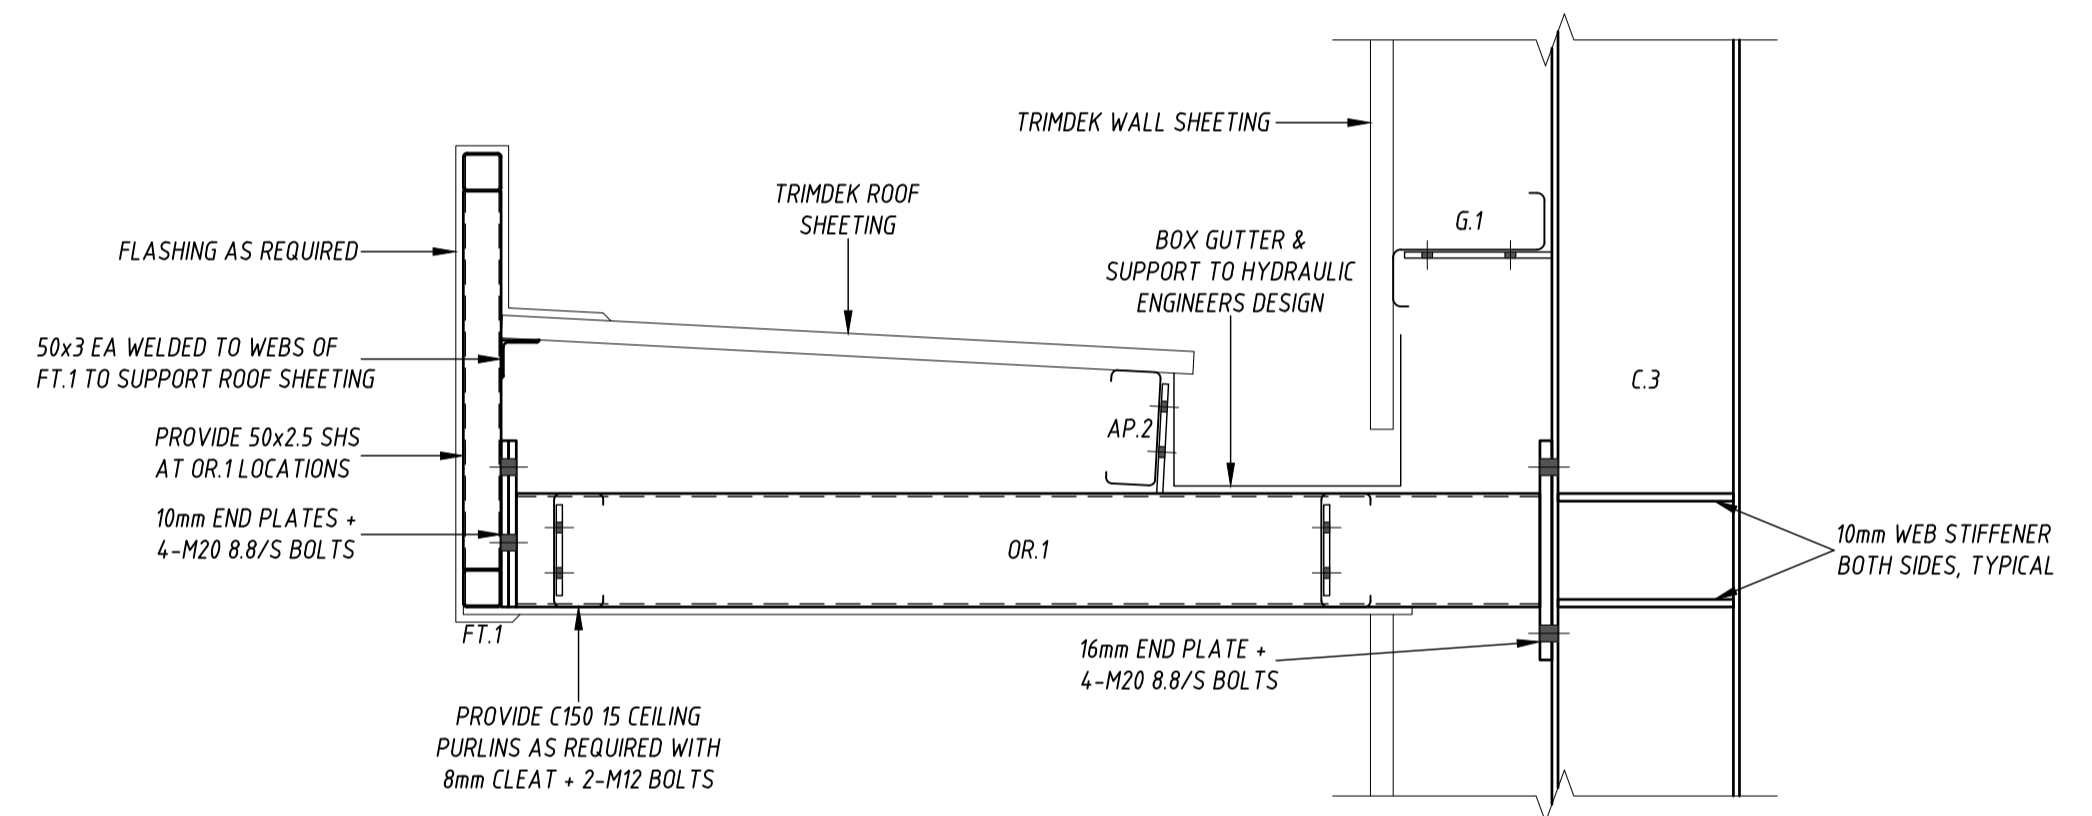

DETAIL 13  
SCALE 1:10 S.60

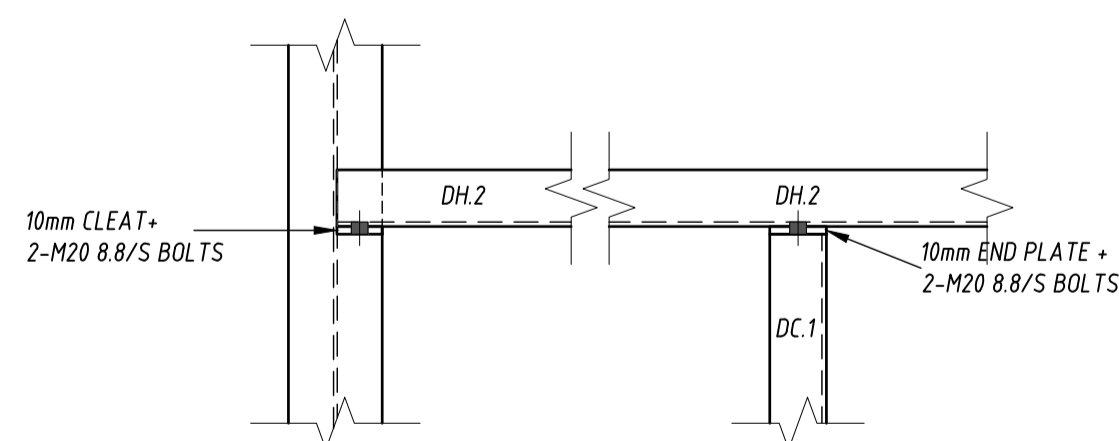



DETAIL 15  
SCALE 1:10 S.61

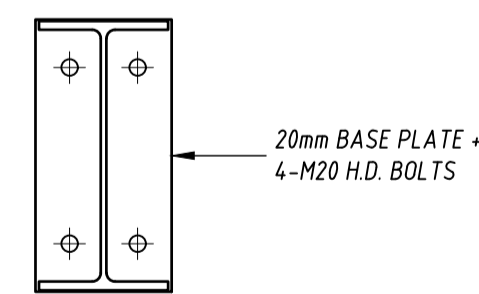

C.1 DETAIL  
TYPICAL BASE PLATE DETAILS  
SCALE 1:10



C.2/3 DETAIL

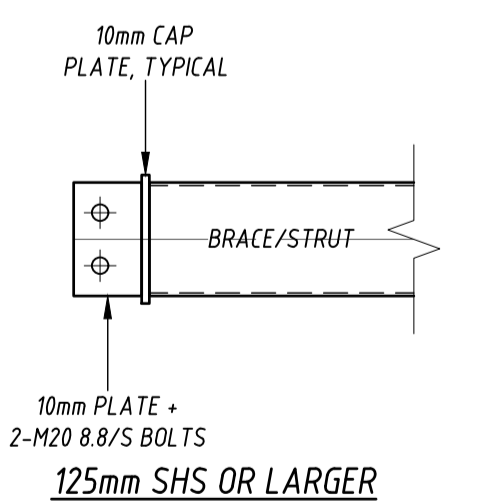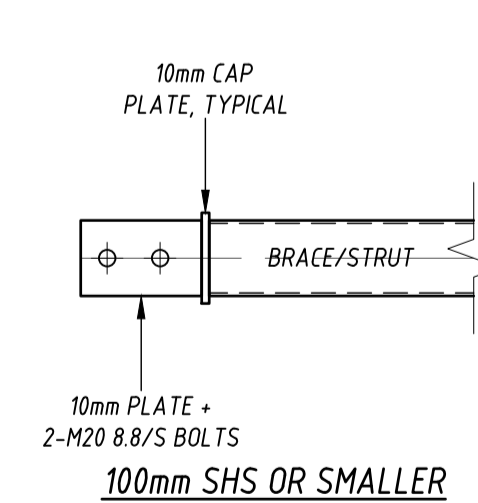

BRACE END DETAILS  
SCALE 1:10

NOTE: DETAILS SHOW DESIGN INTENT. BUILDER/WORKSHOP DETAILER TO ACCURATELY DETERMINE POSITION OF FRAMING AND CONTACT COOK&ROE IF ANYTHING DIFFERS FROM THE DETAILS SHOWN

No	Revision Description	Drawn	Approved	Date
A	ISSUED FOR APPROVAL	JTB	-	17.05.21



DO NOT SCALE

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Project  
**PROPOSED WORKSHOP  
LOT 1 INDUSTRIAL AVENUE, MUDGEE**  
Title  
**STEELWORK DETAILS '2'**

Client  
**HOT ENGINEERING**  
Drawn JTB Designed [Signature] Approved -  
Scale AS SHOWN Date MAY '2021'  
Job No: **37880** Drawing No: **S.71** Rev: **A** Original Size **A1**

FOR APPROVAL