HOT ENGINEERING

STORMWATER DESIGN FOR PROPOSED INDUSTRIAL SHED 10 INDUSTRIAL AVE, MUDGEE, NSW 2850

DRAWING SCHEDULE

STORMWATER MANAGEMENT PLAN

ROOF DRAINAGE PLAN

STORMWATER TYPICAL DETAILS AND NOTES 36881-C12



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HOT ENGINEERING Client: Project:

PROPOSED DEVELOPMENT ON LOT 1 IN DP 262948

10 INDUSTRIAL AVENURE, MUDGEE, 2850 Drawing Title: COVER SHEET- STORMWATER DESIGN

SUBMISSION FOR CC

Certification Drawn **MK**

Size = A1

Rev Date Amendment


A 05/07/21 ISSUED FOR APPROVAL

B 23/08/2021 STORMWATER DESIGN REVISED

Original Sheet

Drawing Number

Revision 36881 - COO

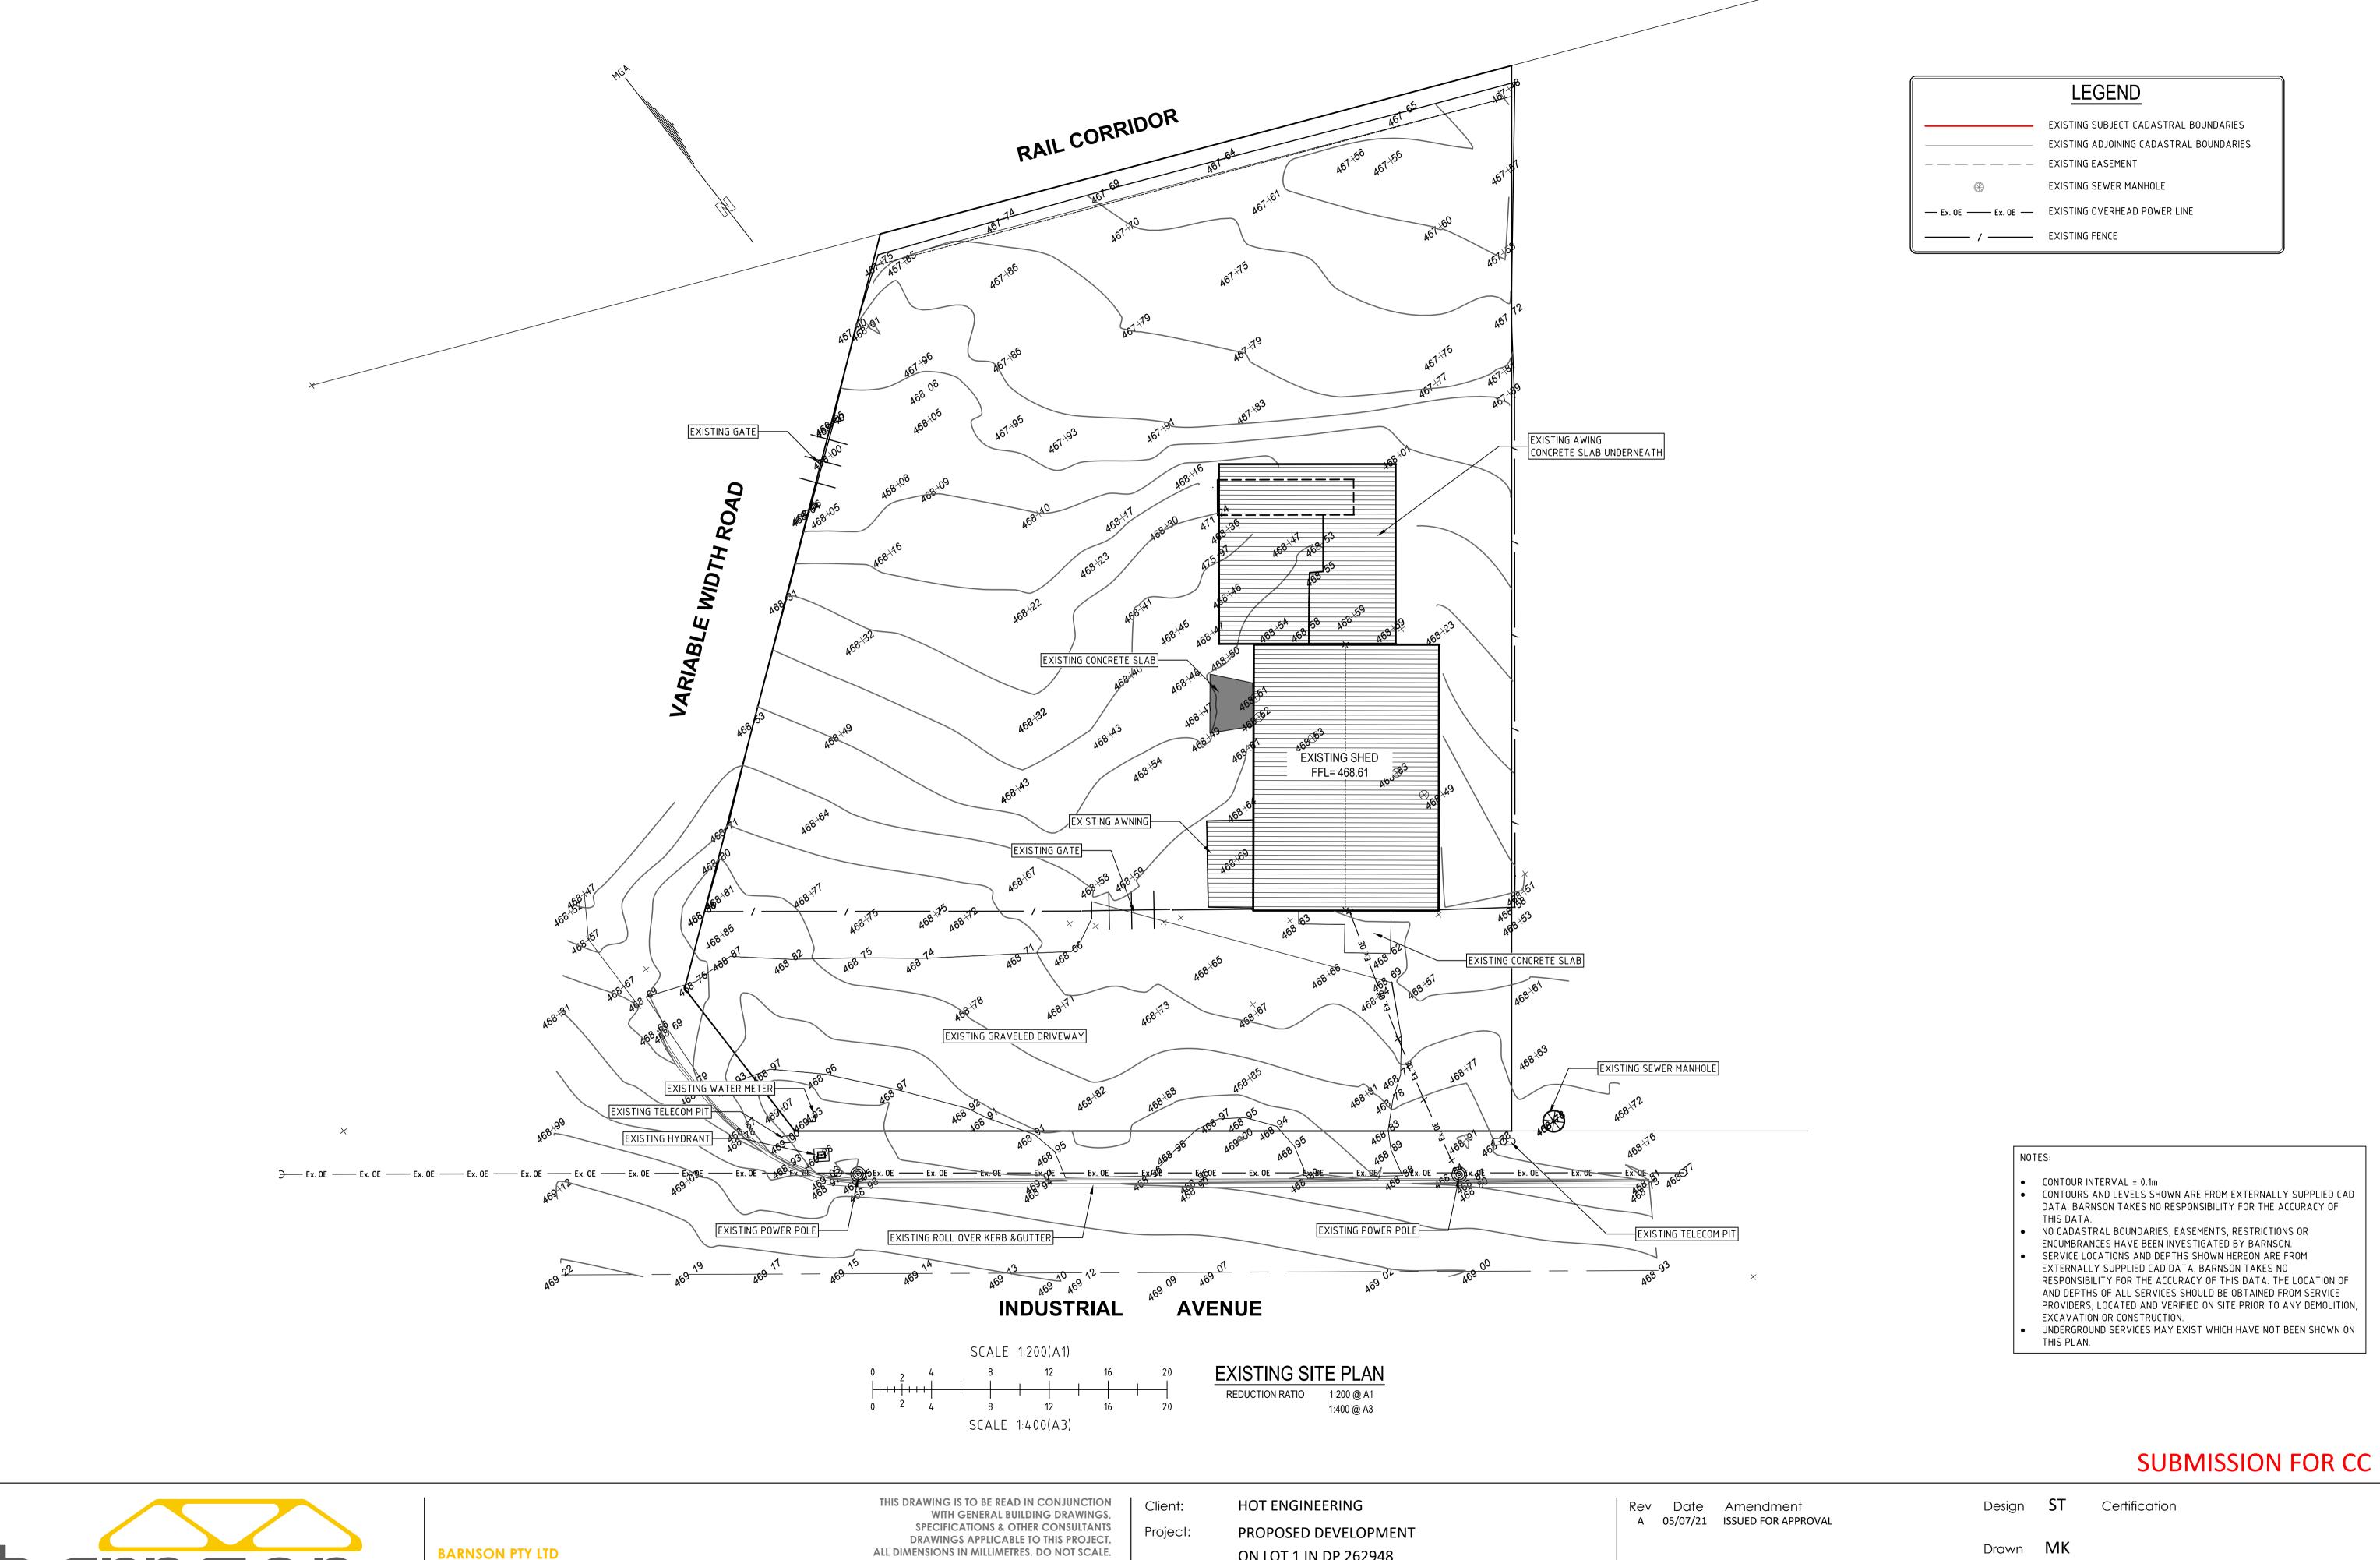

DESIGN.PLAN.MANAGE

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ON LOT 1 IN DP 262948


10 INDUSTRIAL AVENURE, MUDGEE, 2850 Drawing Title: **EXISTING SITE PLAN**

Size = A1

Drawing Number Original Sheet

36881 - C01

Revision

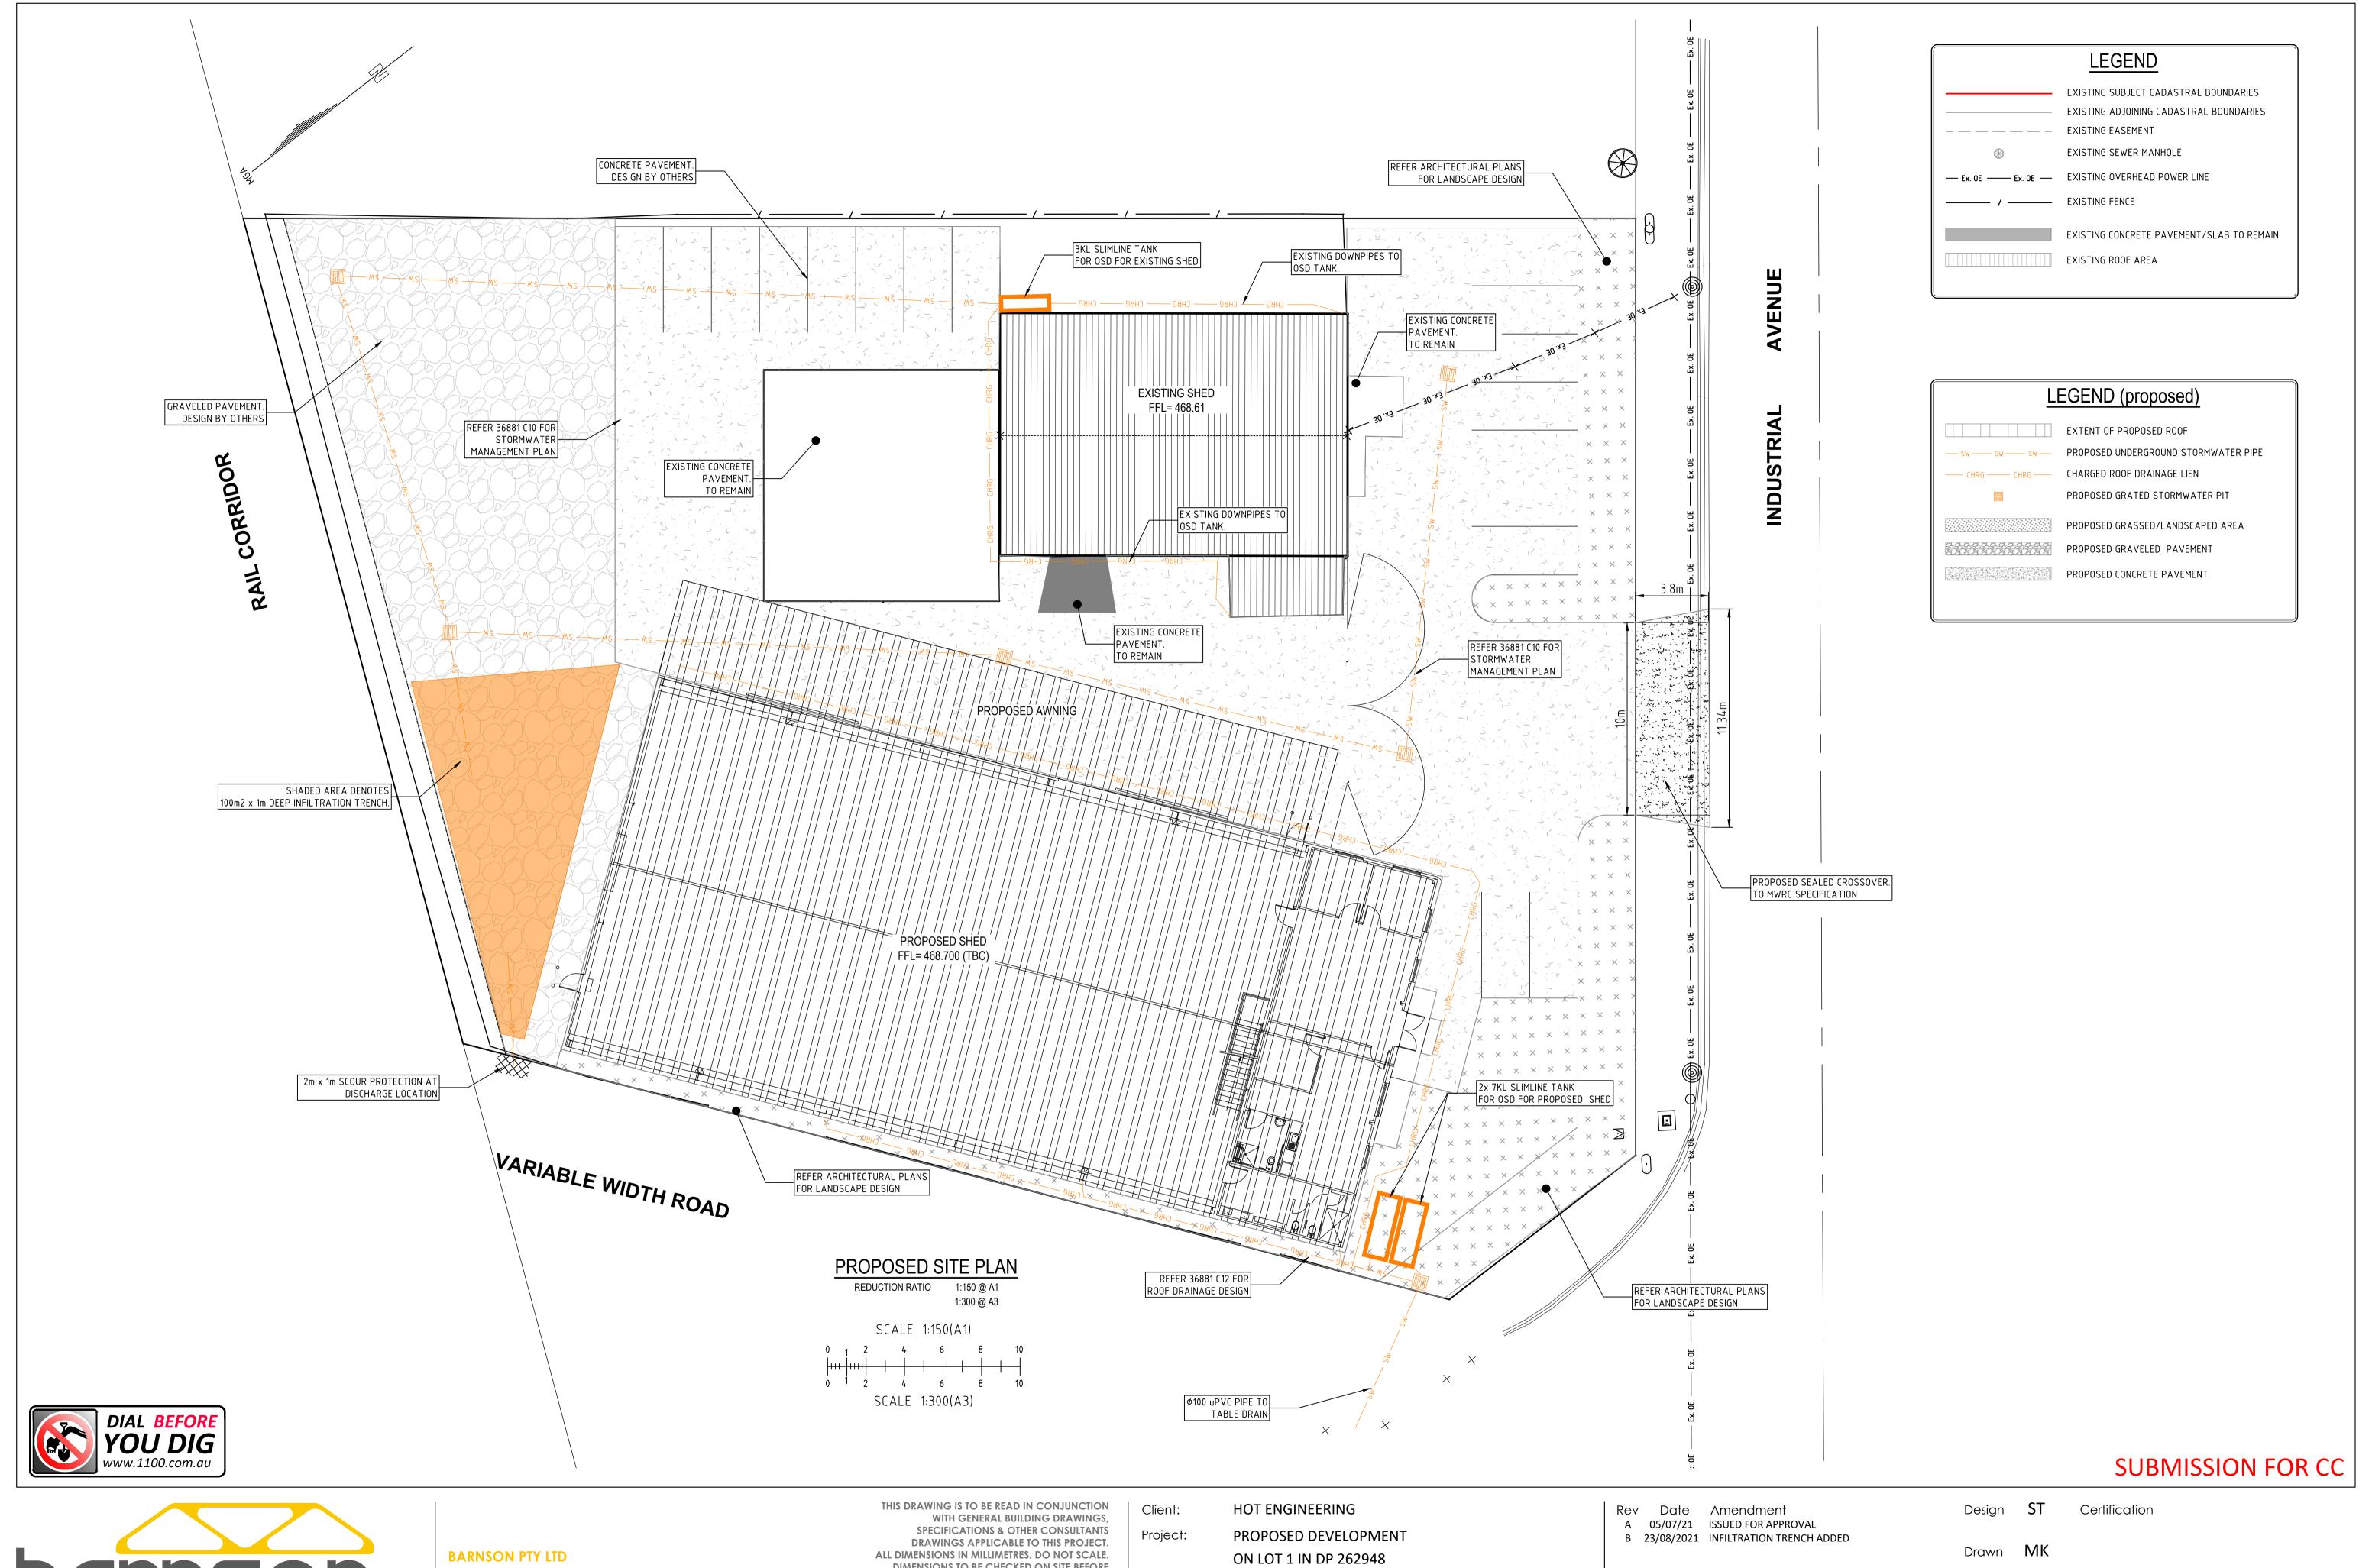



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10 INDUSTRIAL AVENURE, MUDGEE, 2850 Drawing Title: PROPOSED SITE PLAN


Check LM

Original Sheet Size = A1

Drawing Number

Revision

36881 - CO2

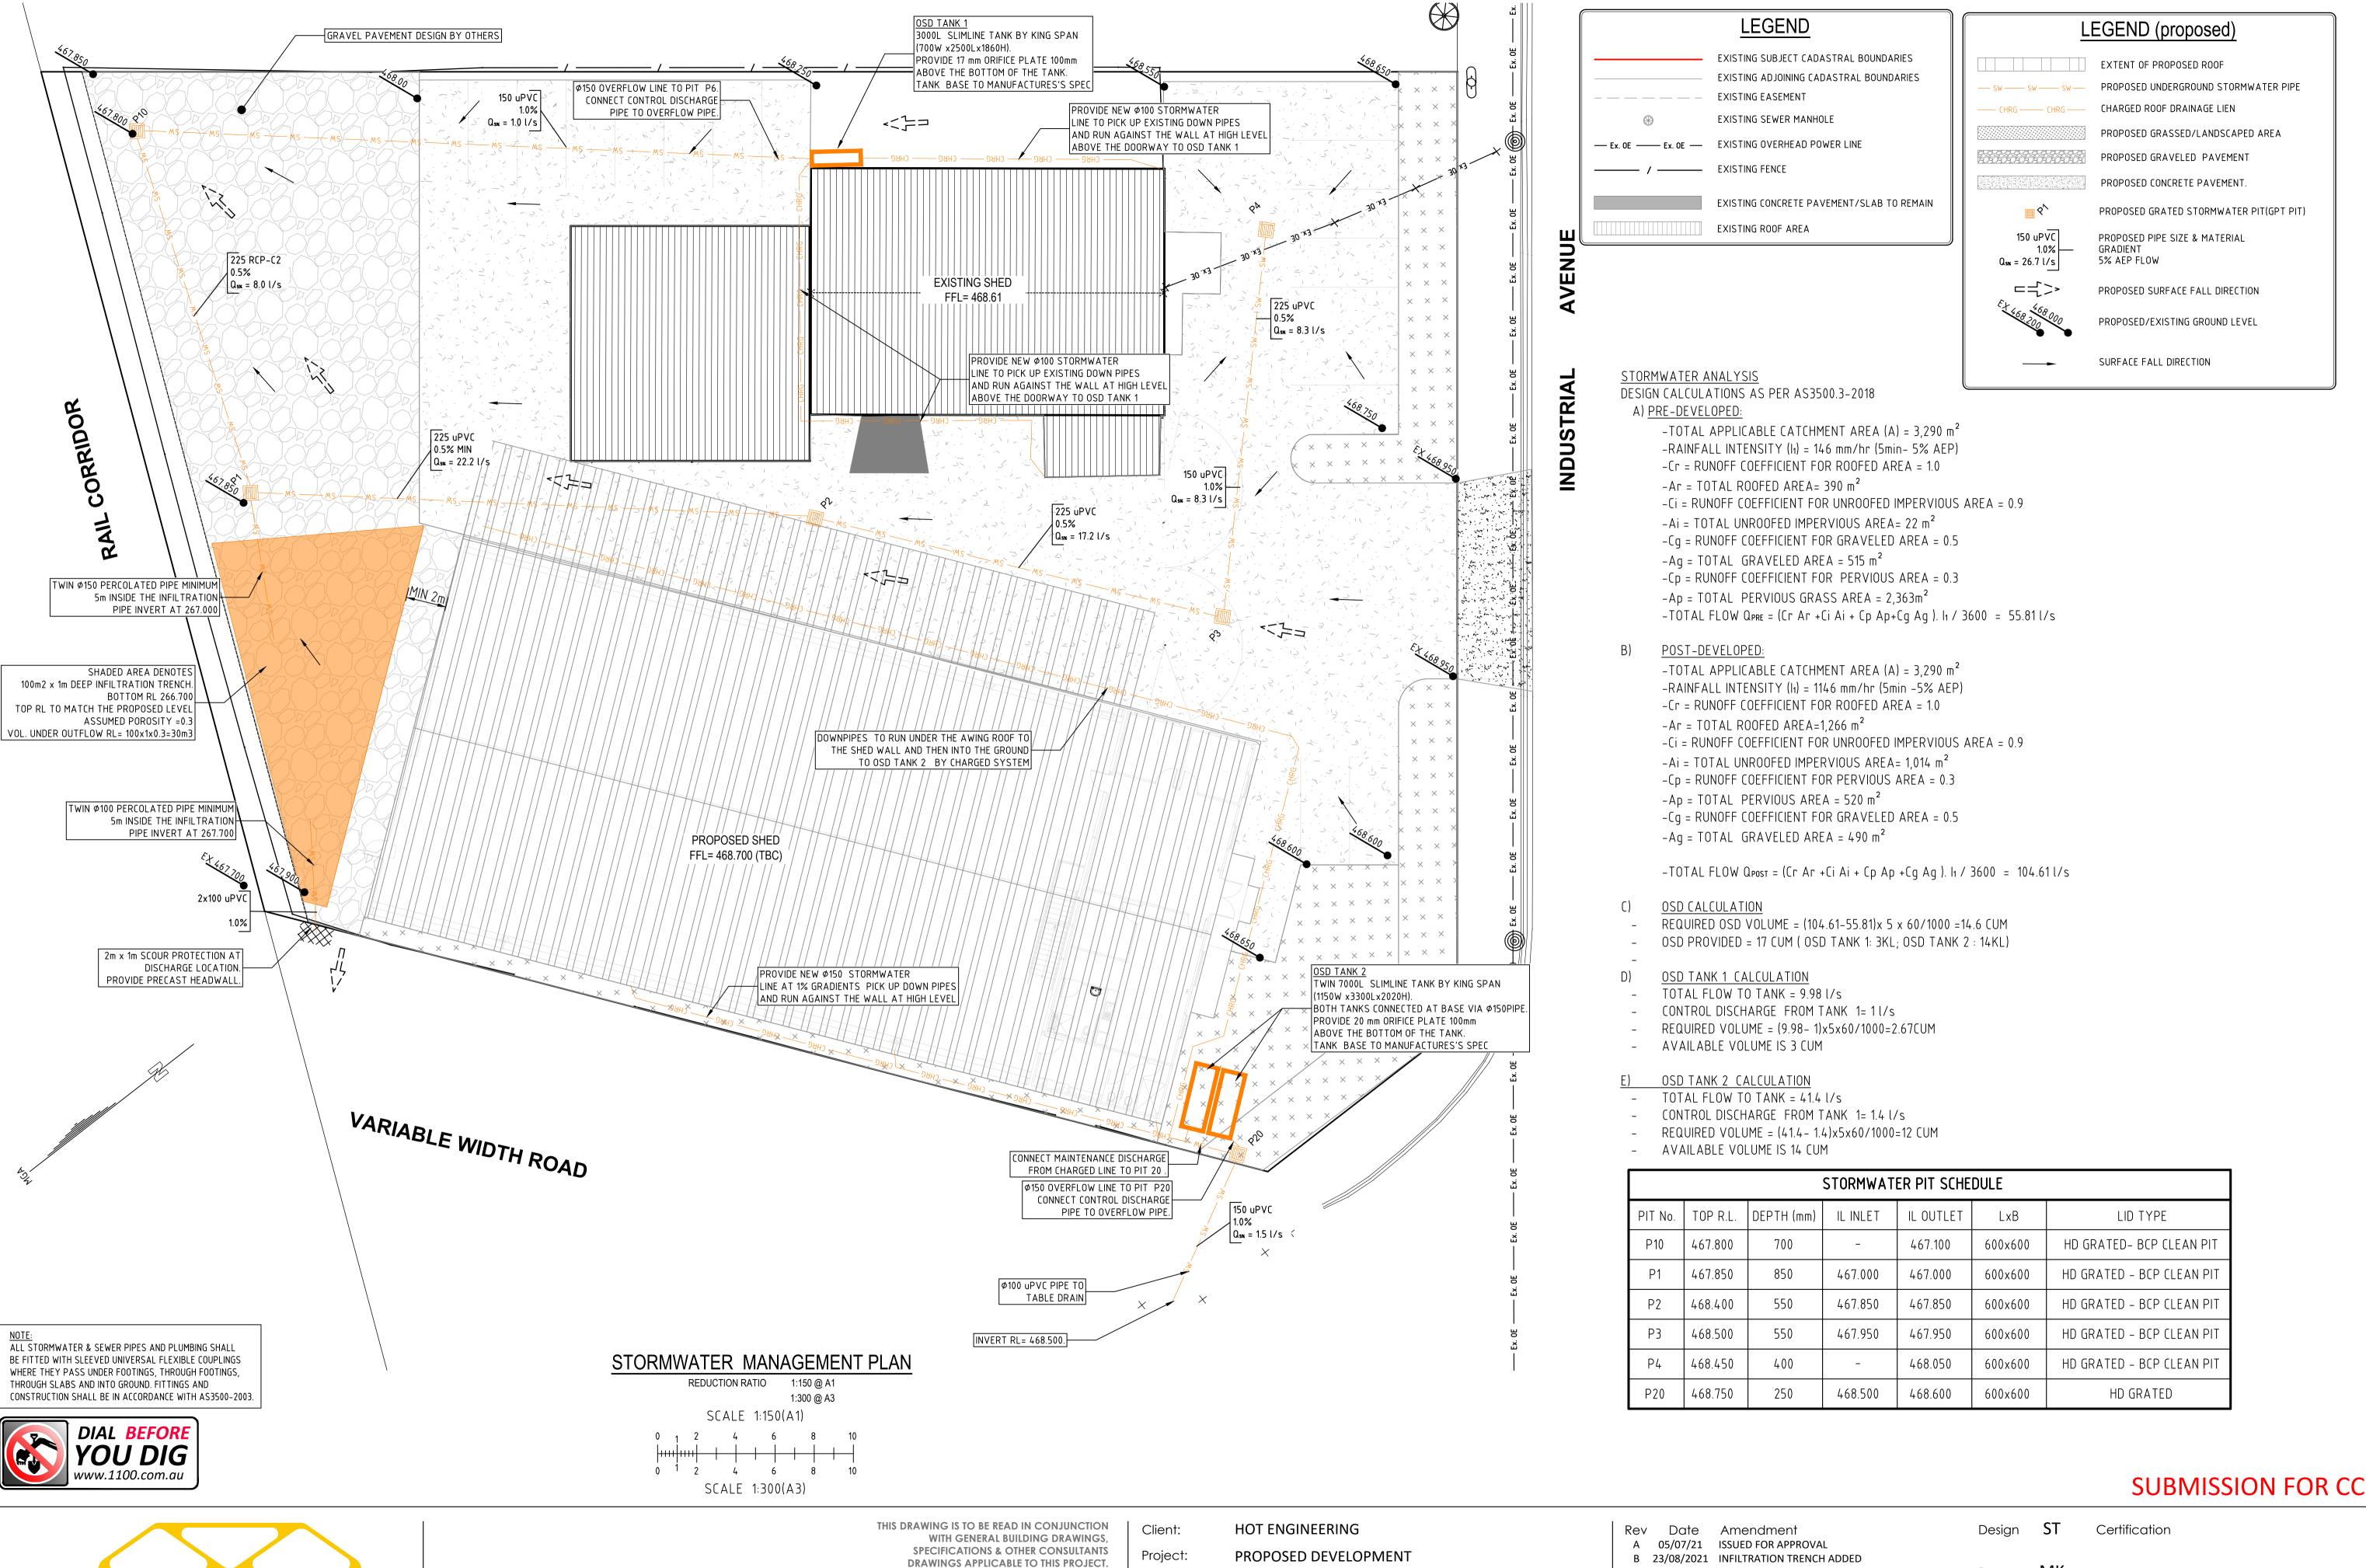



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ON LOT 1 IN DP 262948


10 INDUSTRIAL AVENURE, MUDGEE, 2850 Drawing Title: STORMWATER MANAGEMENT PLAN

Drawn **MK**

Drawing Number Check Original Sheet Size = A1

36881 - C10

Revision

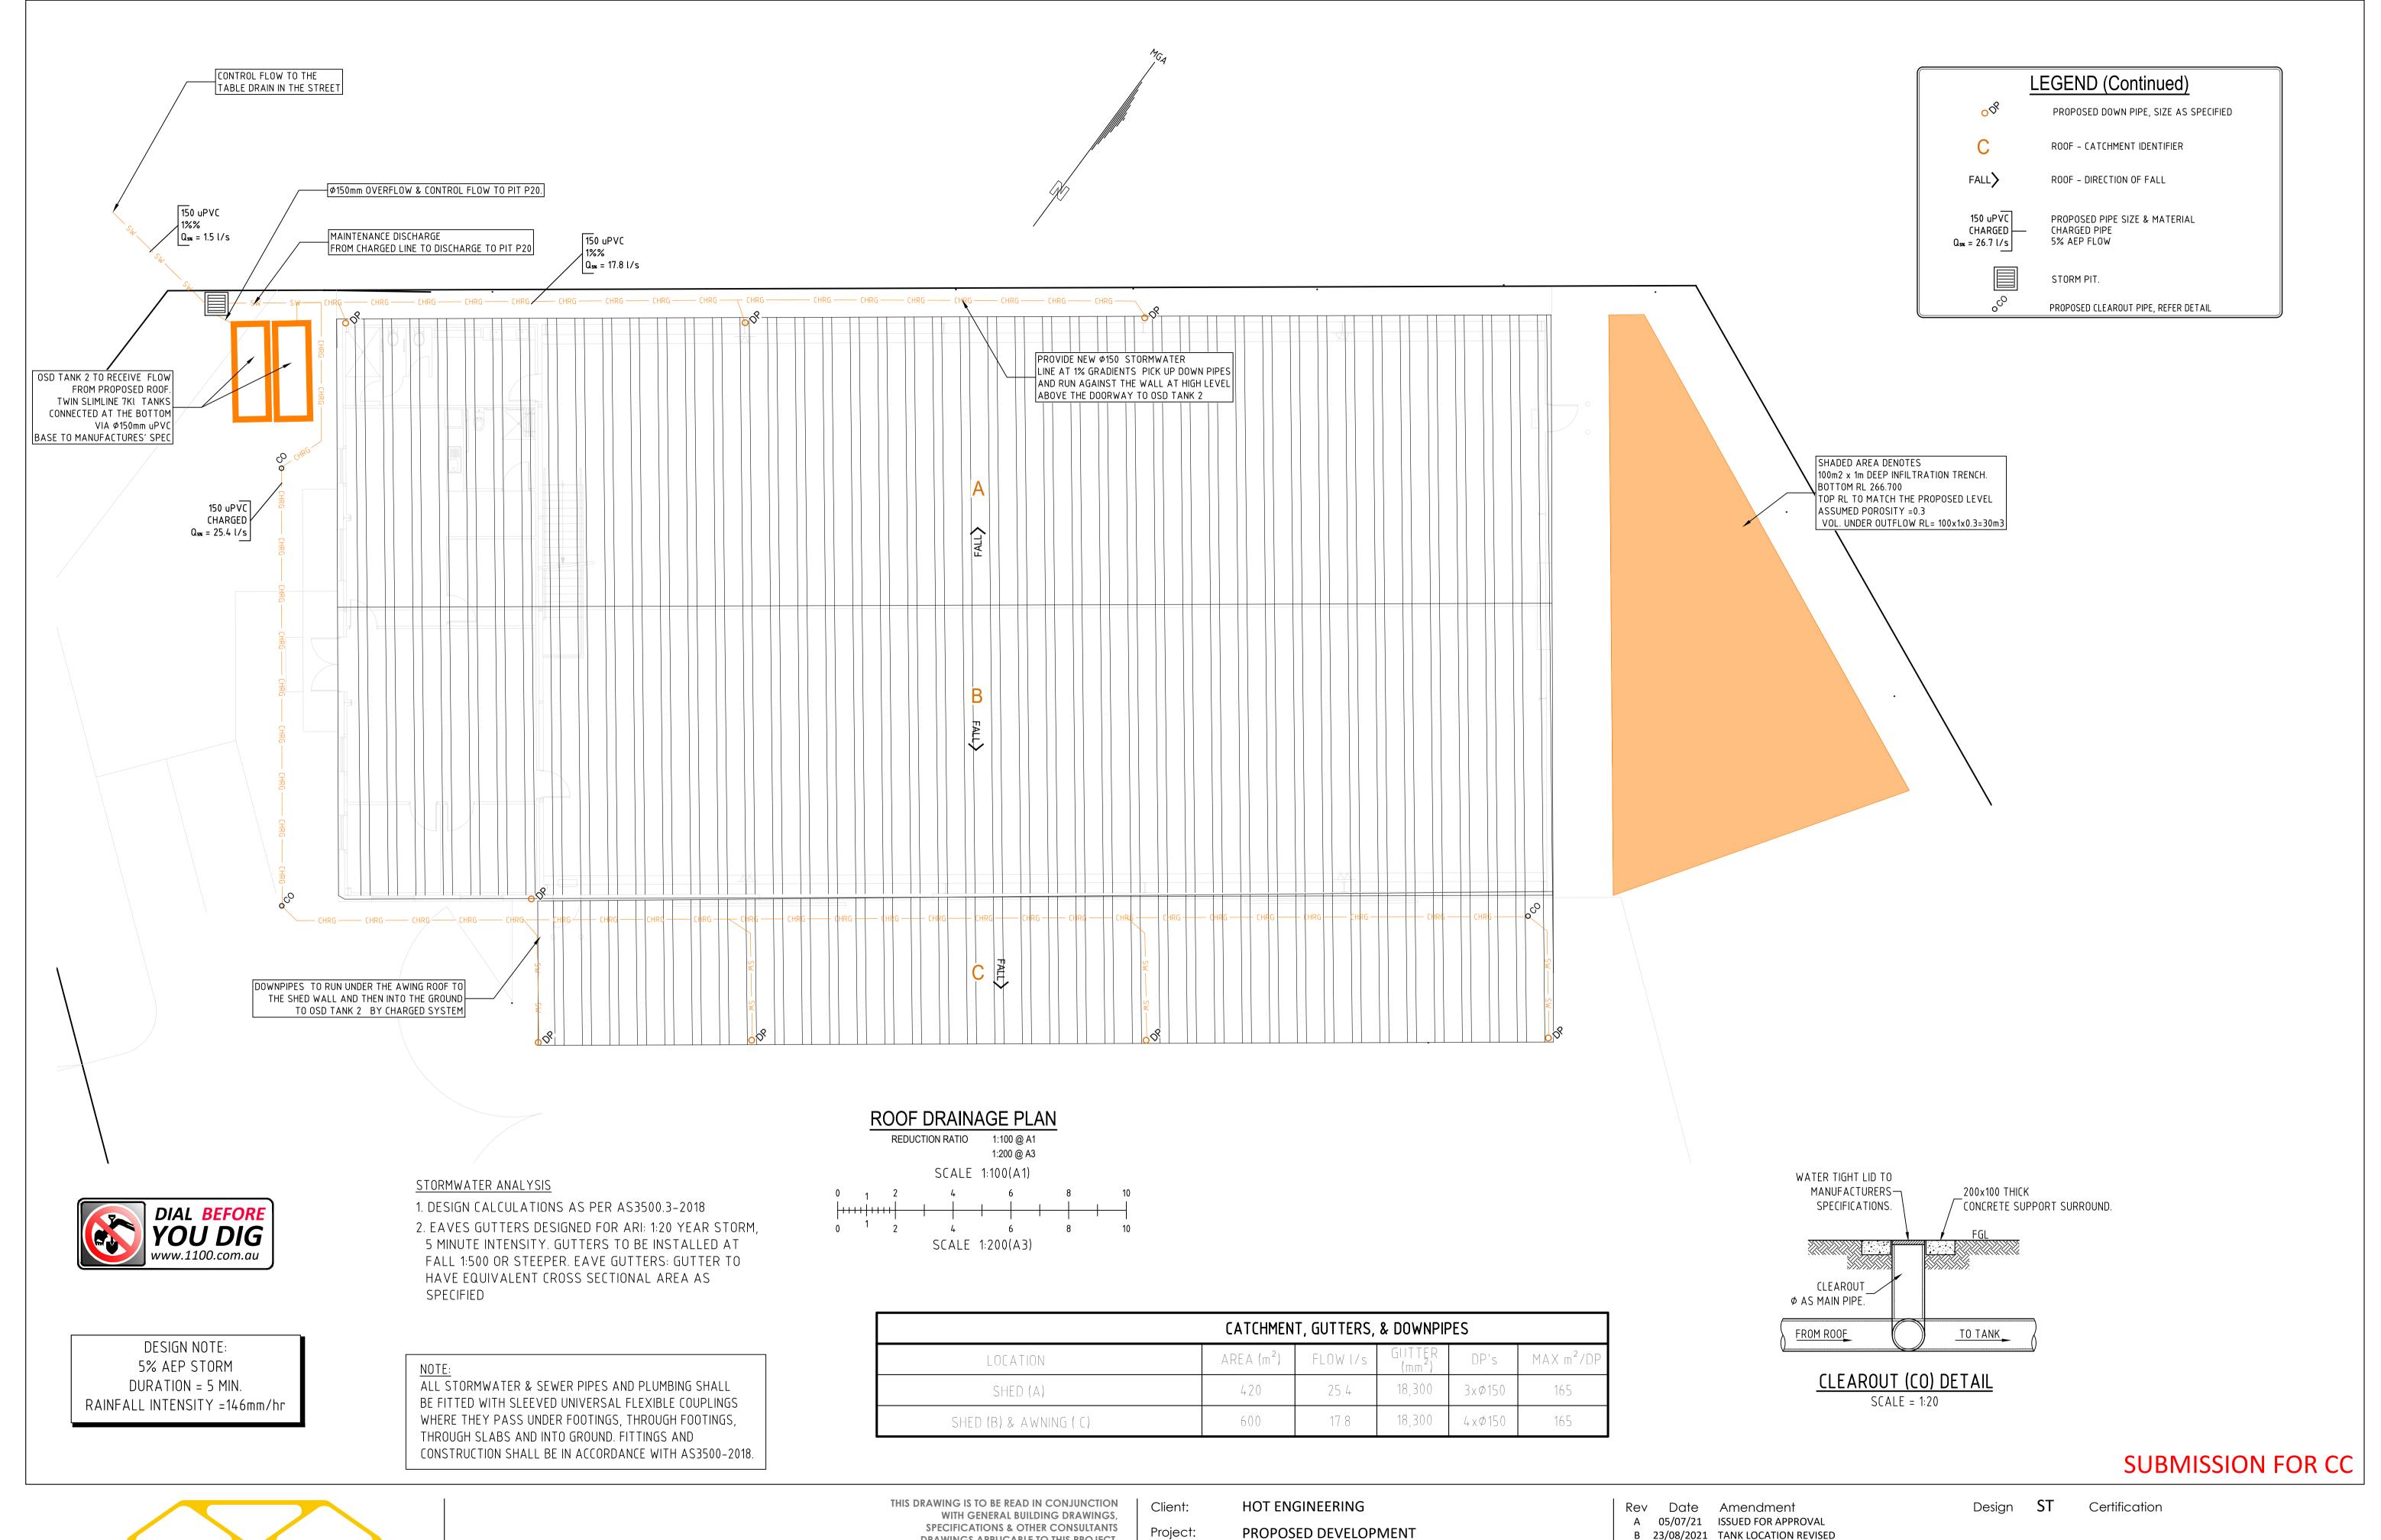



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Project:

ON LOT 1 IN DP 262948

10 INDUSTRIAL AVENURE, MUDGEE, 2850

Drawing Title: ROOF DRAINAGE PLAN

| | | | | | SUBMIS |
|-----------|------------------|-------------------------------|--------|----|----------------|
| }∨ | Date 05/07/21 | Amendment ISSUED FOR APPROVAL | Design | ST | Certification |
| 3 | 23/08/2021 | TANK LOCATION REVISED | Drawn | MK | |
| | | | Check | LM | Drawing Number |

Original Sheet Size = A1

36881 - C11

Revision

SITEWORKS NOTES

1. ORIGIN OF LEVELS :- AHD

2. CONTRACTOR MUST VERIFY ALL DIMENSIONS AND EXISTING LEVELS ON SITE PRIOR TO COMMENCEMENT OF WORK.

3. ALL WORK IS TO BE UNDERTAKEN IN ACCORDANCE WITH THE DETAILS SHOWN ON THE DRAWINGS, THE SPECIFICATIONS AND THE DIRECTIONS OF THE SUPERINTENDENT.

4.EXISTING SERVICES HAVE BEEN OBTAINED FROM SURFACE INSPECTION ONLY. IT IS THE RESPONSIBILITY OF THE CONTRACTOR TO ESTABLISH THE LOCATION AND THE LEVEL OF ALL EXISTING SERVICES PRIOR TO THE COMMENCEMENT OF ANY WORK. ANY DISCREPANCIES SHALL BE REPORTED TO THE SUPERINTENDENT. CLEARANCES SHALL BE OBTAINED FROM THE RELEVANT SERVICE AUTHORITY

5. WHERE NEW WORKS ABUT EXISTING THE CONTRACTOR SHALL ENSURE THAT A SMOOTH EVEN PROFILE, FREE FROM ABRUPT CHANGES IS OBTAINED

6. THE CONTRACTOR SHALL ARRANGE ALL SURVEY SETOUT TO BE CARRIED OUT BY A QUALIFIED SURVEYOR.

7. CARE IS TO BE TAKEN WHEN EXCAVATING NEAR EXISTING SERVICES. NO MECHANICAL EXCAVATIONS ARE TO BE UNDERTAKEN OVER TELECOM OR ELECTRICAL SERVICES. HAND EXCAVATE IN THESE AREAS.

8. ON COMPLETION OF CONSTRUCTION, ALL DISTURBED AREAS MUST BE RESTORED TO ORIGINAL, INCLUDING KERBS, FOOTPATHS, CONCRETE AREAS, GRAVEL AND GRASSED AREAS AND ROAD PAVEMENTS.

9. MAKE SMOOTH TRANSITION TO EXISTING AREAS 10. THE CONTRACTOR SHALL PROVIDE ALL TEMPORARY

DIVERSION DRAINS AND MOUNDS TO ENSURE THAT AT ALL TIMES EXPOSED SURFACES ARE FREE DRAINING AND WHERE NECESSARY EXCAVATE SUMPS AND PROVIDE PUMPING EQUIPMENT TO DRAIN EXPOSED AREAS. ALL WORK TO BE UNDERTAKEN WITH ADHERENCE TO THE REQUIREMENTS OF THE SOIL AND WATER MANAGEMENT PLAN

11. THESE PLANS SHALL BE READ IN CONJUNCTION WITH APPROVED ARCHITECTURAL, STRUCTURAL, HYDRAULIC AND MECHANICAL DRAWINGS AND SPECIFICATIONS

PIPE TRENCH - FILL NOTES:

1. BEDDING SAND

BEDDING SAND SHALL BE GRANULAR MATERIAL HAVING A LOW PERMEABILITY AND HIGH STABILITY WHEN SATURATED, CONFORMING TO THE GRADING LIMITS FOR BEDDING SAND AS INDICATED IN THE CONTRACT DOCUMENTS. BEDDING SAND SHALL BE COMPACTED TO A DENSITY INDEX OF 95% AS DETERMINED IN ACCORDANCE WITH AS1289.

2. APPROVED IMPORTED GRANULAR FILI

ONLY IMPORTED GRANULAR FILL MATERIAL APPROVED BY THE SUPERINTENDENT SHALL BE USED. THIS FILL MATERIAL SHALL BE COMPACTED IN LAYERS NOT EXCEEDING 300mm THICK TO A DRY DENSITY OF 100% OF THE STANDARD MAXIMUM DRY DENSITY OF THE MATERIAL AND WITH A MOISTURE CONTENT NO MORE THAN 1% ABOVE OPTIMUM MOISTURE CONTENT AS DETERMINED IN ACCORDANCE WITH AS1289.

3. ORDINARY EXCAVATED FILL MATERIAL

ORDINARY EXCAVATED FILL MATERIAL IS EXCAVATED TRENCH MATERIAL THAT IS FREE OF VEGETABLE MATTER, HUMUS, LARGE CLAY LUMPS AND ROCK BOULDERS. THIS FILL MATERIAL SHALL BE COMPACTED IN LAYERS NOT EXCEEDING 300mm THICK, TO A DENSITY OF 95% OF THE STANDARD MAXIMUM DRY DENSITY OF THE MATERIAL WITH A MOISTURE CONTENT OF NOT MORE THAN 1% ABOVE THE OPTIMUM MOISTURE CONTENT AS DETERMINED IN ACCORDANCE WITH AS1289.

SCOUR PROTECTION NOTES

1. SCOUR PROTECTION IS TO BE PROVIDED AS A 3000mm WIDE DISTRIBUTION x 300mm DEEP D₅₀ 100mm RIP RAP PLACED ON A SINGLE LAYER OF GEOTEXTILE (BIDIM A34 OR EQUIVALENT) 2. GRADING TO BE AS PER TABLE BELOW

| EQUIVALENT SPHERICAL DIAMETER ## | PERCENT (BY WEIGHT) OF RIP RAP OF SMALLER SIZE | | | | |
|--|--|--|--|--|--|
| 1.5 - 2.0 TIMES D50 ++ | 100% | | | | |
| D 50 | 50% | | | | |
| 0.3 Dso | 10 - 20% | | | | |

THE DIAMETER OF A SPHERE WITH AN EQUIVALENT VOLUME TO THE INDIVIDUAL ROCK.

++ D₅₀ IS THE MEDIAN RIP RAP DIAMETER OF THE ROCK MIX. (i.e. 50% (BY WEIGHT) IS SMALLER AND 50% (BY WEIGHT) IS LARGER).

STORMWATER NOTES

- 1. ALL DOWNPIPE LINES SHALL BE SEWER GRADE uPVC WITH SOLVENT WELD JOINTS (U.N.O)
- 2. EQUIVALENT STRENGTH VCP OR FCP PIPES MAY BE USED. 3. MINIMUM GRADE TO STORMWATER LINES TO BE 0.5% MINIMUM (U.N.O)
- 4. CONTRACTORS TO SUPPLY AND INSTALL ALL FITTINGS AND SPECIALS INCLUDING VARIOUS PIPE ADAPTORS TO ENSURE PROPER CONNECTION BETWEEN DISSIMILAR PIPEWORK
- 5. ALL CONNECTIONS TO EXISTING DRAINAGE PITS SHALL BE MADE IN A TRADESMAN-LIKE MANNER AND THE INTERNAL WALL OF THE PIT AT THE POINT OF ENTRY SHALL BE CEMENT RENDERED TO ENSURE A SMOOTH FINISH.
- 6. APPROVED PRECAST PITS MAY BE USED
- 7. WHERE TRENCHES ARE IN ROCK, THE PIPE SHALL BE BEDDED ON A MIN. 50mm CONCRETE BED (75mm THICK BED OF 12mm BLUE METAL) UNDER THE BARREL OF THE PIPE. THE PIPE COLLAR AT NO POINT SHALL BEAR THE ROCK. IN OTHER THAN ROCK, PIPES SHALL BE LAID ON A 75mm THICK SAND BED. IN ALL CASES, BACKFILL THE TRENCH WITH THE SAND TO 200mm ABOVE THE PIPE .WHERE THE PIPE IS UNDER PAVEMENTS, BACKFILL REMAINDER OF TRENCH WITH SAND OR APPROVED GRANULAR BACKFILL COMPACTED IN 150mm LAYERS TO 98% MAX. DRY DENSITY
- 8. WHERE STORMWATER LINES PASS UNDER FLOOR SLABS,

SOCK

SEWER GRADE RUBBER RING JOINTS ARE TO BE USED 9. ALL PIPES IN THE ROADWAY AND FOOTPATH AREAS, WHERE THE DEPTH OF PIPE IS LESS THAN 500mm FROM THE FINISHED SURFACE LEVEL ARE TO BE CONCRETE ENCASED.

STREAM CLEAN UNIT

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SECTION

Stream/G

SCB66

Filtration Sock

STREAM CLEAN

POLLUTION CONTROL PIT

MAXIMESH

CELL

TREATMENT

OVERFLOW

BYPASS

MAXIMESH TREATMENT CELL

Description


600 x 600 x 650 Stream Clean pit

including Maximesh treatment cell

and oil filtration sock

Stream Clean basket

Oil filtration sock

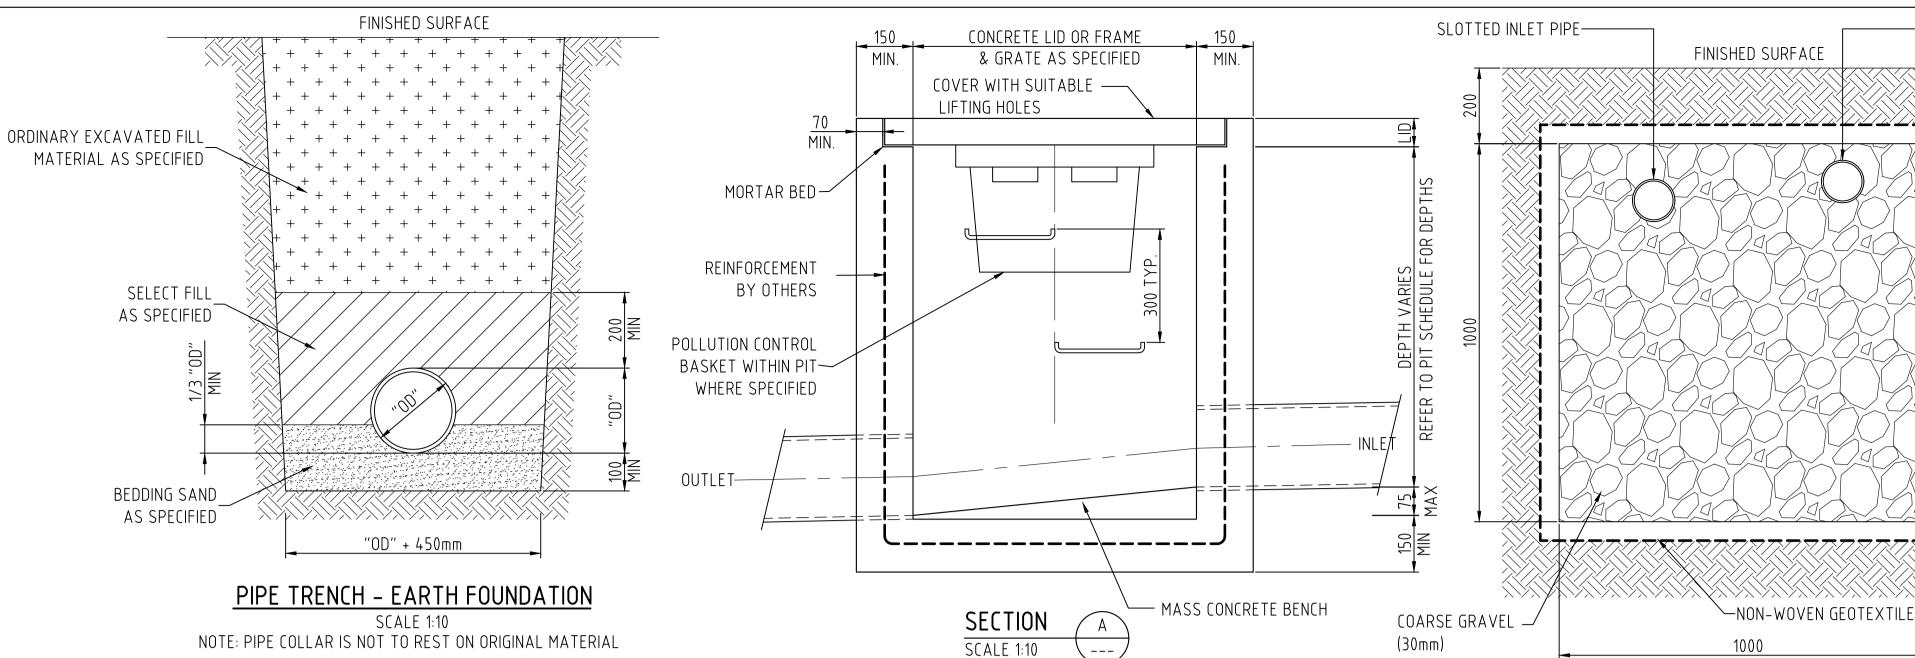

PROVIDE STEP IRONS IF

225-

AS SPECIFIED

STORMWATER PIT PLAN

SCALE 1:10

PIT DEEPER THAN 900mm

REINFORCED CONCRETE

NOTE: EQUIVALENT PRECAST/PLASTIC PIT CAN BE USED PAVEMENT FINISHED SURFACE APPROVED IMPORTED NON-COHESIVE GRANULAR FILI MATERIAL AS SPECIFIED \supset \supset \supset \supset \supset \supset \supset 7 7 7 7 7 7 7 BEDDING SAND AS SPECIFIED

"OD" + 450mm PIPE TRENCH - PAVEMENT

SCALE 1:10

NOTE: PIPE COLLAR IS NOT TO REST ON ORIGINAL MATERIAL

REINFORCED CONCRETE FINISHED SURFACE PAVEMENT APPROVED IMPORTED NON-COHESIVE GRANULAR FILL V V V V V MATERIAL AS SPECIFIED BEDDING SAND AS SPECIFIED 75 SURROUND "OD" + 450mm CONCRETE ENCASEMENT WHERE SPECIFIED.

CONCRETE ENCASED PIPE TRENCH - ROADWAY

ALL uPVC PIPES TO HAVE MIN. 100mm COVER TO UNDERSIDE

SCALE 1:10

REINFORCED CONCRETE PAVEMENT IN TRAFFICABLE AREAS. IF THIS CANNOT BE ACHIEVED PIPES TO BE CONCRETE ENCASED

DESIGN.PLAN.MANAGE

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HOT ENGINEERING Client: Project: PROPOSED DEVELOPMENT ON LOT 1 IN DP 262948

10 INDUSTRIAL AVENURE, MUDGEE, 2850 Drawing Title: STORMWATER TYPICAL DETAILS AND NOTES Rev Date Amendment A 05/07/21 ISSUED FOR APPROVAL B 23/08/2021 INFILTRATION TRENCH DETAILS ADDED

ST Certification Design Drawn **MK**

Check LM Drawing Number Original Sheet

36881 - C12 Size = A1

SUBMISSION FOR CC

Revision

TYPICAL INFILTRATION TRENCH CROSS SECTION

SCALE = 1:10

-SLOTTED OUTLET

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