# **PROPOSED RESIDENTIAL SUBDIVISION 1 RAILWAY STREET, GULGONG - STAGE 1 CIVIL ENGINEERING WORKS** FOR DEVELOPMENT APPLICATION

DRAWING SCHEDULE					
DRG No.	DESCRIPTION	REV.			
GENERAL					
TEL2021184.CIV.DA.000	GENERAL NOTES, LOCALITY PLAN AND DRAWING SCHEDULE	А			
TEL2021184.CIV.DA.001	EXISTING SERVICES AND DEMOLITION PLAN	А			
EROSION AND SEDIMENT					
TEL2021184.CIV.DA.100	EROSION AND SEDIMENT CONTROL PLAN	А			
TEL2021184.CIV.DA.102	EROSION AND SEDIMENT CONTROL DETAILS	А			
ROADS					
TEL2021184.CIV.DA.300	ROADWORKS AND DRAINAGE LAYOUT PLAN	А			
TEL2021184.CIV.DA.302	RAILWAY STREET - LONGITUDINAL SECTIONS AND TYPICAL CROSS SECTION	А			
TEL2021184.CIV.DA.303	RAILWAY STREET - CROSS SECTIONS SHEET 1 OF 2	А			
TEL2021184.CIV.DA.304	RAILWAY STREET - CROSS SECTIONS SHEET 2 OF 2	А			
STORMWATER					
TEL2021184.CIV.DA.400	STORMWATER CATCHMENT PLAN	А			



# DISCLAIMER

ALL INFRASTRUCTURE INFORMATION (MAINS, SEWER, PIPES ETC.) IS DERIVED FROM DIAL BEFORE YOU DIG RECORDS. EVERY EFFORT WAS MADE TO ENSURE ACCURACY OF THESE **RECORDS WHEN COMPILED.** NO WARRANTY IS GIVEN TO CURRENCY OF DEPTHS AND LEVELS DUE TO THE POSSIBILITY OF SUBSEQUENT ALTERATION OF LEVELS THROUGH FILLING OR EXCAVATION. USERS OF THE INFORMATION IN THIS DRAWING/DESIGN SHOULD TAKE ALL REASONABLE STEPS TO VERIFY THE RELEVANT INFORMATION BEFORE COMMENCING EXCAVATING OR CONSTRUCTION WORK.

TELFORD CIVIL DESIGN AND CONSTRUCTION EXCELLENCE TAKE NO RESPONSIBILITY FOR APPARENT ERRORS OR INACCURACIES IN THE INFORMATION PROVIDED.

IT IS THE CONTRACTOR RESPONSIBILITY TO CONTACT "DIAL BEFORE YOU DIG" FOR THE LOCATION OF EXISTING PUBLIC UTILITIES, PRIOR TO EXCAVATION.

# DANGER :

LOCATION OF ALL EXISTING UNDERGROUND SERVICES SHOWN ARE APPROXIMATE AS TAKEN OFF DBYD INFO. EXTREME CAUTION TO BE EXERCISED WHEN WORKING IN THE VICINITY OF AND AROUND THESE SERVICES. PLEASE CALL THE RELEVANT AUTHORITIES TWO DAYS PRIOR TO CONSTRUCTION FOR A MORE EXACT LOCATION OF THE EXISTING SERVICES.



# EARTHWORKS NOTES

- 1. EARTHWORKS NOTES ARE TO BE READ IN CONJUNCTION WITH THE GENERAL AND COORDINATION NOTES. 2. EARTHWORKS SHALL BE CARRIED OUT IN ACCORDANCE WITH PROCEDURES SET DOWN IN AS3798 'GUIDELINES ON
- EARTHWORKS FOR COMMERCIAL AND RESIDENTIAL DEVELOPMENTS'.
- 3. BULK EARTHWORKS INCLUDING CLEARING, FILLING AND TESTING, ARE TO BE CARRIED OUT IN ACCORDANCE WITH THE CURRENT COUNCIL STANDARDS, DRAWINGS AND SPECIFICATIONS. COUNCIL STANDARDS SUPERSEDE ANY NOTES OR SPECIFICATIONS WRITTEN ON THE DESIGN DRAWINGS.
- 4. BULK EARTHWORKS LEVELS SHALL BE DETERMINED RELATIVE TO THE FINISHED SURFACE LEVELS. REFER ARCHITECTURAL DRAWINGS FOR SLAB LEVELS, TO THE STRUCTURAL ENGINEERS DRAWINGS FOR BUILDING AND PATH SLAB THICKNESS AND TO THE CIVIL ENGINEERS DRAWINGS FOR EXTERNAL FINISHED SURFACE LEVELS AND EXTERNAL PAVEMENT THICKNESSES
- 5. TOPSOIL SHALL BE STOCKPILED AS DIRECTED BY THE SUPERINTENDENT ON SITE. 6. PRIOR TO PLACEMENT OF ANY FILLING ALL TOPSOIL AND ORGANIC MATERIAL IS TO BE REMOVED AND THE SUBGRADE SHALL BE UNIFORMLY COMPACTED TO THE MINIMUM DRY DENSITY RATIOS SHOWN IN NOTE 10. ANY SOFT SPOTS REVEALED BY COMPACTION SHALL BE REMOVED AS DIRECTED BY THE SUPERINTENDENT AND BACKFILLED WITH COMPACTED SELECT FILL.
- 7. MOISTURE CONTENT OF COMPACTED FILL SHOULD BE MAINTAINED WITHIN 2% OF OPTIMUM MOISTURE CONTENT. 8. FILL SHALL BE COMPACTED IN MAXIMUM 200mm THICK LAYERS (LOOSE THICKNESS) TO THE FOLLOWING MINIMUM DRY DENSITY RATIOS (STANDARD COMPACTION A.S.1289.5-1).
- 8.A. UPPER 0.3m OF PAVEMENT SUBGRADE = 100%;
- 8.B. UNDER BUILDINGS = 98%;
- 8.C. GENERAL FILL = 95%. 9. ALL FILL MATERIAL PLACED ON THE SITE SHALL COMPRISE ONLY NATURAL EARTH AND ROCK, AND IS TO BE FREE OF CONTAMINANTS (AS DEFINED BY SECTION 11 OF THE ENVIRONMENTAL PROTECTION ACT 1994), NOXIOUS, HAZARDOUS, DELETERIOUS AND ORGANIC MATERIALS. NO DEMOLITION MATERIAL IS TO BE USED. SUITABLE FILL MATERIAL IS DEEMED TO COMPLY WITH THE REQUIREMENTS OF CLAUSE 4.3 OF AS3798, 'GUIDELINES ON EARTHWORKS FOR COMMERCIAL AND RESIDENTIAL DEVELOPMENTS'.
- 10. IMPORTED FILL SHALL COMPLY WITH THE FOLLOWING:
  - 10.A. SOAKED CBR = MINIMUM OF 15%; 10.B. LIQUID LIMIT = 30% MAX;
  - 10.C. PLASTICITY INDEX = 15% MAX;
  - 10.D. MAXIMUM AGGREGATE SIZE = 75mm;
  - 10.E. PASSING 0.075mm SIEVE = 30% MAX;
- 10.F. SHRINK/SWELL INDEX = 1.0% MAX. 11. THE CONTRACTOR IS TO ENGAGE, AT THEIR EXPENSE, AN APPROVED NATA REGISTERED LABORATORY TO CARRY

OUT SITE CONTROL TO 'LEVEL 1' STANDARD AS SET OUT IN APPENDIX B OF AS3798-2007 'GUIDELINES ON EARTHWORKS FOR COMMERCIAL AND RESIDENTIAL DEVELOPMENTS' AND PROVIDE A 'LEVEL 1' REPORT ON COMPLETION OF EARTHWORKS.

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					Certification By Dr. Michel Chaaya in affiliation with Joe Bacha (formerly	Client
					Australian Consulting Engineers):	MR. ROY AMERY
						Council
A	ISSUE FOR DEVELOPMENT APPLICATION	22/10/2021	P.B.T.	J.A.B.		MID-WESTERN
Issue	Description	Date	Design	Checked		<b>REGIONAL COUNCIL</b>
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# DRAINAGE NOTES

- 1. DRAINAGE NOTES ARE TO BE READ IN CONJUNTION WITH THE GENERAL AND COORDINATION NOTES.
- 2. CONTRACTOR IS TO CHECK THAT THE PROPOSED PIPE WORKS DO NOT CLASH WITH EXISTING SERVICES PRIOR TO ANY TRENCH EXCAVATION. THE CONTRACTOR SHALL NOTIFY THE ENGINEER IF ANY CLASHES ARE FOUND FOR ADVICE ON ANY DESIGN REQUIREMENTS.
- 3. STRUCTURES HAVE BEEN DESIGNED FOR OPERATIONAL LOADS ONLY. THE CONTRACTOR IS RESPONSIBLE FOR THE ASSESSMENT OF CONSTRUCTION LOADS AND PROVISION OF ANY TEMPORARY BRACING, PROPPING, ETC. REQUIRED DURING CONSTRUCTION, STRUCTURES SHALL BE MAINTAINED IN A STABLE CONDITION AND NO PART SHALL BE OVERSTRESSED.
- 4. ALL TRENCH EXCAVATIONS AND CONSTRUCTION IS TO BE IN ACCORDANCE WITH THE WORKPLACE HEALTH AND SAFETY 1989 AS AMENDED AND THE MINE REGULATIONS ACT
- 5. ALL TRENCHES IN TRAFFICABLE AND NON TRAFFICABLE ZONES SHALL BE BACKFILLED TO DENSITY RATIOS, FREQUENCIES AND LAYER INTERVALS IN ACCORANCE WITH THE CURRENT COUNCIL STANDARDS. ALL TEST RESULTS SHALL FORWARDED TO THE SUPERINTENDENT AS THEY BECOME AVAILABLE.
- 6. ALL PRECAST CONCRETE PIPES ARE TO BE MANUFACTURED IN ACCORDANCE WITH AS 4058. STORMWATER PIPES SHALL BE TO FOLLOWING CLASSES U.N.O.
  - 6.A. REINFORCED CONCRETE PIPES (RCP) = CLASS 2;
  - 6.B. FIBRE REINFORCED PIPES (FRC) = CLASS 2;
- 6.C. uPVC = CLASS 'SEH'.
- 7. ALL RCP PIPES SHALL HAVE THE FOLLOWING JOINTS U.N.O.
- 7.A. RCP <=600 DIA = RUBBER RING JOINTED (RRJ). 7.B. RCP >600 DIA = FLUSH JOINTED (FJ);
- 8. ROOFWATER PIPES SHALL BE uPVC PIPES CLASS 'SH' U.N.O.
- 9. REFER TO STORMWATER LONGITUDINAL SECTIONS FOR ALL STRUCTURE TYPES, SIZES, LEVELS
- AND GRATE TYPES. GRATES SHALL BE TRAFFICABLE CLASS 'D' U.N.O. 10. MANHOLE AND FIELD INLET ACCESS SHALL BE INSTALLED AS DESCRIBED BELOW IN ACCORDANCE WITH AS1657:
- 10.A. GULLY/FIELD INLETS >1.35m DEPTH: STEP IRONS;
- 10.B. MANHOLES 0.850m-3.0m DEPTH: STEP IRONS;
- 10.C. MANHOLES >3.0m DEPTH: FIXED ACCESS LADDER.
- 11. TEST CERTIFICATES AND MATERIAL CERTIFICATION DOCUMENTATION IS REQUIRED FOR ALL PIPES, FITTINGS, BOX CULVERTS AND OTHER PRECAST CONCRETE PRODUCTS.
- 12. ALL STORMWATER SETOUT IS TO CENTRE OF STRUCTURE U.N.O.



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1 RAILWA **PROPOSED F** CIVIL E DEVELO

- CONNECTION. 3. LEVEL DATUM IS AHD.
- CONTRACTOR

# **EROSION AND SEDIMENT CONTROL NOTES**

- COORDINATION NOTES.

- EFFICIENT OPERATION.

- ACCEPTABLE METHODS INCLUDE:
- 10.A. WATERING;

- 10.D. MULCHING.

# **COORDINATION NOTES**

REFER ELECTRICAL CONSULTANTS DRAWINGS FOR ELECTRICAL RETICULATION SETOUT REFER LANDSCAPE ARCHITECTS DRAWINGS FOR SOIL STABILATION AND PLANTING DETAILS REFER SERVICE AUTHORITY FOR LOCATION AND CONSTRUCTION REQUIREMENTS APPLICABLE TO EXISTING SERVICES

# **GENERAL NOTES**

ALL WORK IS TO CONFORM TO THE CURRENT COUNCIL STANDARDS, DRAWINGS AND SPE WHERE CONNECTION IS TO BE MADE TO EXISTING CONSTRUCTION THE CONTRACTOR SHALL LOCATION AND LEVEL OF THIS CONSTRUCTION PRIOR TO COMMENCING WORK ON ANY CRITICAL SECTION. THE SUPERINTENDENT MAY VARY LEVELS AND GRADIENTS OF NEW WORKS TO ACHIEVE A SATISFACTORY

ALL DIMENSIONS ARE IN METRES U.N.O

PRIOR TO CONSTRUCTION THE CONTRACTOR WILL SATISFY HIMSELF OF THE CORRECT LOCATIONS OF ALL EXISTING SERVICES WHETHER INDICATED OR NOT ON THE PLANS, ANY DAMAGE RECTIFIED AT THE CONTRACTORS EXPENSE

PRIOR TO CONSTRUCTION THE CONTRACTOR SHALL VERIFY BENCH MARK LE

SUPERINTENDENT OF ANY DISCREPANCIES PRIOR TO CONSTRUCTION THE CONTRACTOR IS TO CONFIRM WITH THE SUPERINTENDENT THE FOLLOWING: 7.A. ALL INSPECTION HOLD POINTS, AND;

7.B. ALL COMPLIANCE TESTING REQUIREMENTS

ANY WORK ON EXISTING SERVICES THAT REQUIRE RELOCATION BY AUTHORITIES SHALL BE CARRIED OUT BY THE RELEVANT AUTHORITY, BUT WITHIN TERMS OF THE CONTRACT, AND SHALL BE CO-ORDINATED BY THE

COUNCIL STANDARDS AND SUBMIT THE DETAILS SHOWN ON A PLAN TO THE SUPERINTENDENT

1. EROSION & SEDIMENT CONTROL (ESC) NOTES ARE TO BE READ IN CONJUNCTION WITH THE GENERAL AND

2. ALL ESC MEASURES SHALL BE IN ACCORDANCE CURRENT COUNCIL STANDARDS, DRAWINGS AND SPECIFICATIONS U.N.O. 3. CONSTRUCTION OF ALL SEDIMENT CONTROL MANAGEMENT DEVICES SHALL BE TO THE SATISFACTION OF THE SUPERINTENDENT. THE CONTRACTOR IS TO FOLLOW THE CONSTRUCTION PHASE AS OUTLINED:

3.A. CONSTRUCTION OF EROSION AND SEDIMENT DEVICES;

3.B. STRIPPING TOPSOIL;

3.C. BULK EARTHWORKS;

3.D. SERVICES, BUILDING, PAVEMENT AND ROAD CONSTRUCTION

3.E. LANDSCAPED AREAS TO BE TOPSOILED, TURFED, MULCHED OR PLANTED.

4. THE CONTRACTOR IS TO PROVIDE A CONSTRUCTION TRAFFIC SHAKEDOWN DEVICE AT ALL RELEVANT POINTS OF EXIT FROM THE SITE. THE CONTRACTOR SHALL CLEAN OUT AND MAINTAIN THE SHAKEDOWN DEVICE REGULARLY TO ENSURE

5. THE CONTRACTOR SHALL PROVIDE SILT FENCES IMMEDIATELY DOWNSTREAM OF ANY SOIL STOCKPILES. 6. BOTH TEMPORARY AND PERMANENT ESC MEASURES SHALL BE MAINTAINED AT A SUITABLE LEVEL/CONDITION

THROUGHOUT CONSTRUCTION TO THE SATISFACTION OF THE SUPERINTENDENT.

7. ALL TEMPORARY ESC MEASURES SHALL BE MAINTAINED AND FULLY OPERATIONAL DURING THE CONSTRUCTION AND MAINTENANCE PERIOD, AND ARE TO BE REMOVED AFTER THE SATISFACTORY COMPLETION OF AN 'OFF MAINTENANCE' INSPECTION BY THE SUPERINTENDENT.

8. ALL ESC MEASURES ARE TO BE INSPECTED AT LEAST DAILY, PRIOR TO EXPECTED RAINFALL AND AFTER RAINFALL. ANY DAMAGE OR EXCESS EROSION/SEDIMENT IS TO BE REPAIRED/MANAGED AS REQUIRED TO MAINTAIN CONTROL DEVICES. 9. ALL ESC MEASURES MUST SUIT THE PREVAILING CLIMATE/WEATHER CONDITIONS AT THE TIME OF CONSTRUCTION. 10. THE CONTRACTOR IS TO ENSURE THE SUPPRESSION OF DUST AT ALL TIMES DURING THE CONSTRUCTION AND MAINTENANCE PERIOD OF THE DEVELOPMENT. ENVIRONMENTAL HARM AND NUISANCE FROM DUST IS TO BE PREVENTED.

10.B. PROMOTING VEGETATION IN WIND EROSION PRONE AREAS;

10.C. CONSTRUCTING WIND BREAKS;

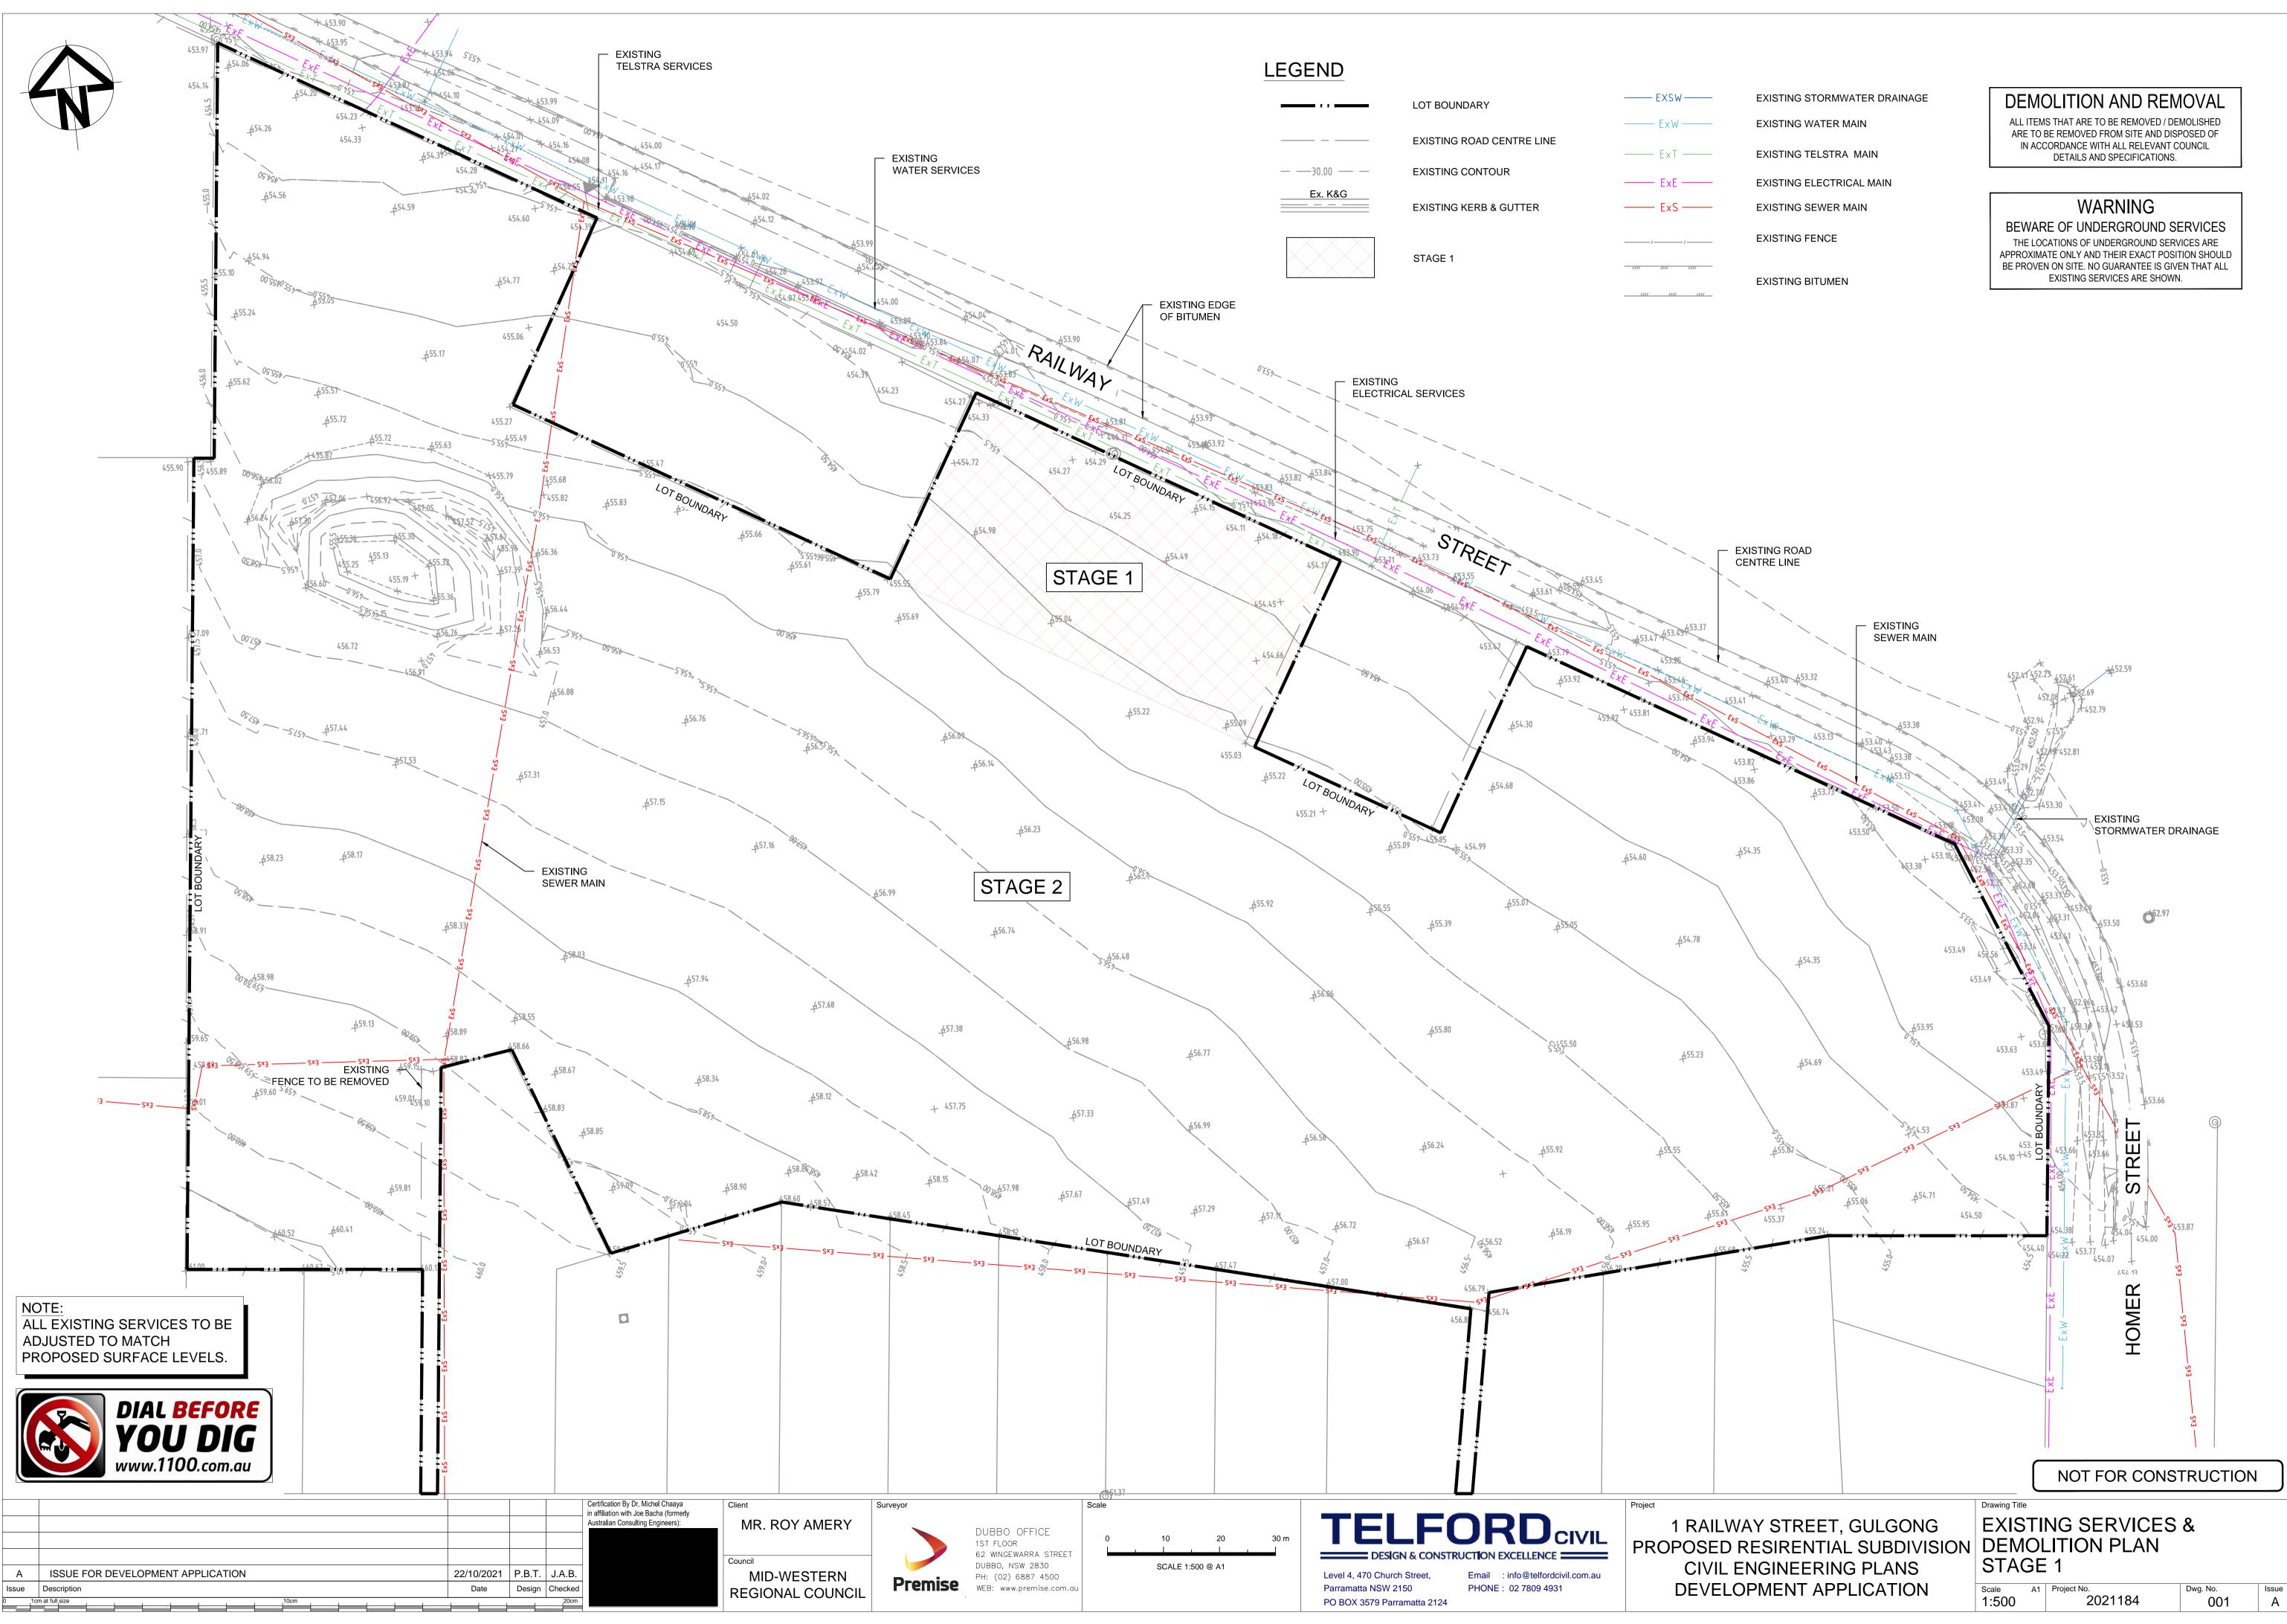
11. THE CONTRACTORS VEHICLES & PLANT SHALL NOT OPERATE OUTSIDE THE LIMITS OF THE IMMEDIATE CONSTRUCTION AREA AND ARE RESTRICTED FROM CROSSING OR DISTURBING AREAS NOT SUBJECT TO CONSTRUCTION. 12. ANY WATER TRAPPED WITHIN THE TEMPORARY SEDIMENT BASIN IS TO BE REGULARLY TESTED DURING THE COURSE OF

CONSTRUCTION. REFER WATER QUALITY MONITORING TABLE FOR DETAILS. 13. ALL DISTURBED GROUND IS TO BE GRASS SEEDED TO PREVENT EROSION IF THE DISTURBED GROUND IS TO BE LEFT

"OPEN" FOR A PERIOD OF GREATER THEN ONE (1) MONTH. 14. REFER DRAWING AS TEL2021184.CIV.DA - 100 TO 101 FOR EROSION AND SEDIMENT CONTROL DETAILS.

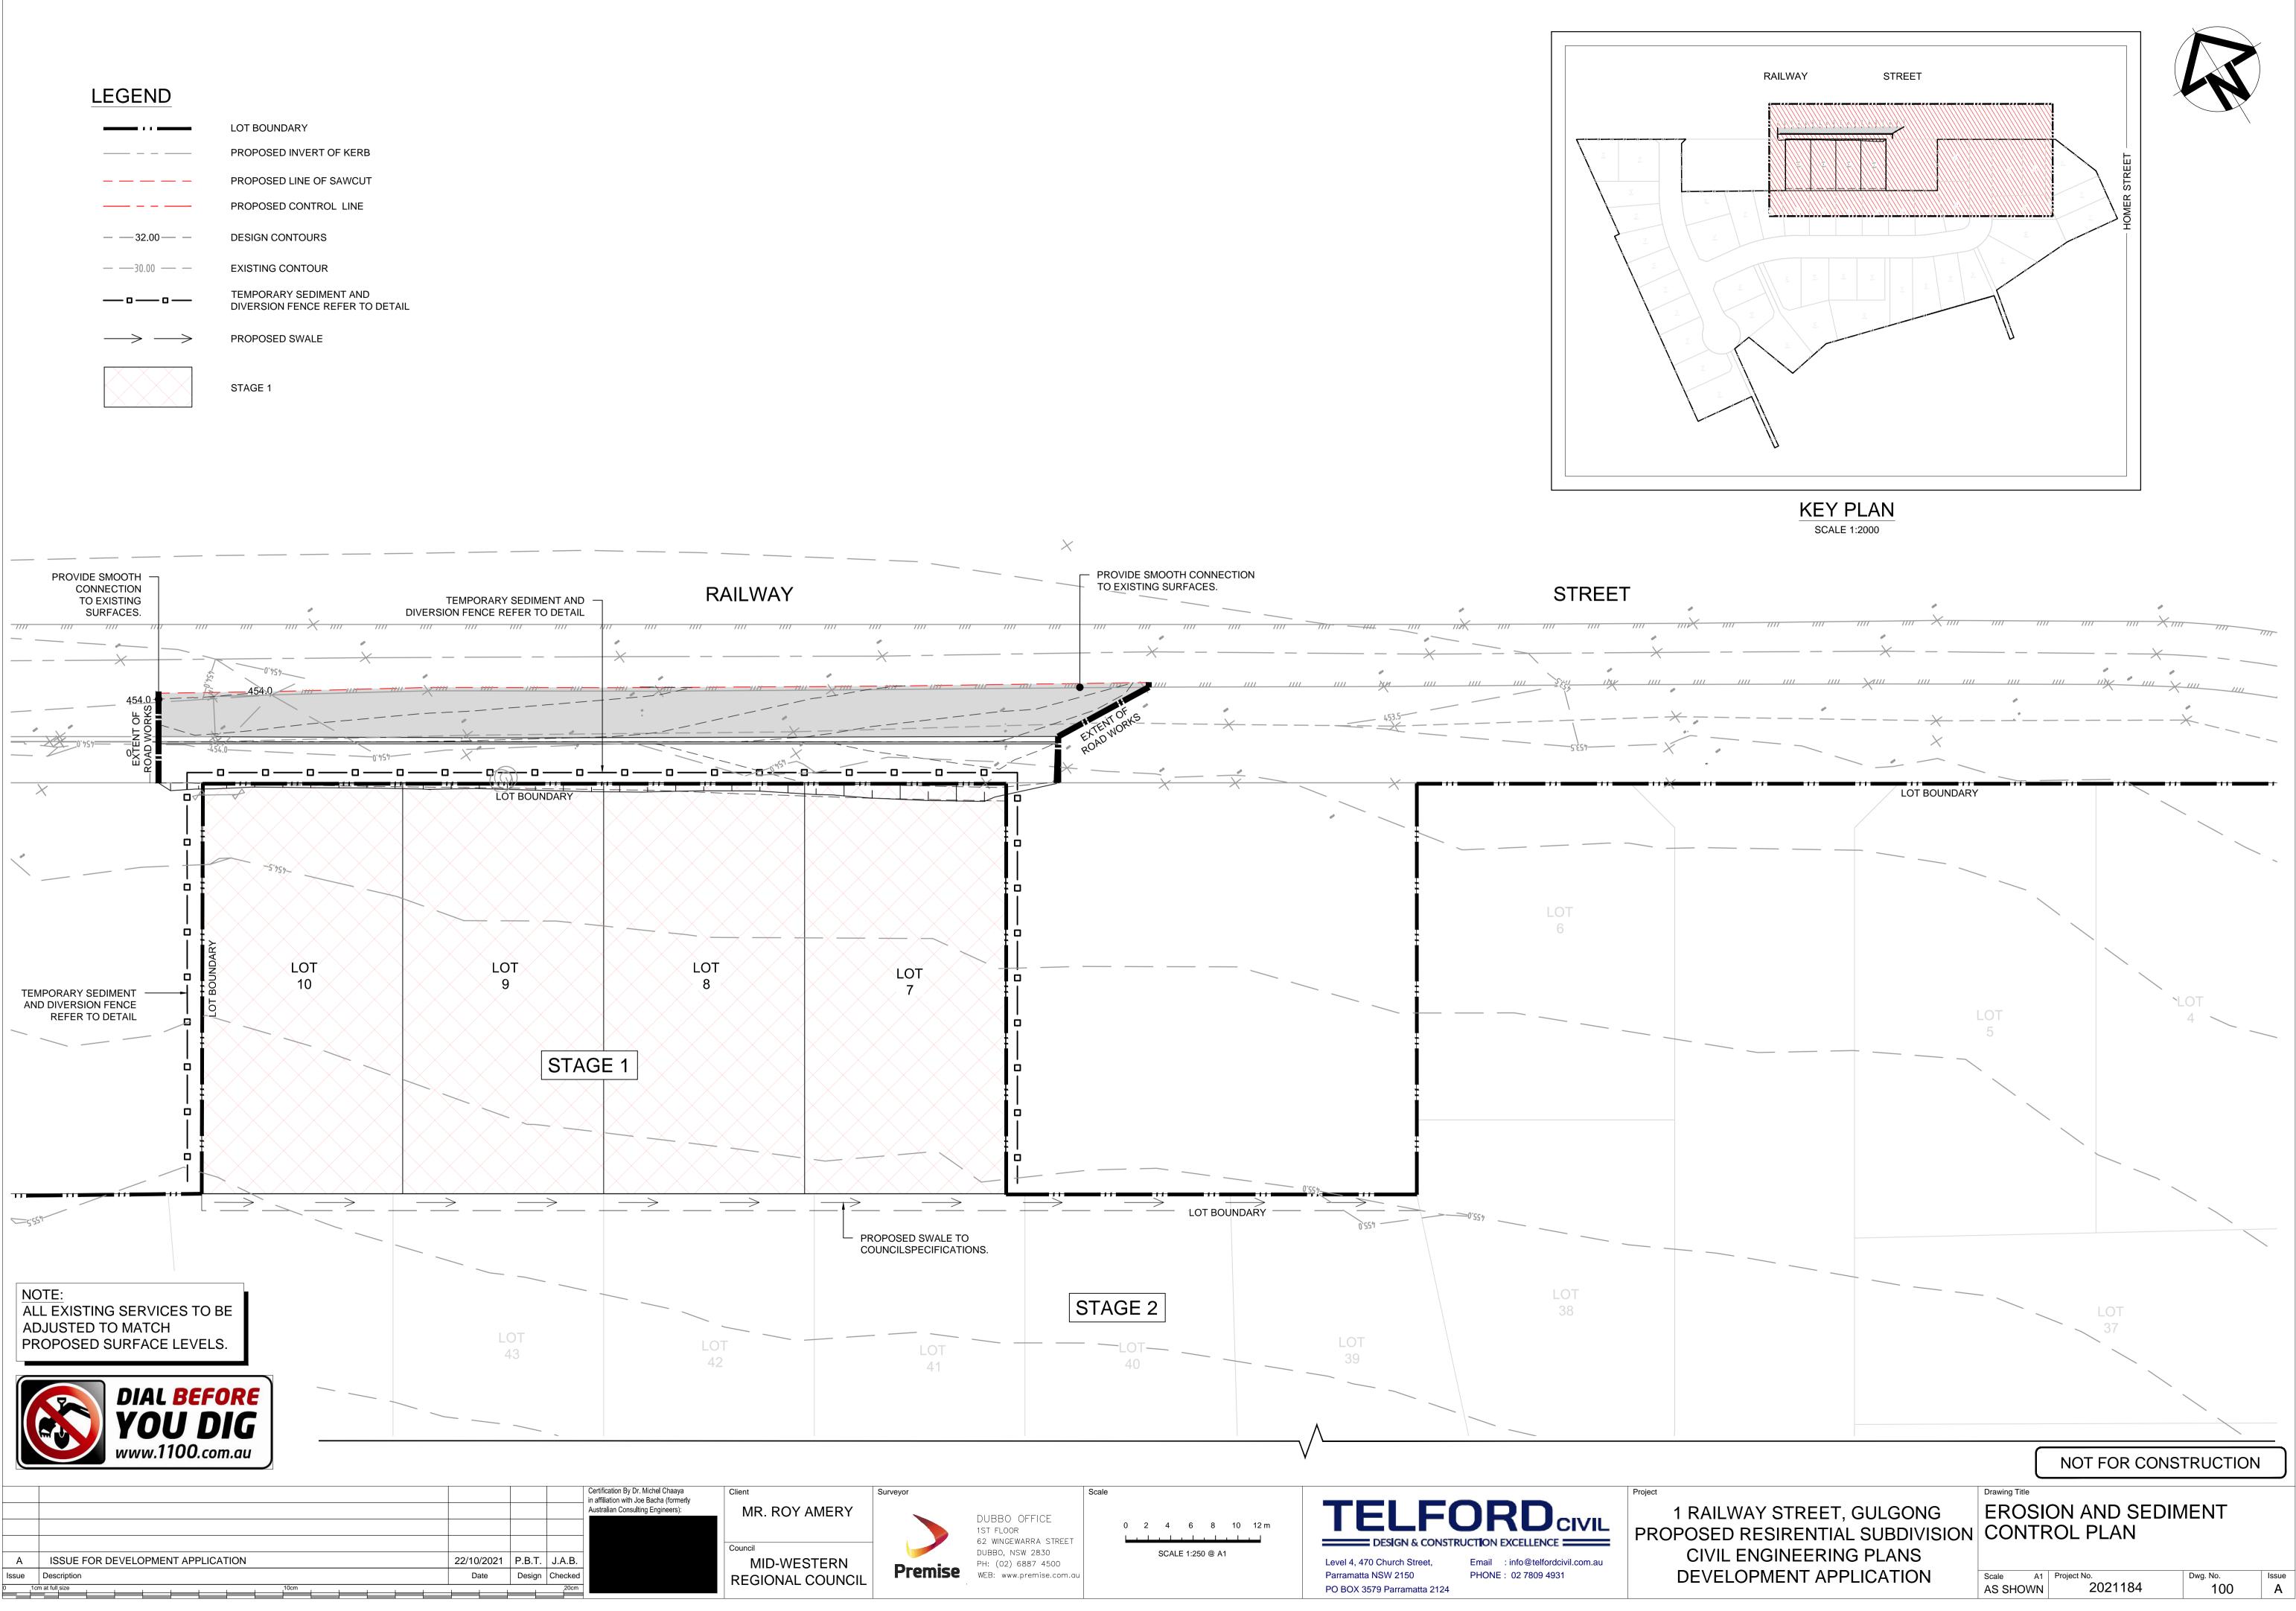
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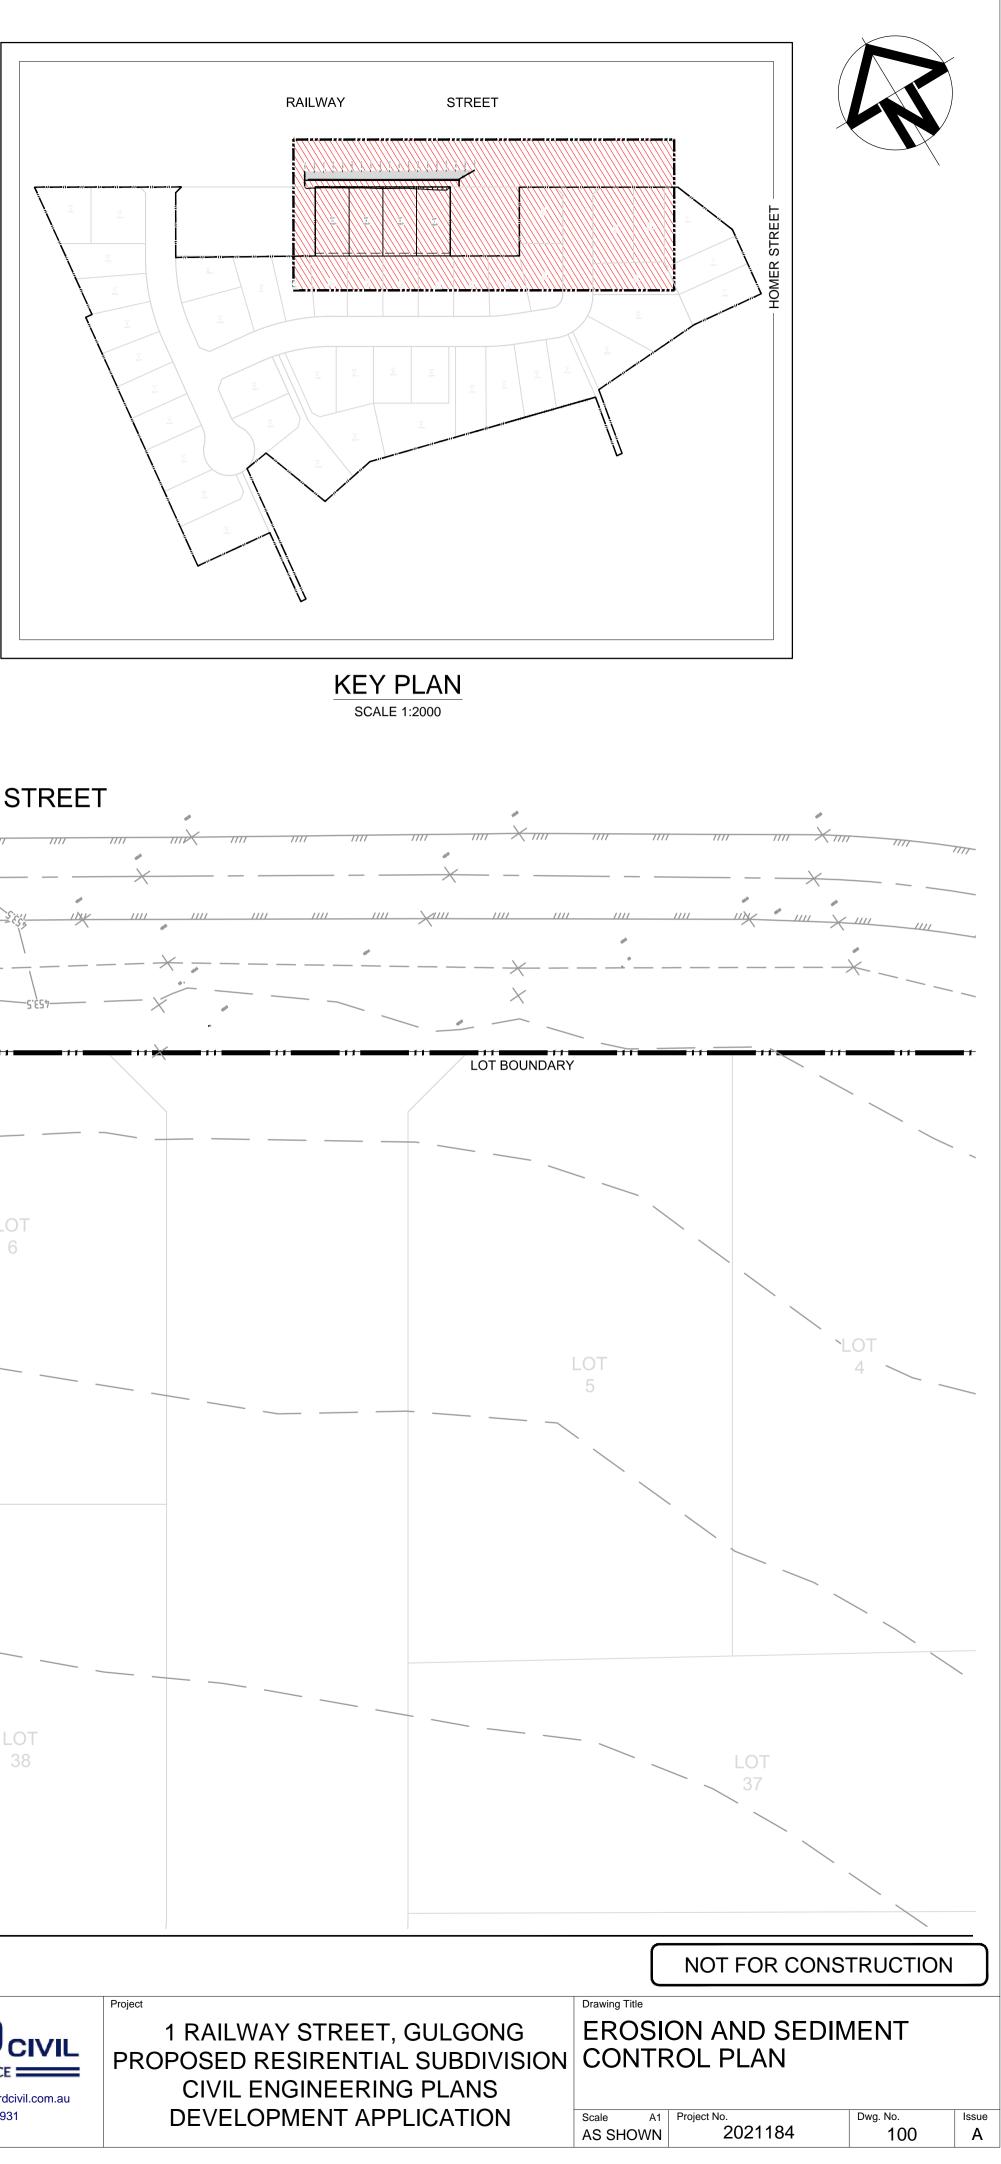
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AY STREET, GULGONG	GENERAL NOTES, LOCALITY						
<b>RESIRENTIAL SUBDIVISION</b>	SION PLAN AND DRAWING SCHEDULE						
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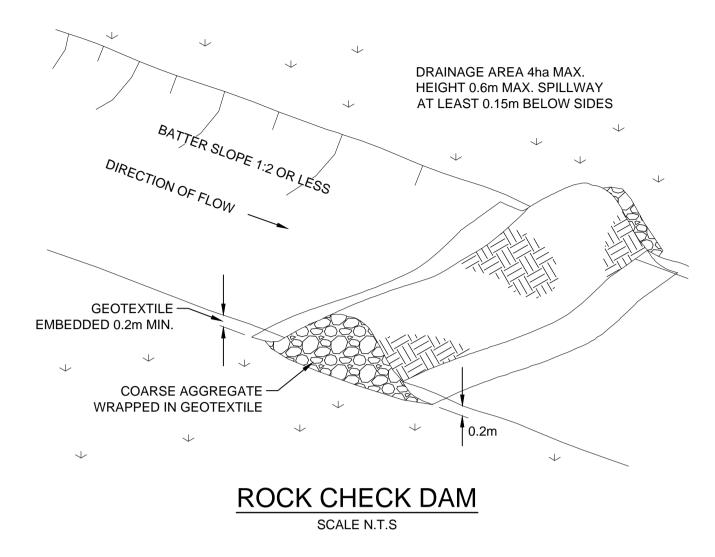


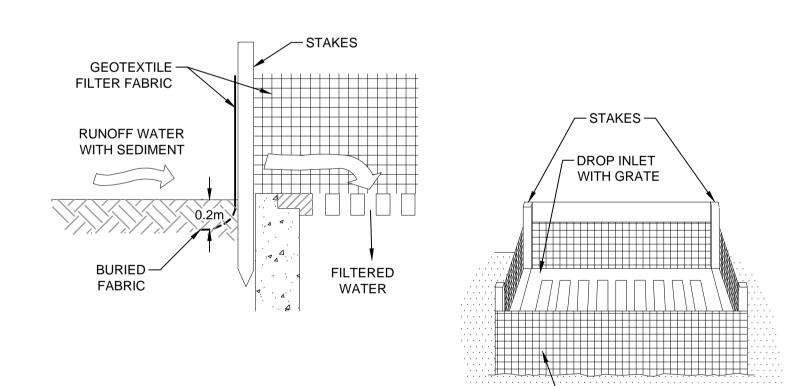












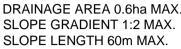
- GEOTEXTILE FILTER FBRIC

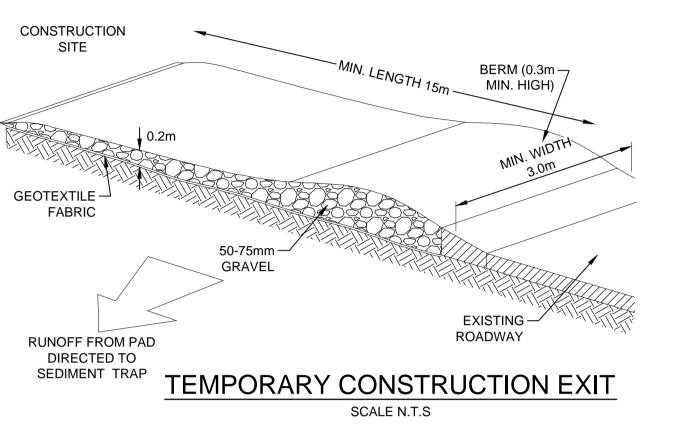
GEOTEXTILE FILTER FABRIC DROP INLET SEDIMENT TRAP SCALE N.T.S

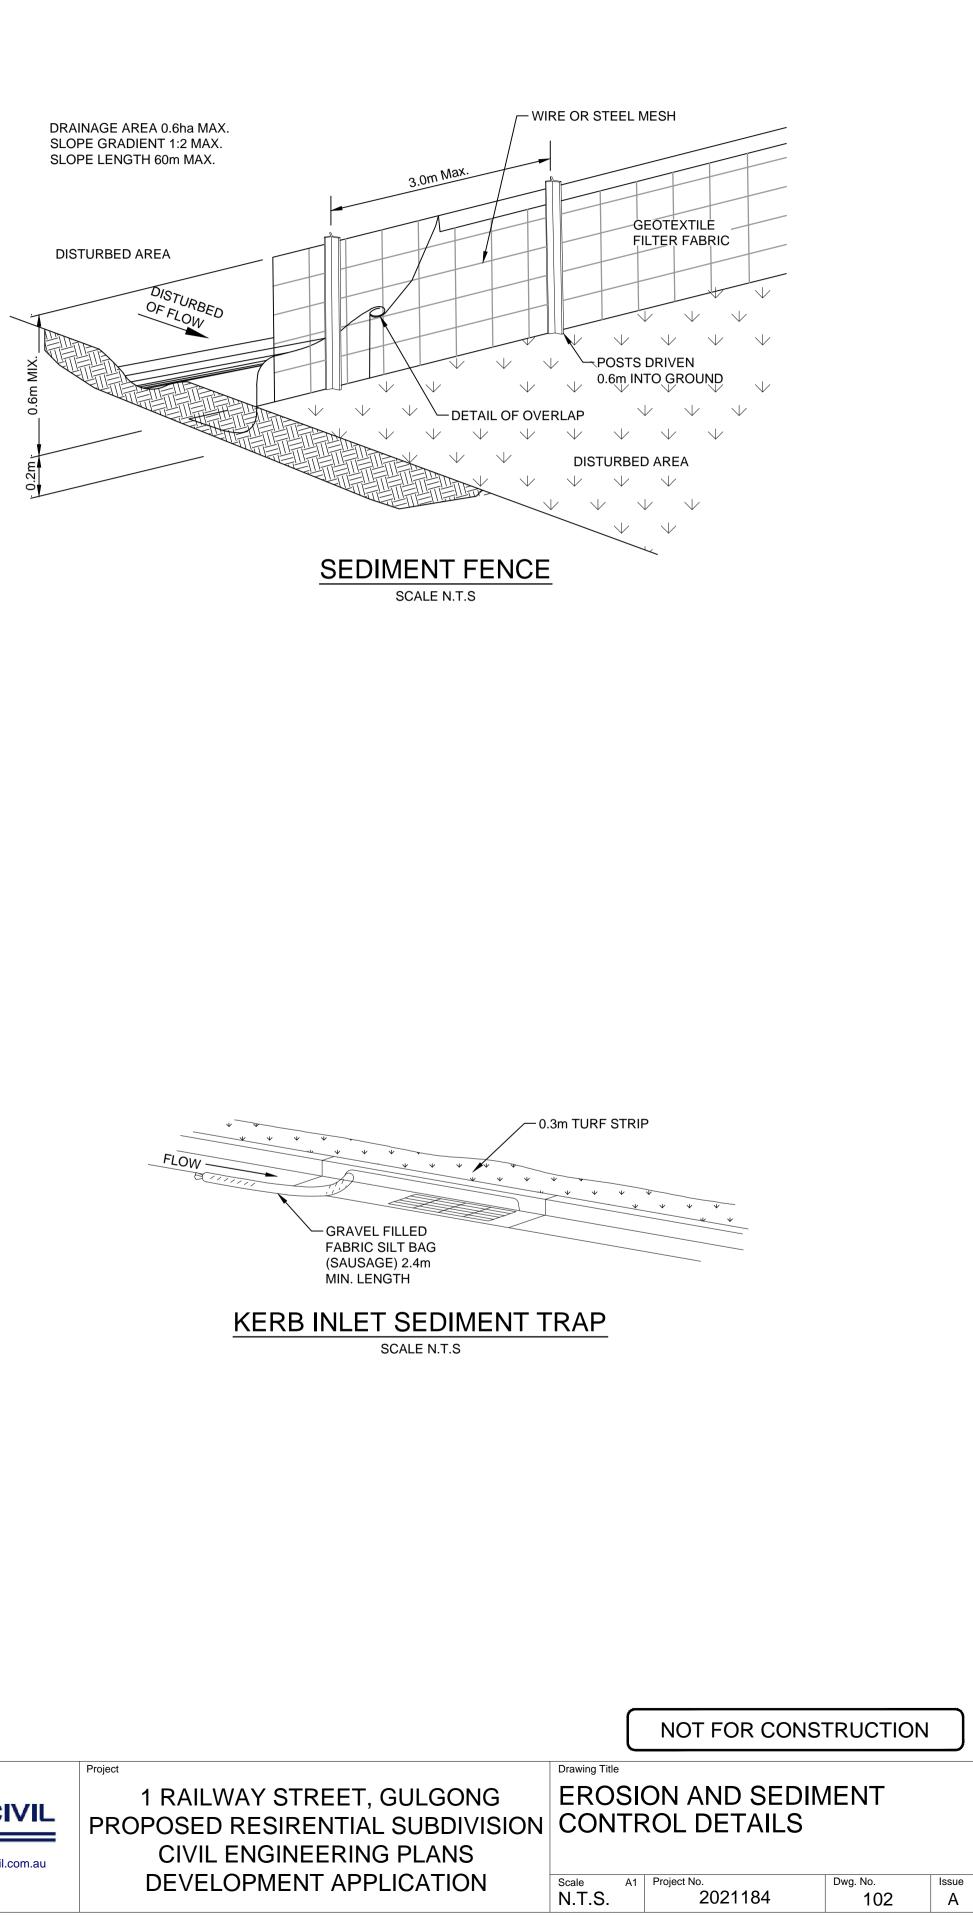
					Certification By Dr. Michel Chaaya in affiliation with Joe Bacha (formerly	Client
					Australian Consulting Engineers):	MR. ROY
					-	
A	ISSUE FOR DEVELOPMENT APPLICATION	22/10/2021	P.B.T.	J.A.B.		Council MID-WE
Issue	Description	Date	Design	Checked		REGIONAL
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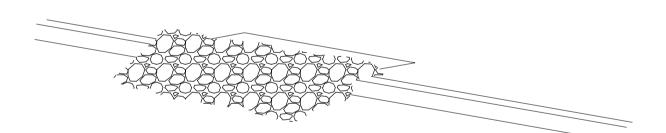
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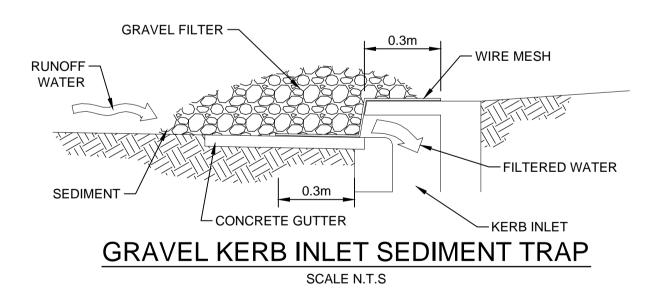
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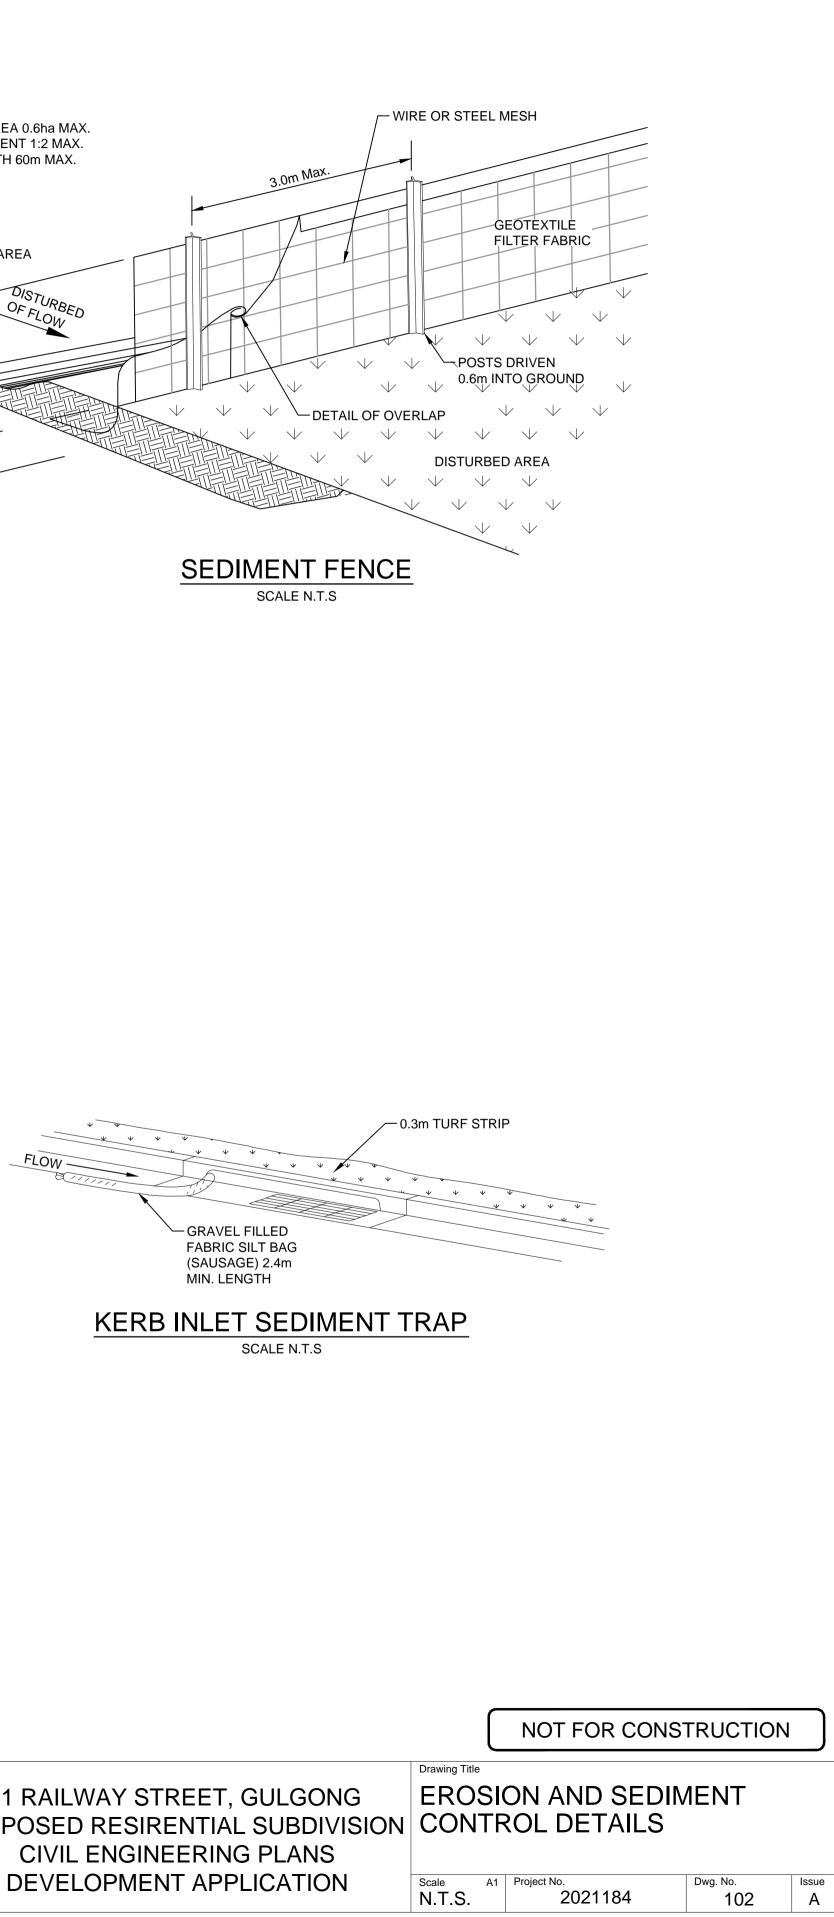


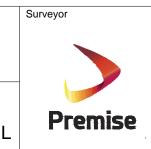








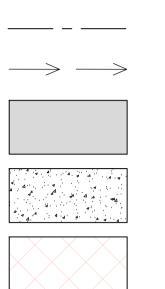




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PROVIDE SMOOTH				ERB AND GUTT SPECIFICATION
CH C	CH 10.00	CH 25.00	40 45 50	CH 55.00
Ex. K&G <sup>2</sup> 4 <sup>EA</sup> O Ex. K&G <sup>2</sup> B EXE EXT ExT ExT	W = ExW = ExT =	ExW = ExW $ExW = ExW$ $ExE = ExS$ $ExE = ExT$ $ExT = ExT$	ExS ExT ExT ExT ExT	ExWEXS EXE EXE
EXISTING KERB AND GUTTER TO REMAIN UNDISTURBED.		PROPOSED in 6 BATTER		
LOT BOUNDARY	LOT 10	LOT STA	AGE 1 LOT 8	
	SD VOLUME OF 7.3m <sup>3</sup> REQUIRED TO BE ESIGNED AS PART OF FUTURE DA/CDC	OSD VOLUME OF 7.3m <sup>3</sup> REQUIRED TO BE DESIGNED AS PART OF FUTURE DA/CDC	OSD VOLUME OF 7.3m <sup>3</sup> REQUIRED TO BE DESIGNED AS PART OF FUTURE DA/CDC	OSD R DESI F
			PROPOSED SWALE TO COUNCILSPECIFICATIONS.	
NOTE: ALL EXISTING SERVICES TO BE ADJUSTED TO MATCH PROPOSED SURFACE LEVELS.		LOT 43	LOT 42	
DIAL BEFORE YOU DIG www.1100.com.au				
A ISSUE FOR DEVELOPMENT APPLICATION		in	Council	Y AMERY ESTERN
Issue Description	10cm	Date Design Checked		L COUNCIL



STAGE 1

### PROPOSED CONCRETE FOOTPATH

### PROPOSED ROAD PAVEMENT

LOT BOUNDARY		
	Ex. K&G	EXISTING KERB & GUTTER
PROPOSED KERB & GUTTER		EXISTING KERB & GUTTER
	——— E×W ———	EXISTING WATER MAIN
(CONTROL LINE)	———— ExT ———	EXISTING TELSTRA MAIN
FINISHED CONTOURS	———— ExE ———	EXISTING ELECTRICAL MAIN
PROPOSED ROAD CENTERLINE	——— ExS ———	EXISTING SEWER MAIN
PROPOSED SWALE		EXISTING EDGE OF BITUMEN

PROPOSED KERB AND GUTTER

TO COUNCIL SPECIFICATIONS.

\_\_\_\_\_

EXISTING ROAD CENTRE LINE

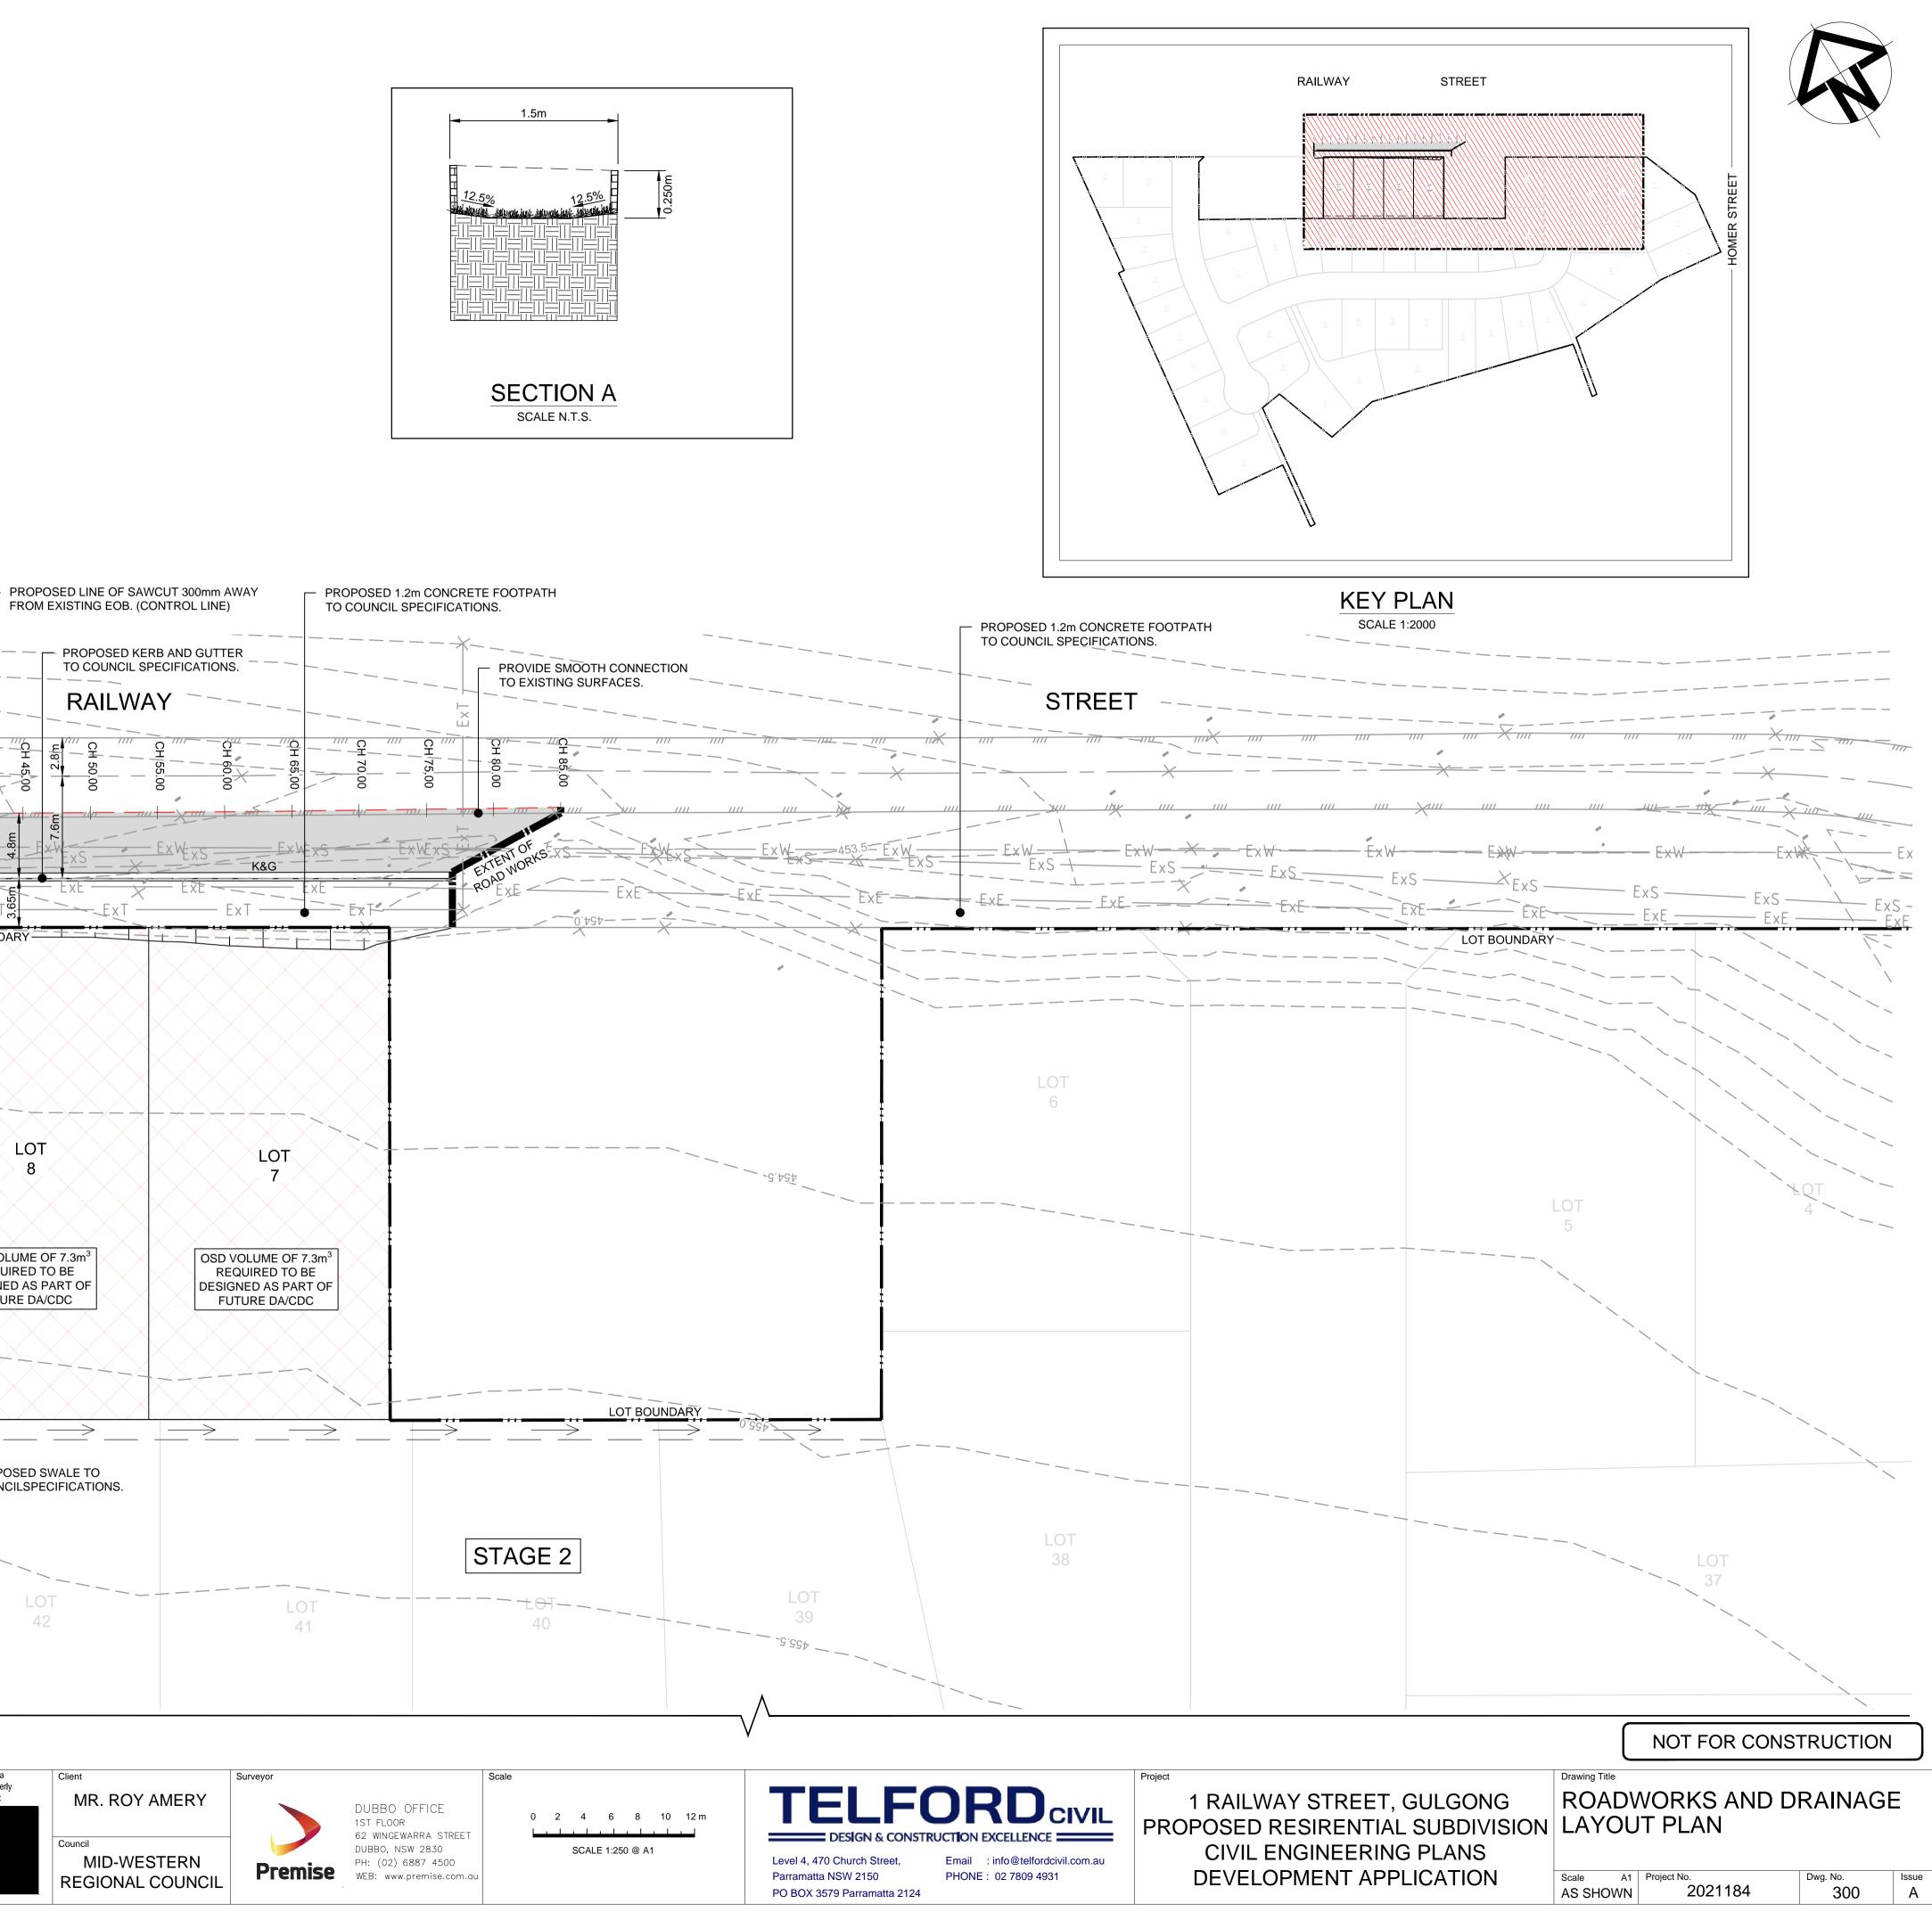
EXISTING EDGE

OF BITUMEN

# LEGEND

K&G

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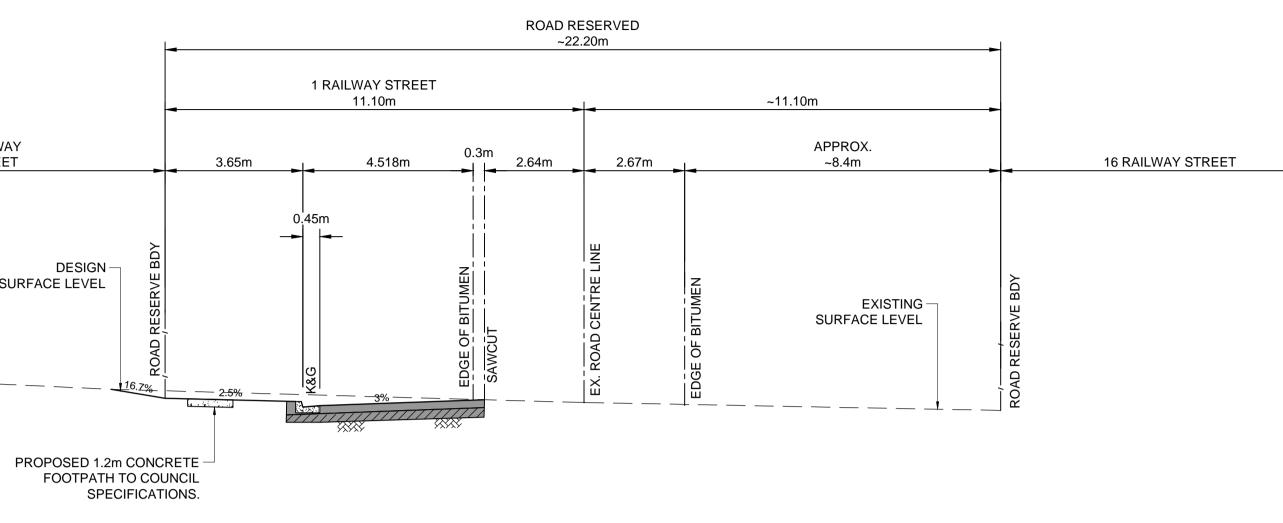
1 . RAILWAY STREET

> DESIGN SURFACE LEVEL

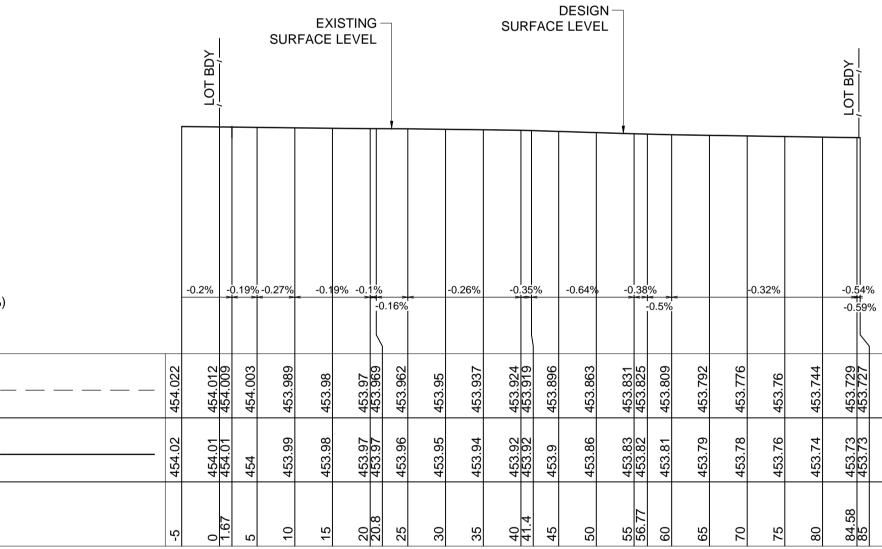
VERTICAL GRADE (%)

DATUM R.L. 448.00
EXISTING ROAD LEVEL
PROPOSED _ ROAD LEVEL
CHAINAGE

Certification By Dr. Michel Chaaya in affiliation with Joe Bacha (formerly Australian Consulting Engineers): Client MR. ROY AMERY Council ISSUE FOR DEVELOPMENT APPLICATION 22/10/2021 P.B.T. J.A.B. MID-WESTERN А Issue Description Date Design Checked **REGIONAL COUNCIL** 
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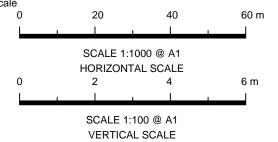
# CROSS SECTION (RAILWAY STREET) SCALE 1:50



# RAILWAY STREET - LONGITUDINAL SECTION (CONTROL LINE SAWCUT) SCALE (H) 1:500 (V) 1:100



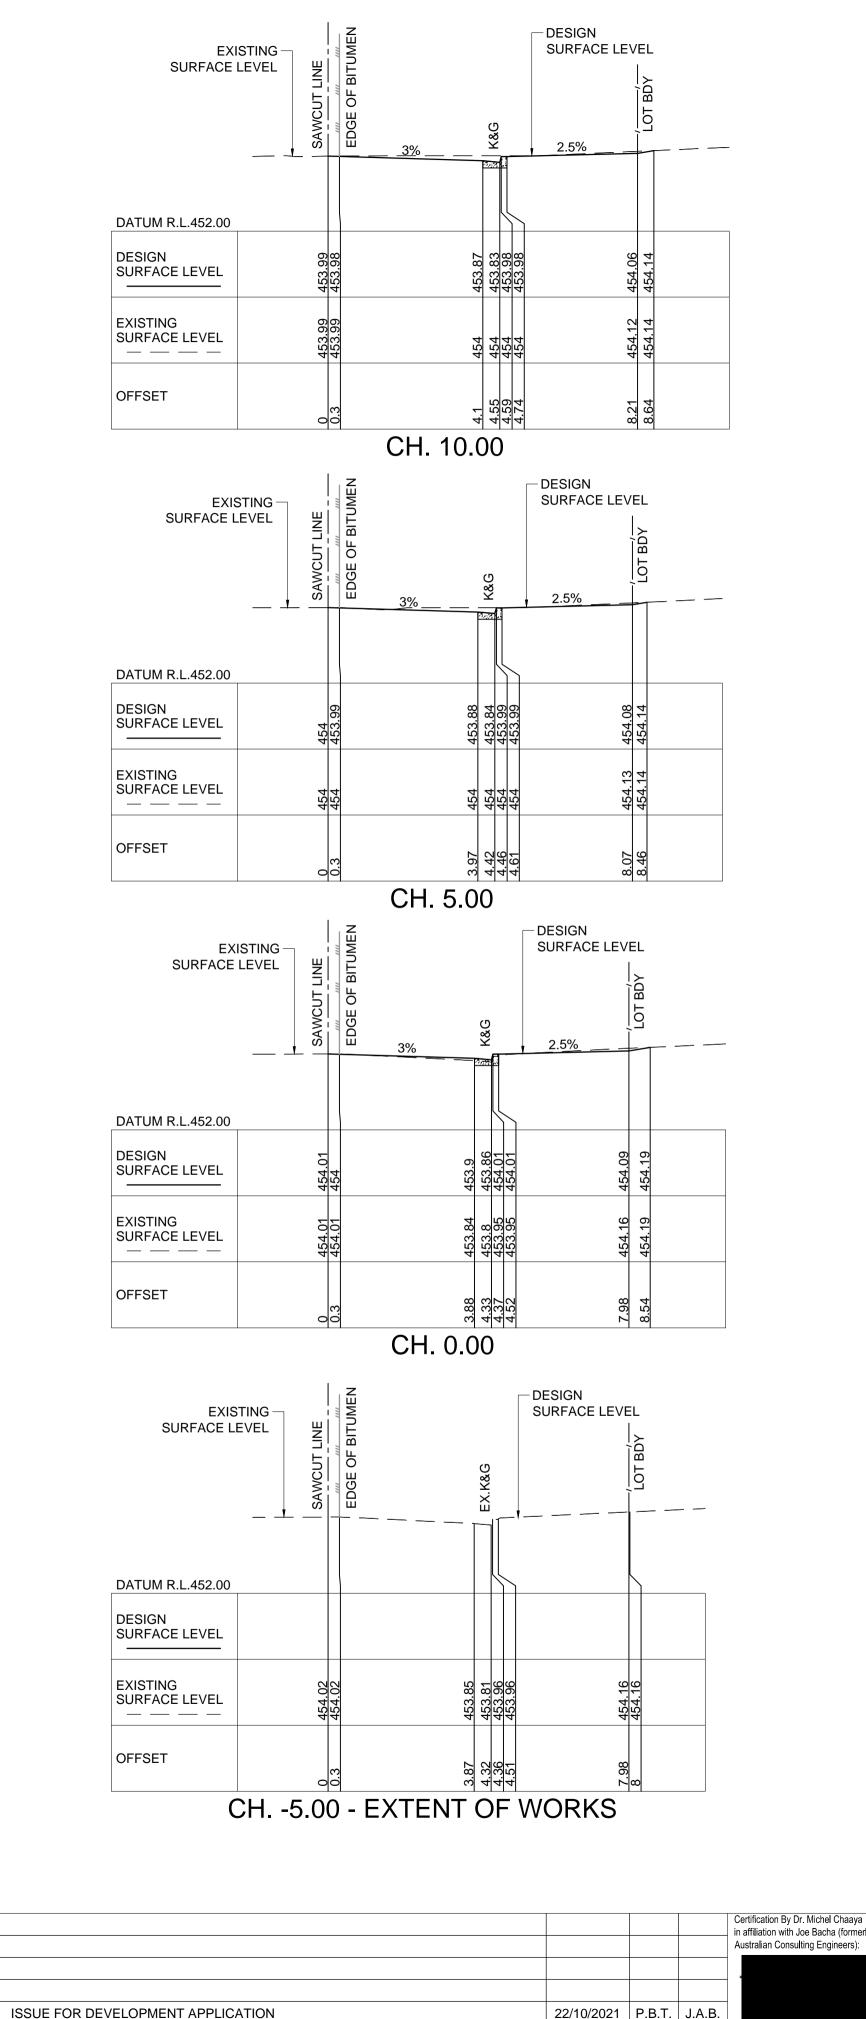






Project 1 RAILWA PROPOSED R CIVIL EN DEVELO

0 1 2 3 m					
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Drawing Title					
RAILWAY STREET					
ON LONGITUDINAL SECTION AND					
TYPICAL CROSS SECTION					
Scale         A1         Project No.         Dwg. No.         Issu           AS SHOWN         2021184         302         A					
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DESIGN EXISTING

OFFSET

DESIGN \_\_\_\_\_ EXISTING OFFSET

DESIGN \_\_\_\_\_ EXISTING

DESIGN EXISTING OFFSET

Council MID-WESTERN **REGIONAL COUNCIL** 

Client



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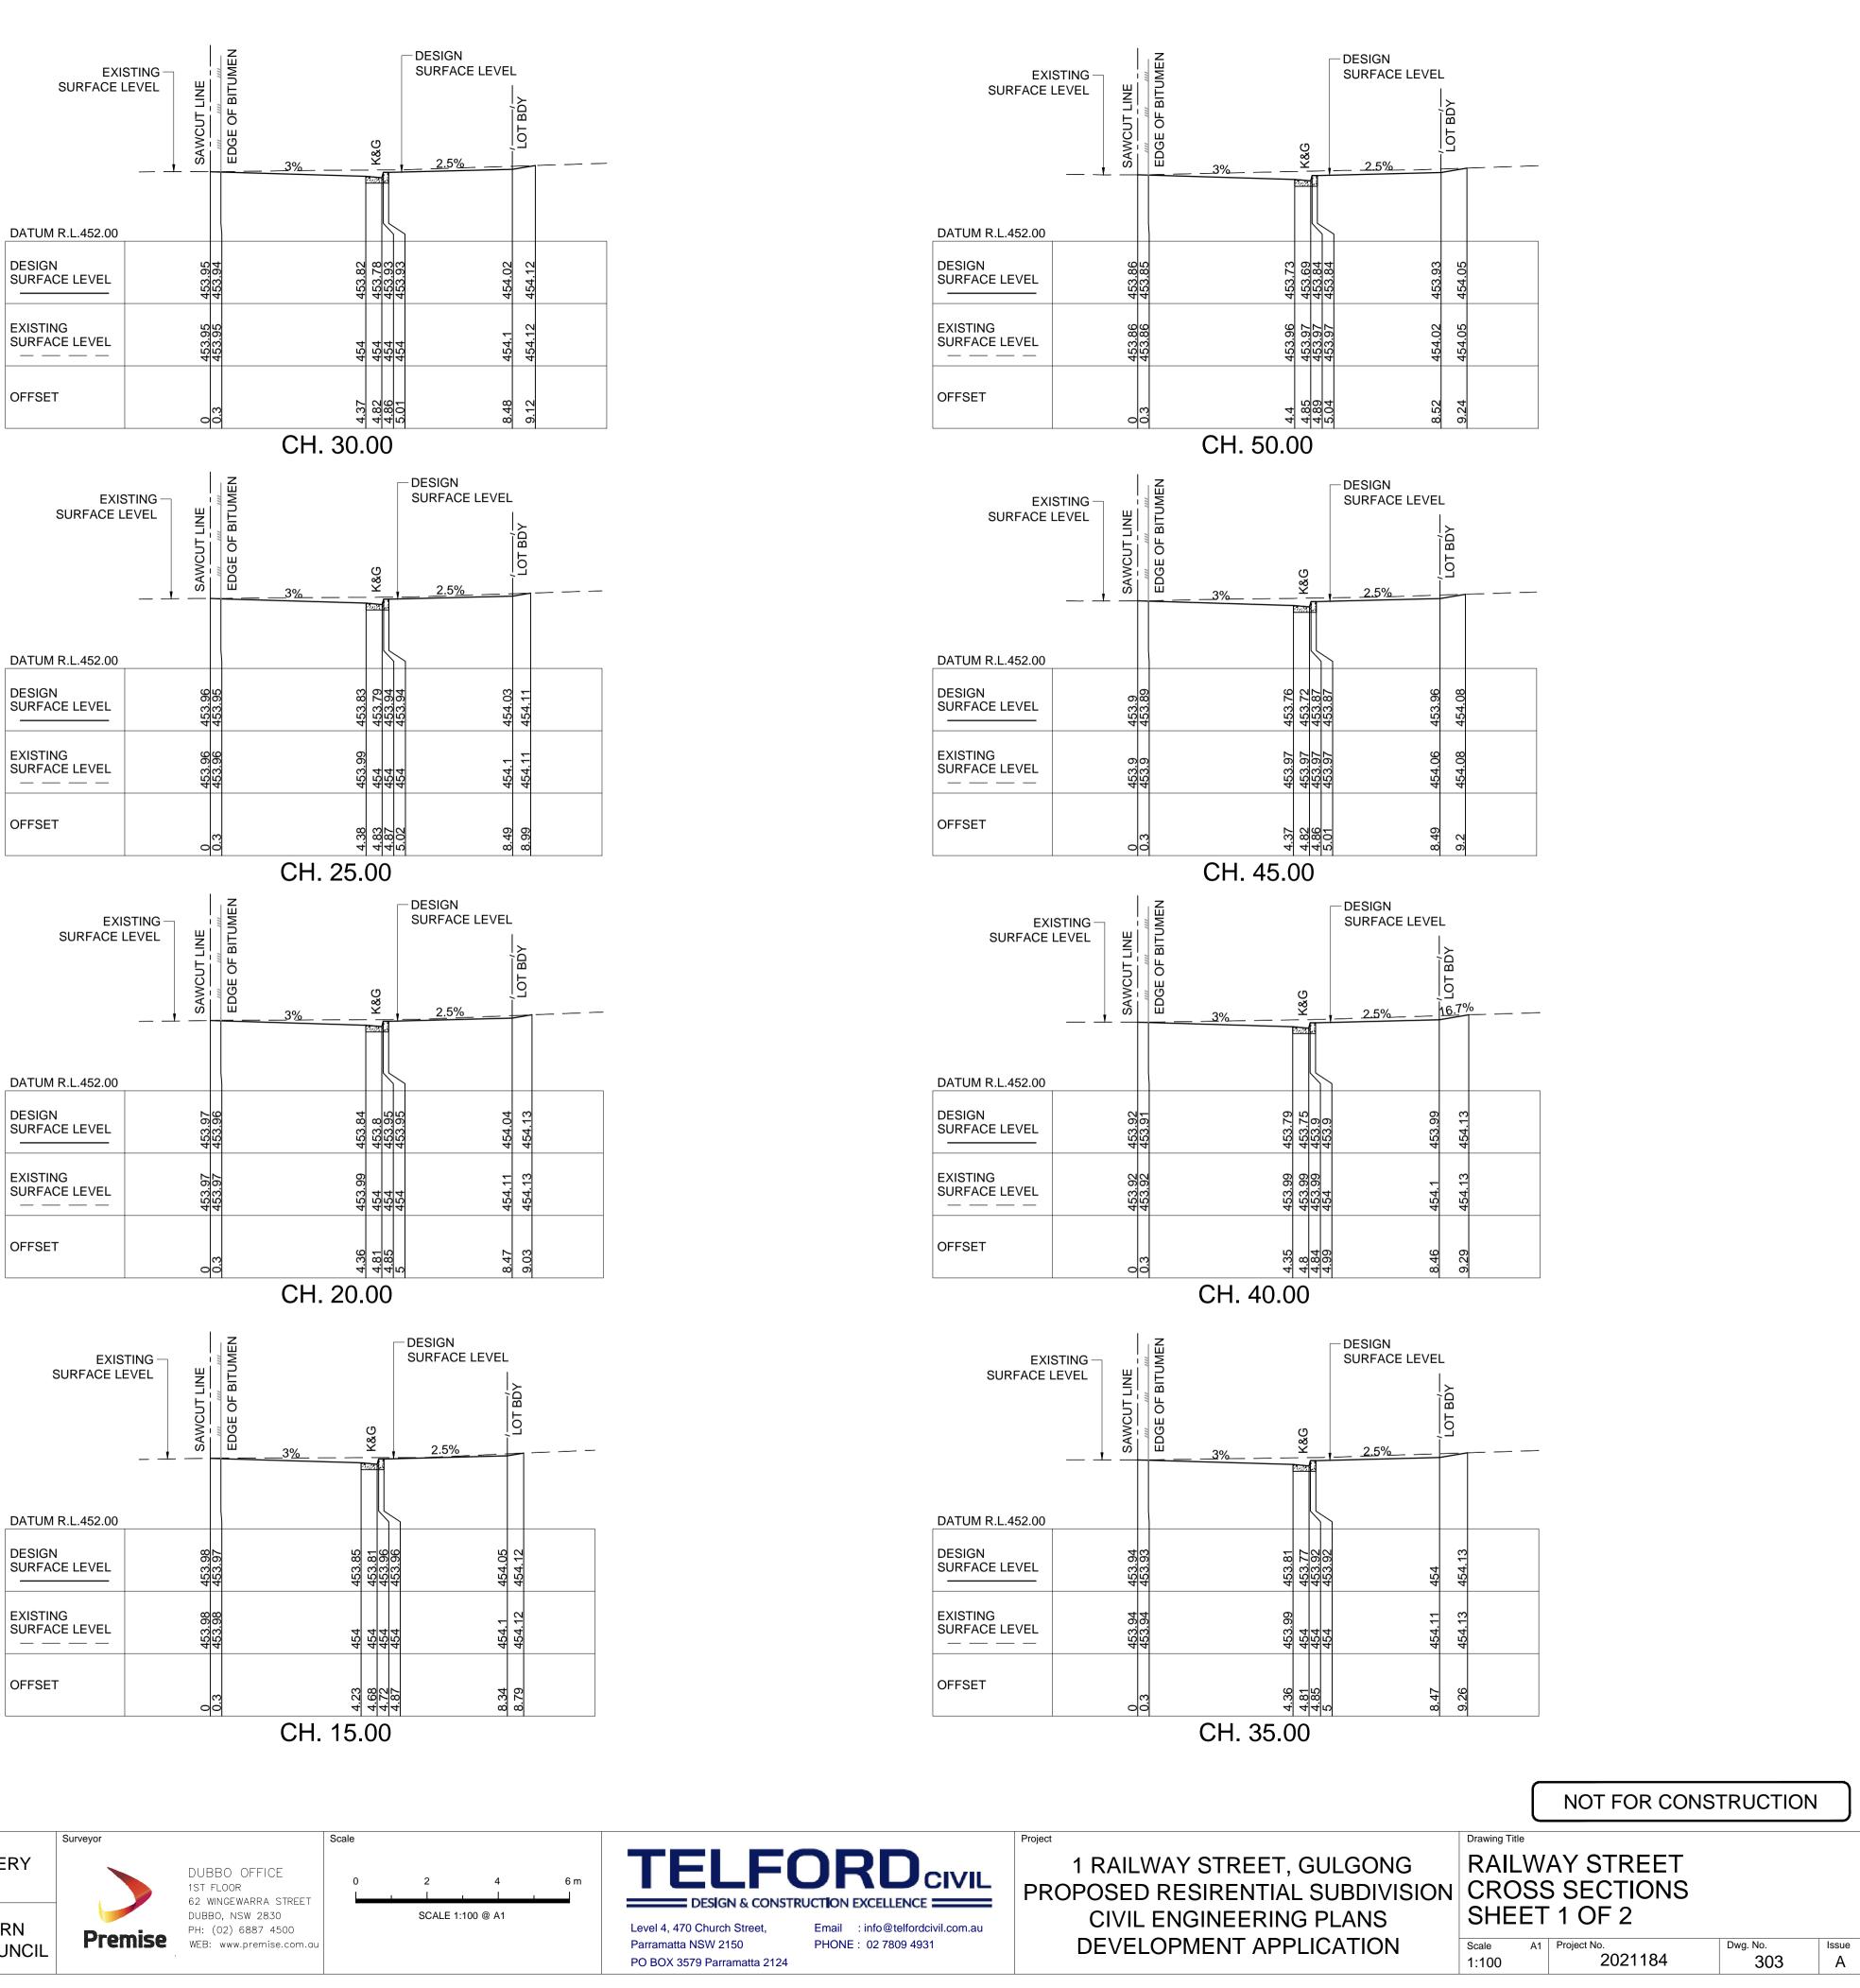
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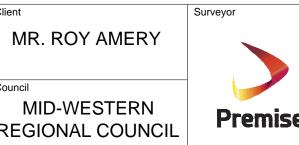
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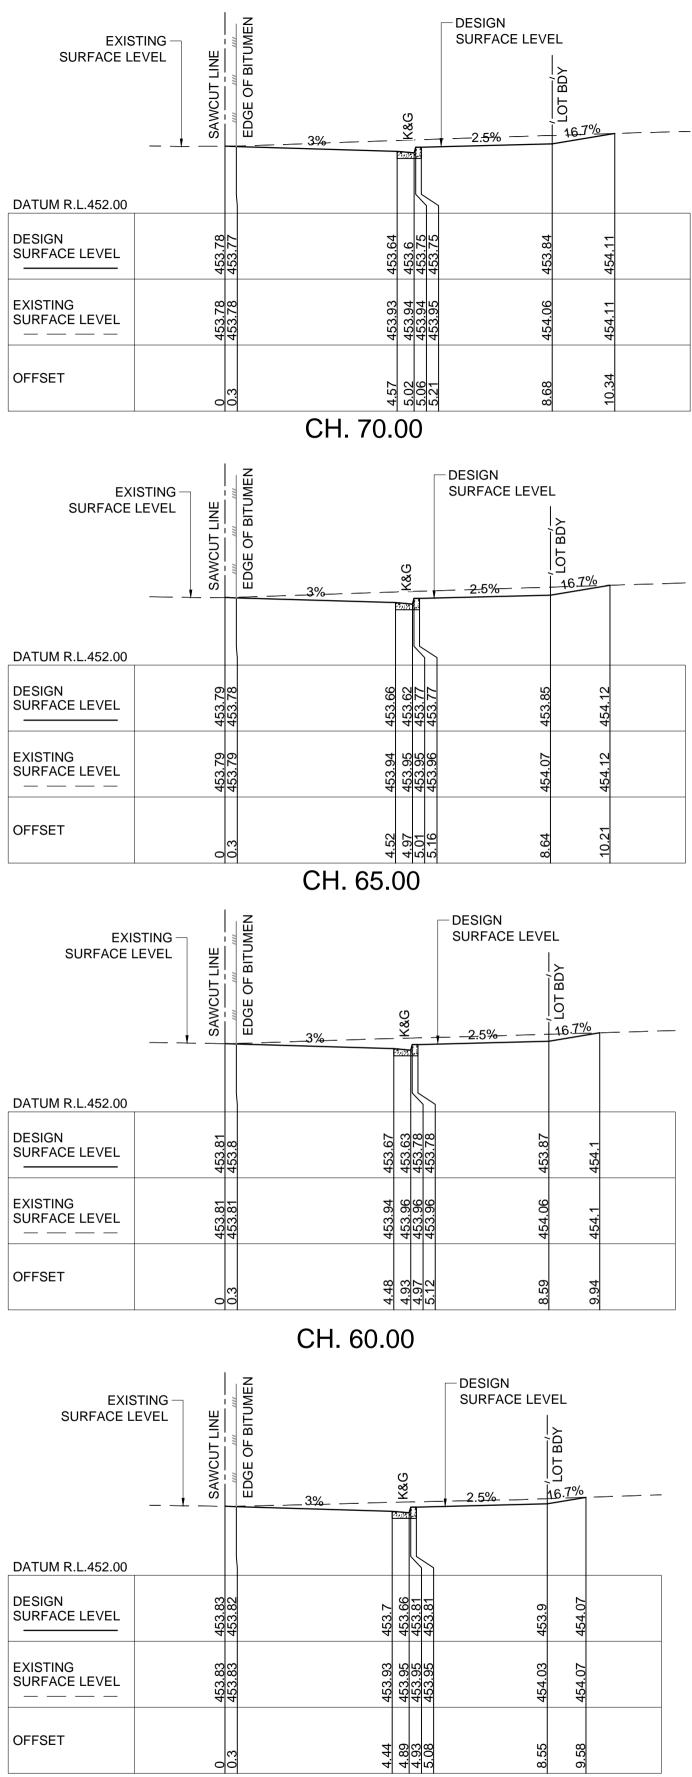
22/10/2021 P.B.T. J.A.B. Design Checked 20cm

in affiliation with Joe Bacha (formerly Australian Consulting Engineers):



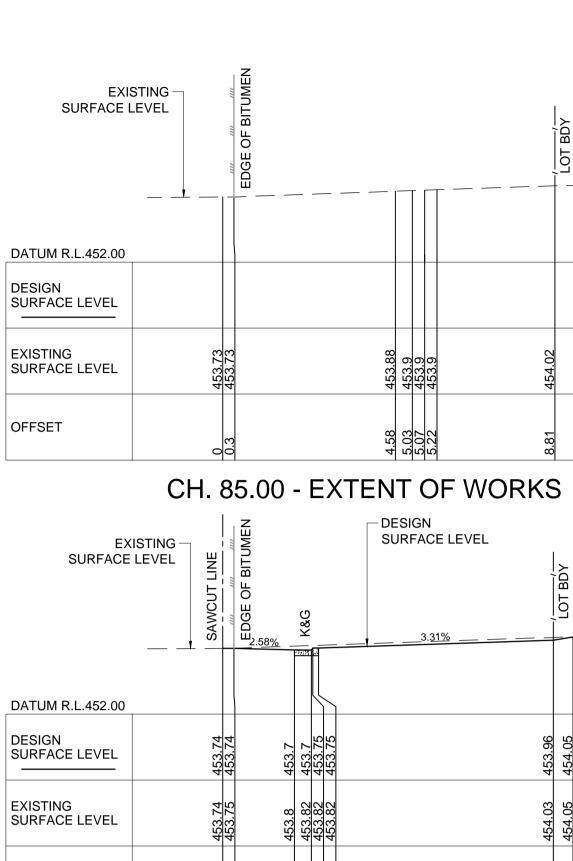




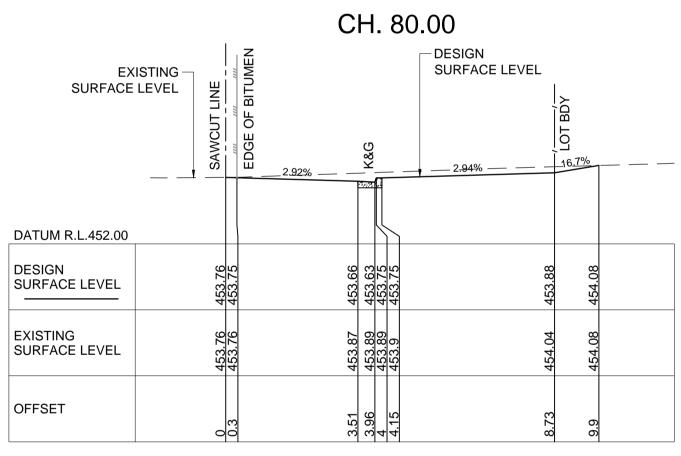


CH. 55.00

					Certification By Dr. Michel Chaaya in affiliation with Joe Bacha (formerly Australian Consulting Engineers):	Client MR. ROY AMERY
						Council
A	ISSUE FOR DEVELOPMENT APPLICATION	22/10/2021	P.B.T.	J.A.B.		MID-WESTERN
Issue	Description	Date	Design	Checked		<b>REGIONAL COUNCI</b>
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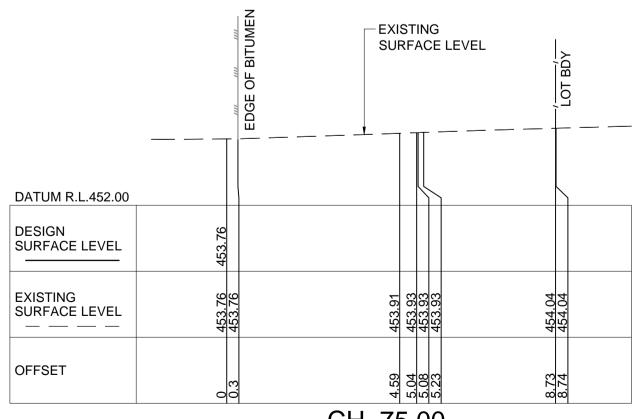
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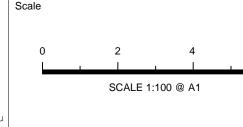
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Project 1 RAILWA PROPOSED RE CIVIL EN DEVELOP

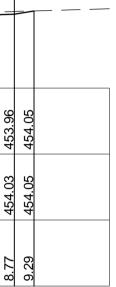






6 m

	NOT FOR CON	STRUCTION	
CROSS	<b>SECTIONS</b>		
Scale A1 1:100	Project No. 2021184	Dwg. No. <b>304</b>	Issue A
	RAILW CROSS SHEET	Drawing Title RAILWAY STREET CROSS SECTIONS SHEET 2 OF 2 Scale A1 Project No.	RAILWAY STREET CROSS SECTIONS SHEET 2 OF 2 Scale A1 Project No. Dwg. No.







# LEGEND

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LOT BOUNDARY FINISH CONTOURS EXISTING CONTOURS PROPOSED SWALE PROPOSED EASEMENT CATCHMENT NUMBER

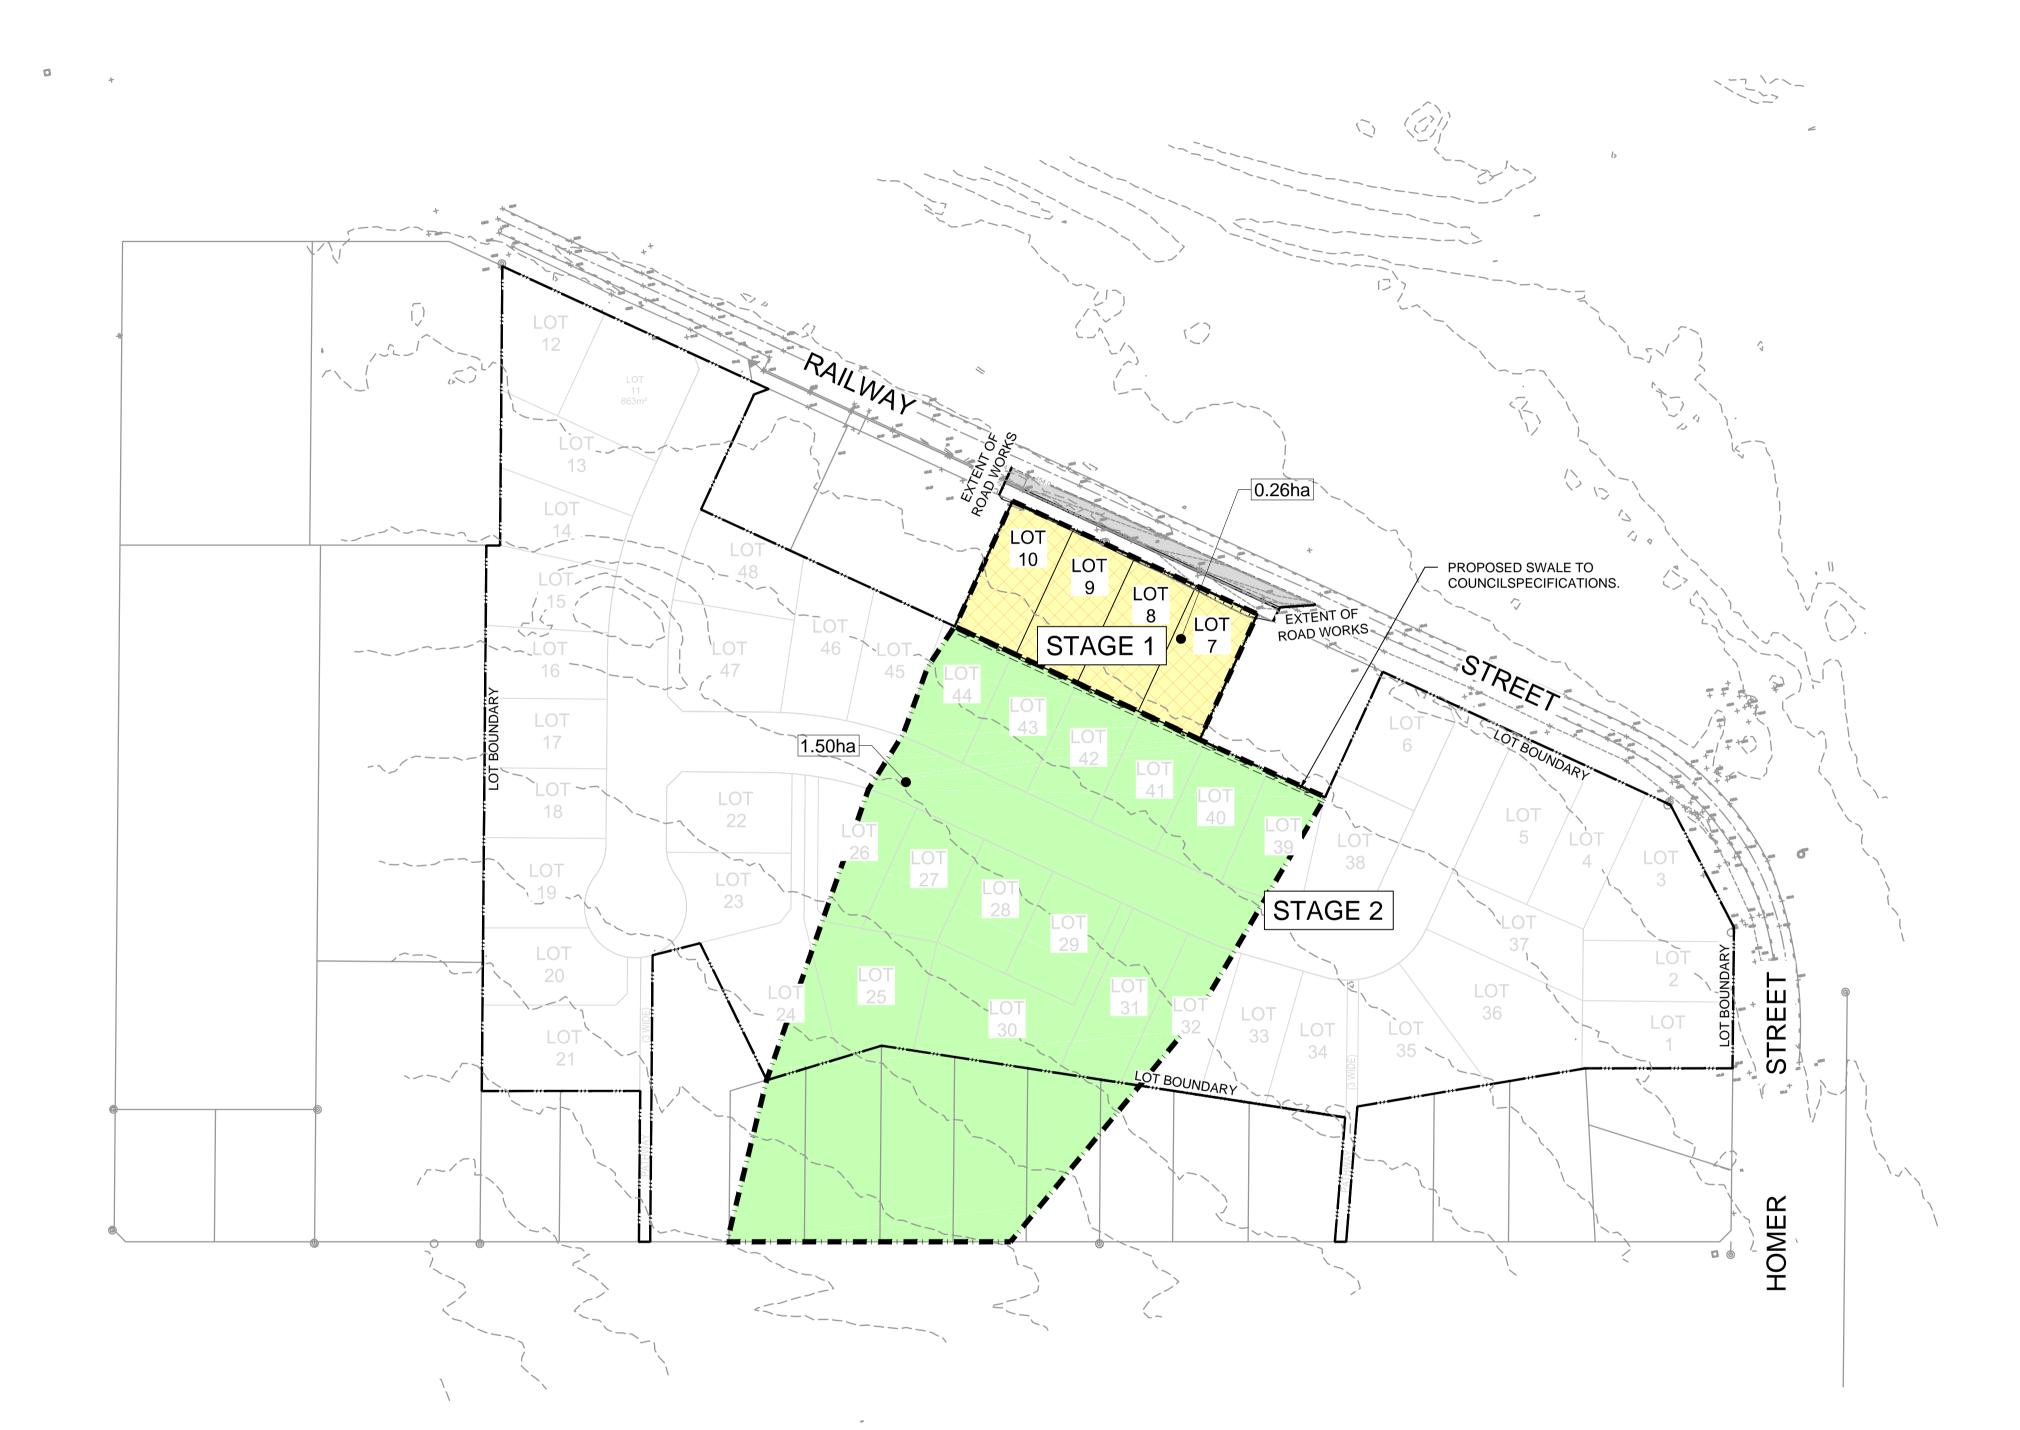
CATCHMENT 1

CATCHMENT 2

STAGE 1

PROPOSED STORMWATER PIT

PROPOSED STORMWATER PIPE



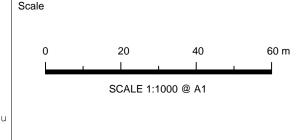
NOTE: ALL EXISTING SERVICES TO BE ADJUSTED TO MATCH PROPOSED SURFACE LEVELS.



				Certification By Dr. Michel Chaaya in affiliation with Joe Bacha (formerly Australian Consulting Engineers):	Client MR. ROY AMERY
					Council
Α	ISSUE FOR DEVELOPMENT APPLICATION	22/10/2021	P.B.T. J.A.B.		MID-WESTERN
Issue	Description	Date	Design Checked		REGIONAL COUNCIL
0 1c	m at full size 10cm		20cm		

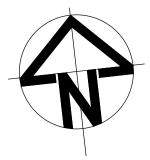


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Project 1 RAILWA PROPOSED R CIVIL EN DEVELOF



	Drawing Title			
AY STREET, GULGONG RESIRENTIAL SUBDIVISION NGINEERING PLANS	STORMWATER CATCHMENT PLAN			
PMENT APPLICATION	Scale A1 1:1000	Project No. 2021184	Dwg. No. <b>400</b>	Issue A

NOT FOR CONSTRUCTION