


INDUSTRIAL UNITS LOTS 4, 5, 6 & 7 DP1116874 WILKINS CRESCENT, MUDGEES NSW 2850 CIVIL DRAWINGS

DRAWINGS LIST

- C1.00 COVER SHEET
- C1.01 GENERAL NOTES
- C2.00 EXISTING SITE PLAN
- C2.01 EROSION AND SEDIMENT CONTROL PLAN
- C3.00 STORMWATER MANAGEMENT PLAN
- C4.00 SWEEP PATHS
- C5.00 TRAFFIC CONTROL PLAN
- C6.00 SEWER PLAN
- C6.01 BUILDING CROSS SECTION

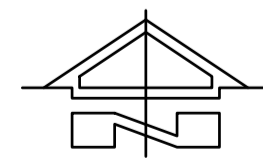

LOCATION PLAN
SCALE 1:1000 AT A1

10.0m 0.0 20.0 40.0 60.0 80.0 100.0m
SCALE 1:1000 AT A1 SHEET | 1:2000 AT A3 SHEET

AMENDMENTS	DATE	ISSUE	BY
ISSUED FOR CONSTRUCTION	26.02.21	1	J.D.
ISSUED FOR CONSTRUCTION	10.02.221	0	J.D.
ISSUED FOR APPROVAL	26-08-2020	A	Ra.S

ARCHITECT
GISELLE DENLY DRAFTING
53 HILL SIXTY DRIVE
MUDGEES NSW 2850

CLIENT
SWORDS GROUP
UNIT 5/13 SYDNEY ROAD
MUDGEES NSW 2850

PROJECT
PROPOSED INDUSTRIAL UNITS
LOTS 4-7 WILKINS CRESCENT
MUDGEES NSW 2850

DESIGNED -- DRAWN -- DATE FEB 21 SIZE AS NOTED CAD REF TX14938.00 - C01



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ADELAIDE | BAROSSA | DARWIN | MUDGEES | PARRAMATTA | SYDNEY



DRAWING TITLE
COVER SHEET

PROJECT No. **TX14938.00** - DRAWING No. **C1.00** ISSUE **1**


FOR CONSTRUCTION

NOTE:
 1. THIS IS AN ENGINEERING SURVEY PLAN AND SHALL NOT BE TAKEN AS A CADASTRAL OR IDENTIFICATION SURVEY. BOUNDARY DATA IF SHOWN, SHOULD BE TAKEN AS A GUIDE ONLY.
 2. REFER TO THE CERTIFICATE OF TITLE FOR EASEMENT DETAILS (IF ANY).
 3. NO UNDERGROUND SERVICES HAVE BEEN LOCATED.
 4. TBM 100.00 - TO BE CONFIRMED

SYMBOL	DESCRIPTION
	SPOT LEVEL
	CONTOUR MAJOR (Xm)
	CONTOUR MINOR (Xm)
	FENCE
	BOUNDARY
	DRAINAGE LINE
	SEWER LINE
	WATER LINE
	POWER U/G
	POWER O/H
	TELSTRA LINE
	GAS LINE
	ROAD CENTRELINE
	TREE

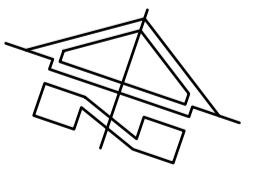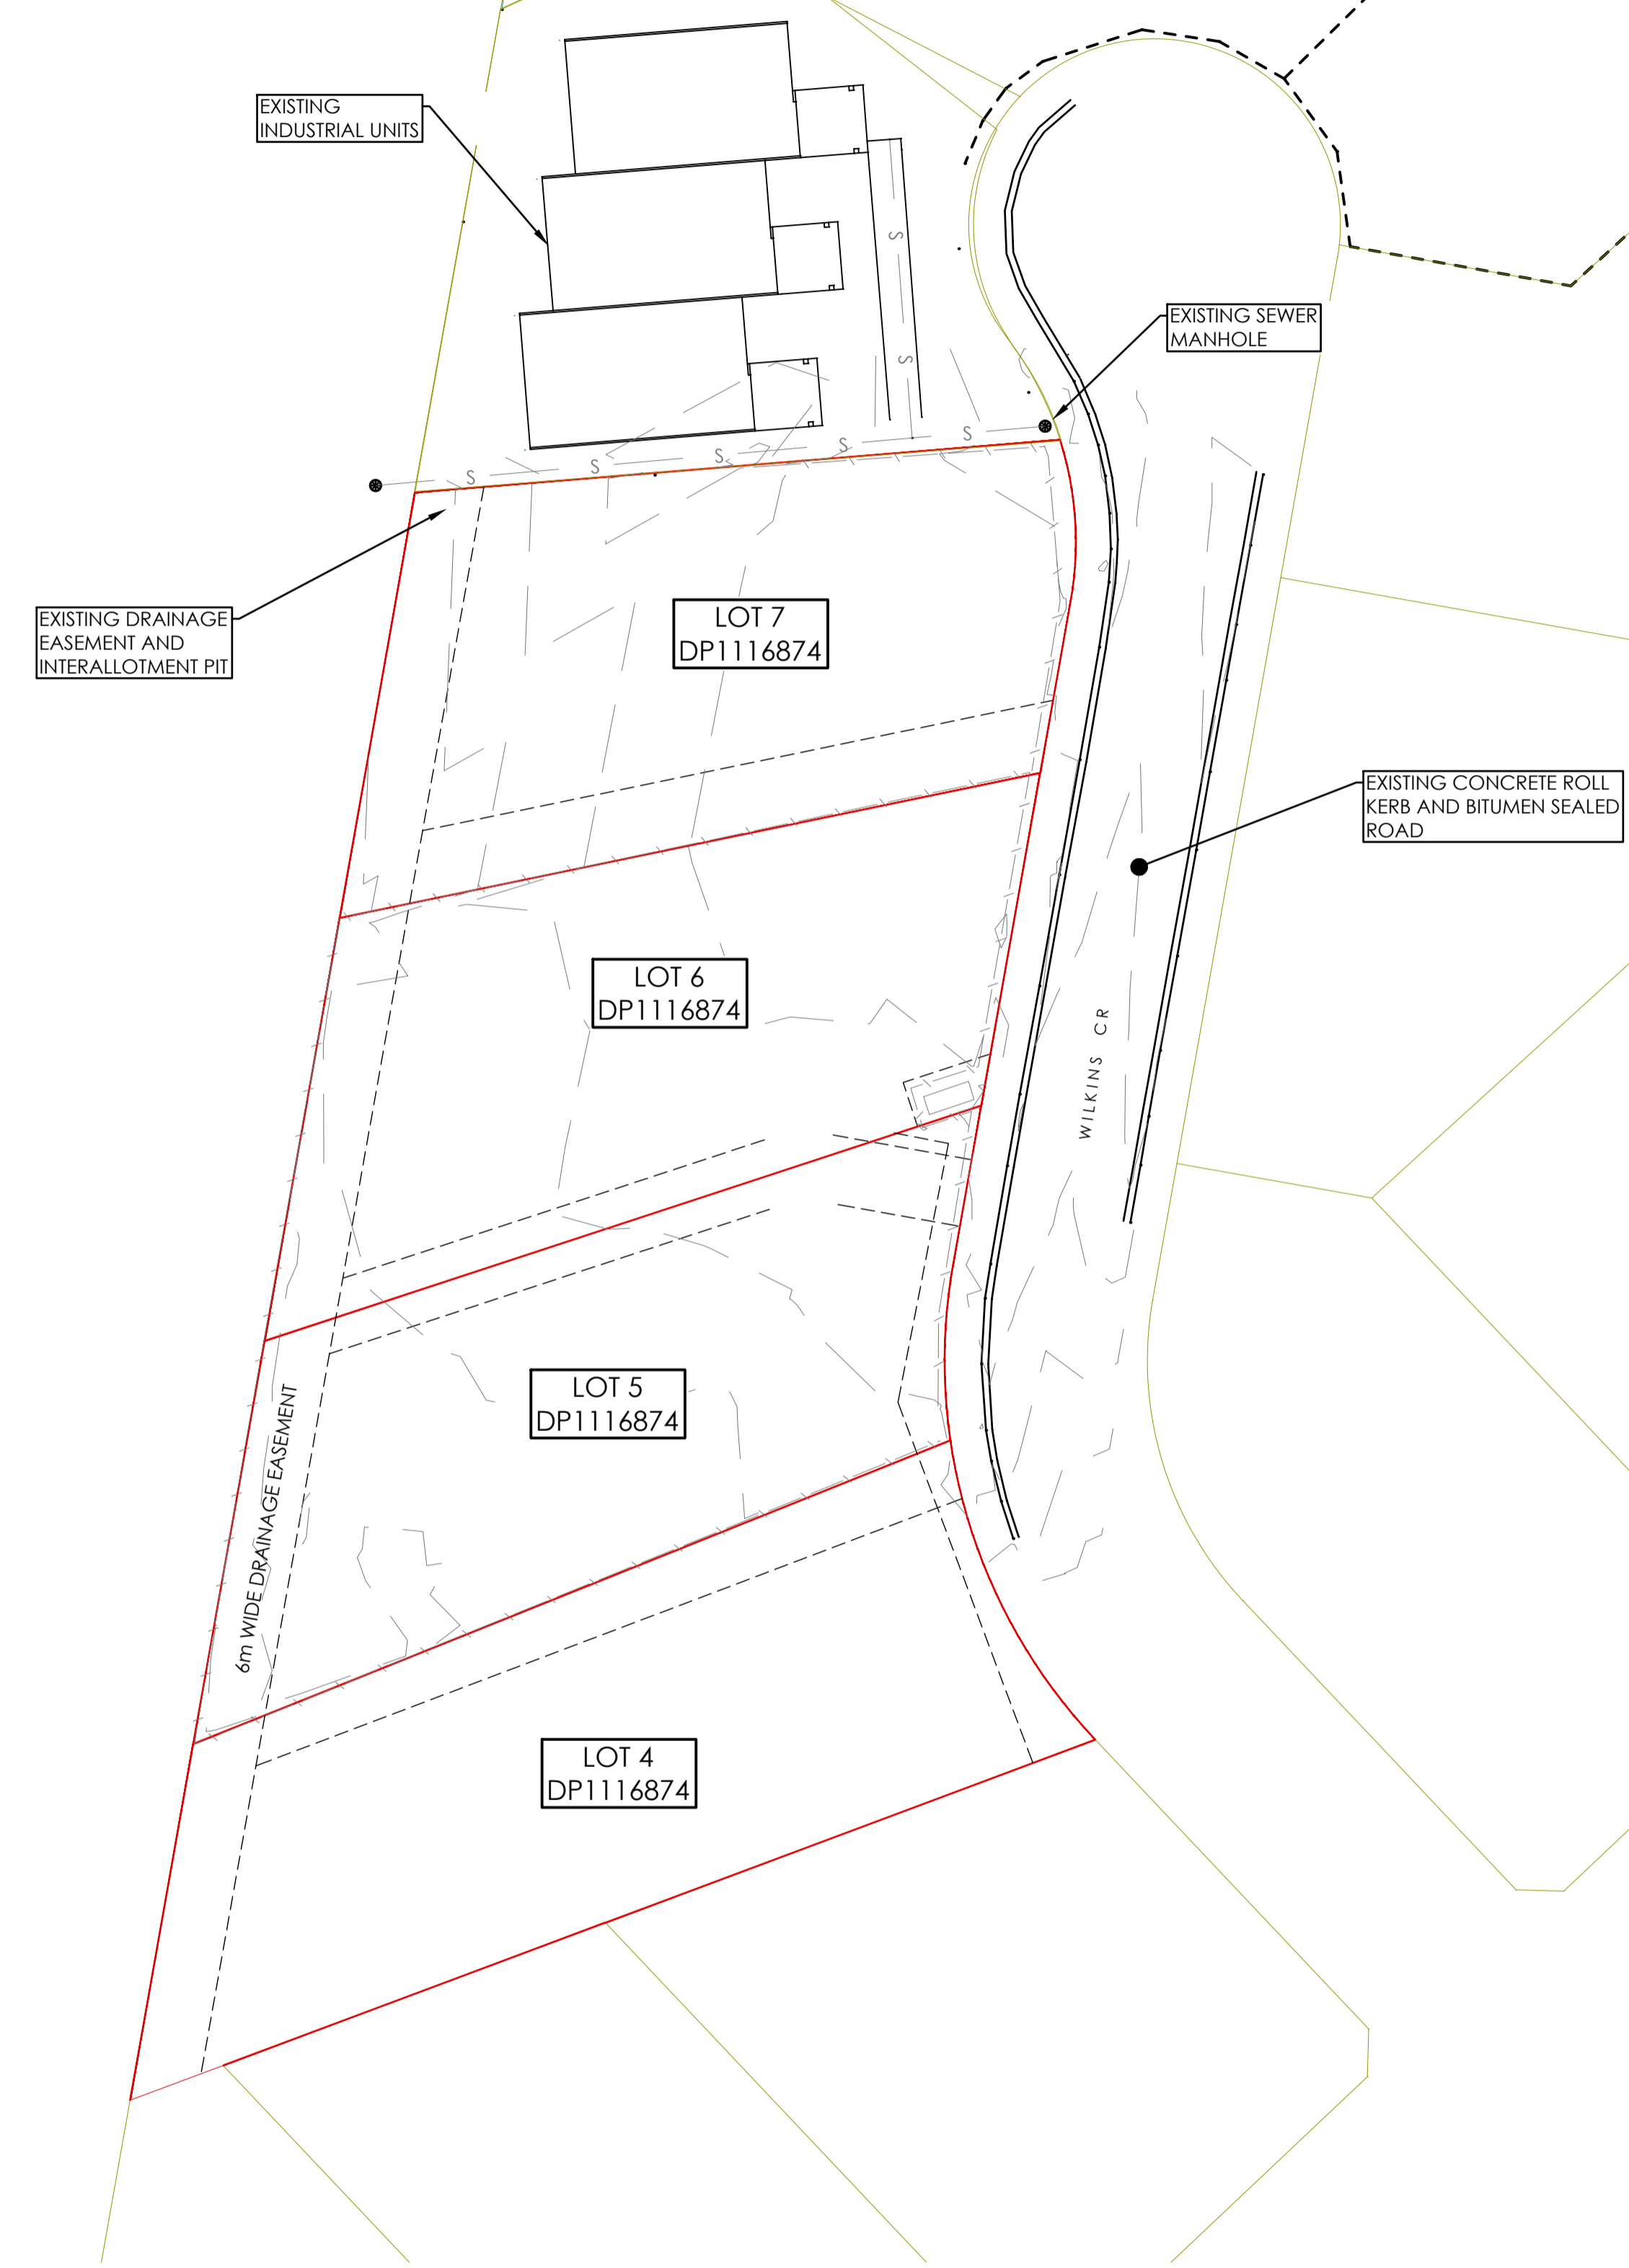

EXISTING SITE PLAN
 SCALE 1:484 AT A1

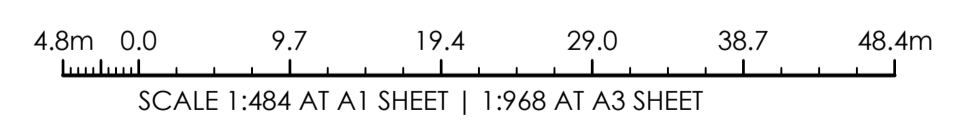

ISSUED FOR CONSTRUCTION	10.02.21	0	J.D.
ISSUED FOR APPROVAL	26-08-2020	A	Rd.S
AMENDMENTS	DATE	ISSUE	BY

ARCHITECT
GISELLE DENLY DRAFTING
 53 HILL SIXTY DRIVE
 MUDGEE NSW 2850

CLIENT
SWORDS GROUP
 UNIT 5/13 SYDNEY ROAD
 MUDGEE NSW 2850

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 MUDGEE NSW 2850

DESIGNED	DRAWN	DATE	SIZE	CAD REF
--	--	FEB 21	AS NOTED	TX14938.00 - C01




1300 874 294 | TRIAXIAL.COM.AU
 LEVEL 2, 1 KING WILLIAM ROAD, UNLEY SA 5061
 PO BOX 474, TANUNDA SA 5352

DRAWING TITLE
EXISTING SITE PLAN


ADELAIDE | BAROSSA | DARWIN | MUDGEE | PARRAMATTA | SYDNEY

PROJECT No. **TX14938.00 - C2.00** DRAWING No. **0** ISSUE


FOR CONSTRUCTION

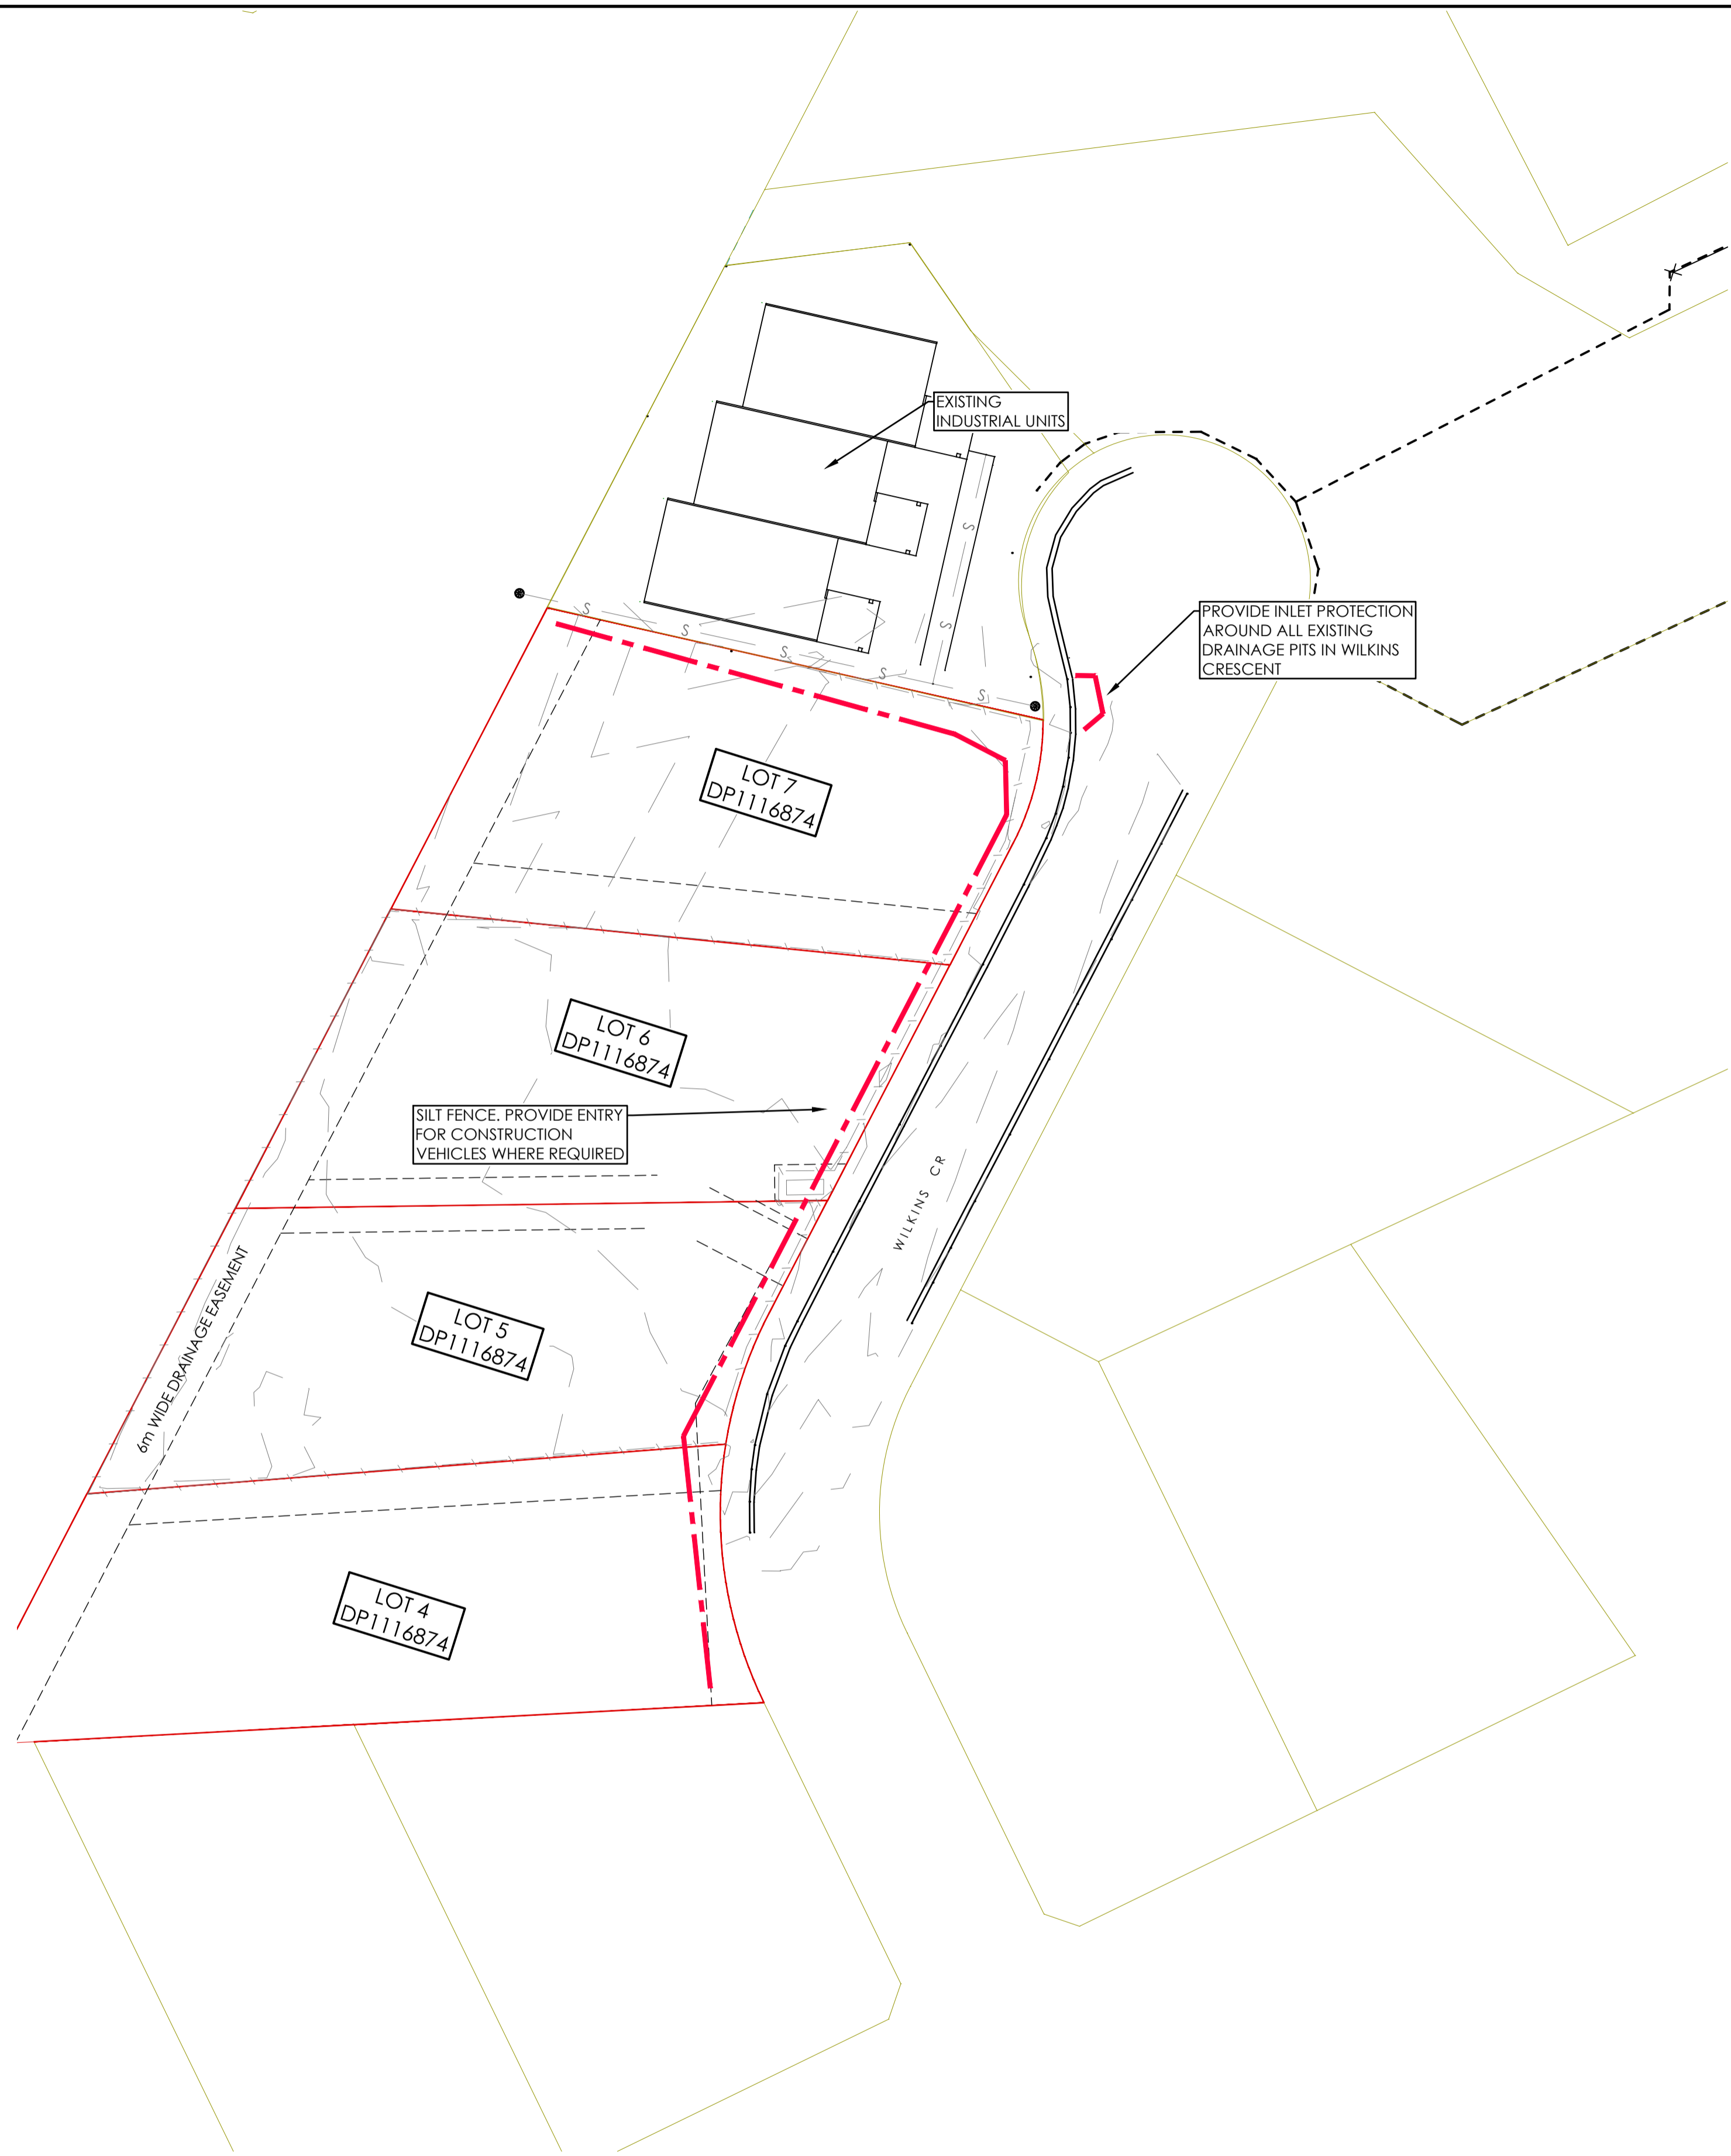

EXISTING SITE PLAN
SCALE 1:500 AT A1

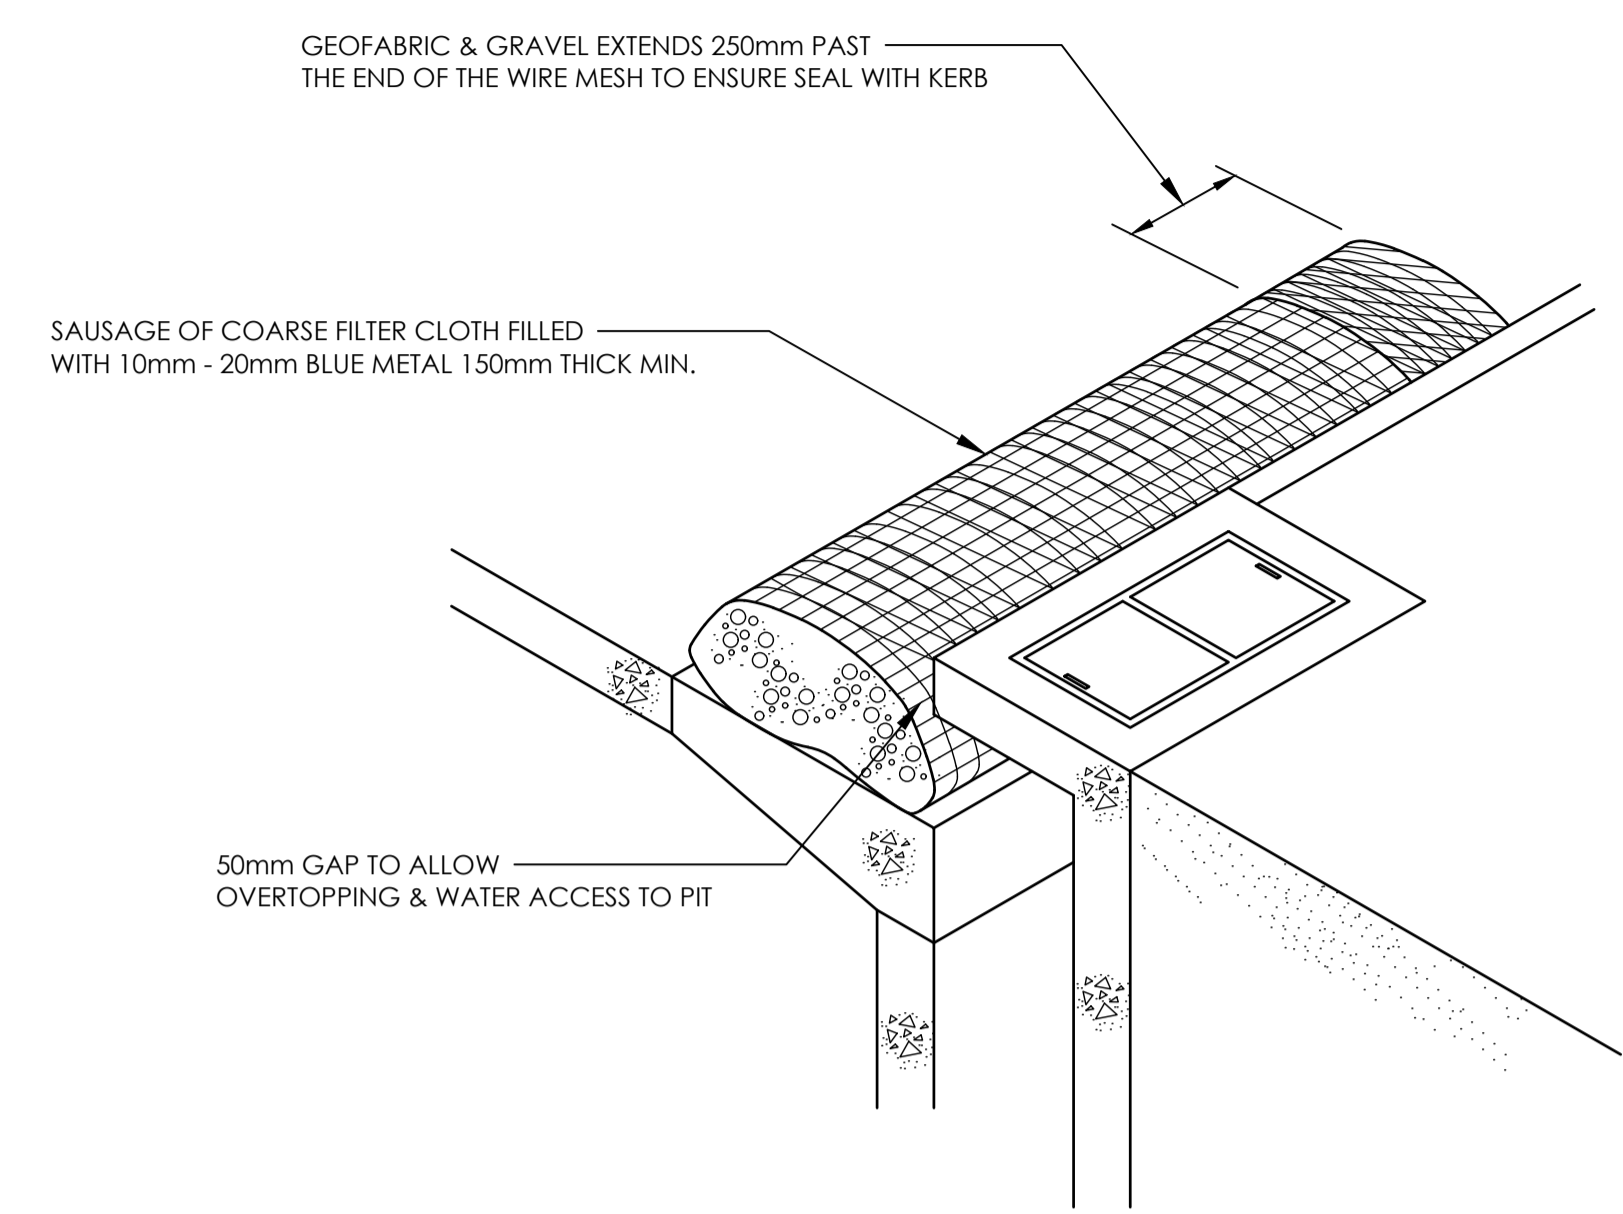

KERB INLET CONTROL
NOT TO SCALE

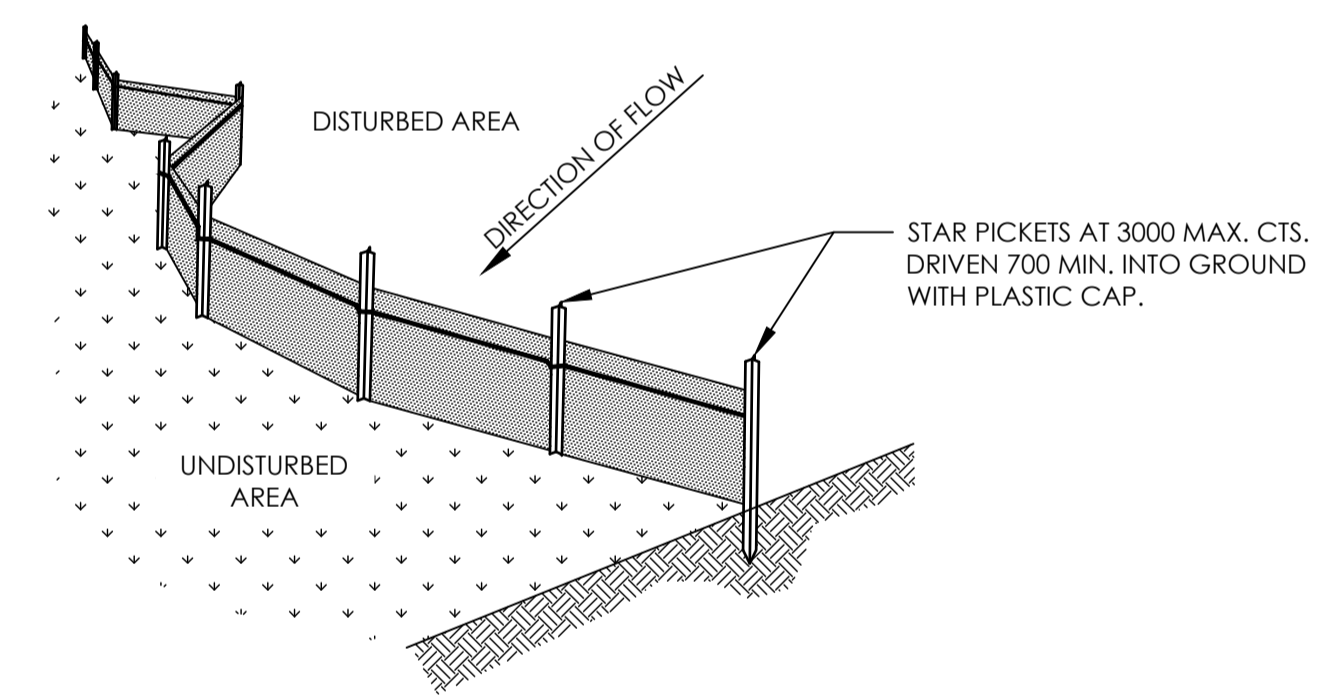


SILT FENCE DETAIL
NOT TO SCALE


NOTE:
PROVIDE 1m RETURNS AT 30m INTERVALS, TYPICAL.

NOTES :

- ALL EROSION & SEDIMENT CONTROL MEASURES TO BE IMPLEMENTED PRIOR TO COMMENCEMENT OF SITE WORKS.
- ALL EROSION & SEDIMENT CONTROL MEASURES TO BE INSPECTED & MAINTAINED DAILY BY SITE MANAGER.
- MINIMISE DISTURBED AREAS.
- ROADS & FOOTPATHS TO BE SWEEPED DAILY. NO MUD OR DIRT ALLOWED ON FOOTPATH OR ROAD PAVEMENTS.
- BATTERS TO BE STABILISED BY VEGETATING, TURFING OR OTHER APPROVED METHOD WITHIN 30 DAYS OF COMPLETION.
- DUST MINIMISATION CONTROL BY WATERING TO BE IMPLEMENTED BY SITE MANAGER AS REQUIRED OR AS PER COUNCIL SPECIFICATIONS.

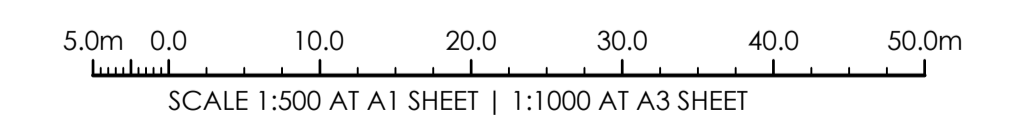

FOR CONSTRUCTION

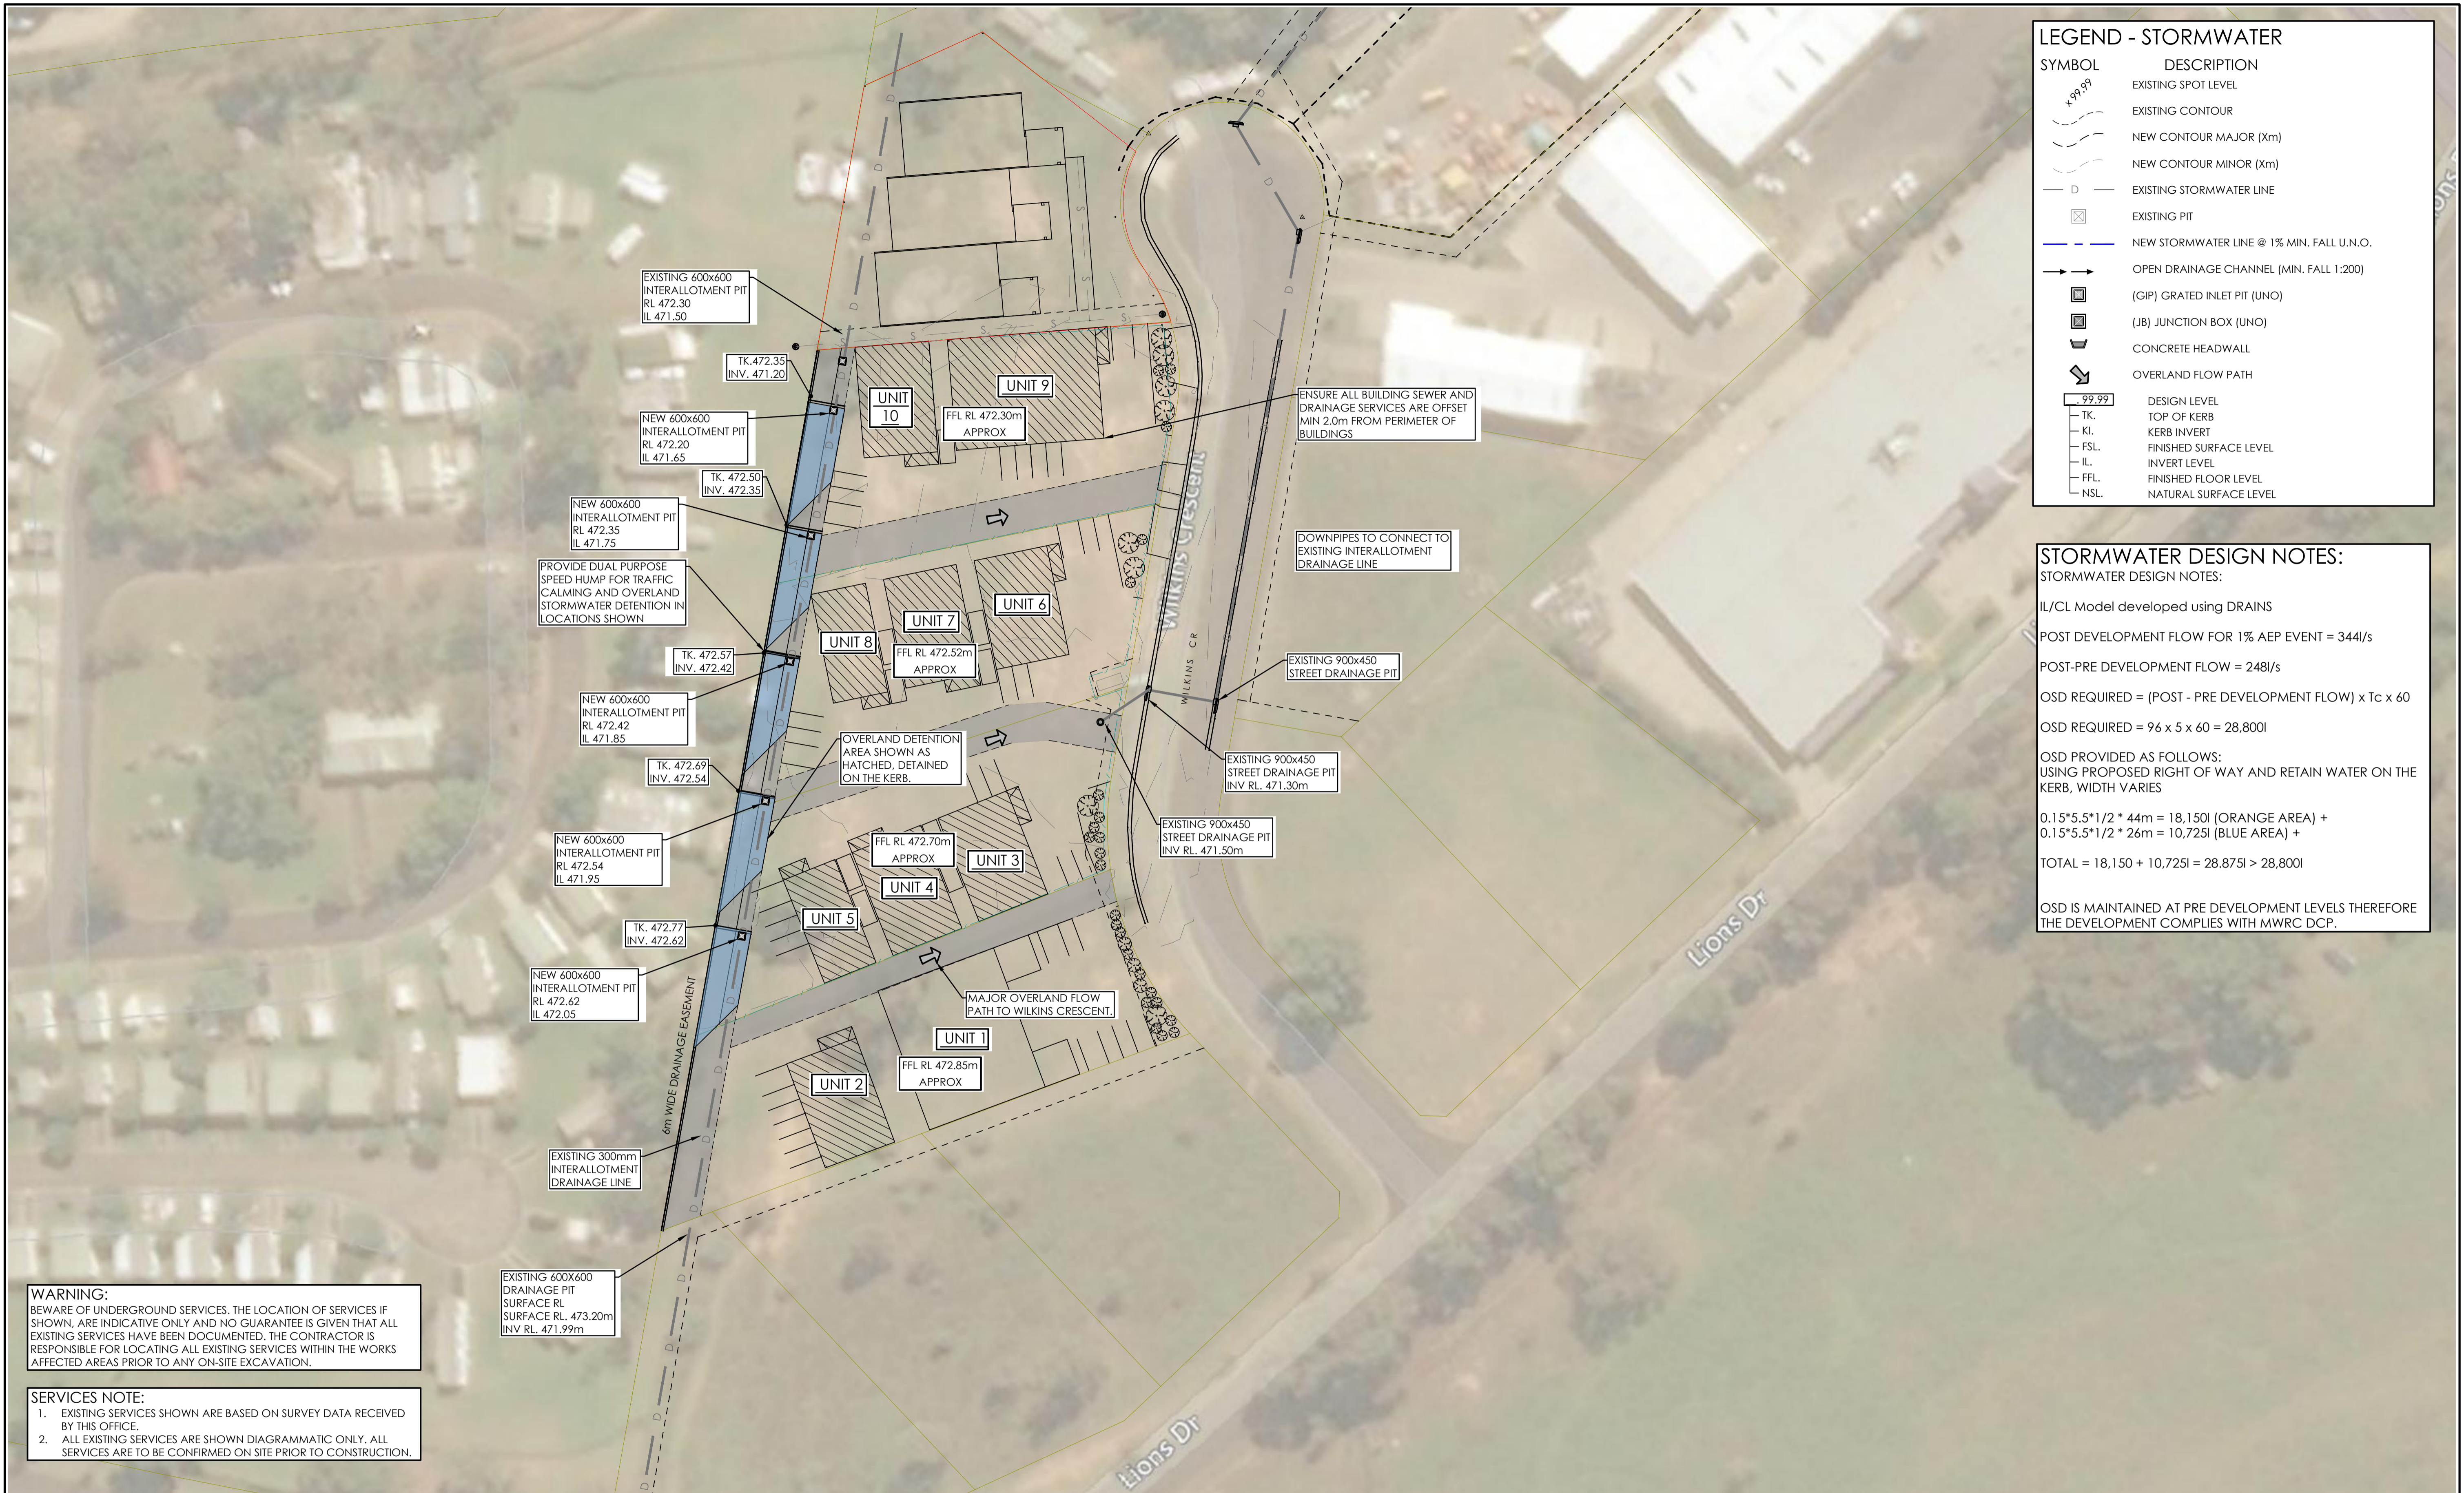

LEGEND - STORMWATER	
SYMBOL	DESCRIPTION
	EXISTING SPOT LEVEL
	EXISTING CONTOUR
	NEW CONTOUR MAJOR (Xm)
	NEW CONTOUR MINOR (Xm)
	EXISTING STORMWATER LINE
	EXISTING PIT
	NEW STORMWATER LINE @ 1% MIN. FALL U.N.O.
	OPEN DRAINAGE CHANNEL (MIN. FALL 1:200)
	(GIP) GRATED INLET PIT (UNO)
	(JB) JUNCTION BOX (UNO)
	CONCRETE HEADWALL
	OVERLAND FLOW PATH
	DESIGN LEVEL
	TK. TOP OF KERB
	KI. KERB INVERT
	FSL. FINISHED SURFACE LEVEL
	IL. INVERT LEVEL
	FFL. FINISHED FLOOR LEVEL
	NSL. NATURAL SURFACE LEVEL

STORMWATER DESIGN NOTES:

STORMWATER DESIGN NOTES:

IL/CL Model developed using DRAINS

POST DEVELOPMENT FLOW FOR 1% AEP EVENT = 344l/s

POST-PRE DEVELOPMENT FLOW = 248l/s

OSD REQUIRED = (POST - PRE DEVELOPMENT FLOW) x Tc x 60

OSD REQUIRED = 96 x 5 x 60 = 28,800l

OSD PROVIDED AS FOLLOWS:
USING PROPOSED RIGHT OF WAY AND RETAIN WATER ON THE KERB, WIDTH VARIES

0.15*5.5*1/2 * 44m = 18,150l (ORANGE AREA) +
0.15*5.5*1/2 * 26m = 10,725l (BLUE AREA) +


TOTAL = 18,150 + 10,725l = 28,875l > 28,800l

OSD IS MAINTAINED AT PRE DEVELOPMENT LEVELS THEREFORE THE DEVELOPMENT COMPLIES WITH MWRC DCP.

WARNING:
BEWARE OF UNDERGROUND SERVICES. THE LOCATION OF SERVICES IF SHOWN, ARE INDICATIVE ONLY AND NO GUARANTEE IS GIVEN THAT ALL EXISTING SERVICES HAVE BEEN DOCUMENTED. THE CONTRACTOR IS RESPONSIBLE FOR LOCATING ALL EXISTING SERVICES WITHIN THE WORKS AFFECTED AREAS PRIOR TO ANY ON-SITE EXCAVATION.


SERVICES NOTE:

- EXISTING SERVICES SHOWN ARE BASED ON SURVEY DATA RECEIVED BY THIS OFFICE.
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STORMWATER MANAGEMENT PLAN

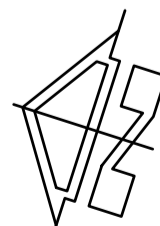SCALE 1:500 AT A1



AMENDMENTS	DATE	ISSUE	BY
ISSUED FOR CONSTRUCTION	26.02.21	2	J.D.
ISSUED FOR CONSTRUCTION	25.02.21	1	J.D.
ISSUED FOR CONSTRUCTION	10.02.21	0	J.D.
ISSUED FOR APPROVAL	26-08-2020	A	Ro.S

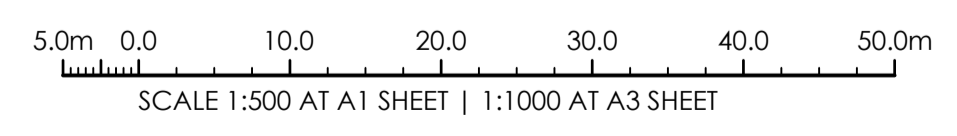ARCHITECT
GISELLE DENLY DRAFTING
53 HILL SIXTY DRIVE
MUDGEES NSW 2850

CLIENT
SWORDS GROUP
UNIT 5/13 SYDNEY ROAD
MUDGEES NSW 2850

PROJECT
PROPOSED INDUSTRIAL UNITS
LOTS 4-7 WILKINS CRESCENT
MUDGEES NSW 2850




1300 874 294 | TRIAXIAL.COM.AU
LEVEL 2, 1 KING WILLIAM ROAD, UNLEY SA 5061
PO BOX 474, TANUNDA SA 5352

DRAWING TITLE
STORMWATER MANAGEMENT PLAN


FOR CONSTRUCTION

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PROJECT No. **TX14938.00 - C3.00** DRAWING No. **2**

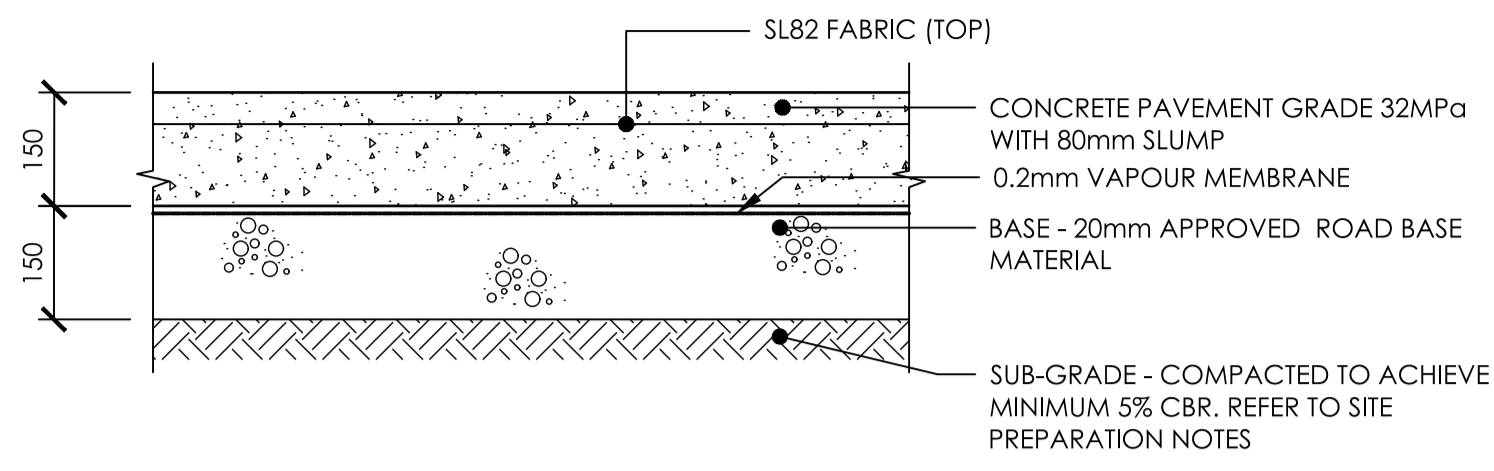

CONCRETE DRIVEWAY PAVEMENT
SCALE 1:10 (A1)

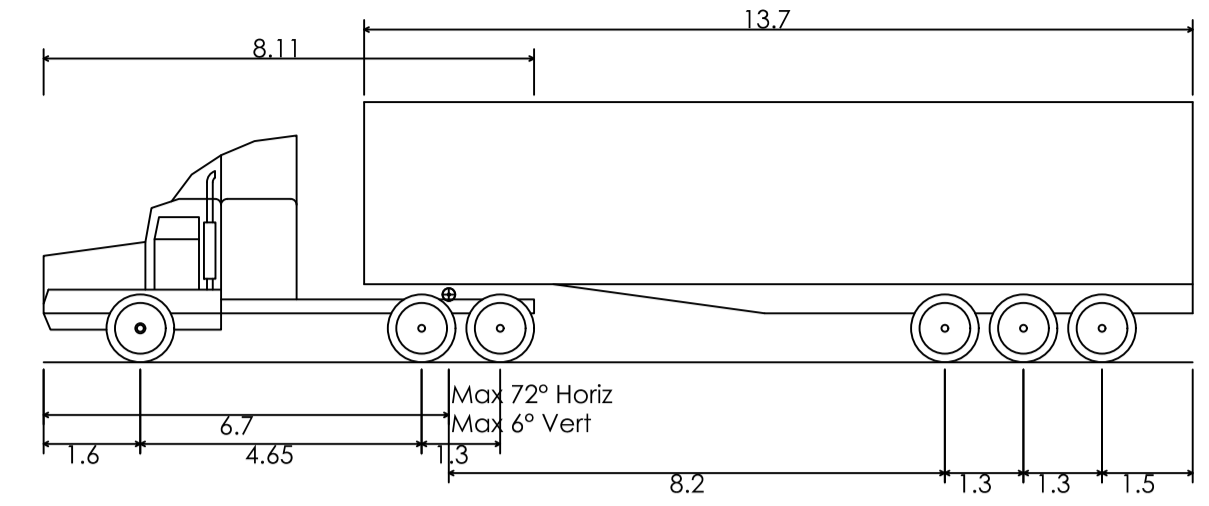


Prime mover and semi-trailer (19 m)

Overall Length	19.000m
Overall Width	2.500m
Overall Body Height	4.300m
Min Body Ground Clearance	0.540m
Track Width	2.500m
Lock-to-lock time	6.00s
Curb to Curb Turning Radius	12.500m

SWEPT PATH ANALYSIS


- VEHICLE SWEEP PATH ANALYSIS UNDERTAKEN USING CIVIL3D2019 VEHICLE TRACKING MODULE.
- DESIGN SPEED = 5km/hr.
- VEHICLE/S USED IN SWEEP PATH ANALYSIS.
 - 19m SEMI AUSTRROADS 2013.

SYMBOL	DESCRIPTION
	WHEEL PATH EXTENT (FORWARD)
	VEHICLE CHASSIS ENVELOPE (FORWARD)
	WHEEL PATH EXTENT (REVERSE)
	VEHICLE CHASSIS ENVELOPE (REVERSE)
	ARROW FORWARD DIRECTION
	ARROW REVERSE DIRECTION
	NEW DRIVEWAY CROSSOVER

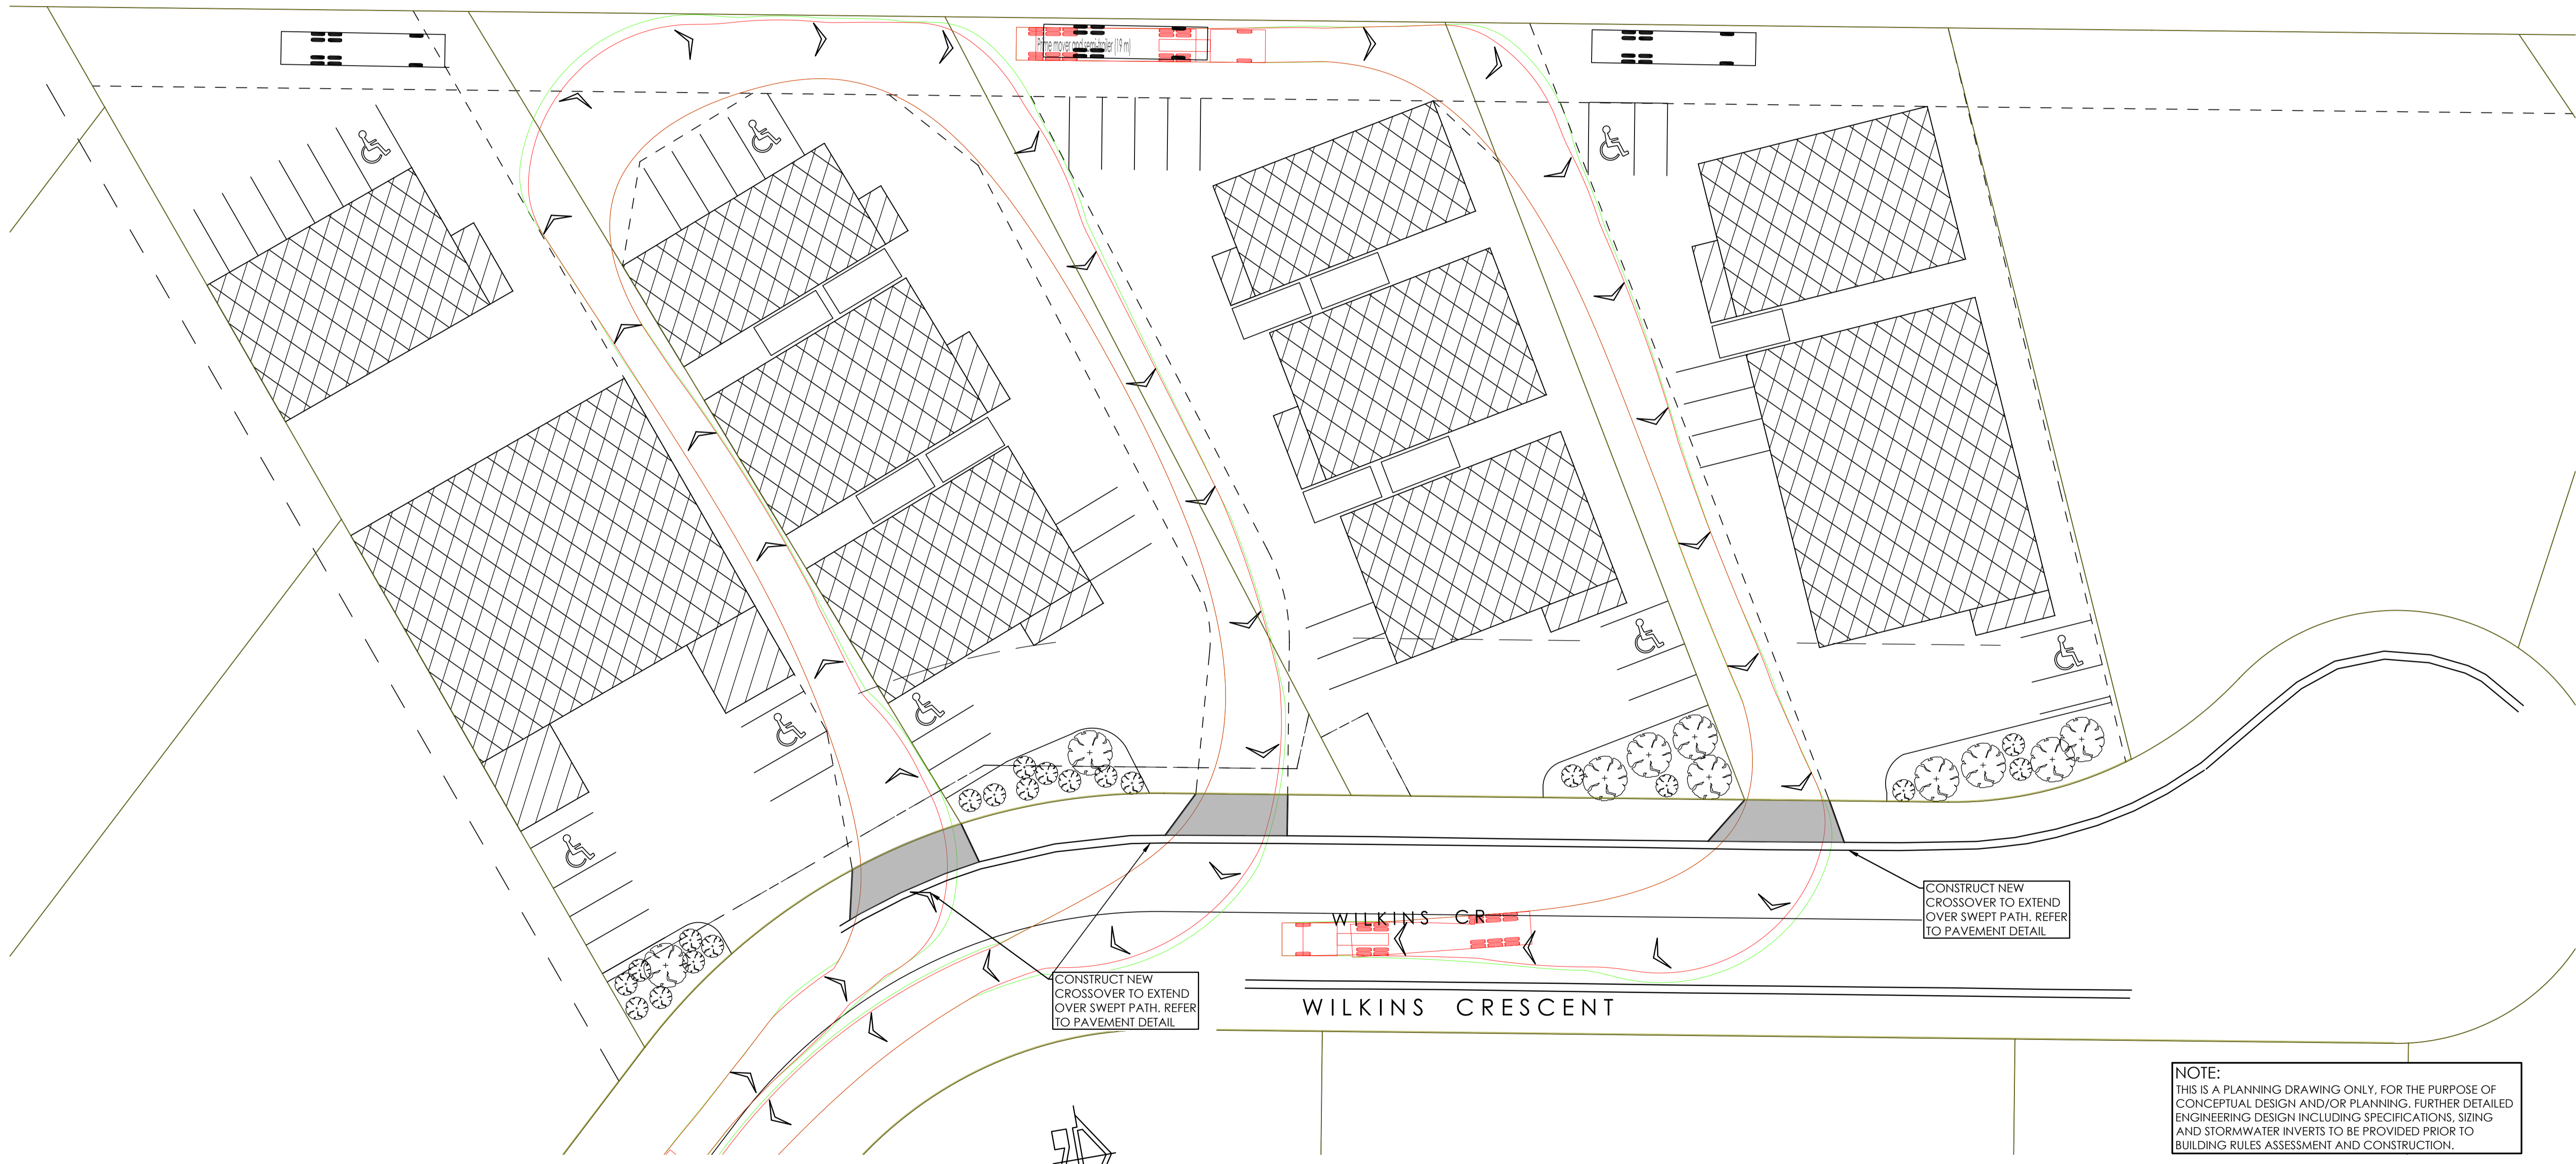

SWEPT PATH PLAN
SCALE 1:250 AT A1

NOTE:
THIS IS A PLANNING DRAWING ONLY, FOR THE PURPOSE OF CONCEPTUAL DESIGN AND/OR PLANNING. FURTHER DETAILED ENGINEERING DESIGN INCLUDING SPECIFICATIONS, SIZING AND STORMWATER INVERTS TO BE PROVIDED PRIOR TO BUILDING RULES ASSESSMENT AND CONSTRUCTION.

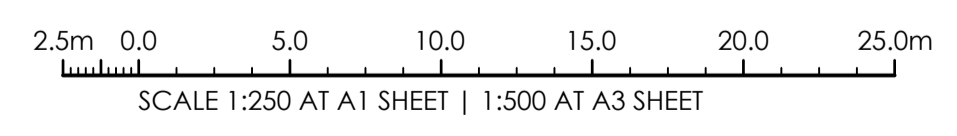

ISSUED FOR CONSTRUCTION	10.02.21	O	J.D.
ISSUED FOR APPROVAL	26.08.20	B	J.O.M.
ISSUED FOR APPROVAL	25.08.20	A	J.O.M.
AMENDMENTS	DATE	ISSUE	BY

ARCHITECT
GISELLE DENLY DRAFTING
53 HILL SIXTY DRIVE
MUDGEES NSW 2850

CLIENT
SWORDS GROUP
UNIT 5/13 SYDNEY ROAD
MUDGEES NSW 2850

PROJECT
PROPOSED INDUSTRIAL UNITS
LOTS 4-7 WILKINS CRESCENT
MUDGEES NSW 2850

DESIGNED	DRAWN	DATE	SIZE	CAD REF
--	--	FEB 21	AS NOTED	TX14938.00 - C01


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DRAWING TITLE
SWEPT PATHS

PROJECT No. **TX14938.00 - C4.00** ISSUE **0**

FOR CONSTRUCTION



ROADWORK AHEAD SIGN TO BE PLACED IN WILKINS CRESCENT AT INTERSECTION WITH LIONS DRIVE

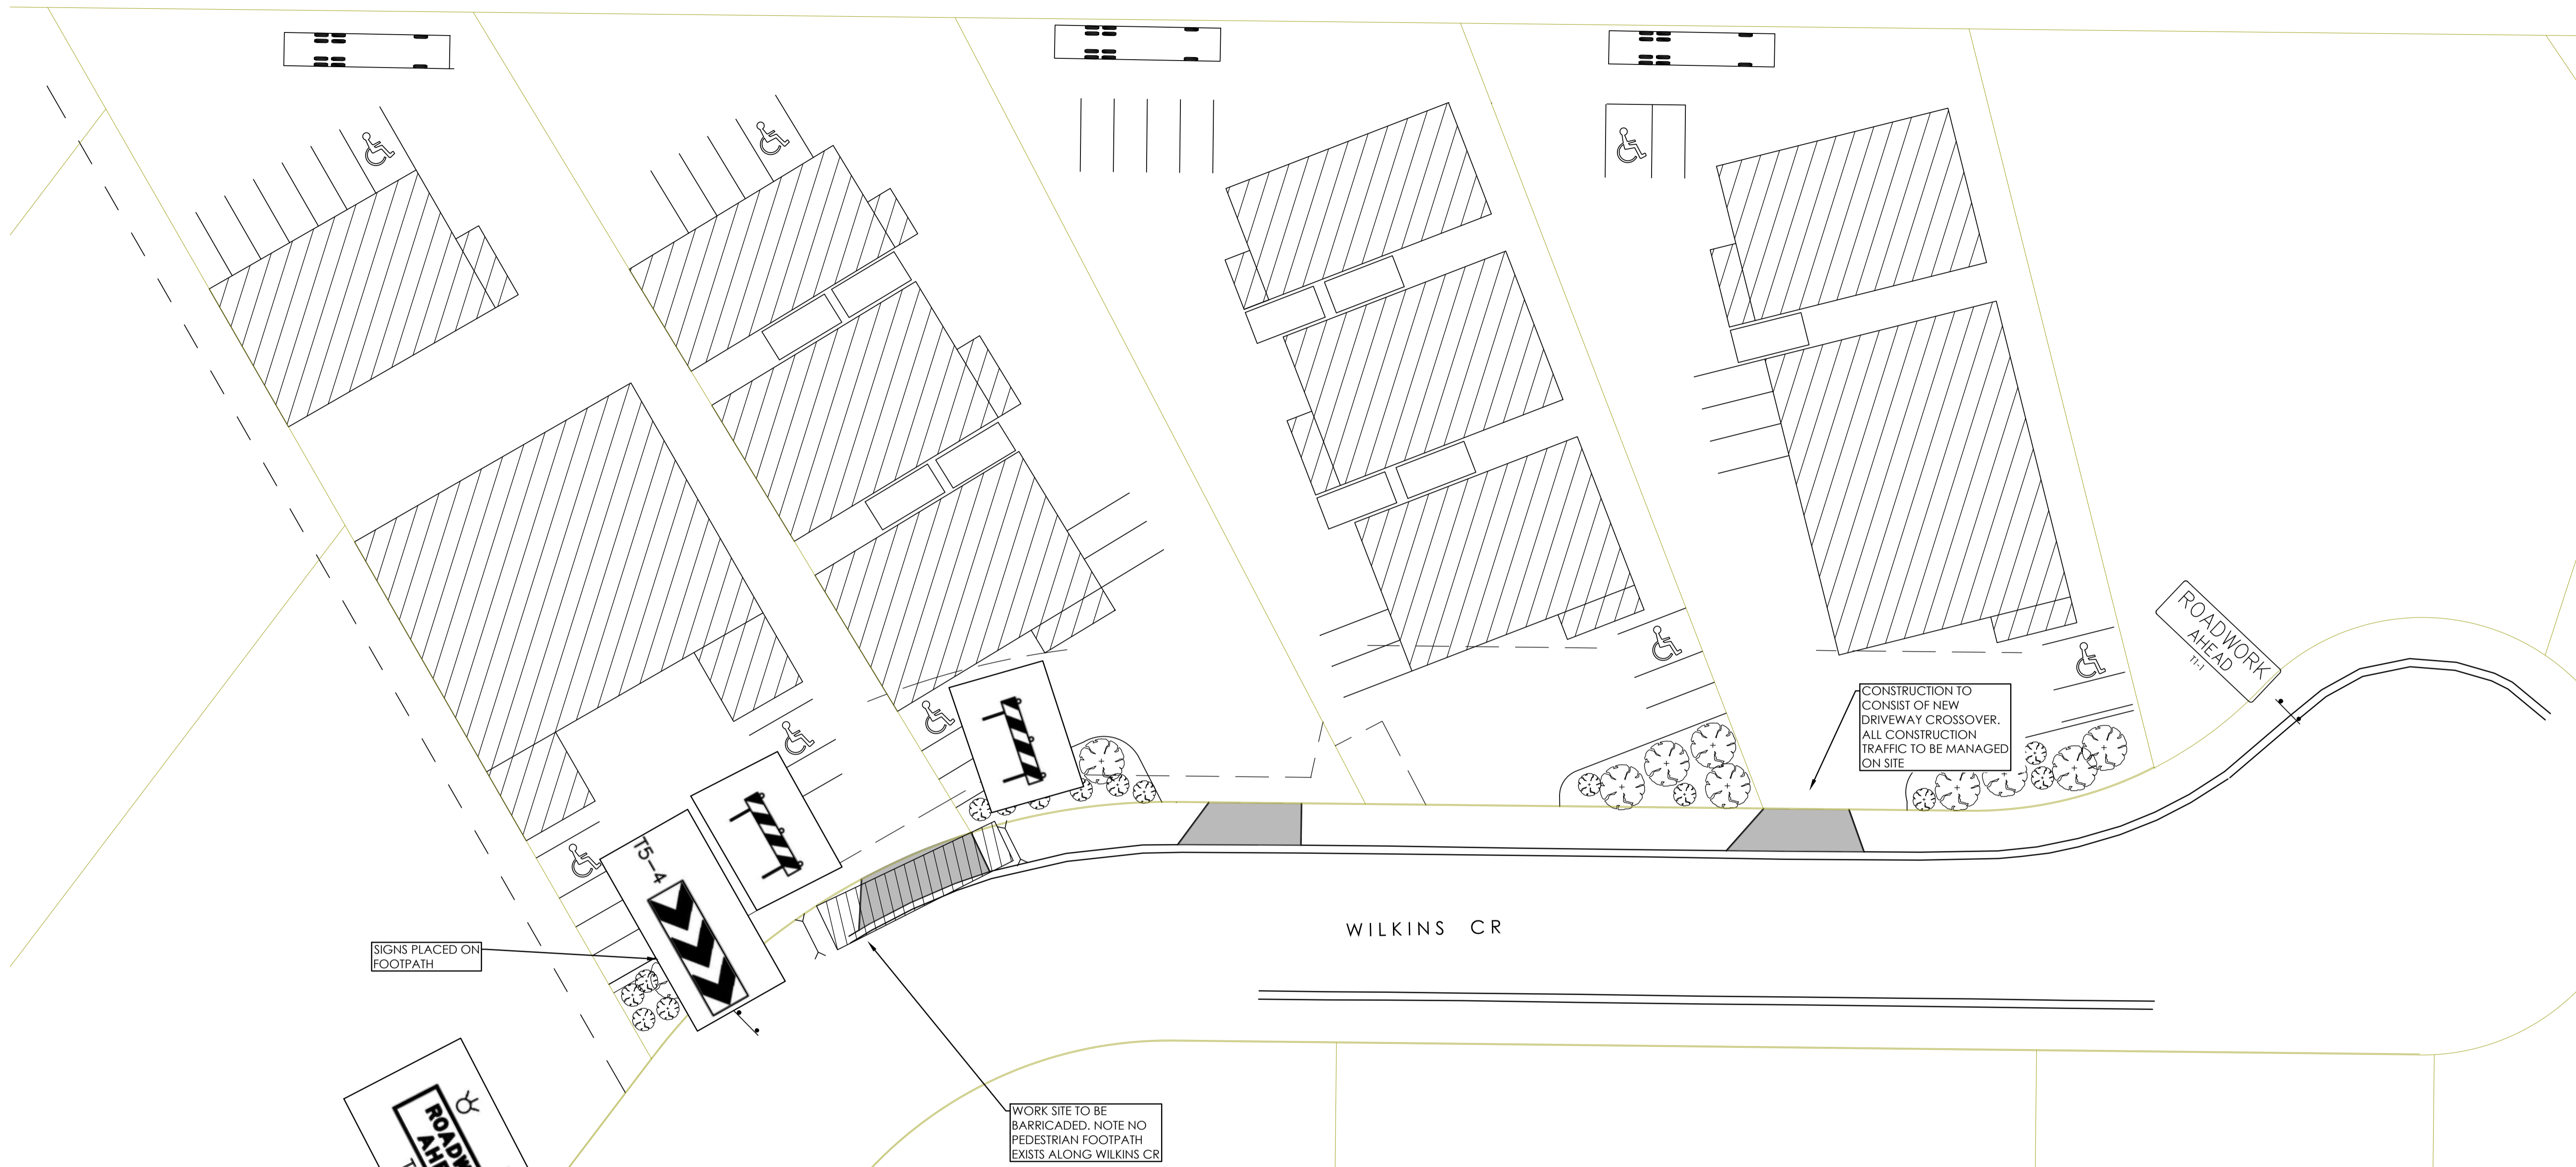SIGNS PLACED ON FOOTPATH

WORK SITE TO BE BARRICADED. NOTE NO PEDESTRIAN FOOTPATH EXISTS ALONG WILKINS CR

CONSTRUCTION TO CONSIST OF NEW DRIVEWAY CROSSOVER. ALL CONSTRUCTION TRAFFIC TO BE MANAGED ON SITE


ROADWORK AHEAD T1-1

ROADWORK AHEAD T1-1

T5-4

WILKINS CR

PLAN PRODUCED BY J.KNOX
 TRAFFIC SELECT/MODIFY CERTIFICATE NUMBER: 0020744826

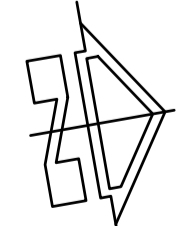

TRAFFIC CONTROL PLAN
 SCALE 1:250 AT A1

2.5m 0.0 5.0 10.0 15.0 20.0 25.0m
 SCALE 1:250 AT A1 SHEET | 1:500 AT A3 SHEET

ISSUED FOR CONSTRUCTION AMENDMENTS
 10.02.221 0 J.D.
 DATE ISSUE BY

ARCHITECT
GISELLE DENLY DRAFTING
 53 HILL SIXTY DRIVE
 MUDGEES NSW 2850

CLIENT
SWORDS GROUP
 UNIT 5/13 SYDNEY ROAD
 MUDGEES NSW 2850

PROJECT
PROPOSED INDUSTRIAL UNITS
 LOTS 4-7 WILKINS CRESCENT
 MUDGEES NSW 2850



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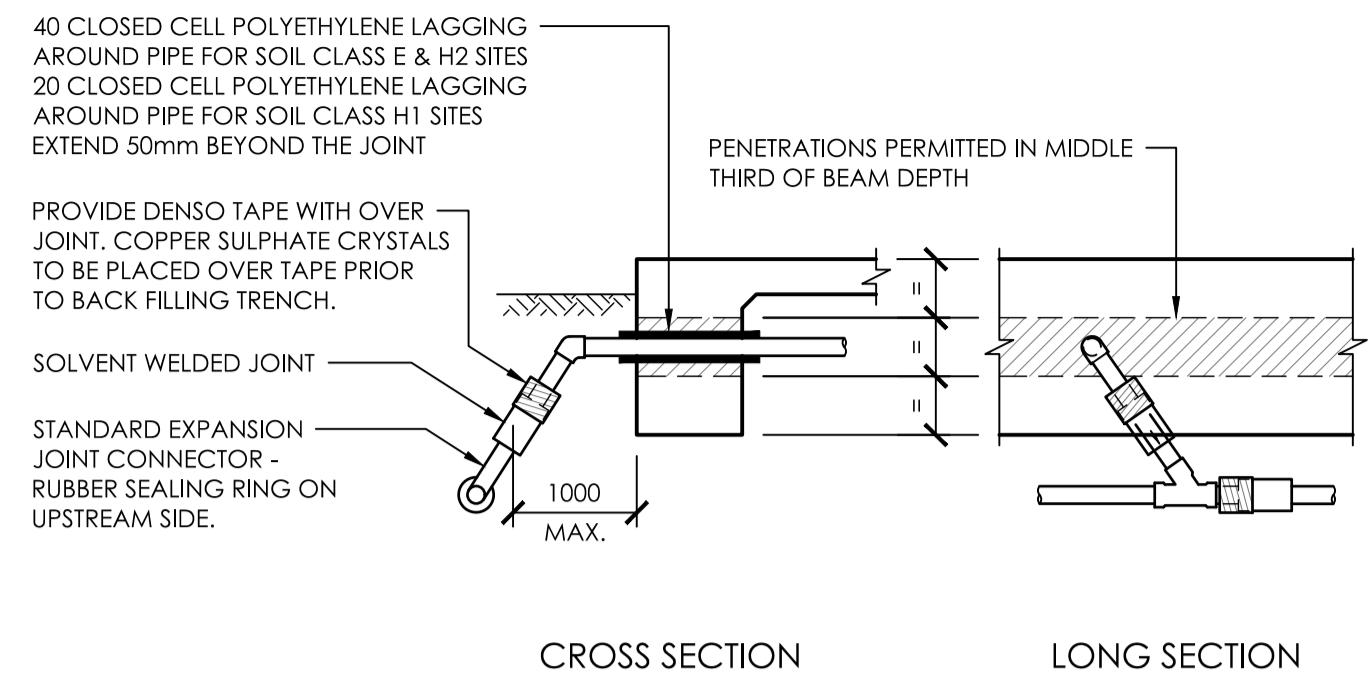
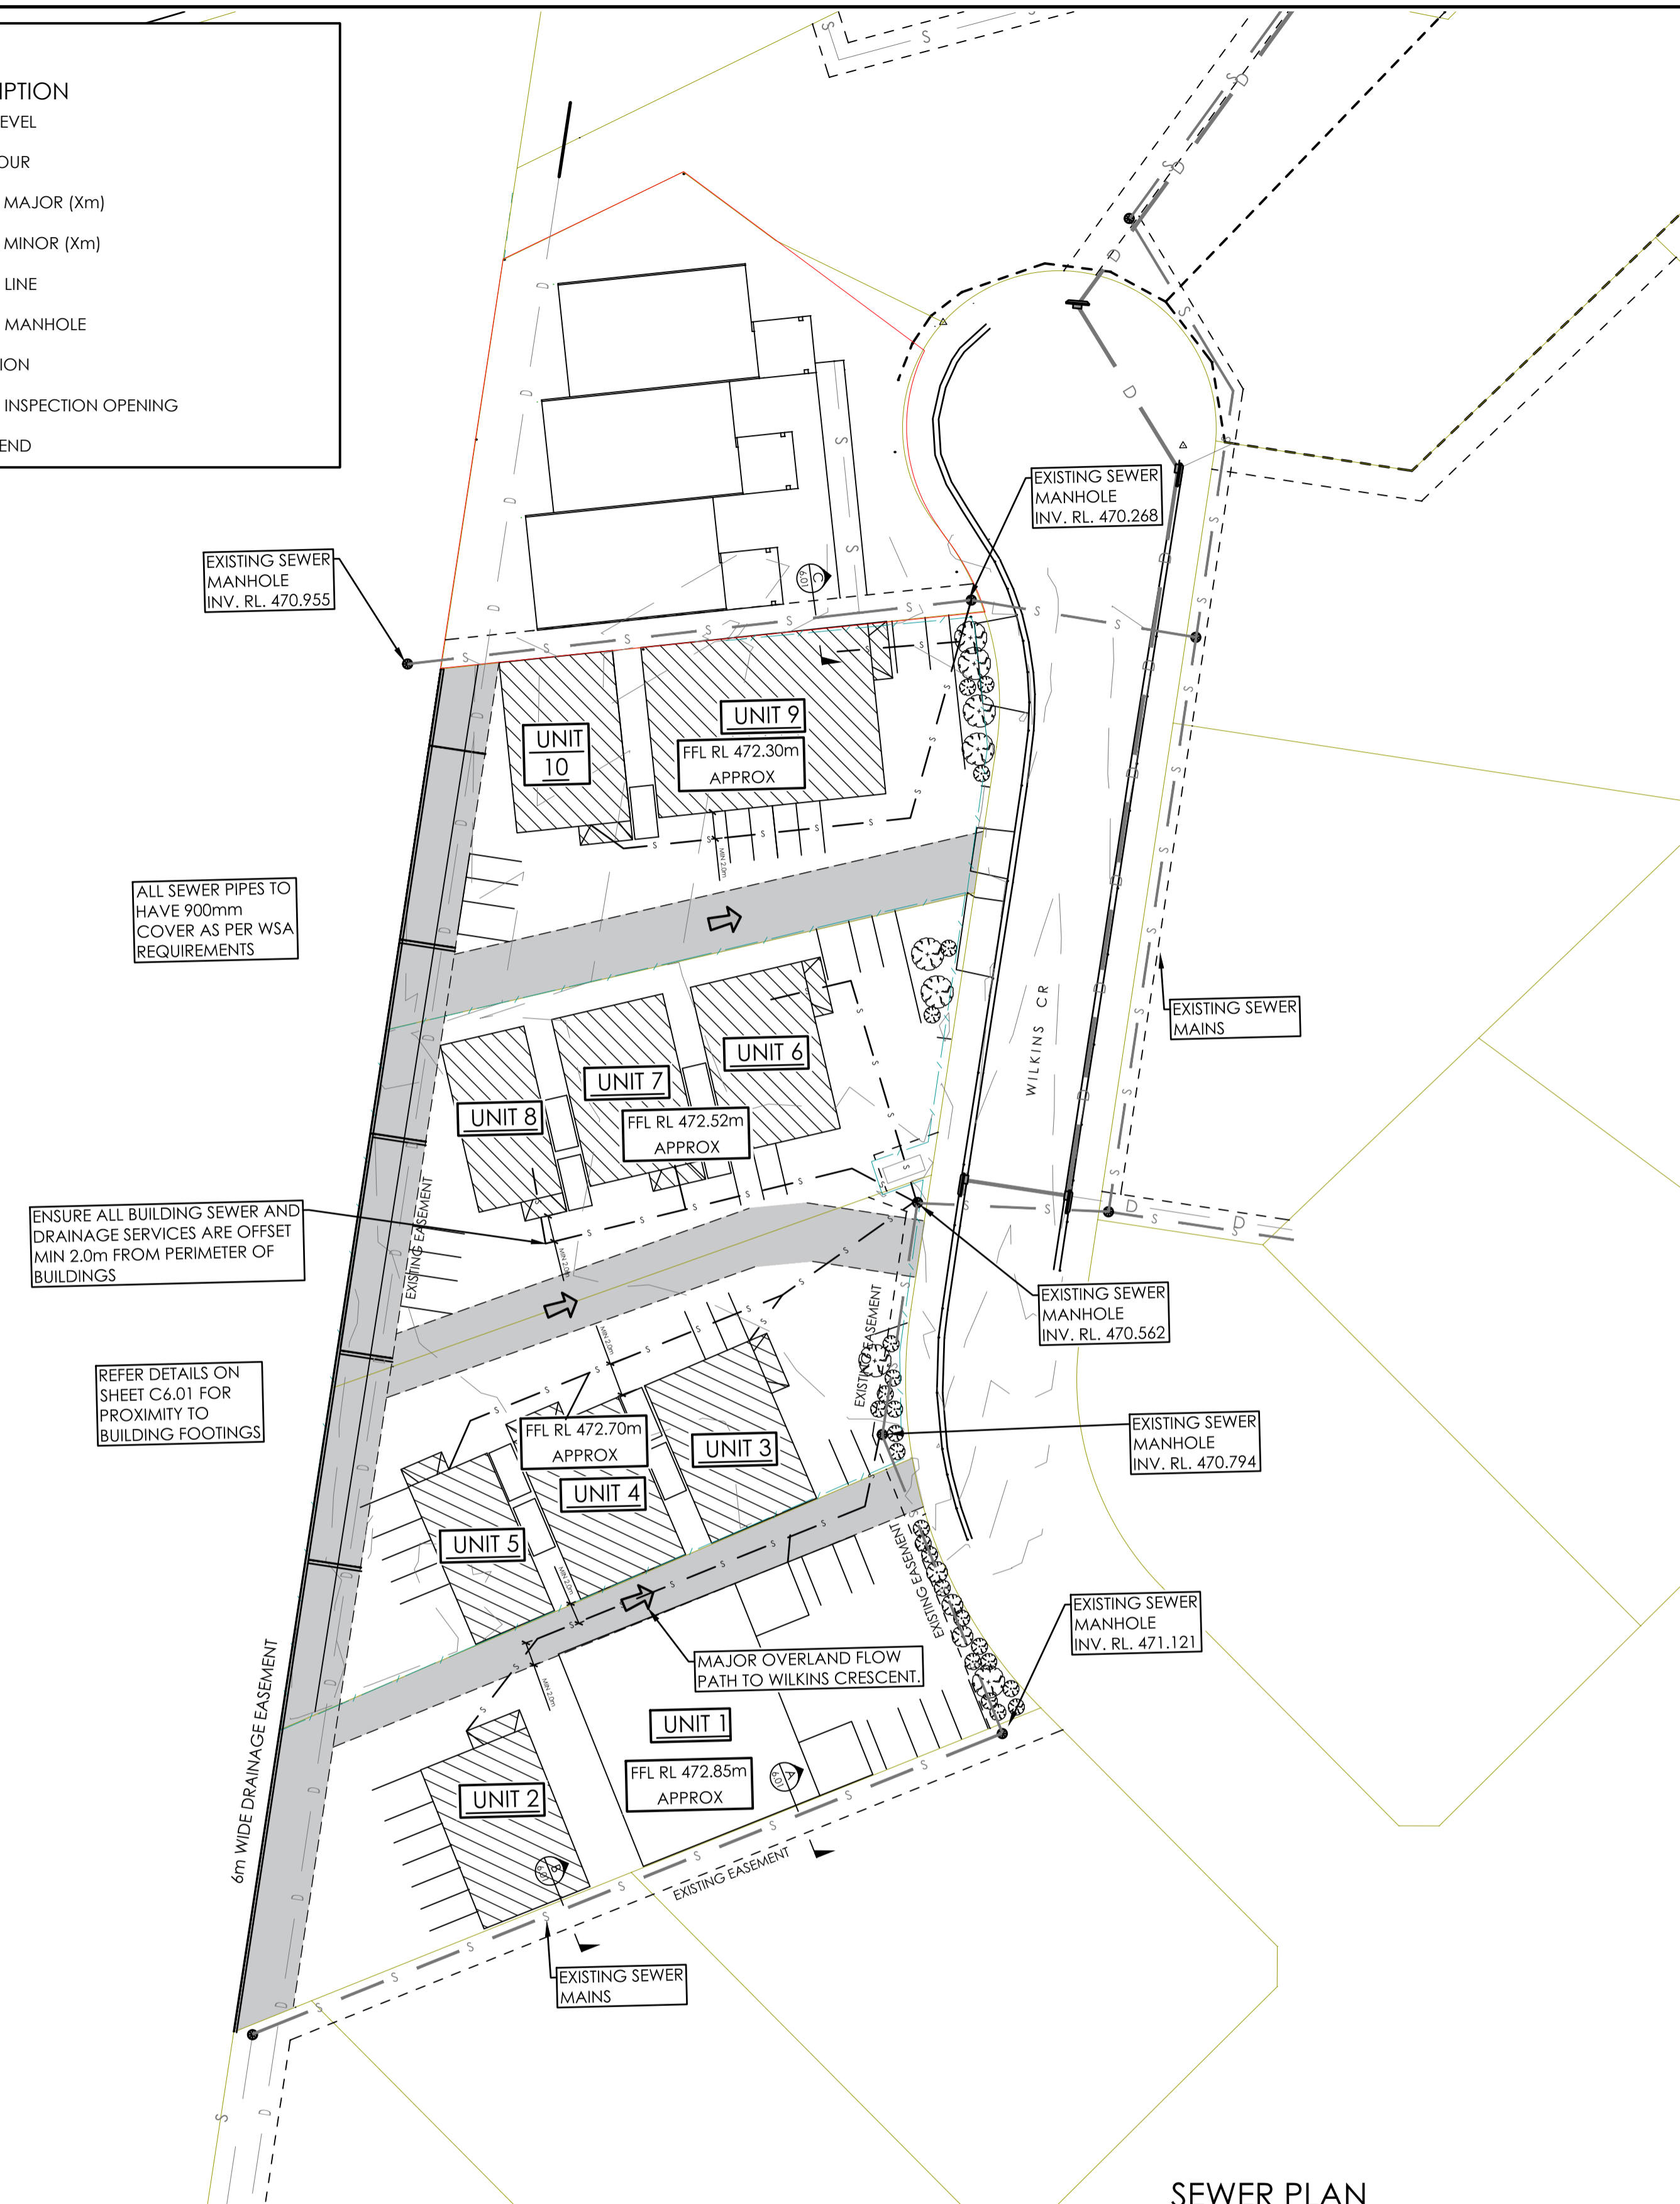
DRAWING TITLE
TRAFFIC CONTROL PLAN

FOR CONSTRUCTION

PROJECT No. **TX14938.00 - C5.00** DRAWING No. **0** ISSUE

LEGEND - SEWER


SYMBOL	DESCRIPTION
X 99.99	EXISTING SPOT LEVEL
---	EXISTING CONTOUR
---	NEW CONTOUR MAJOR (Xm)
---	NEW CONTOUR MINOR (Xm)
---	EXISTING SEWER LINE
●	EXISTING SEWER MANHOLE
---	EXISTING JUNCTION
○	EXISTING SEWER INSPECTION OPENING
---	EXISTING DEAD END




FLEXIBLE COUPLING DETAIL AND PREFERRED ZONE FOR PENETRATIONS
N.T.S.

PLUMBING JOINT NOTE:
DUE TO THE MOISTURE REACTIVE NATURE OF SOILS ON CLASS H, E SITES, IT IS REQUIRED THAT THE SERVICE PIPES INCLUDE STANDARD EXPANSION TYPE JOINT COUPLINGS. PROVIDE A FLEXIBLE CONNECTION TO PIPES IN ACCORDANCE WITH THE FOLLOWING:

- CONNECTIONS ARE REQUIRED AT EACH LOCATION WHERE ANY PIPES PENETRATE OR PASS BENEATH THE EXTERNAL FOOTING BEAMS.
- TWO EXPANSION JOINT CONNECTORS ARE REQUIRED, AS DETAILED ABOVE, AT EACH CONNECTION.
- THE DENSO TAPE MUST BE SPRINKLED WITH COPPER SULPHATE CRYSTALS PRIOR TO WRAPPING AND MUST EXTEND 50mm BEYOND THE JOINT ON EITHER SIDE.
- DETAILS ARE APPLICABLE TO SEWER AND STORMWATER PIPES.

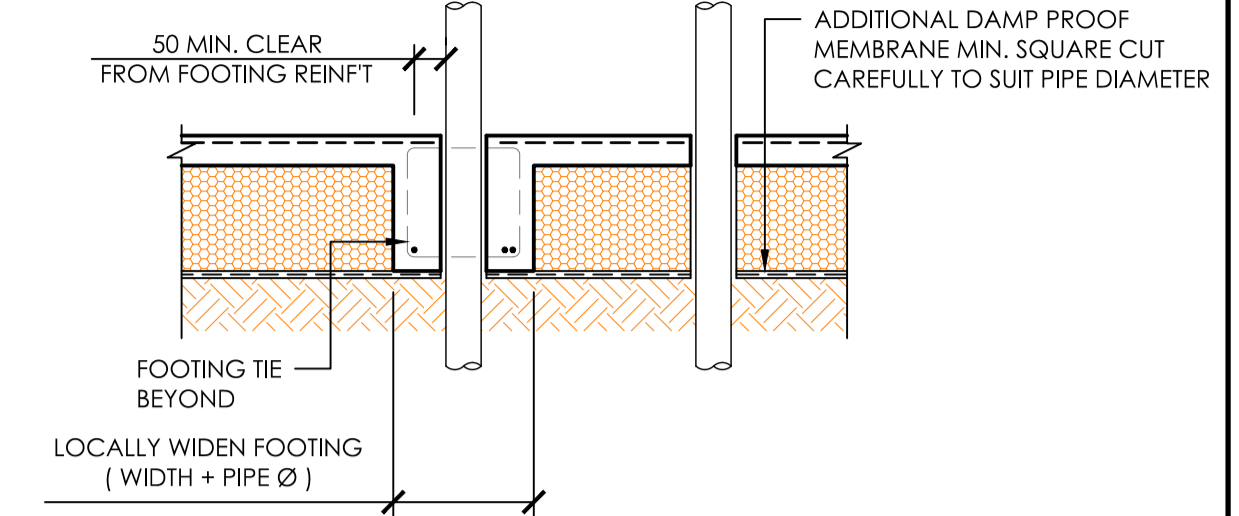

VERTICAL PIPE PENETRATION DETAIL
N.T.S.

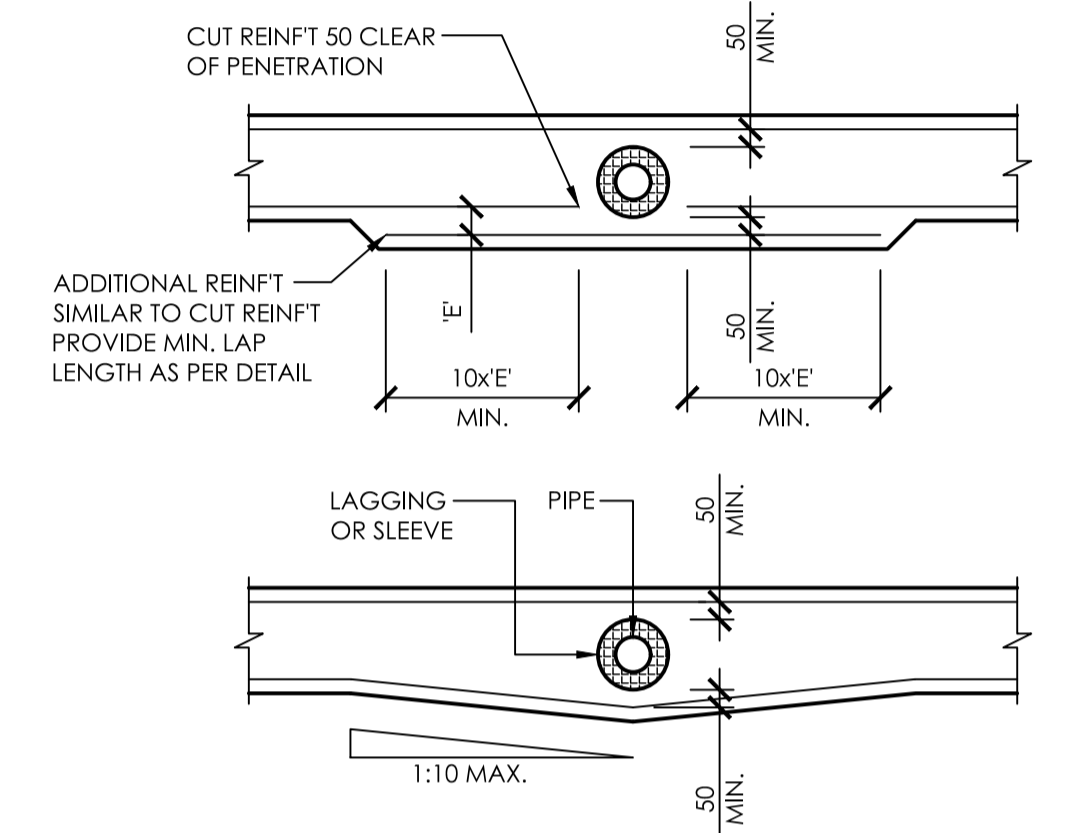


DETAILS WHERE PENETRATIONS UNAVOIDABLE CLASH WITH REINFORCEMENT
N.T.S.

SCHEDULE OF SEWER CONNECTIONS

	CONNECTION INVERT	UNIT FFL	DISTANCE TO CONNECTION	FALL REQUIRED	FALL AVAILABLE
UNIT 1	470.87	472.85	20	1.23	1.98
UNIT 2	470.87	472.85	58	1.86	1.98
UNIT 3	470.64	472.7	23	1.28	2.06
UNIT 4	470.64	472.7	45	1.64	2.06
UNIT 5	470.64	472.7	59	1.87	2.06
UNIT 6	470.64	472.52	33	1.44	1.88
UNIT 7	470.64	472.52	31	1.41	1.88
UNIT 8	470.64	472.52	49	1.71	1.88
UNIT 9	470.27	472.3	28	1.36	2.03
UNIT 10	470.27	472.3	58.0	1.86	2.03

SEWER CONNECTION NOTES
ASSUMPTIONS FOR FALL REQUIRED TAKEN FROM WSA02 - 2002-2.3:4.6.5.3
* SEWER PIPES TO HAVE 900 COVER ASSUMED FROM FFL START OF DRAIN AS PER FIGURE 4.1 WSA02-2002-2.3
GRADES TAKEN AS 1.65% AS PER 100mm SEWER MINIMUM GRADE FROM AS/NZS 3500.2:3.7

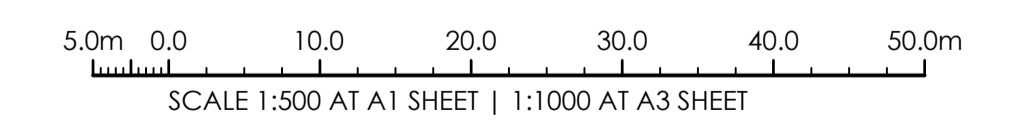

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ISSUED FOR CONSTRUCTION	DATE	BY	REVISION
ISSUED FOR CONSTRUCTION	26.02.21	J.D.	2
ISSUED FOR CONSTRUCTION	25.02.21	J.D.	1
ISSUED FOR CONSTRUCTION	23.02.21	J.D.	0
ISSUED FOR APPROVAL	26-08-2020	A	Rev.5
AMENDMENTS	DATE	ISSUE	BY

GISELLE DENLY DRAFTING
53 HILL SIXTY DRIVE
MUDGEES NSW 2850

CLIENT
SWORDS GROUP
UNIT 5/13 SYDNEY ROAD
MUDGEES NSW 2850

PROJECT
PROPOSED INDUSTRIAL UNITS
LOTS 4-7 WILKINS CRESCENT
MUDGEES NSW 2850



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PO BOX 474, TANUNDA SA 5352


DRAWING TITLE
SEWER PLAN

FOR CONSTRUCTION


DESIGNED -- DRAWN -- DATE FEB 21 SIZE AS NOTED CAD REF TX14938.00 - C01

ADELAIDE | BAROSSA | DARWIN | MUDGEES | PARRAMATTA | SYDNEY


PROJECT No. TX14938.00 - **DRAWING No.** C6.00 **ISSUE** 2

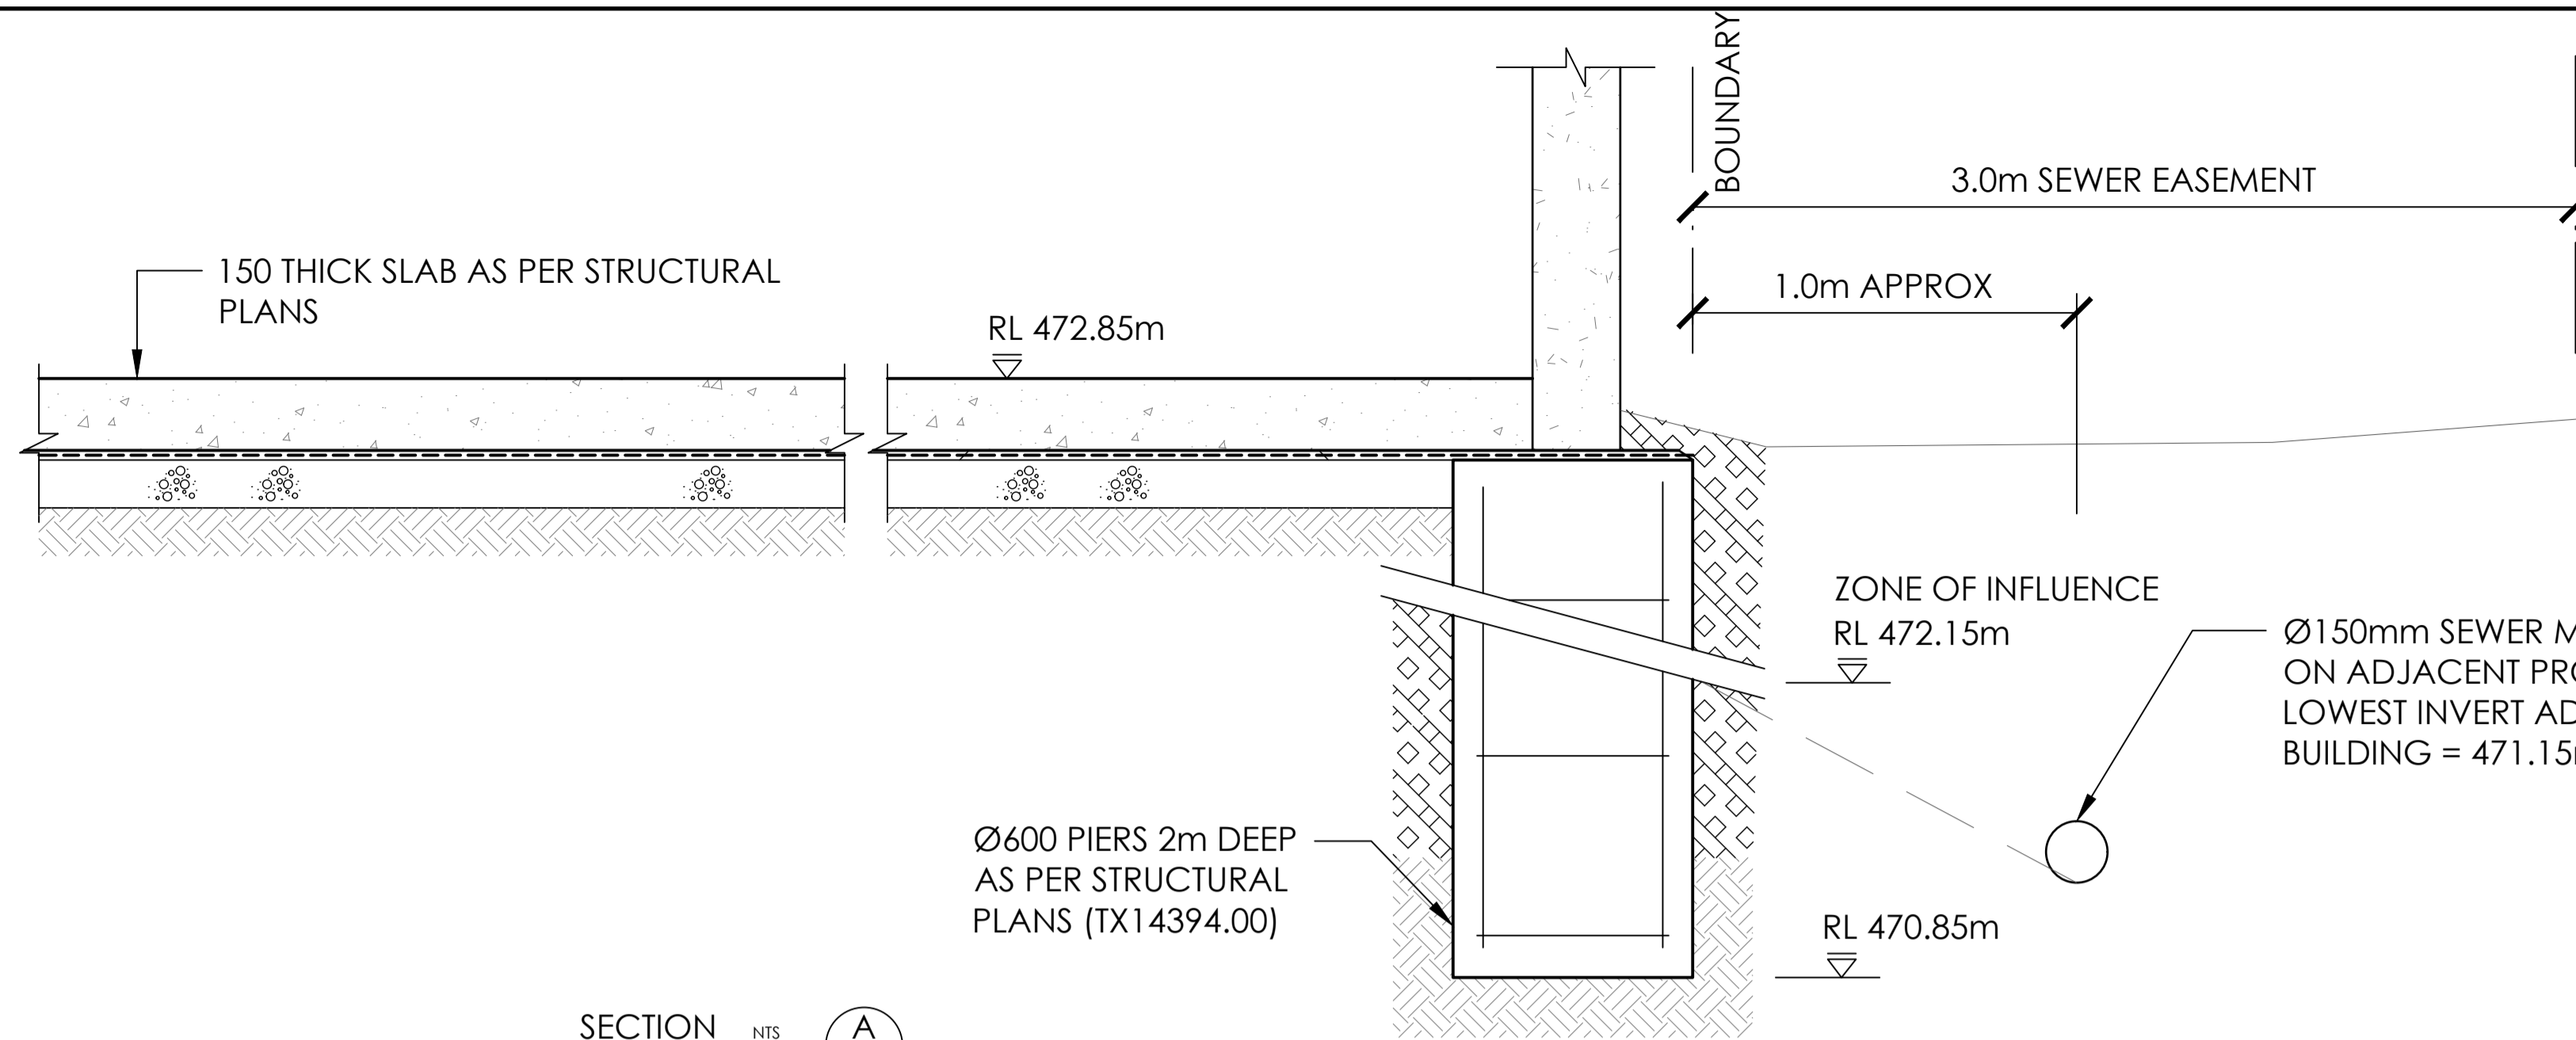


SECTION A
UNIT 1 NTS 6.00

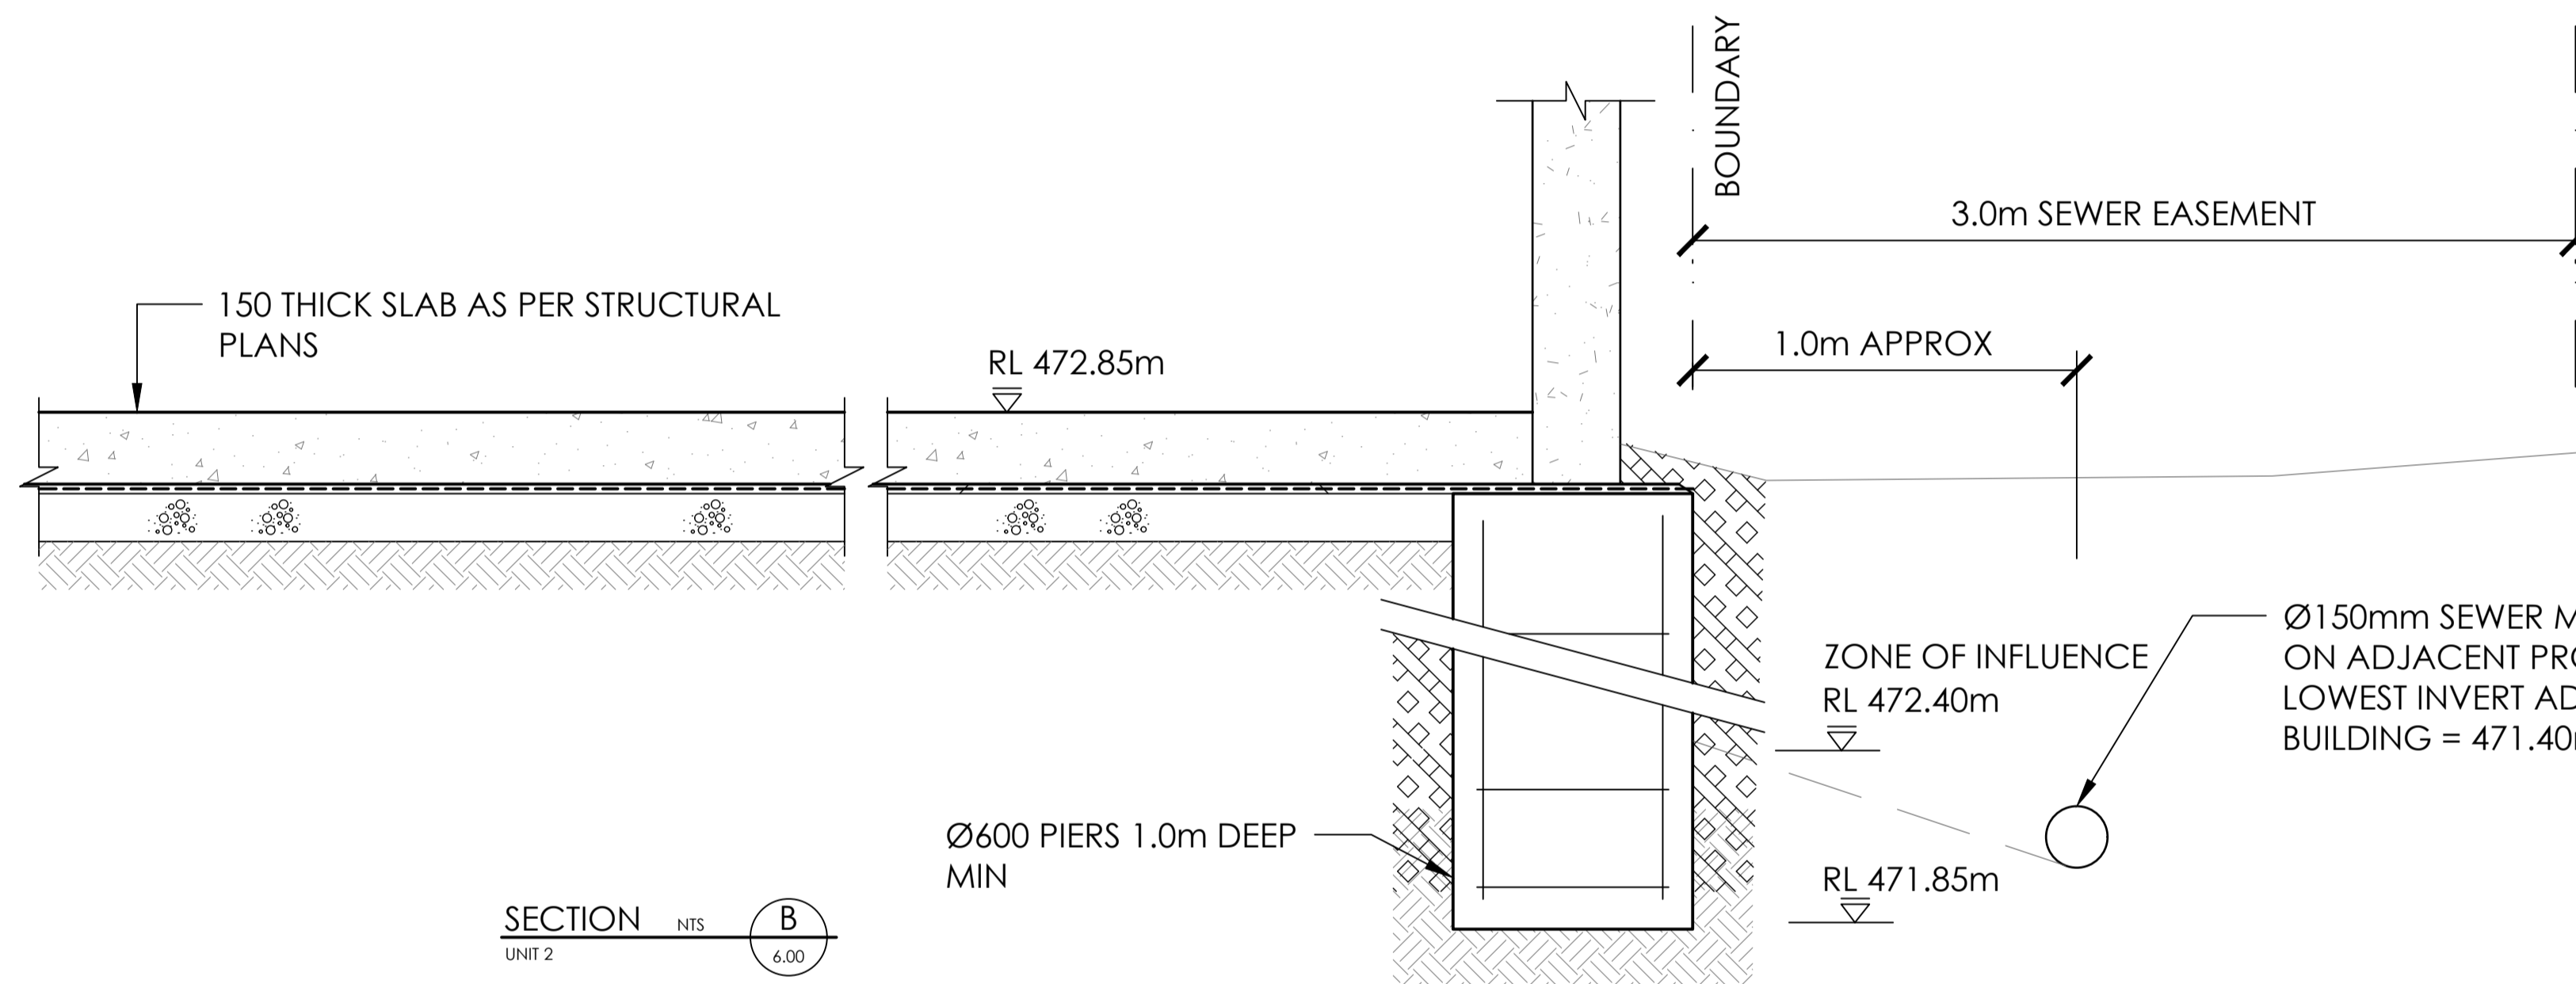

SECTION B
UNIT 2 NTS 6.00

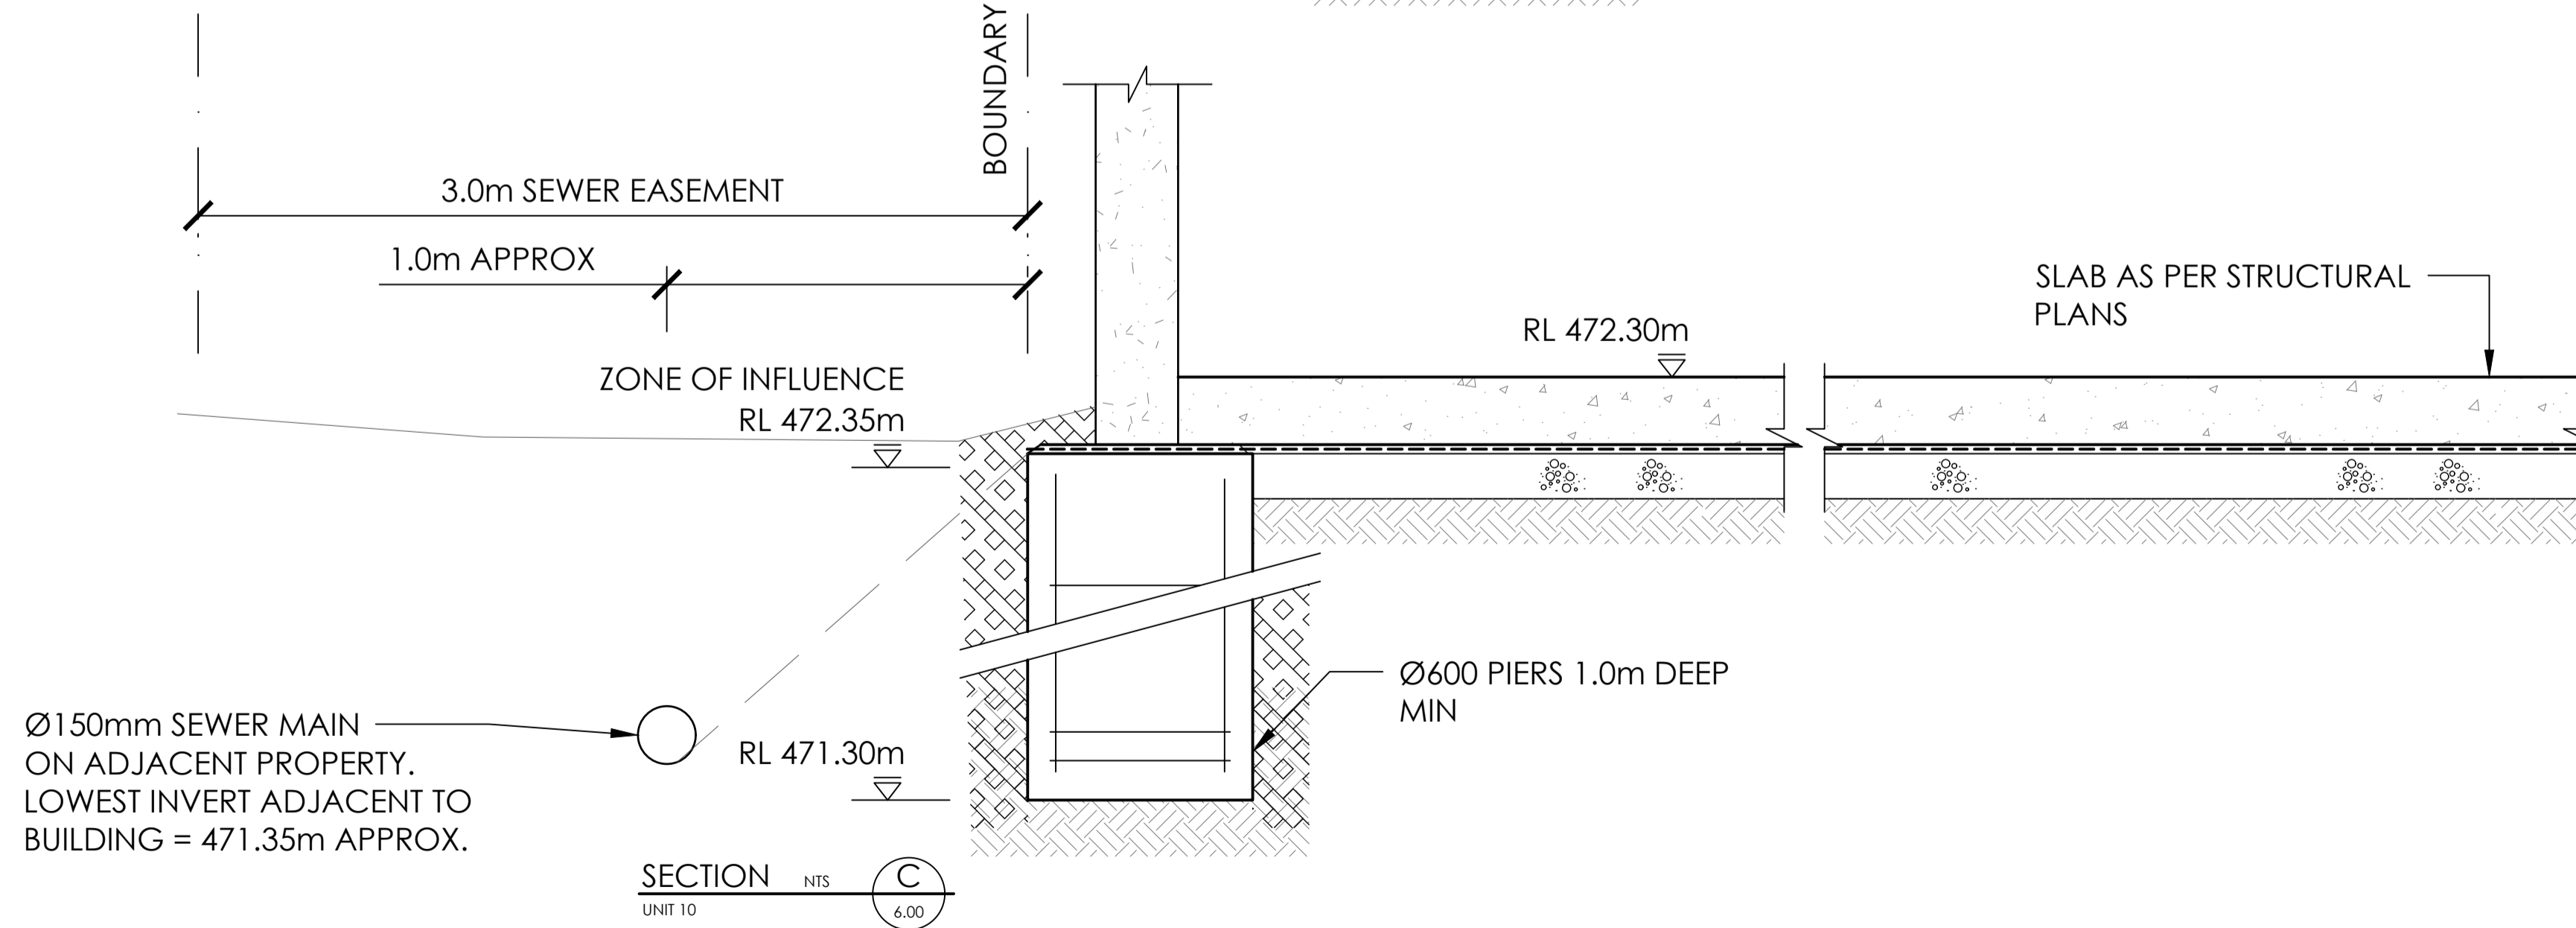

SECTION C
UNIT 10 NTS 6.00

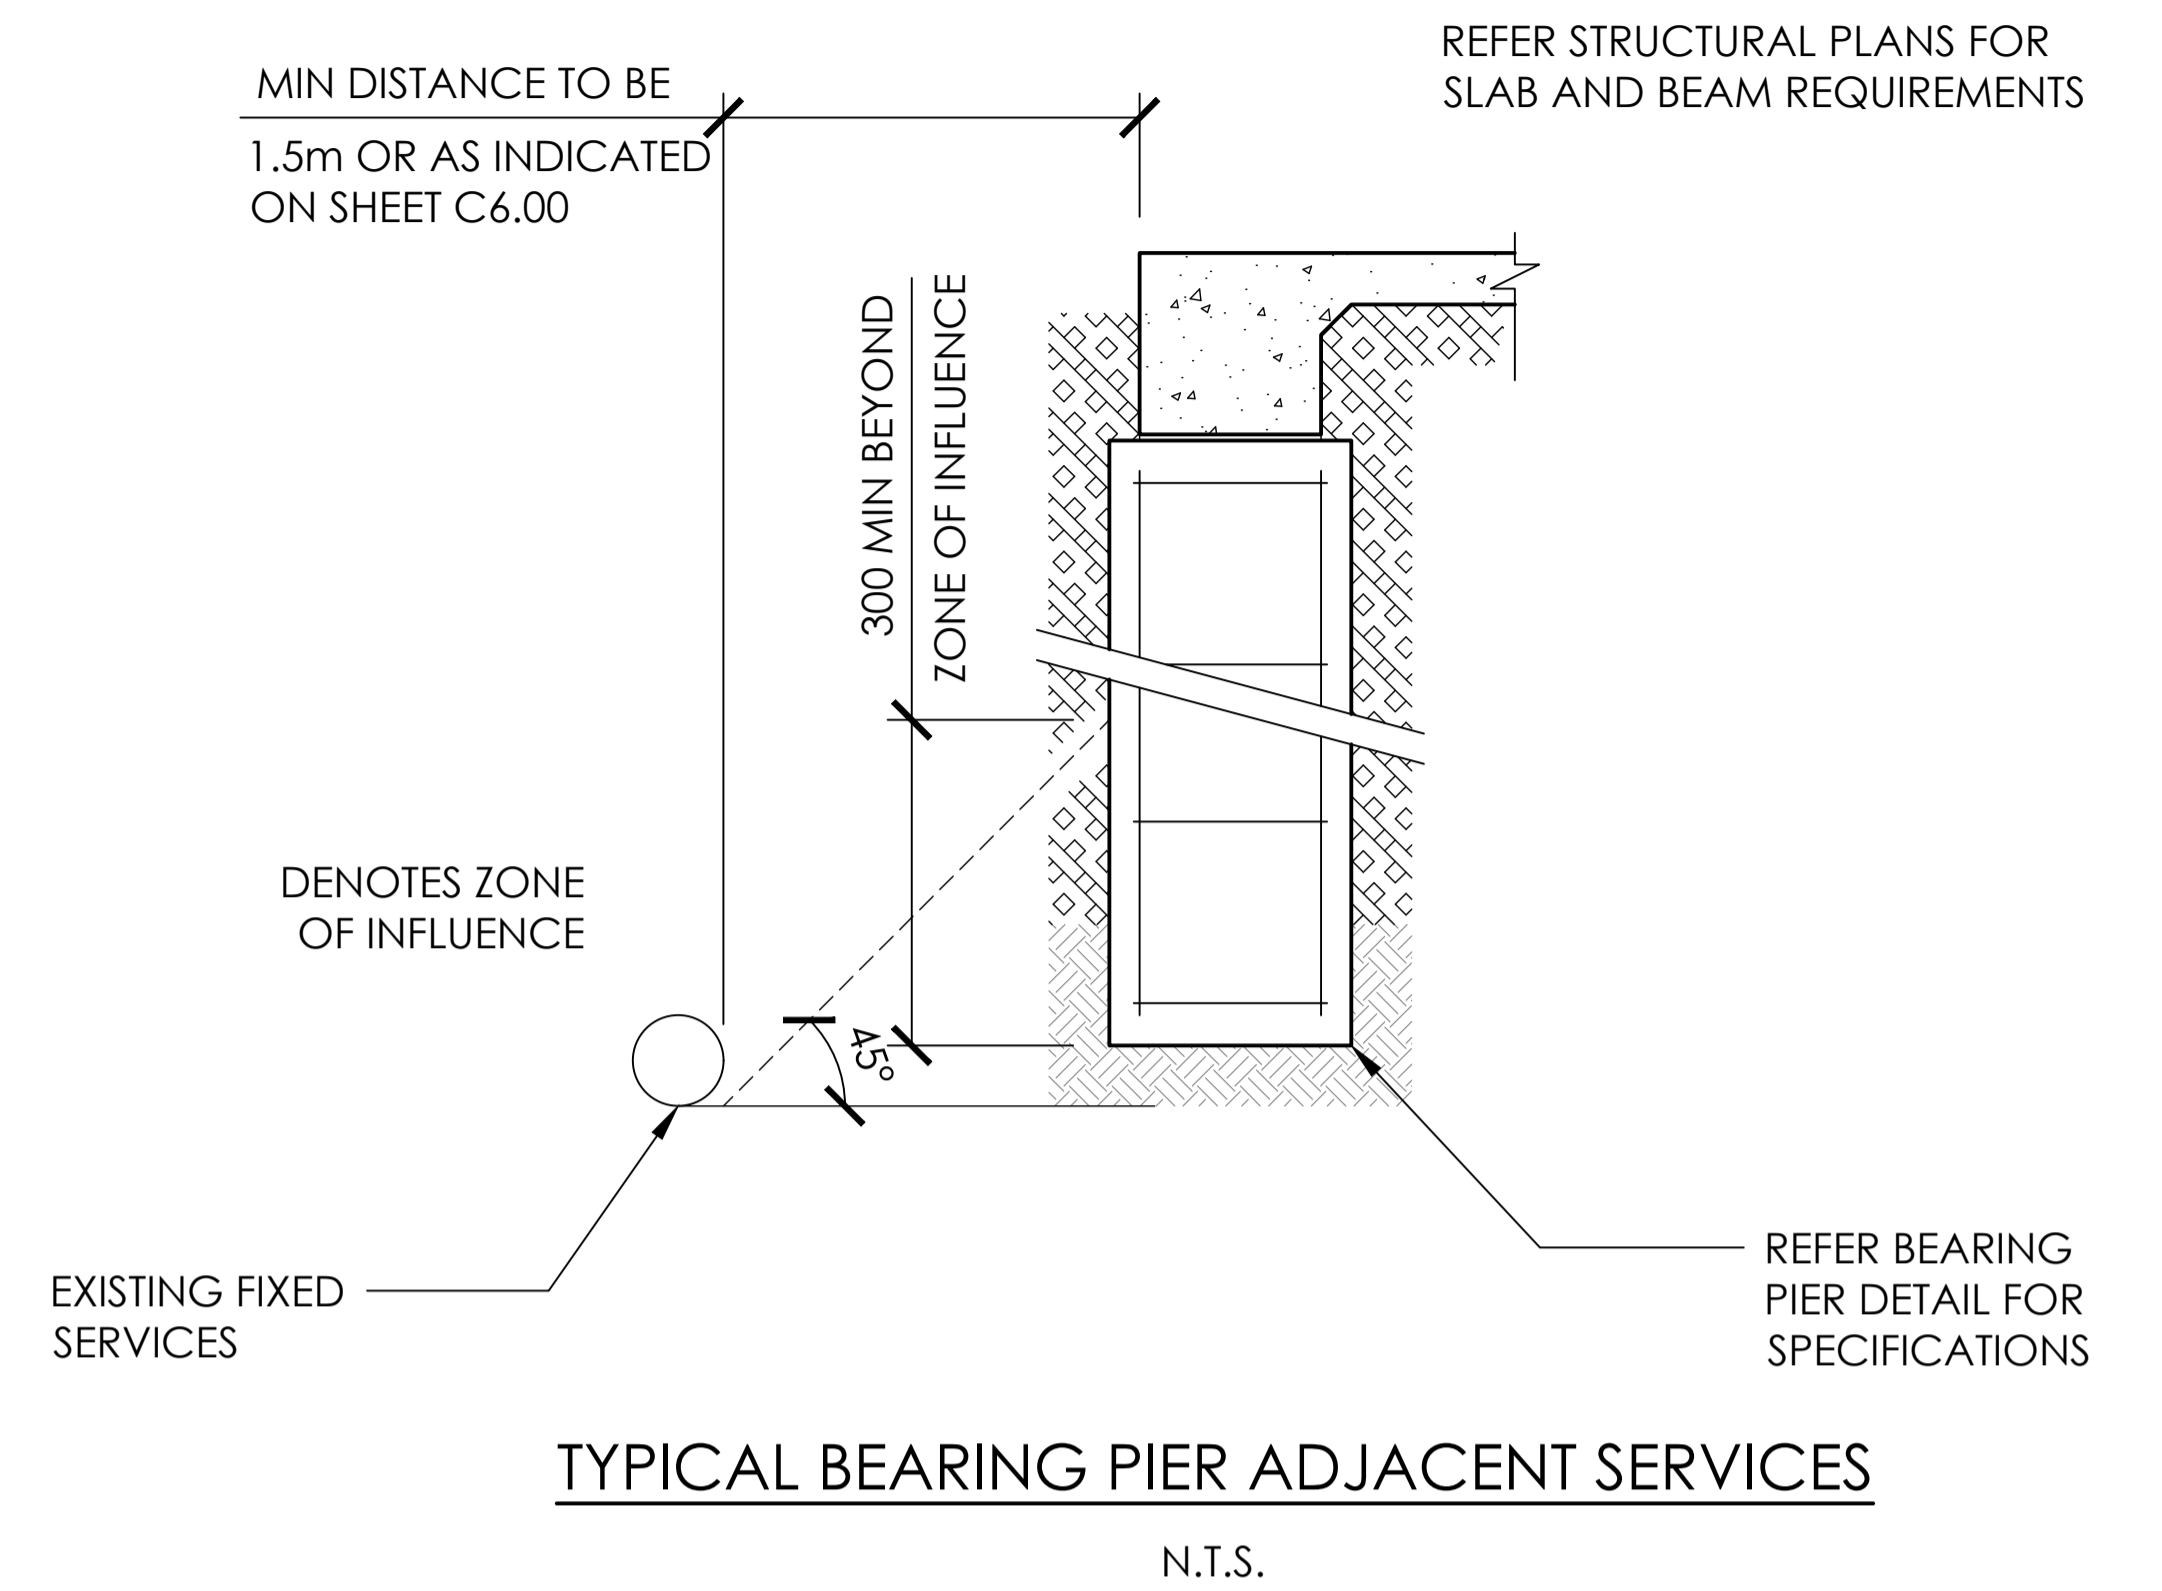

ISSUED FOR APPROVAL
AMENDMENTS

21.02.26 0 J.D.
DATE ISSUE BY

ARCHITECT
GISELLE DENLY DRAFTING
53 HILL SIXTY DRIVE
MUDGEE NSW 2850

CLIENT
SWORDS GROUP
UNIT 5/13 SYDNEY ROAD
MUDGEE NSW 2850

PROJECT
PROPOSED INDUSTRIAL UNITS
LOTS 4-7 WILKINS CRESCENT
MUDGEE NSW 2850

DESIGNED -- DRAWN -- DATE FEB 21 SIZE AS NOTED CAD REF TX14938.00 - C01



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ADELAIDE | BAROSSA | DARWIN | MUDGEE | PARRAMATTA | SYDNEY

DRAWING TITLE
BUILDING CROSS SECTIONS

PROJECT No. **TX14938.00 - C6.01** DRAWING No. **0** ISSUE **0**

FOR CONSTRUCTION