HAYES CONSTRUCTION

MULTI-UNIT DEVELOPMENT AT 22 LAWSON STREET **MUDGEE NSW 2850**


DRAWING SCHEDULE

37340-C02 PROPOSED SITE PLAN

37340-C03 PROPOSED STORMWATER PLAN

37340-C04 PROPOSED SEWER PLAN

37340-C05 PROPOSED HYDRANT PLAN 37340-C06 PROPOSED VEHICLE TURNING PLAN

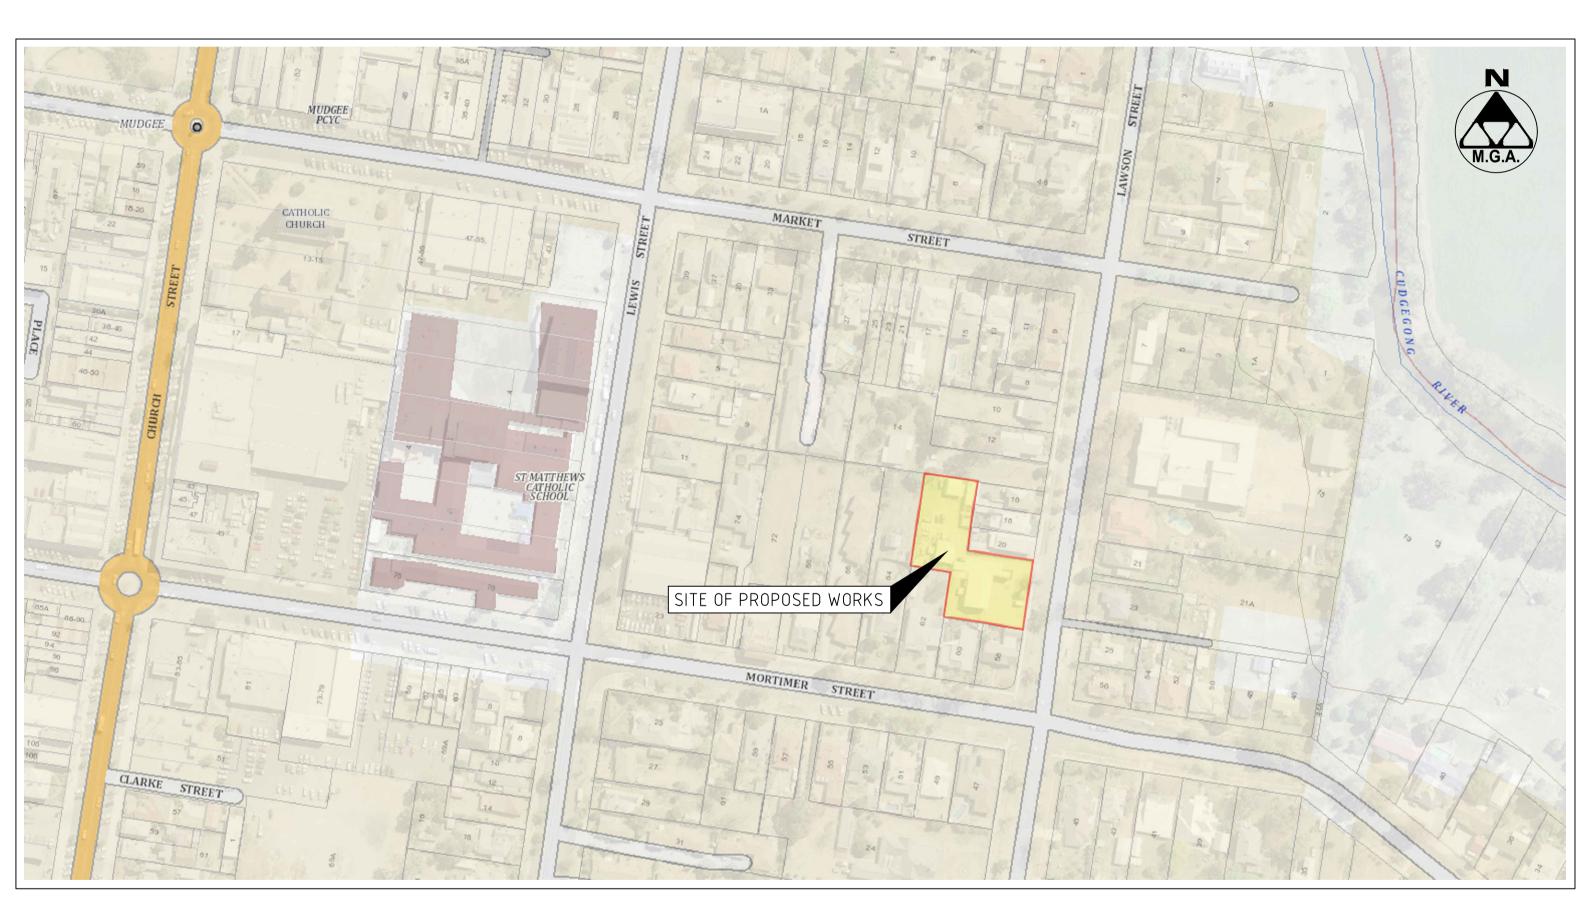

LOCALITY PLAN NOT TO REDUCTION RATIO

SUBMISSION FOR DA



BARNSON PTY LTD

† 1300 BARNSON (1300 227 676)

generalenquiry@barnson.com.au

THIS DRAWING IS TO BE READ IN CONJUNCTION WITH GENERAL BUILDING DRAWINGS, SPECIFICATIONS & OTHER CONSULTANTS DRAWINGS APPLICABLE TO THIS PROJECT. ALL DIMENSIONS IN MILLIMETRES. DO NOT SCALE. DIMENSIONS TO BE CHECKED ON SITE BEFORE COMMENCEMENT OF WORK. REPORT DISCREPANCIES TO BARNSON PTY LTD. NO PART OF THIS DRAWING MAY BE

REPRODUCED IN ANY WAY WITHOUT THE WRITTEN

PERMISSION OF BARNSON PTY LTD.

HAYES CONSTRUCTION

MULTI-UNIT DEVELPMENT AT 22 LAWSON STREET

MUDGEE NSW 2850

Drawing Title: COVER SHEET

Rev Date Amendment A 19-08-2021 ISSUED FOR DA


Certification

Drawn **MK**

Drawing Number Original Sheet Size = A1 37340 - C00

Revision



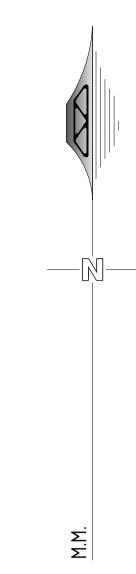



LEGEND

EXISTING SUBJECT CADASTRAL BOUNDARIES

— Ex. S — Ex. S — EXISTING UNDERGROUND SEWER PIPE

EXISTING SEWER MANHOLE

NOTES:

- THE BOUNDARY INFORMATION SHOWN ON THIS PLAN BEEN PLOTTED AS REQUIRED UNDER DIVISION 1, SECTION 9.(1) OF THE "SURVEYING AND SPATIAL INFORMATION REGULATION 2017". IT HAS NOT BEEN DETERMINED BY AN ACCURATE
- A DETAIL & LEVEL SURVEY IS NOT A "LAND SURVEY" AS DEFINED BY THE SURVEYING AND SPATIAL INFORMATION ACT 2002. IF ANY CONSTRUCTION OR DESIGN WORK WHICH RELIES ON CRITICAL SETBACKS FROM THE STREET OR BOUNDARIES IS PLANNED, IT WOULD BE IMPERATIVE TO CARRY OUT FURTHER SURVEY WORK TO DETERMINE THE
- THE LOCATIONS AND DEPTHS OF UNDERGROUND SERVICES ARE NOT ASSURED BY BARNSON. SERVICE AUTHORITIES
- SHOULD BE CONSULTED BEFORE ANY EXCAVATION, DEMOLITION OR CONSTRUCTION COMMENCES. THERE MAY BE UNDERGROUND SERVICES THAT HAVE NOT BEEN SHOWN HEREON.

MAY OCCUR DUE TO THE RELIANCE ON THIS PLAN FOR THE LOCATION OF UNDERGROUND SERVICES.

BARNSON TAKES NO RESPONSIBILITY FOR LOSSES, DAMAGES OR INJURIES TO ANY PERSON OR ORGANISATION THAT

THIS DRAWING IS TO BE READ IN CONJUNCTION WITH GENERAL BUILDING DRAWINGS, SPECIFICATIONS & OTHER CONSULTANTS

PERMISSION OF BARNSON PTY LTD.

DRAWINGS APPLICABLE TO THIS PROJECT. ALL DIMENSIONS IN MILLIMETRES. DO NOT SCALE. DIMENSIONS TO BE CHECKED ON SITE BEFORE COMMENCEMENT OF WORK. REPORT DISCREPANCIES TO BARNSON PTY LTD. NO PART OF THIS DRAWING MAY BE REPRODUCED IN ANY WAY WITHOUT THE WRITTEN

HAYES CONSTRUCTION Client: Project:

1:400 @ A3

REDUCTION RATIO 1:200 @ A1

MULTI-UNIT DEVELPMENT AT 22 LAWSON STREET MUDGEE NSW 2850

Drawing Title: **EXISTING SITE PLAN**

SCALE 1:400(A3)

SUBMISSION FOR DA



BARNSON PTY LTD

- † 1300 BARNSON (1300 227 676) e generalenquiry@barnson.com.auw www.barnson.com.au

Rev Date Amendment A 19-08-2021 ISSUED FOR DA


Design **LM** Certification

Drawn **MK** Check LM

Drawing Number Original Sheet Size = A1

Revision

37340 - C01

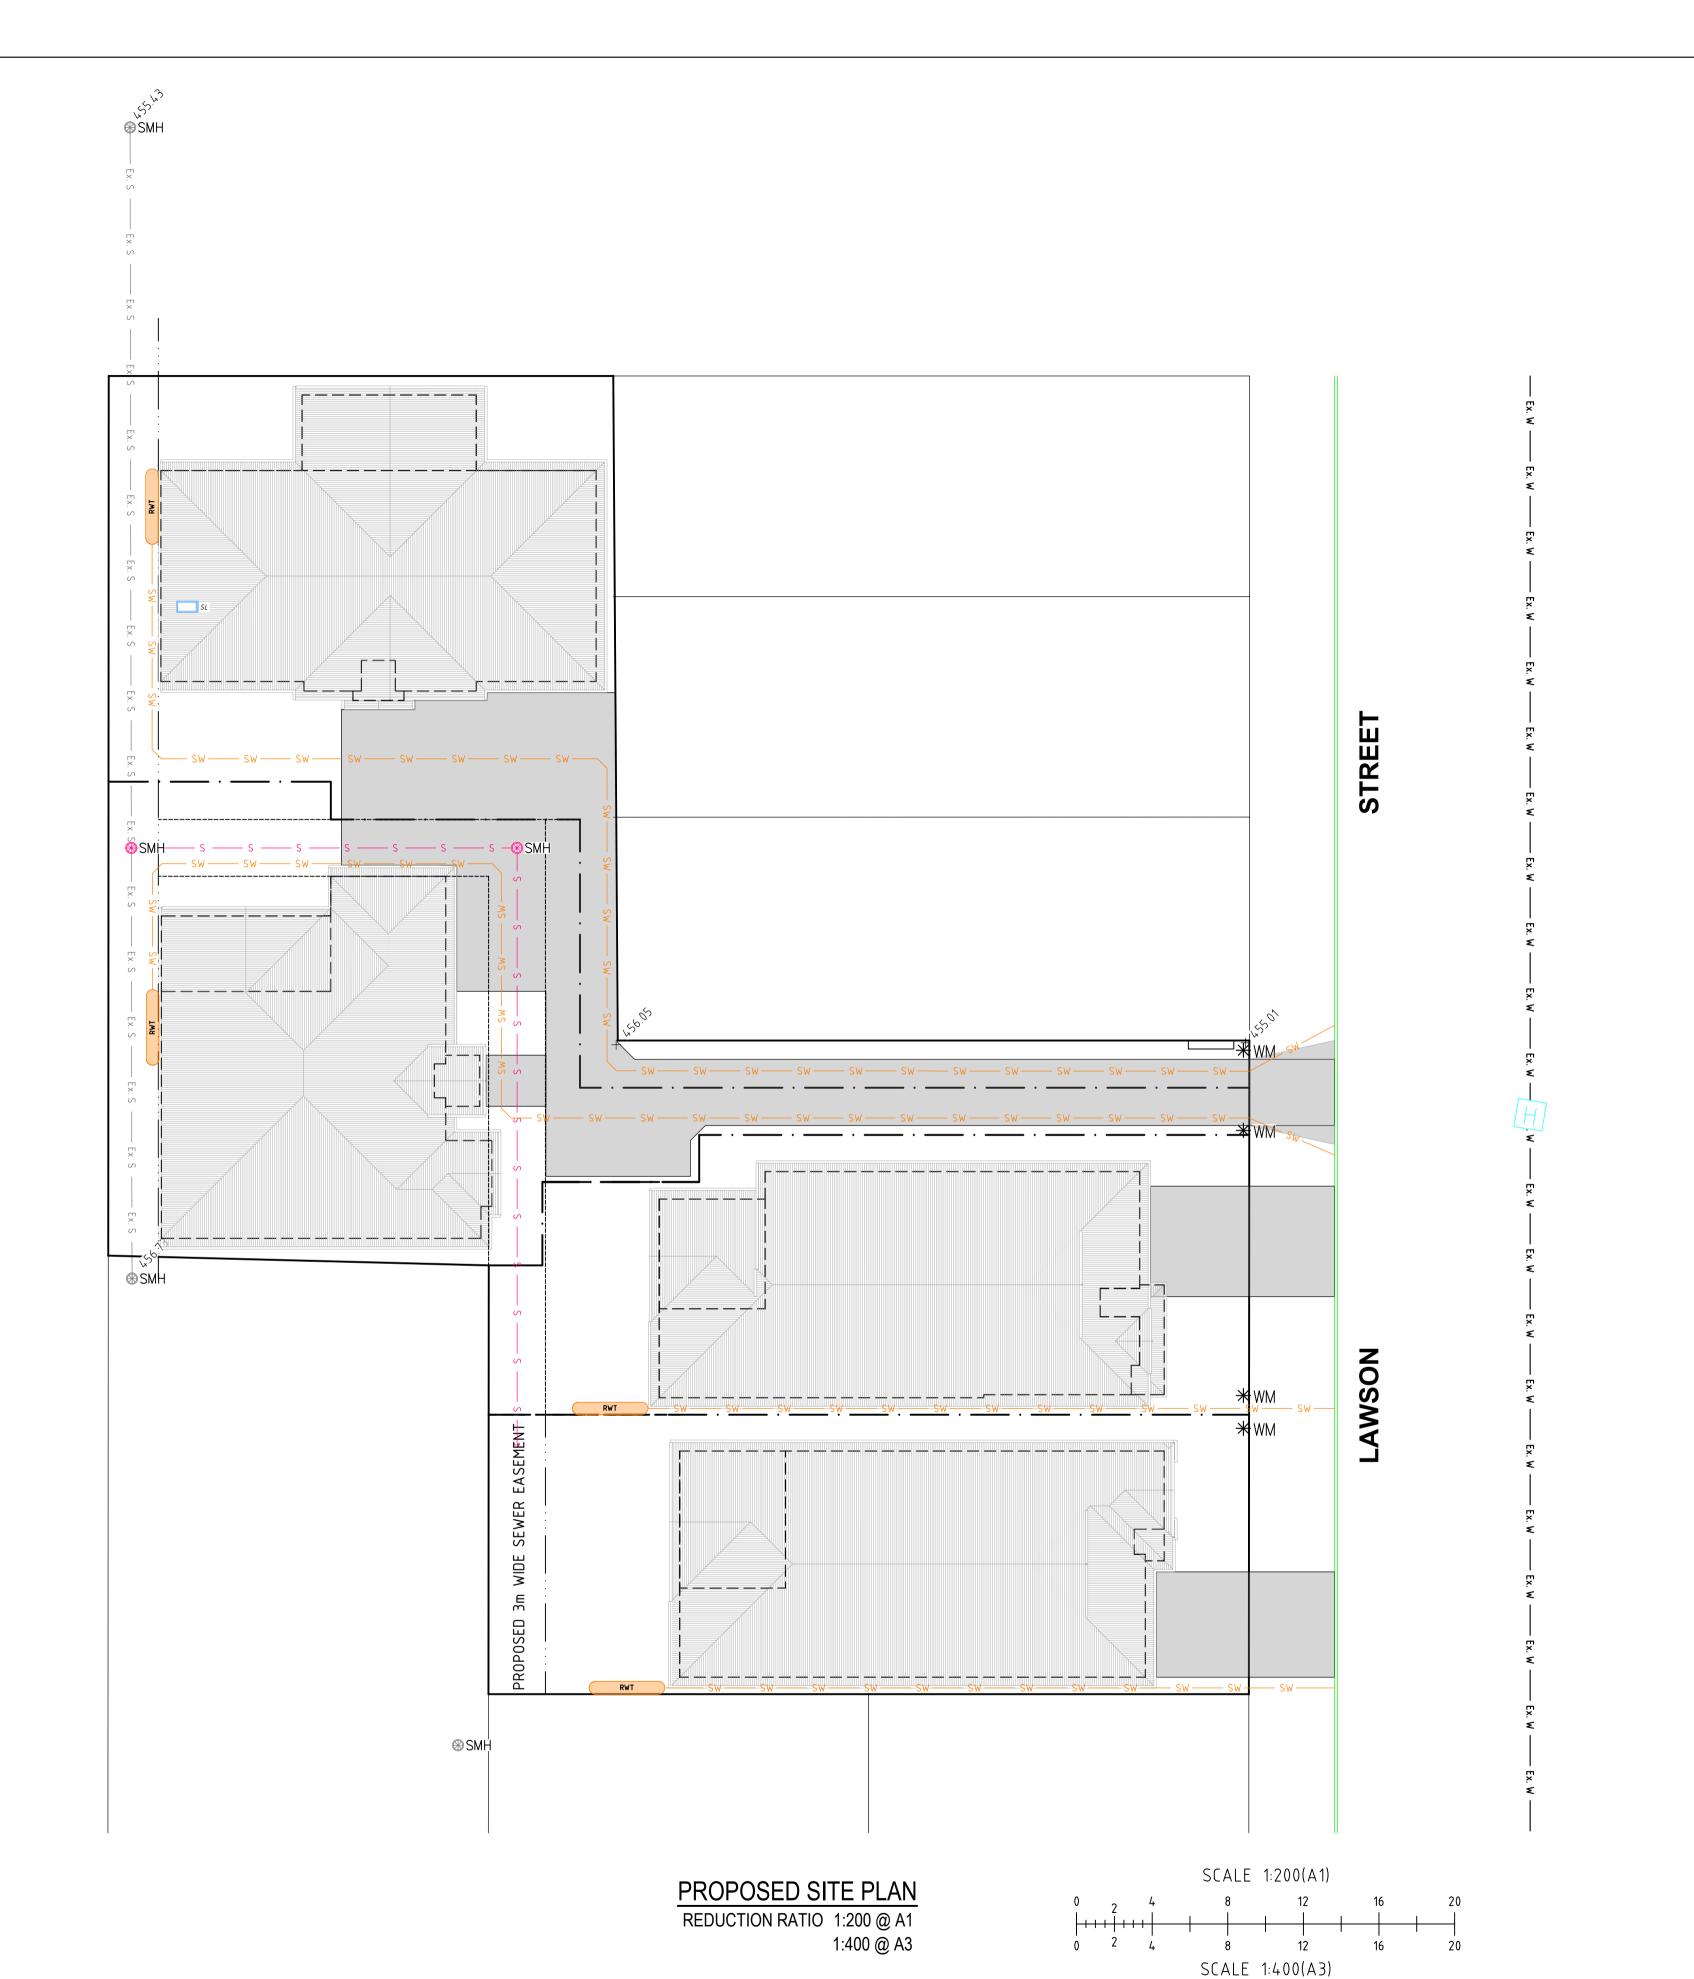



*wm

- THE BOUNDARY INFORMATION SHOWN ON THIS PLAN BEEN PLOTTED AS REQUIRED UNDER DIVISION 1, SECTION 9.(1) OF THE "SURVEYING AND SPATIAL INFORMATION REGULATION 2017". IT HAS NOT BEEN DETERMINED BY AN ACCURATE
- A DETAIL & LEVEL SURVEY IS NOT A "LAND SURVEY" AS DEFINED BY THE SURVEYING AND SPATIAL INFORMATION ACT 2002. IF ANY CONSTRUCTION OR DESIGN WORK WHICH RELIES ON CRITICAL SETBACKS FROM THE STREET OR BOUNDARIES IS PLANNED, IT WOULD BE IMPERATIVE TO CARRY OUT FURTHER SURVEY WORK TO DETERMINE THE
- THE LOCATIONS AND DEPTHS OF UNDERGROUND SERVICES ARE NOT ASSURED BY BARNSON. SERVICE AUTHORITIES
- SHOULD BE CONSULTED BEFORE ANY EXCAVATION, DEMOLITION OR CONSTRUCTION COMMENCES.

LEGEND

EXISTING SEWER MANHOLE

LEGEND (proposed)

EXTENT OF PROPOSED ROOF

PROPOSED RAINWATER TANK

PROPOSED SEWER MANHOLE

PROPOSED SEWER PIPE

PROPOSED WATER MAIN

PROPOSED WATER METER

PROPOSED HYDRANT

PROPOSED EASEMENT

EXISTING SUBJECT CADASTRAL BOUNDARIES

EXTENT OF PROPOSED CONCRETE PAVEMENT

PROPOSED STORMWATER DRAINAGE PIPE

EXISTING UNDERGROUND SEWER PIPE EXISTING UNDERGROUND WATER MAIN

- THERE MAY BE UNDERGROUND SERVICES THAT HAVE NOT BEEN SHOWN HEREON.
- BARNSON TAKES NO RESPONSIBILITY FOR LOSSES, DAMAGES OR INJURIES TO ANY PERSON OR ORGANISATION THAT MAY OCCUR DUE TO THE RELIANCE ON THIS PLAN FOR THE LOCATION OF UNDERGROUND SERVICES.



BARNSON PTY LTD

- † 1300 BARNSON (1300 227 676) e generalenquiry@barnson.com.au
- w www.barnson.com.au

THIS DRAWING IS TO BE READ IN CONJUNCTION WITH GENERAL BUILDING DRAWINGS, SPECIFICATIONS & OTHER CONSULTANTS DRAWINGS APPLICABLE TO THIS PROJECT. ALL DIMENSIONS IN MILLIMETRES. DO NOT SCALE. DIMENSIONS TO BE CHECKED ON SITE BEFORE COMMENCEMENT OF WORK. REPORT DISCREPANCIES TO BARNSON PTY LTD. NO PART OF THIS DRAWING MAY BE REPRODUCED IN ANY WAY WITHOUT THE WRITTEN PERMISSION OF BARNSON PTY LTD.

HAYES CONSTRUCTION Client: MULTI-UNIT DEVELPMENT AT Project: 22 LAWSON STREET MUDGEE NSW 2850

Drawing Title: PROPOSED SITE PLAN

Rev Date Amendment A 19-08-2021 ISSUED FOR DA

Design **LM** Certification

Drawn **MK**

Original Sheet


Size = A1

Drawing Number

37340 - C02

SUBMISSION FOR DA

Revision

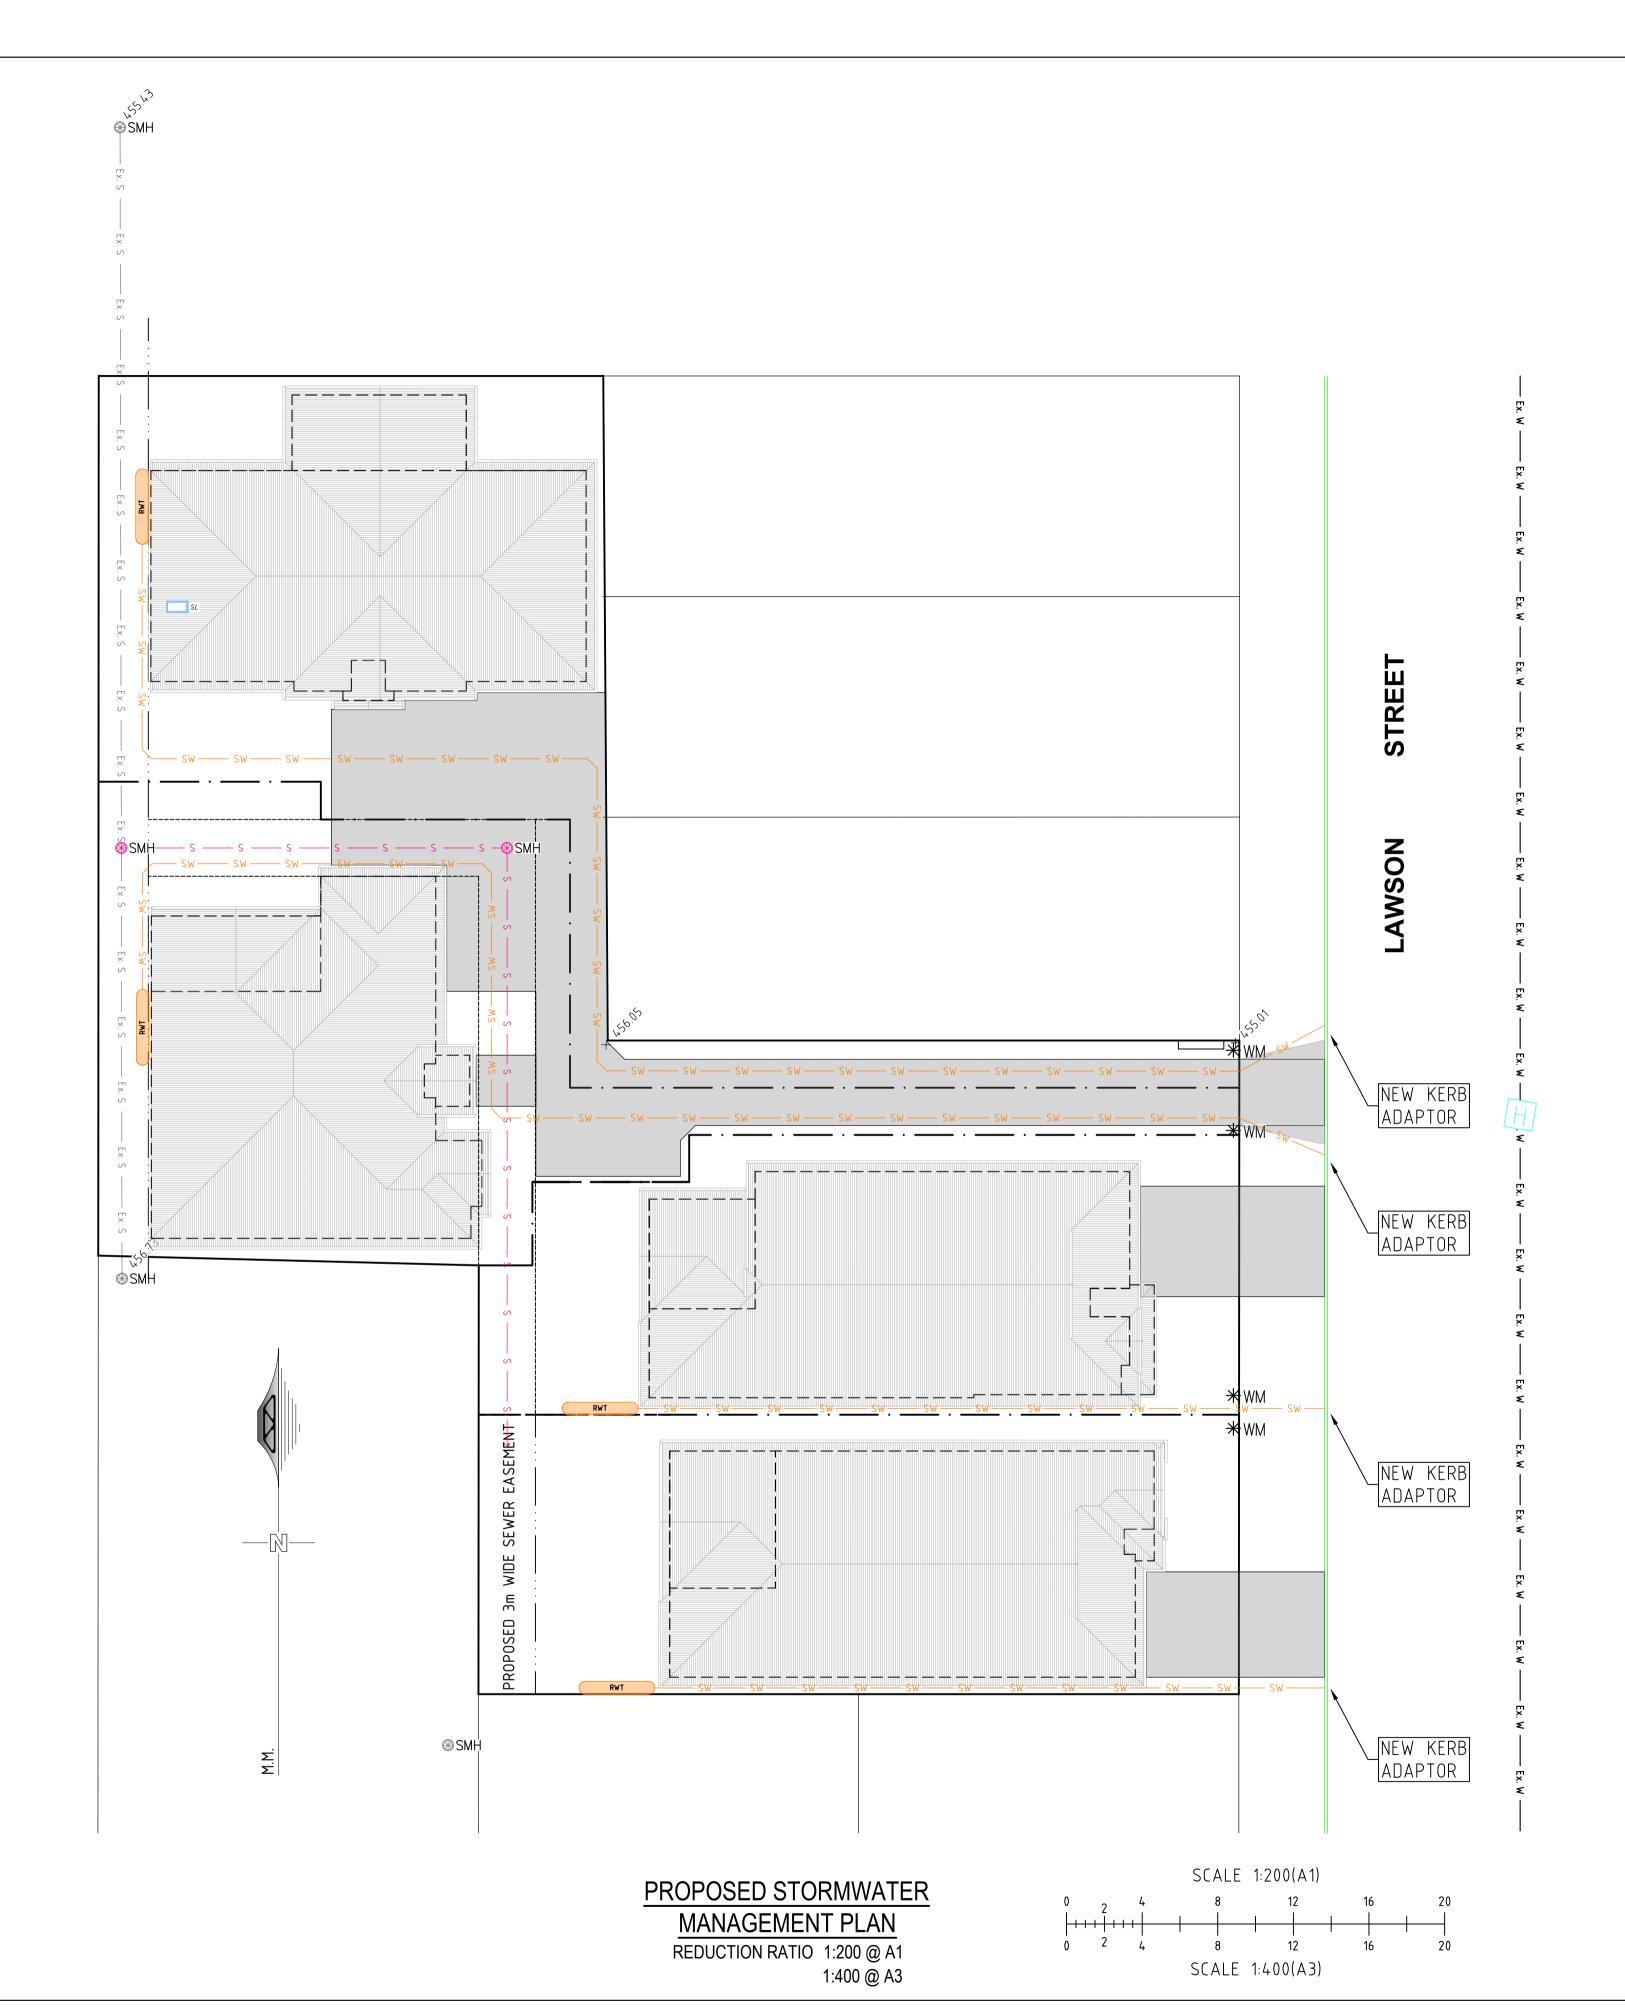

STORMWATER NOTES

STORMWATER ANALYSIS

1. DESIGN CALCULATIONS AS PER AS3500.3-2015

2.RAINFALL INTENSITY FOR 5 MINUTES DURATION AND 5% AEP I₅ = 147 mm/hr.

HYDRAULIC ANALYSIS

DESIGN CALCULATIONS AS PER AS3500.3-2015
 A) <u>PRE-DEVELOPED:</u>

 TOTAL APPLICABLE CATCHMENT AREA (A) = 2572 m²

-RAINFALL INTENSITY (15) = 147mm/hr (5min 5% AEP)
-Cr = RUNOFF COEFFICIENT FOR ROOF AREA = 1.0

-Ar = TOTAL ROOF AREA = 0 m²

-Ci = RUNOFF COEFFICIENT FOR UNROOFED IMPERVIOUS AREA = 0.9
-Ai = TOTAL UNROOFED IMPERVIOUS AREA = 0 m²

-Cp = RUNOFF COEFFICIENT FOR PERVIOUS GRAVEL AREA = 0.6

-CP = RUNUFF CUEFFICIENT FUR PERVIOUS GRAVEL AREA = C
-Ap = TOTAL IMPERVIOUS GRASS AREA = 2572 m²

-TOTAL FLOW Q_{PRE} = (Cr Ar+Ci Ai+Cp Ap). 1 / 3600 = 63.0 l/s

B) POST-DEVELOPED FLOW:

-TOTAL APPLICABLE CATCHMENT AREA (A) = 2572 m²
-RAINFALL INTENSITY (ξ) = 147mm/hr (5min 5% AEP)

-RAINFALL INTENSITY (15) = 14/mm/nr (5min 5% AEF -Cr = RUNOFF COEFFICIENT FOR ROOF AREA = 1.0 -Ar = TOTAL ROOF AREA= 1320 m²

-Ci = RUNOFF COEFFICIENT FOR UNROOFED IMPERVIOUS AREA = 0.9
-Ai = TOTAL UNROOFED IMPERVIOUS AREA = 411 m²

-Cp = RUNOFF COEFFICIENT FOR PERVIOUS GRASS AREA = 0.3

-Ap = TOTAL PERVIOUS GRASS AREA = 841 m²

-TOTAL FLOW Q_{POST} = (Cr Ar+Ci Ai+Cp Ap). I / 3600 = 79.3 l/s

2. RAINWATER TANK:

-ROOF AREA OF PROPOSED UNITS = 1320 m²
-RUNOFF FROM ROOF FOR 5% AEP = 53.9 l/s
-SITE RUNOFF BYPASSING RWT = 25.4 l/s
-CONTROLLED OUTFLOW = 37.6 l/s

-REQUIRED STORAGE VOLUME = (63 l/s - 25.4 l/s) × 60s × 5 min = 11,280 L OVERALL

= 2,820 L PER DWELLING +1,000L BASIX

-FOR EACH DWELLING, PROVIDE 4,000 L RAINWATER TANK WITH OUTFLOW < 9.4 L/s

DESIGN NOTE:

AEP = 5%

DURATION = 5 MIN.

RAINFALL INTENSITY =147mm/h

SUBMISSION FOR DA

barnson

LEGEND

EXISTING SUBJECT CADASTRAL BOUNDARIES

EXTENT OF PROPOSED CONCRETE PAVEMENT

PROPOSED STORMWATER DRAINAGE PIPE

THE BOUNDARY INFORMATION SHOWN ON THIS PLAN BEEN PLOTTED AS REQUIRED UNDER DIVISION 1, SECTION 9.(1) OF THE "SURVEYING AND SPATIAL INFORMATION REGULATION 2017". IT HAS NOT BEEN DETERMINED BY AN ACCURATE

A DETAIL & LEVEL SURVEY IS NOT A "LAND SURVEY" AS DEFINED BY THE SURVEYING AND SPATIAL INFORMATION ACT 2002. IF ANY CONSTRUCTION OR DESIGN WORK WHICH RELIES ON CRITICAL SETBACKS FROM THE STREET OR

BOUNDARIES IS PLANNED, IT WOULD BE IMPERATIVE TO CARRY OUT FURTHER SURVEY WORK TO DETERMINE THE

SHOULD BE CONSULTED BEFORE ANY EXCAVATION, DEMOLITION OR CONSTRUCTION COMMENCES.

MAY OCCUR DUE TO THE RELIANCE ON THIS PLAN FOR THE LOCATION OF UNDERGROUND SERVICES.

THERE MAY BE UNDERGROUND SERVICES THAT HAVE NOT BEEN SHOWN HEREON.

THE LOCATIONS AND DEPTHS OF UNDERGROUND SERVICES ARE NOT ASSURED BY BARNSON. SERVICE AUTHORITIES

BARNSON TAKES NO RESPONSIBILITY FOR LOSSES, DAMAGES OR INJURIES TO ANY PERSON OR ORGANISATION THAT

EXISTING UNDERGROUND SEWER PIPE EXISTING UNDERGROUND WATER MAIN

EXISTING SEWER MANHOLE

LEGEND (proposed)

EXTENT OF PROPOSED ROOF

PROPOSED RAINWATER TANK

PROPOSED SEWER PIPE

PROPOSED WATER MAIN

PROPOSED WATER METER

PROPOSED HYDRANT

*WM

PROPOSED SEWER MANHOLE

PROPOSED EASEMENT

BARNSON PTY LTD

- † 1300 BARNSON (1300 227 676)
- e generalenquiry@barnson.com.au
- w www.barnson.com.au

THIS DRAWING IS TO BE READ IN CONJUNCTION
WITH GENERAL BUILDING DRAWINGS,
SPECIFICATIONS & OTHER CONSULTANTS
DRAWINGS APPLICABLE TO THIS PROJECT.
ALL DIMENSIONS IN MILLIMETRES. DO NOT SCALE.
DIMENSIONS TO BE CHECKED ON SITE BEFORE
COMMENCEMENT OF WORK.
REPORT DISCREPANCIES TO BARNSON PTY LTD.
NO PART OF THIS DRAWING MAY BE
REPRODUCED IN ANY WAY WITHOUT THE WRITTEN
PERMISSION OF BARNSON PTY LTD.

Client: HAYES CONSTRUCTION

Project: MULTI-UNIT DEVELPMENT AT

22 LAWSON STREET

MUDGEE NSW 2850

Drawing Title: PROPOSED STORMWATER MANAGEMENT PLAN

N Rev Date Amendment
A 19-08-2021 ISSUED FOR DA

Design **LM** Certification

Drawn MK
Check LM


Original Sheet

Size = A1

Drawing Number

37340 - C03

Revision

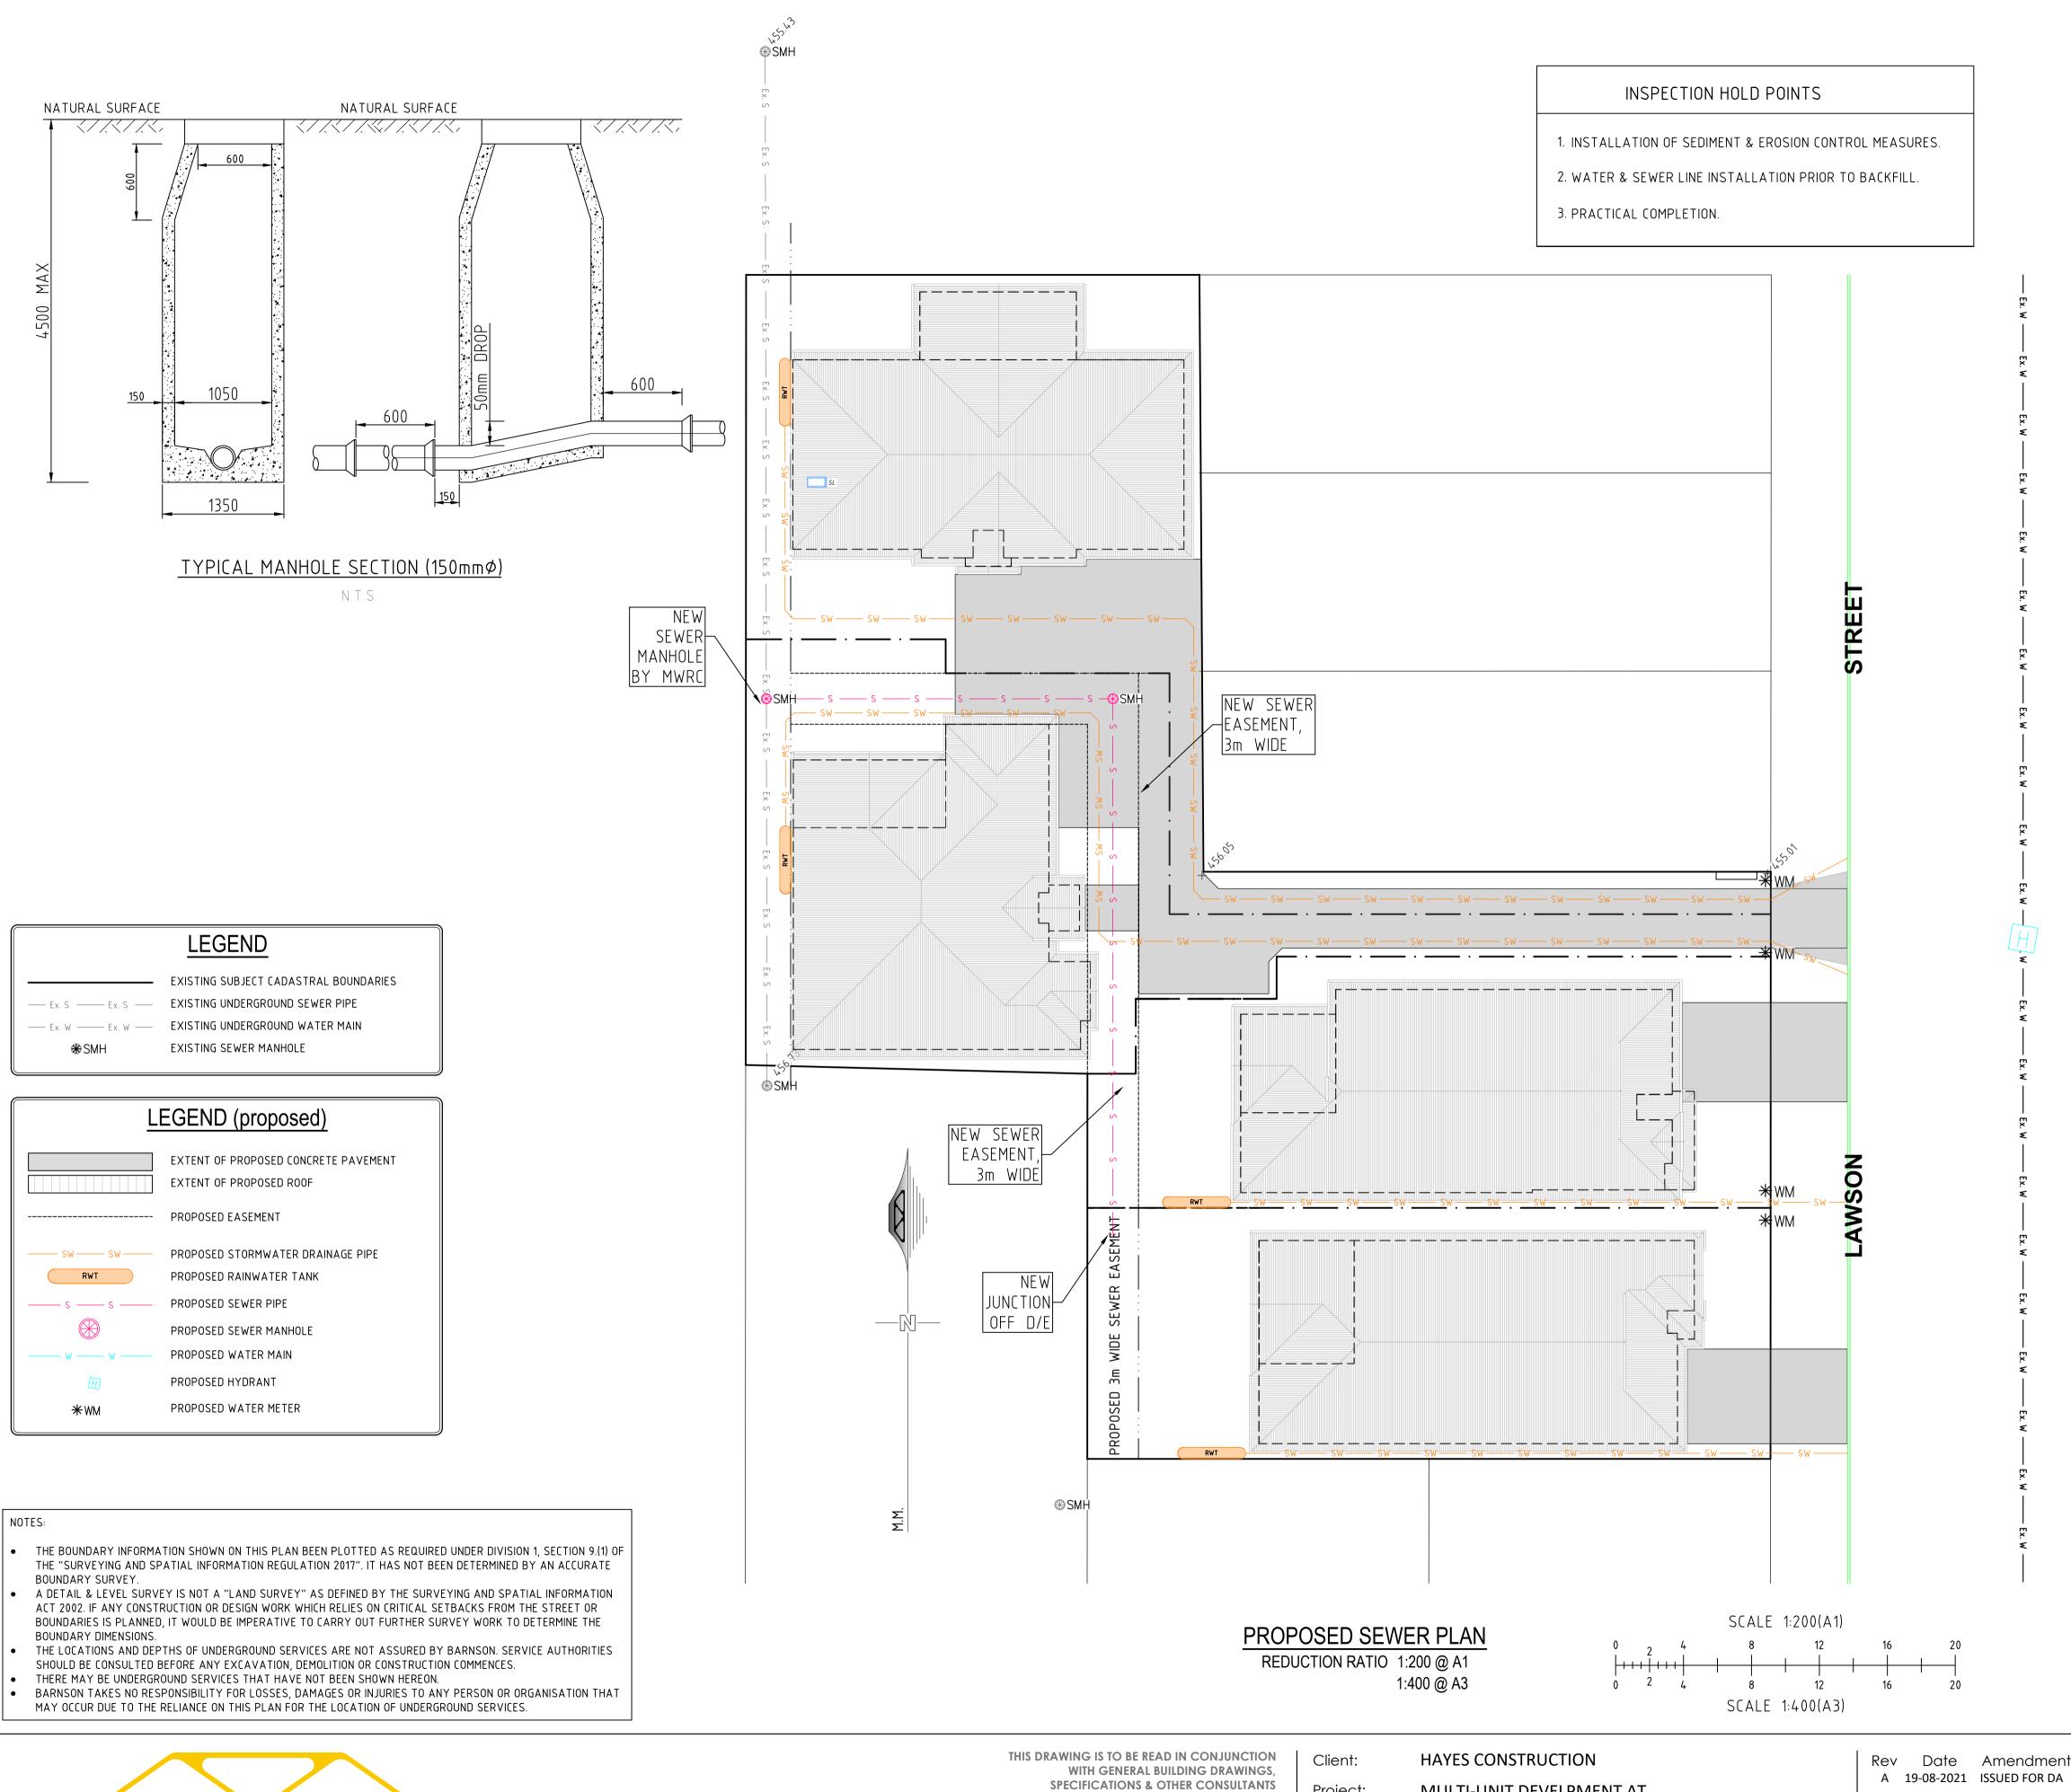


SEWER NOTES

- 1. ALL SEWER MAINS SHALL BE 1500/2250 CLASS SN8 RRJ UPVC PIPE. ALL GRAVITY LINES TO USE SEWER GRADE FITTINGS WHERE REQUIRED.
- 2. CONSTRUCTION OF SEWER MAINS AND MANHOLES SHALL BE CARRIED OUT IN ACCORDANCE WITH THE WSA SEWERAGE CODE, WSA-02, 2002.
- 3. ANY OTHER SERVICES INCLUDING TELSTRA, GAS, POWER, WATER AND STORMWATER MUST BE LOCATED BEFORE WORK COMMENCES.
- 4. MANHOLES SHALL BE PRECAST CONCRETE FROM A SUPPLIER APPROVED BY COUNCIL AND HAVE A ROUND REMOVABLE LIGHT DUTY GATIC COVER (UNO) AND A MINIMUM INTERNAL DIAMTER OF 1020mm.
- 5. 150mmø BOUNDARY RISERS SHALL BE PROVIDED TO EACH LOT TO MID-WESTERN COUNCIL'S GUIDELINES FOR ENGINEERING WORKS.
- 6. RISERS AND SIDELINES TO BE CONSTRUCTED TO WSA-02 2002.
- 7. FLOW LINE CHANNELS AND INTERSECTIONS SHALL BE CONSTRUCTED THROUGH MA AS PER WSA-02 2002.
- 8. ALL SEWER MAINS TO BE PRESSURE TESTED AS PER WSA-02 2002 AND DUBBO REGIONAL COUNCIL'S GUIDELINES FOR ENGINEERING WORKS.

BEDDING NOTES

- 1. THE MINIMUM DEPTH TO TOP OF PIPE SHALL BE 1000mm, EXCEPT UNDER ROAD PAVEMENT WHERE MINIMUM COVER TO TOP OF PIPE SHALL BE 1200mm MINIMUM UNLESS SHOWN OTHERWISE. PIPES WITH LESS COVER THAN THESE LIMITS TO BE CONCRETE ENCASED, AND DICL UNDER ROADS.
- 2. GRADES OF GRAVITY SEWER NOT TO BE FLATTER THAN 1:179 (0.55%) FOR 150mm DIAMETER PIPES AS PER WSA-2014.
- 3. MANHOLES SHALL BE PLACED AT EACH CHANGE IN DIRECTION OR GRADE OF THE PIPE LINE AT INTERVALS ALONG THE LINE NOT EXCEEDING

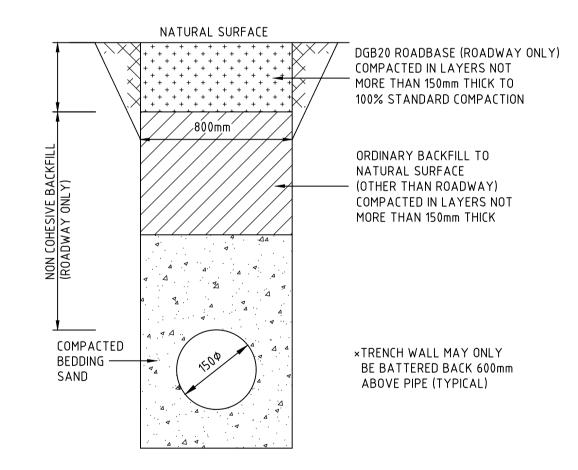

TYPICAL TRENCH SECTION

N.T.S.

× INSTALLATION OF UPVC PIPES SHALL TO CONFORM TO AS2032-1977 "INSTALLATION OF UPVC PIPE SYSTEMS", AS2566-1998 "BURIED FLEXIBLE PIPELINES", WSA-02 2002 AND MANUFACTURERS INSTRUCTIONS.

SUBMISSION FOR



BARNSON PTY LTD

- t 1300 BARNSON (1300 227 676)
- e generalenquiry@barnson.com.au
- w www.barnson.com.au

DIMENSIONS TO BE CHECKED ON SITE BEFORE COMMENCEMENT OF WORK. REPORT DISCREPANCIES TO BARNSON PTY LTD. NO PART OF THIS DRAWING MAY BE REPRODUCED IN ANY WAY WITHOUT THE WRITTEN PERMISSION OF BARNSON PTY LTD.

Project: DRAWINGS APPLICABLE TO THIS PROJECT. ALL DIMENSIONS IN MILLIMETRES. DO NOT SCALE.

MULTI-UNIT DEVELPMENT AT 22 LAWSON STREET


MUDGEE NSW 2850 Drawing Title: PROPOSED SEWER PLAN

Certification

Drawn **MK**


Drawing Number

Original Sheet 37340 - CO4

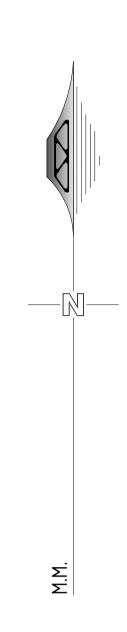

LEGEND

EXISTING SUBJECT CADASTRAL BOUNDARIES EXISTING UNDERGROUND SEWER PIPE EXISTING UNDERGROUND WATER MAIN EXISTING SEWER MANHOLE

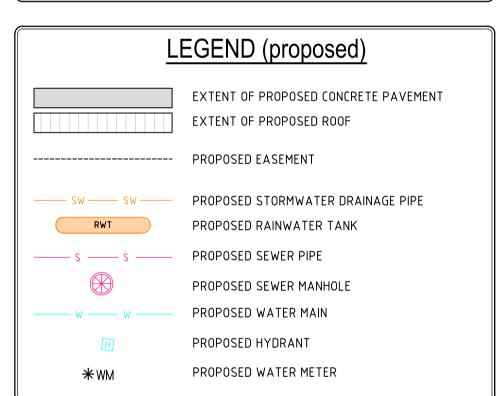

- THE BOUNDARY INFORMATION SHOWN ON THIS PLAN BEEN PLOTTED AS REQUIRED UNDER DIVISION 1, SECTION 9.(1) OF THE "SURVEYING AND SPATIAL INFORMATION REGULATION 2017". IT HAS NOT BEEN DETERMINED BY AN ACCURATE
- A DETAIL & LEVEL SURVEY IS NOT A "LAND SURVEY" AS DEFINED BY THE SURVEYING AND SPATIAL INFORMATION ACT 2002. IF ANY CONSTRUCTION OR DESIGN WORK WHICH RELIES ON CRITICAL SETBACKS FROM THE STREET OR BOUNDARIES IS PLANNED, IT WOULD BE IMPERATIVE TO CARRY OUT FURTHER SURVEY WORK TO DETERMINE THE
- THE LOCATIONS AND DEPTHS OF UNDERGROUND SERVICES ARE NOT ASSURED BY BARNSON. SERVICE AUTHORITIES
- SHOULD BE CONSULTED BEFORE ANY EXCAVATION, DEMOLITION OR CONSTRUCTION COMMENCES.
- THERE MAY BE UNDERGROUND SERVICES THAT HAVE NOT BEEN SHOWN HEREON.
- BARNSON TAKES NO RESPONSIBILITY FOR LOSSES, DAMAGES OR INJURIES TO ANY PERSON OR ORGANISATION THAT MAY OCCUR DUE TO THE RELIANCE ON THIS PLAN FOR THE LOCATION OF UNDERGROUND SERVICES.

_ _ _ _ _ _ _ _ _ _ _ _ _ "NEW STREET FIRE HYDRANT, BY MWRC **⊕**SMH SCALE 1:200(A1) PROPOSED HYDRANT PLAN REDUCTION RATIO 1:200 @ A1

NOTES:

1. STOP VALVE & SCOUR VALVE CHAMBERS MAY EITHER BE CONSTRUCTED USING PREFABRICATED POLYPROPYLENE UNITS, 375mm DIAM. PVC OR CONCRETE PIPE, INTERLOCKING CONCRETE BLOCKS OR BRICKS WITH SAND/CEMENT MORTAR JOINTS.

2. THE BOTTOM OF THE BRICK, INTERLOCKING CONCRETE BLOCK OR PIPE CHAMBERS SHALL NOT REST DIRECTLY ON THE PIPE BUT ON A COURSE OF BRICKS OR A 100mm THICK CONCRETE FOUNDATION.

3. MINIMUM COVER OVER PIPELINES (ALL TYPES) SHALL BE 750mm IN AREAS SUBJECT TO VEHICULAR LOADING SUCH AS ROADS & FOOTPATHS AND 600mm ELSEWHERE.

4. IN AREAS PAVED WITH BITUMEN SEALING, ASPHALT, CONCRETE OR PAVING BLOCKS THE SURFACE OF VALVE AND HYDRANT COVERS SHALL FINISH FLUSH WITH THE PAVED SURFACE.

5. FOR STOP VALVES INSTALLATION, SOCKETS SHALL BE BUTTED UP TO SPIGOTS AND TRENCH WIDTHS SHALL BE KEPT TO A MINIMUM.

6. FILL SAND SHALL BE COMPACTED IN LAYERS NOT EXCEEDING 150mm AND COMPACTED TO ACHIEVE A MINIMUM 70 INDEX AND TO THE SATISFACTION OF THE SUPERINTENDENT.

7. INDICATOR POSTS SHALL BE WHITE IN COLOUR AND ONE OF THE FOLLOWING TYPES:

- 100mm x 100mm REINFORCED CONCRETE WITH 20mm CHAMFERS. - POWDER COATED METAL SUCH AS "EZIDRIVE" POST OR EQUIVALENT.
- RECYCLED PLASTIC POST WITH RECESSES FOR MARKER PLATES. - OTHER POSTS APPROVED BY COUNCIL.

8. DIMENSIONS OF SURFACE BOX COVERS SHOWN ON THIS DRAWING ARE NOMINAL. IF SURFACE BOX COVERS OTHER THAN THOSE SHOWN ARE SUPPLIED, THE DIMENSIONS OF THE CONCRETE SURROUNDS SHALL BE ADJUSTED ACCORDINGLY.

9. CONCRETE SHALL HAVE A MINIMUM COMPRESSIVE STRENGTH OF 20 MPa AND COMPLY WITH THE AUS-SPEC SPECIFICATION FOR MINOR CONCRETE WORKS.

10. THE DIMENSION BETWEEN THE UNDERSIDE OF THE STOP VALVE SURFACE BOX LID AND THE TOP OF THE VALVE SPINDLE SHALL BE A MINIMUM OF 80mm. THE TOP OF VALVE SPINDLE SHALL BE NO MORE THAN 300mm BELOW TOP SURFACE OF SURFACE BOX LID. IF THIS CANNOT BE ATTAINED, A GALVANIZED OR EPOXY PAINTED VALVE KEY EXTENSION SECURED BY GRUB SCREWS SHALL BE FITTED. IF NECESSARY, TO ENSURE THAT THE KEY EXTENSION IS CENTERED CORRECTLY A SPIDER ASSEMBLY SHALL BE INCORPORATED IN THE EXTENSION.

SUBMISSION FOR DA



BARNSON PTY LTD

- t 1300 BARNSON (1300 227 676) e generalenquiry@barnson.com.au
- w www.barnson.com.au

THIS DRAWING IS TO BE READ IN CONJUNCTION WITH GENERAL BUILDING DRAWINGS, SPECIFICATIONS & OTHER CONSULTANTS DRAWINGS APPLICABLE TO THIS PROJECT. ALL DIMENSIONS IN MILLIMETRES. DO NOT SCALE. DIMENSIONS TO BE CHECKED ON SITE BEFORE COMMENCEMENT OF WORK. REPORT DISCREPANCIES TO BARNSON PTY LTD. NO PART OF THIS DRAWING MAY BE

REPRODUCED IN ANY WAY WITHOUT THE WRITTEN

PERMISSION OF BARNSON PTY LTD.

HAYES CONSTRUCTION Client: Project: MULTI-UNIT DEVELPMENT AT 22 LAWSON STREET MUDGEE NSW 2850

Drawing Title: PROPOSED HYDRANT PLAN

1:400 @ A3

Rev Date Amendment A 19-08-2021 ISSUED FOR DA

SCALE 1:400(A3)

Design

Drawn **MK**


Size = A1

Original Sheet

Drawing Number 37340 - C05

Certification

Revision

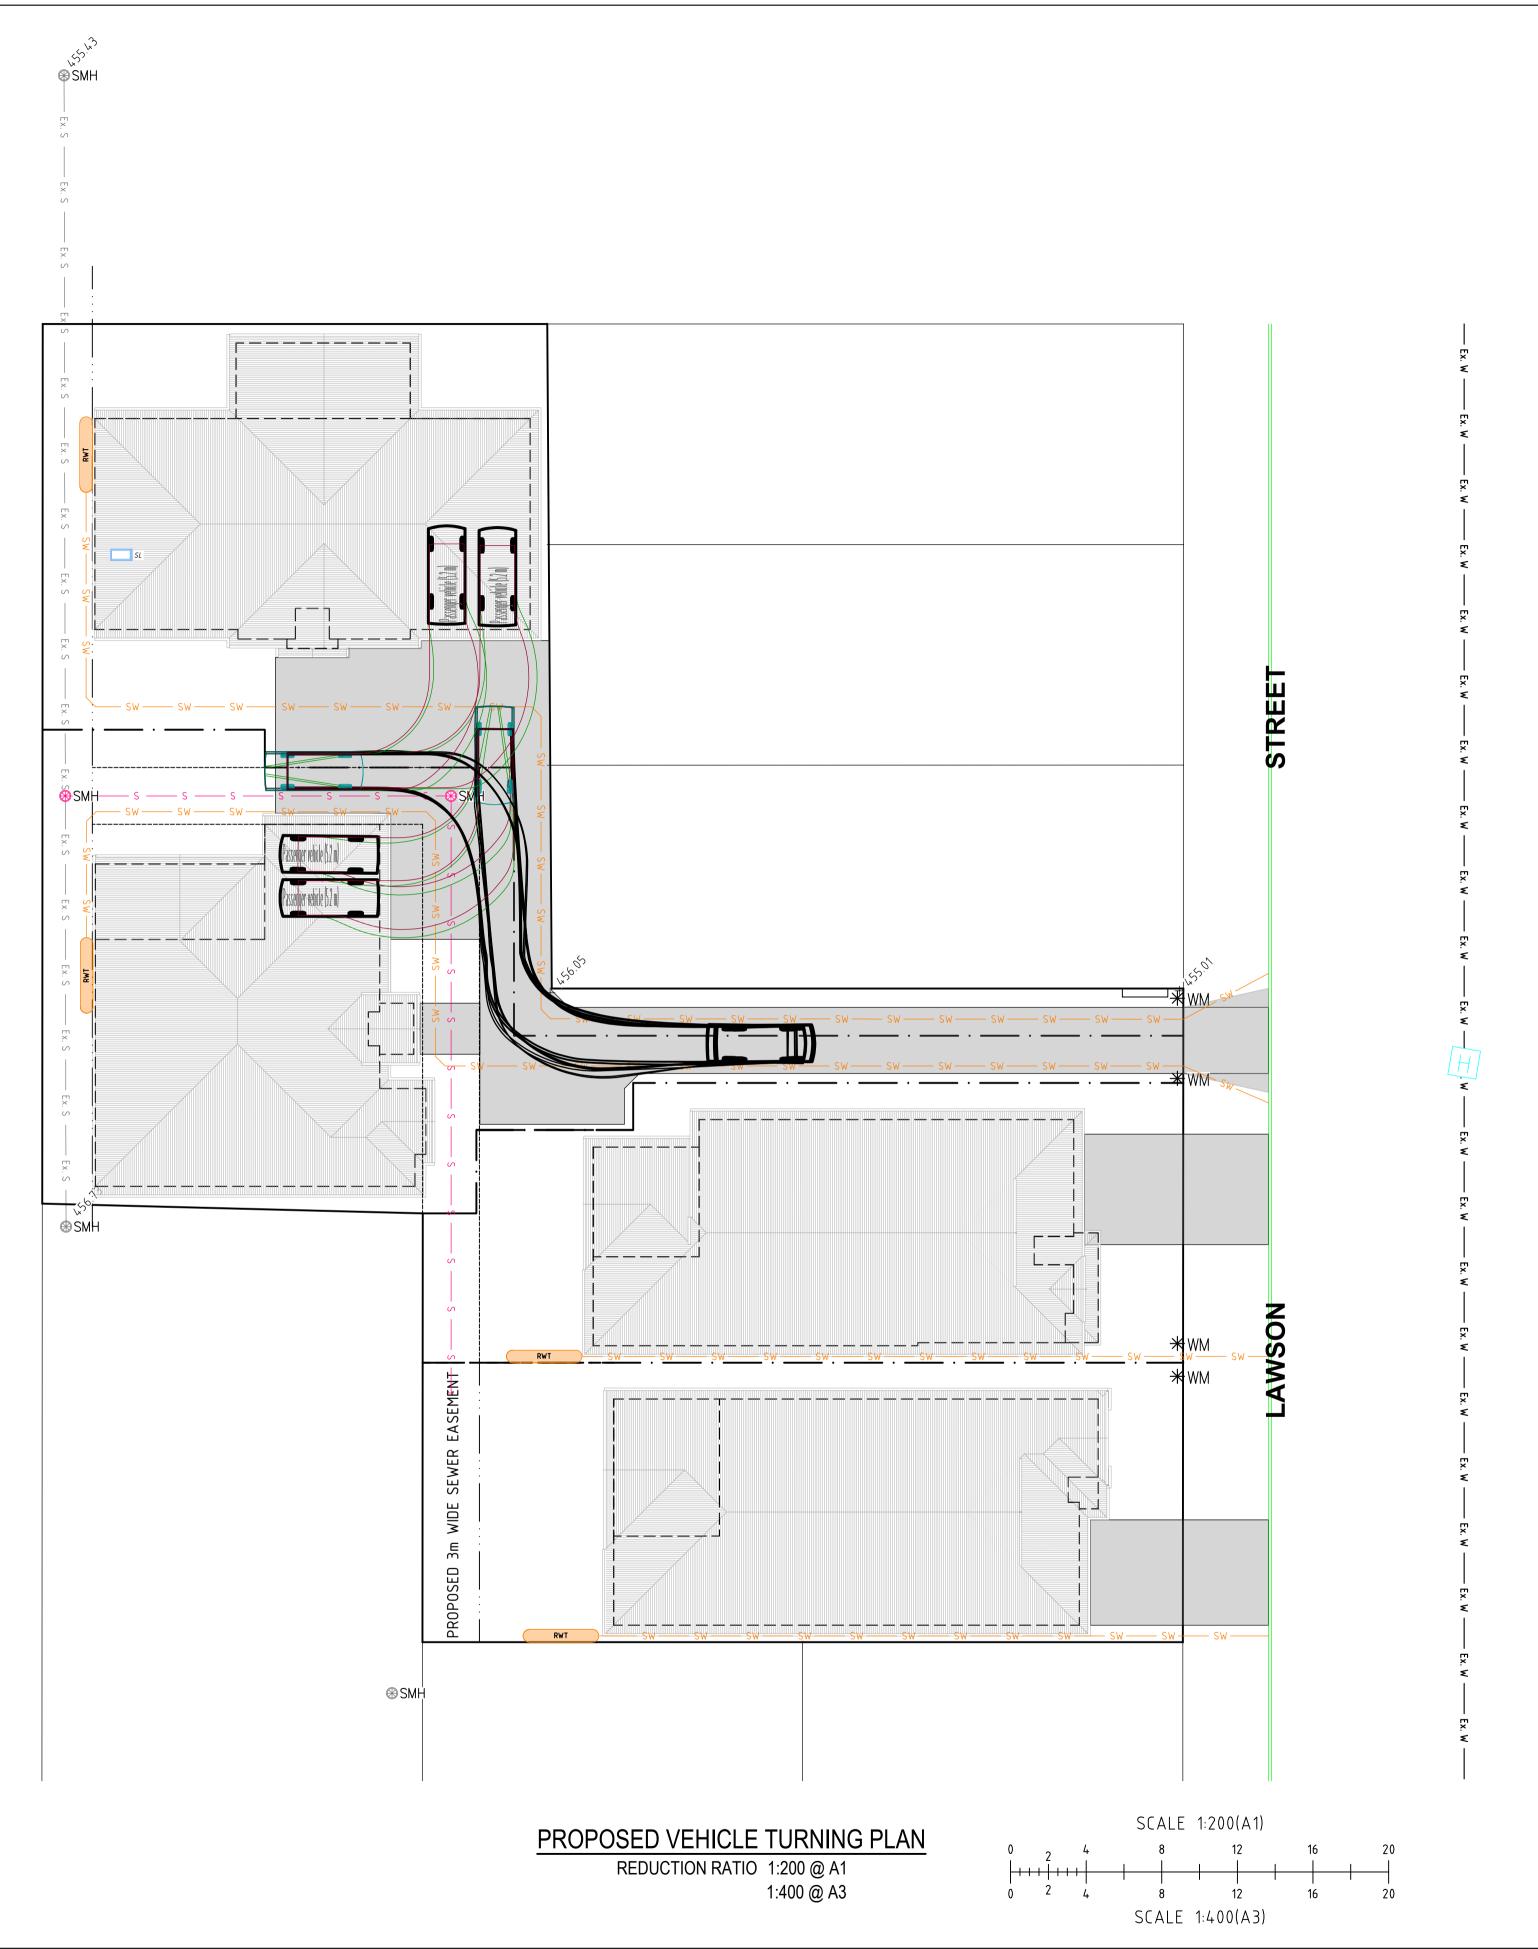



THERE MAY BE UNDERGROUND SERVICES THAT HAVE NOT BEEN SHOWN HEREON.

LEGEND

EXISTING SEWER MANHOLE
PROPOSED WATER METER

NOTES:

EXISTING SUBJECT CADASTRAL BOUNDARIES

THE BOUNDARY INFORMATION SHOWN ON THIS PLAN BEEN PLOTTED AS REQUIRED UNDER DIVISION 1, SECTION 9.(1) OF THE "SURVEYING AND SPATIAL INFORMATION REGULATION 2017". IT HAS NOT BEEN DETERMINED BY AN ACCURATE

A DETAIL & LEVEL SURVEY IS NOT A "LAND SURVEY" AS DEFINED BY THE SURVEYING AND SPATIAL INFORMATION ACT 2002. IF ANY CONSTRUCTION OR DESIGN WORK WHICH RELIES ON CRITICAL SETBACKS FROM THE STREET OR

BOUNDARIES IS PLANNED, IT WOULD BE IMPERATIVE TO CARRY OUT FURTHER SURVEY WORK TO DETERMINE THE

THE LOCATIONS AND DEPTHS OF UNDERGROUND SERVICES ARE NOT ASSURED BY BARNSON. SERVICE AUTHORITIES

BARNSON TAKES NO RESPONSIBILITY FOR LOSSES, DAMAGES OR INJURIES TO ANY PERSON OR ORGANISATION THAT

SHOULD BE CONSULTED BEFORE ANY EXCAVATION, DEMOLITION OR CONSTRUCTION COMMENCES.

MAY OCCUR DUE TO THE RELIANCE ON THIS PLAN FOR THE LOCATION OF UNDERGROUND SERVICES.

EXISTING UNDERGROUND SEWER PIPE

BARNSON PTY LTD

† 1300 BARNSON (1300 227 676)

e generalenquiry@barnson.com.auw www.barnson.com.au

DESIGN.PLAN.MANAGE bathurst|coffsharbour|dubbo|mudgee|orange|sydney|tamworth

THIS DRAWING IS TO BE READ IN CONJUNCTION
WITH GENERAL BUILDING DRAWINGS,
SPECIFICATIONS & OTHER CONSULTANTS
DRAWINGS APPLICABLE TO THIS PROJECT.
ALL DIMENSIONS IN MILLIMETRES. DO NOT SCALE.
DIMENSIONS TO BE CHECKED ON SITE BEFORE
COMMENCEMENT OF WORK.
REPORT DISCREPANCIES TO BARNSON PTY LTD.

REPRODUCED IN ANY WAY WITHOUT THE WRITTEN

NO PART OF THIS DRAWING MAY BE

PERMISSION OF BARNSON PTY LTD.

Client: HAYES CONSTRUCTION

Project: MULTI-UNIT DEVELPMENT AT

22 LAWSON STREET

MUDGEE NSW 2850

Drawing Title: PROPOSED VEHICLE TURNING PLAN

Rev Date Amendment A 19-08-2021 ISSUED FOR DA

Design LM Certification

Drawn MK

Check **LM**Original Sheet

Size = A1

M Drawing Number

eet 37340 - C06

Revision •

SUBMISSION FOR DA